RENOVATIONS TO GOVERNMENT OF CANADA BUILDING Ulukhaktok, NWT

WBSE # R.023085.001

CONSULTANTS

ARCHITECTURAL

PSAV ARCHITECTS LTD.

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MECHANICAL

WILLIAMS ENGINEERING CANADA INC.

P.O. BOX 1529 4902 49 STREET YELLOWKNIFE, N.W.T. X1A 2P2 EMAIL bgeorge@williamsengineering.com

ELECTRICAL

WILLIAMS ENGINEERING CANADA INC.

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LIST OF DRAWINGS

COVER SHEET

ARCHITECTURAL

- NOTES, DEMOLITION PLAN, FLOOR PLAN, REFLECTED CEILING PLAN AND DETAILS
- DOOR SCHEDULE, ROOM FINISH SCHEDULE, INTERIOR ELEVATIONS AND DETAILS
- MILLWORK DETAILS
- FLOOR PLAN, NOTES, SCHEDULES AND


MECHANICAL

MECHANICAL EXISTING PLANS MECHANICAL NEW PLANS MECHANICAL SCHEMATIC

MECHANICAL SITE PLAN


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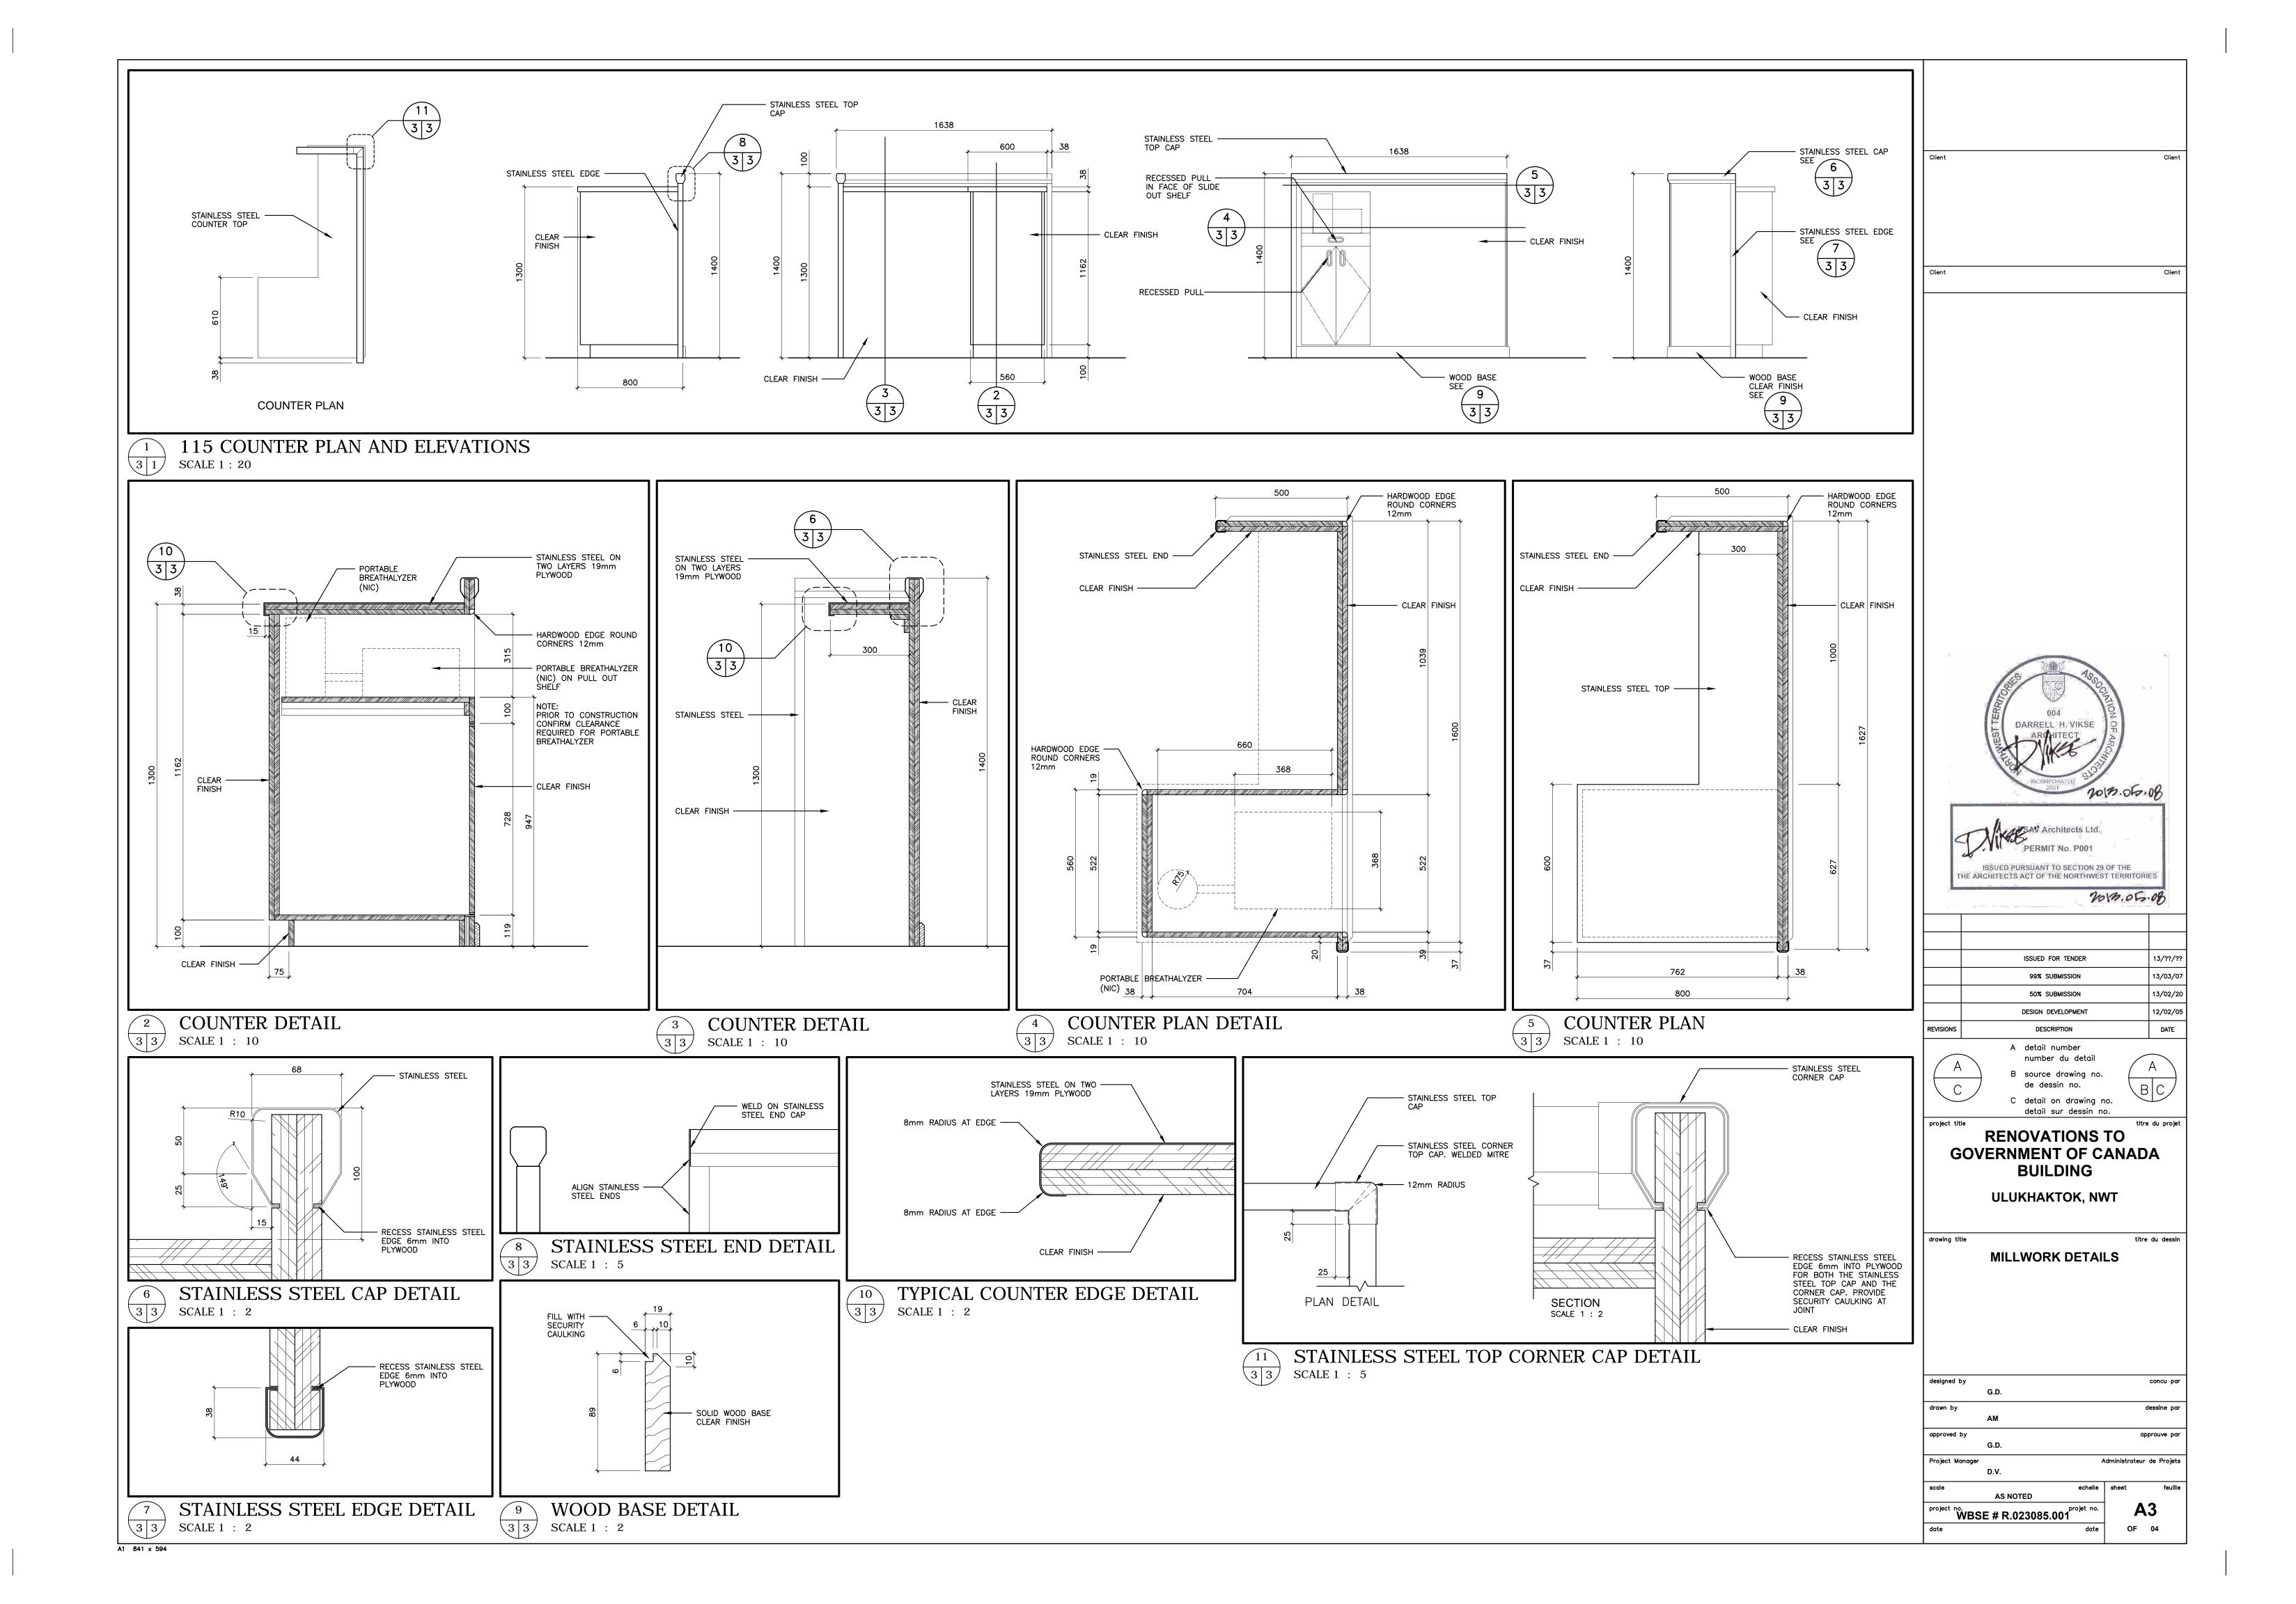
ELECTRICAL NEW PLAN ELECTRICAL NEW PLAN

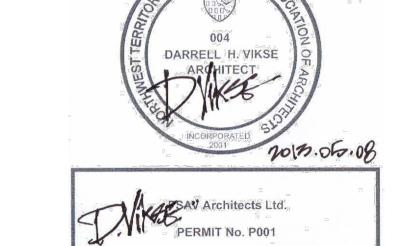



ISSUED FOR TENDER- 2013/05/08

CADFLNM




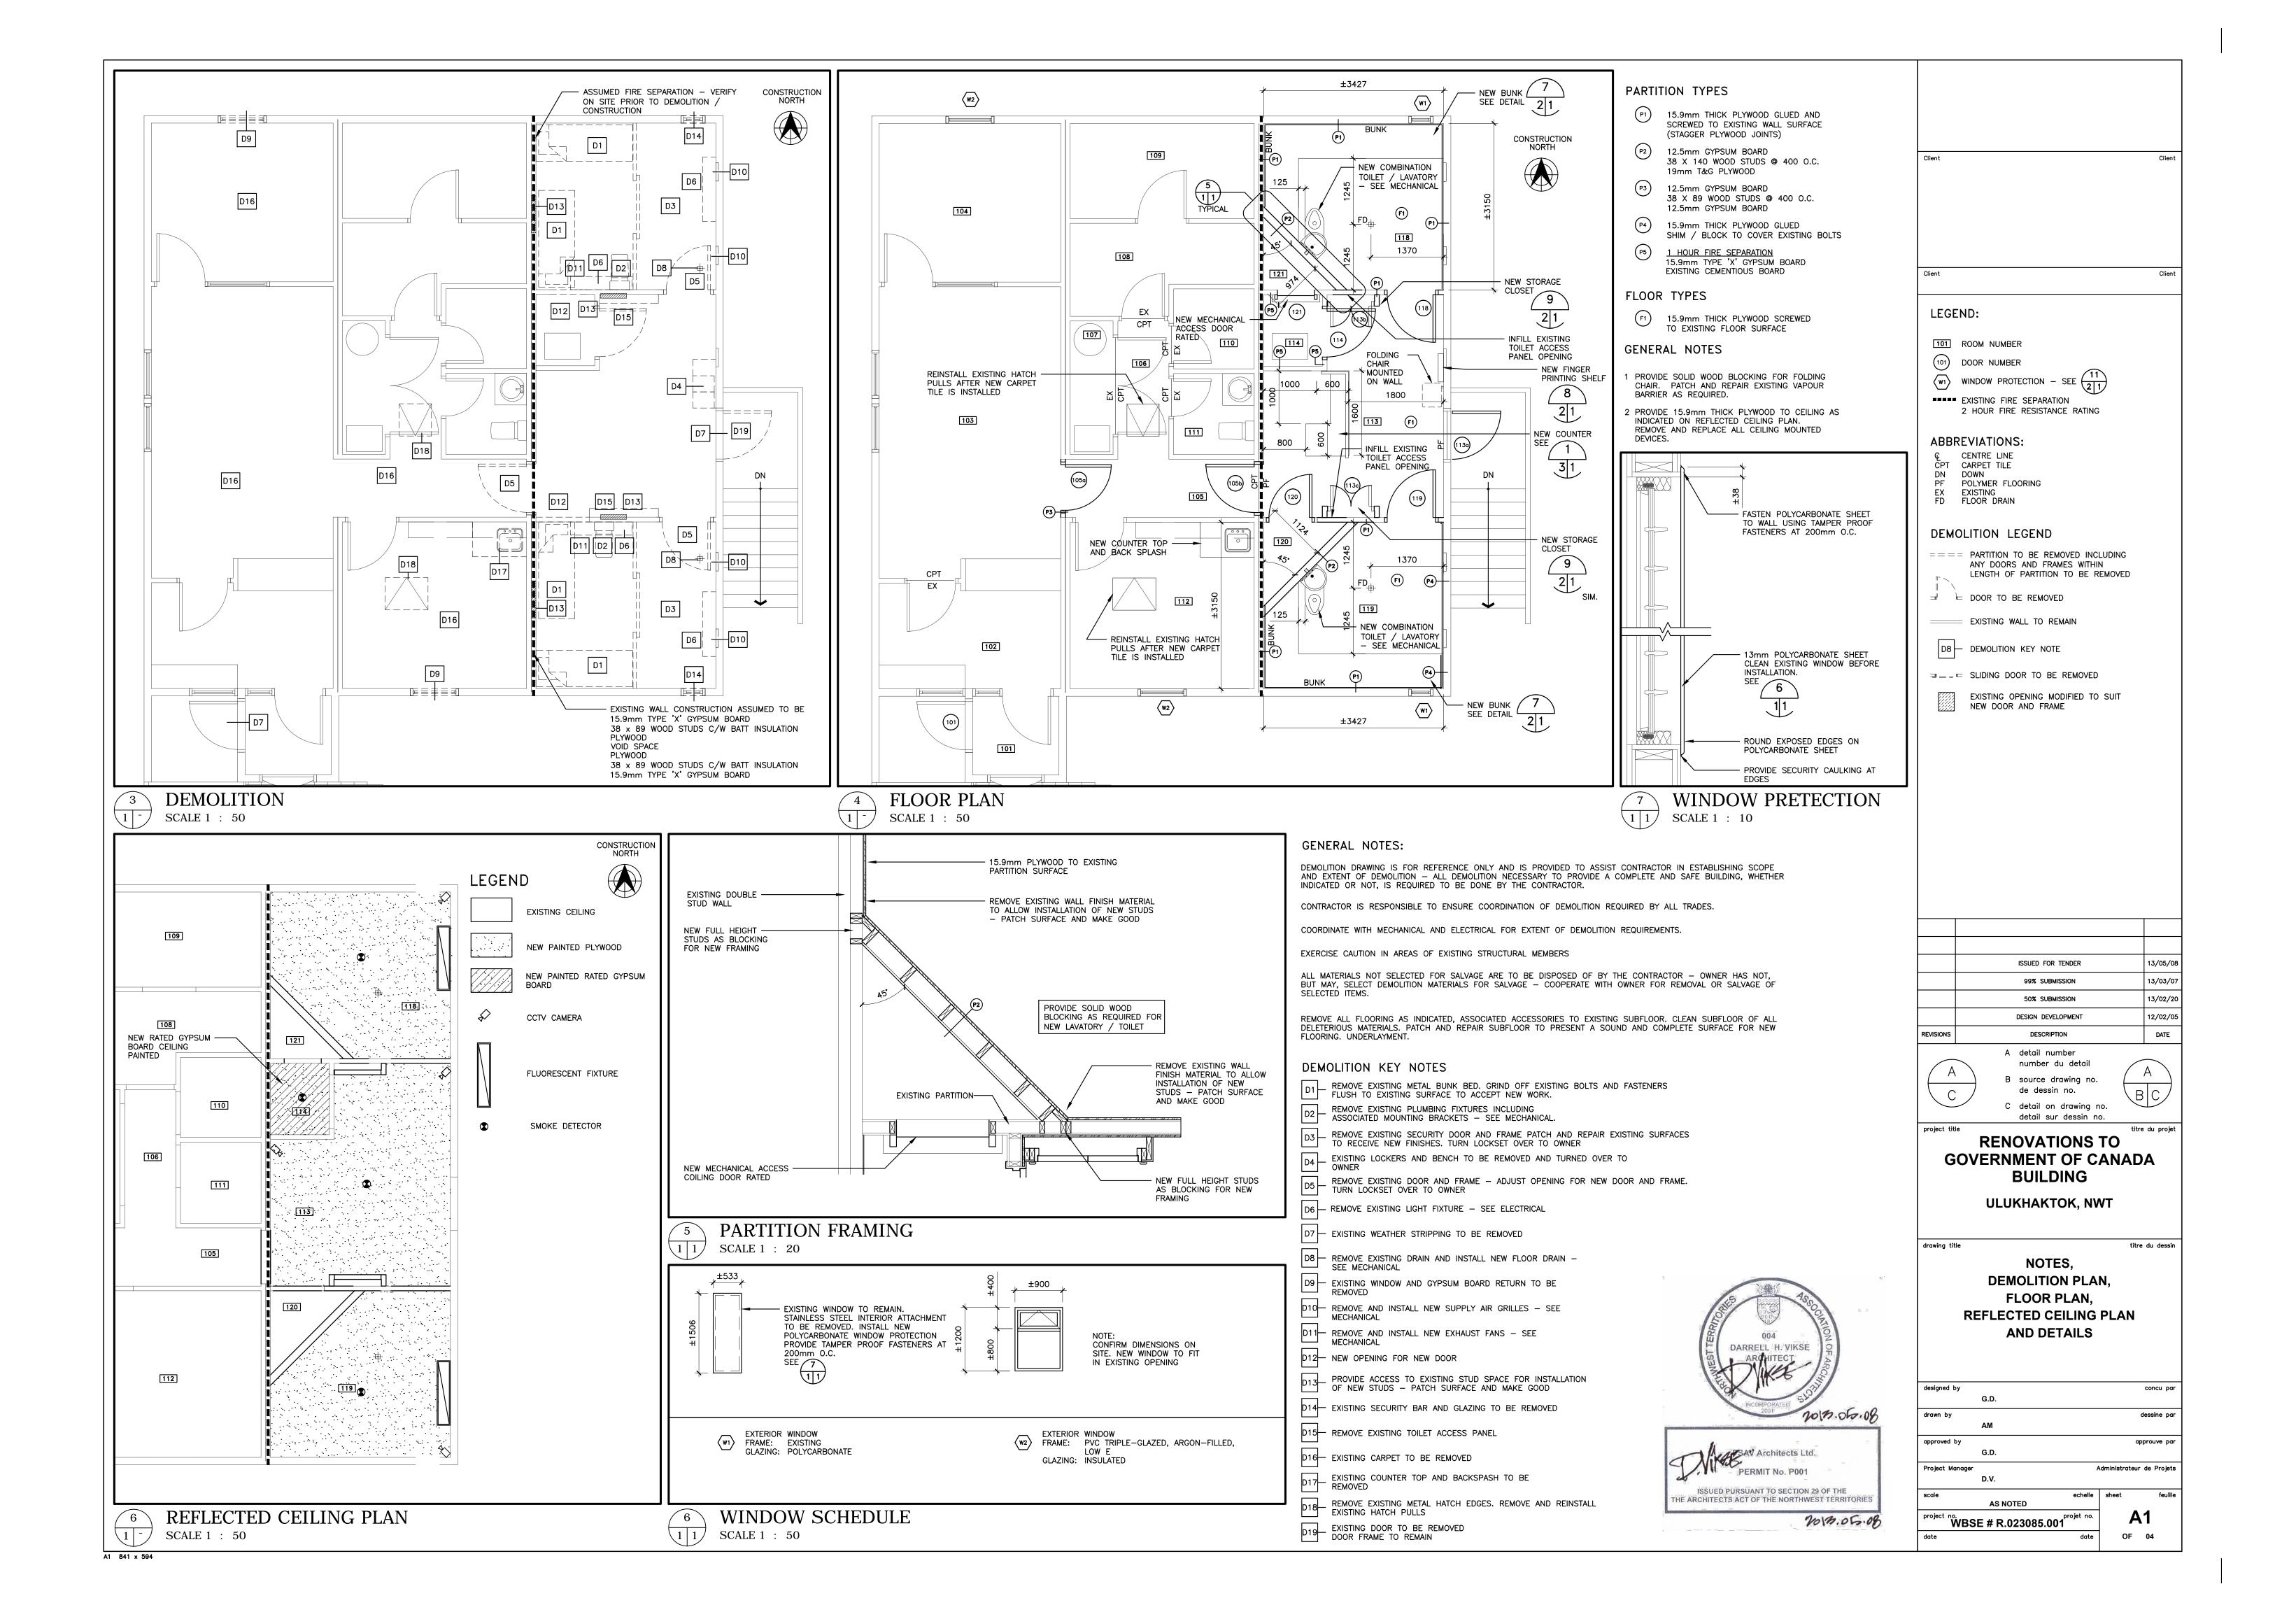

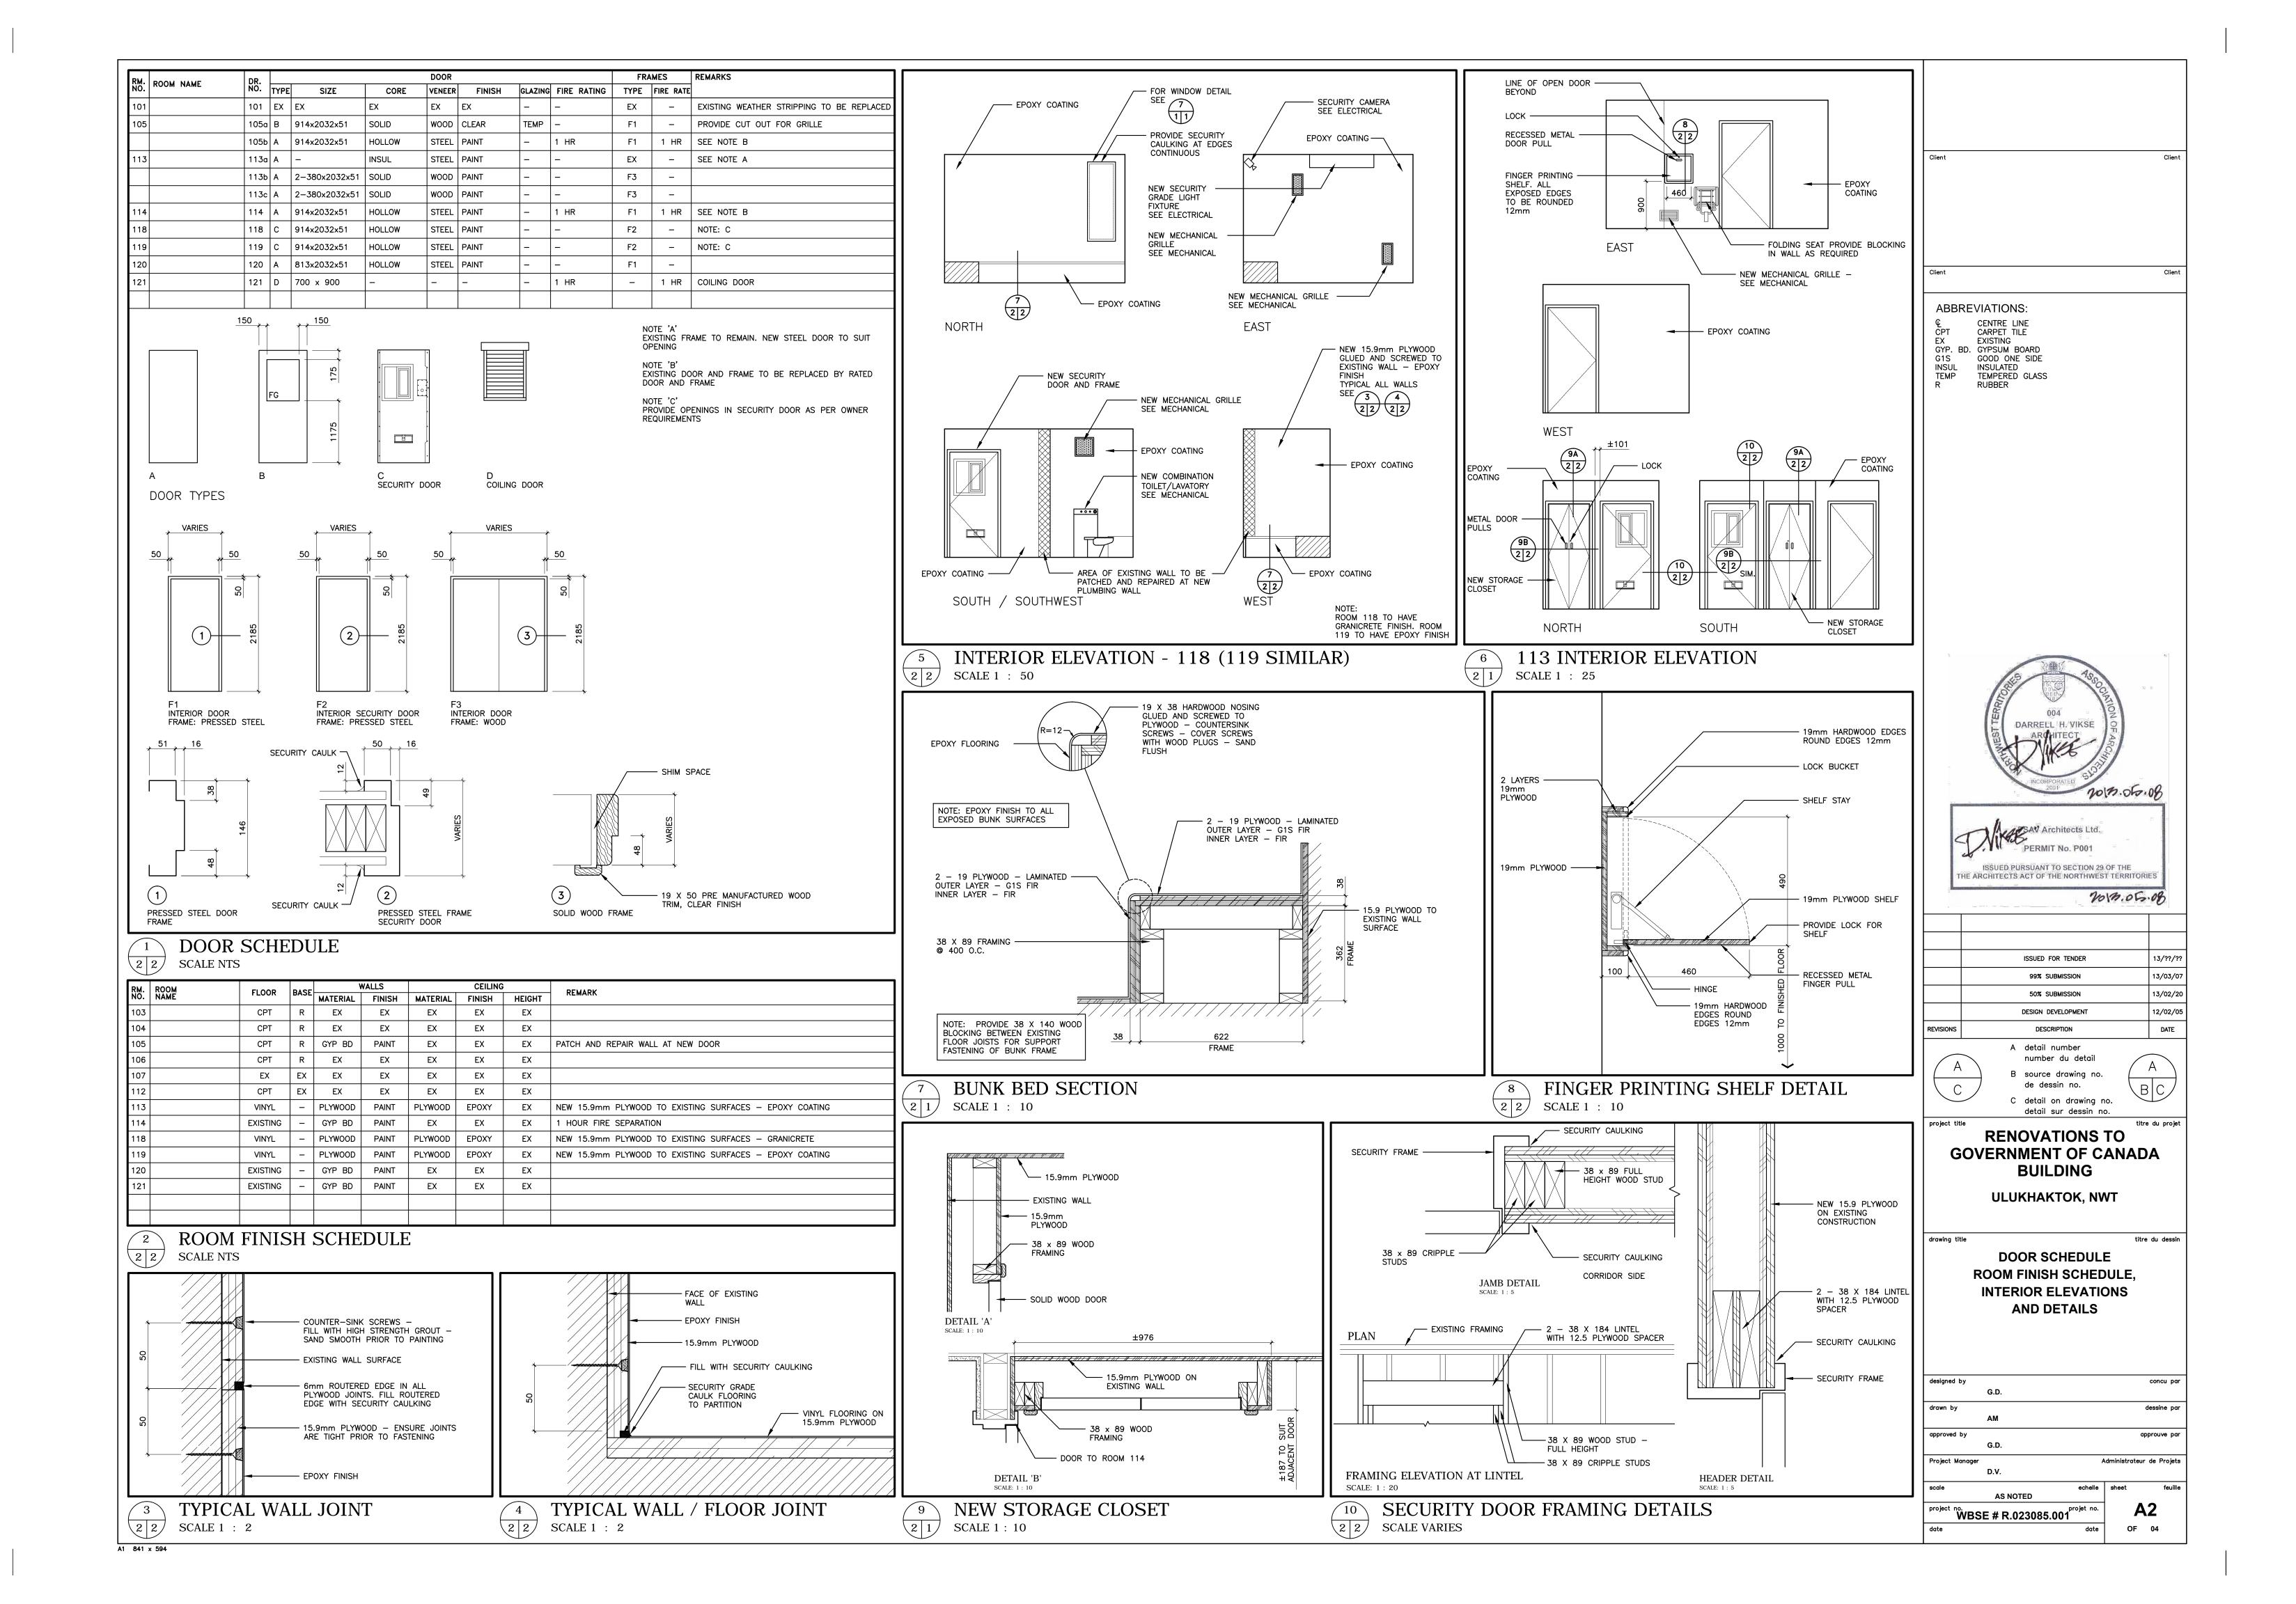

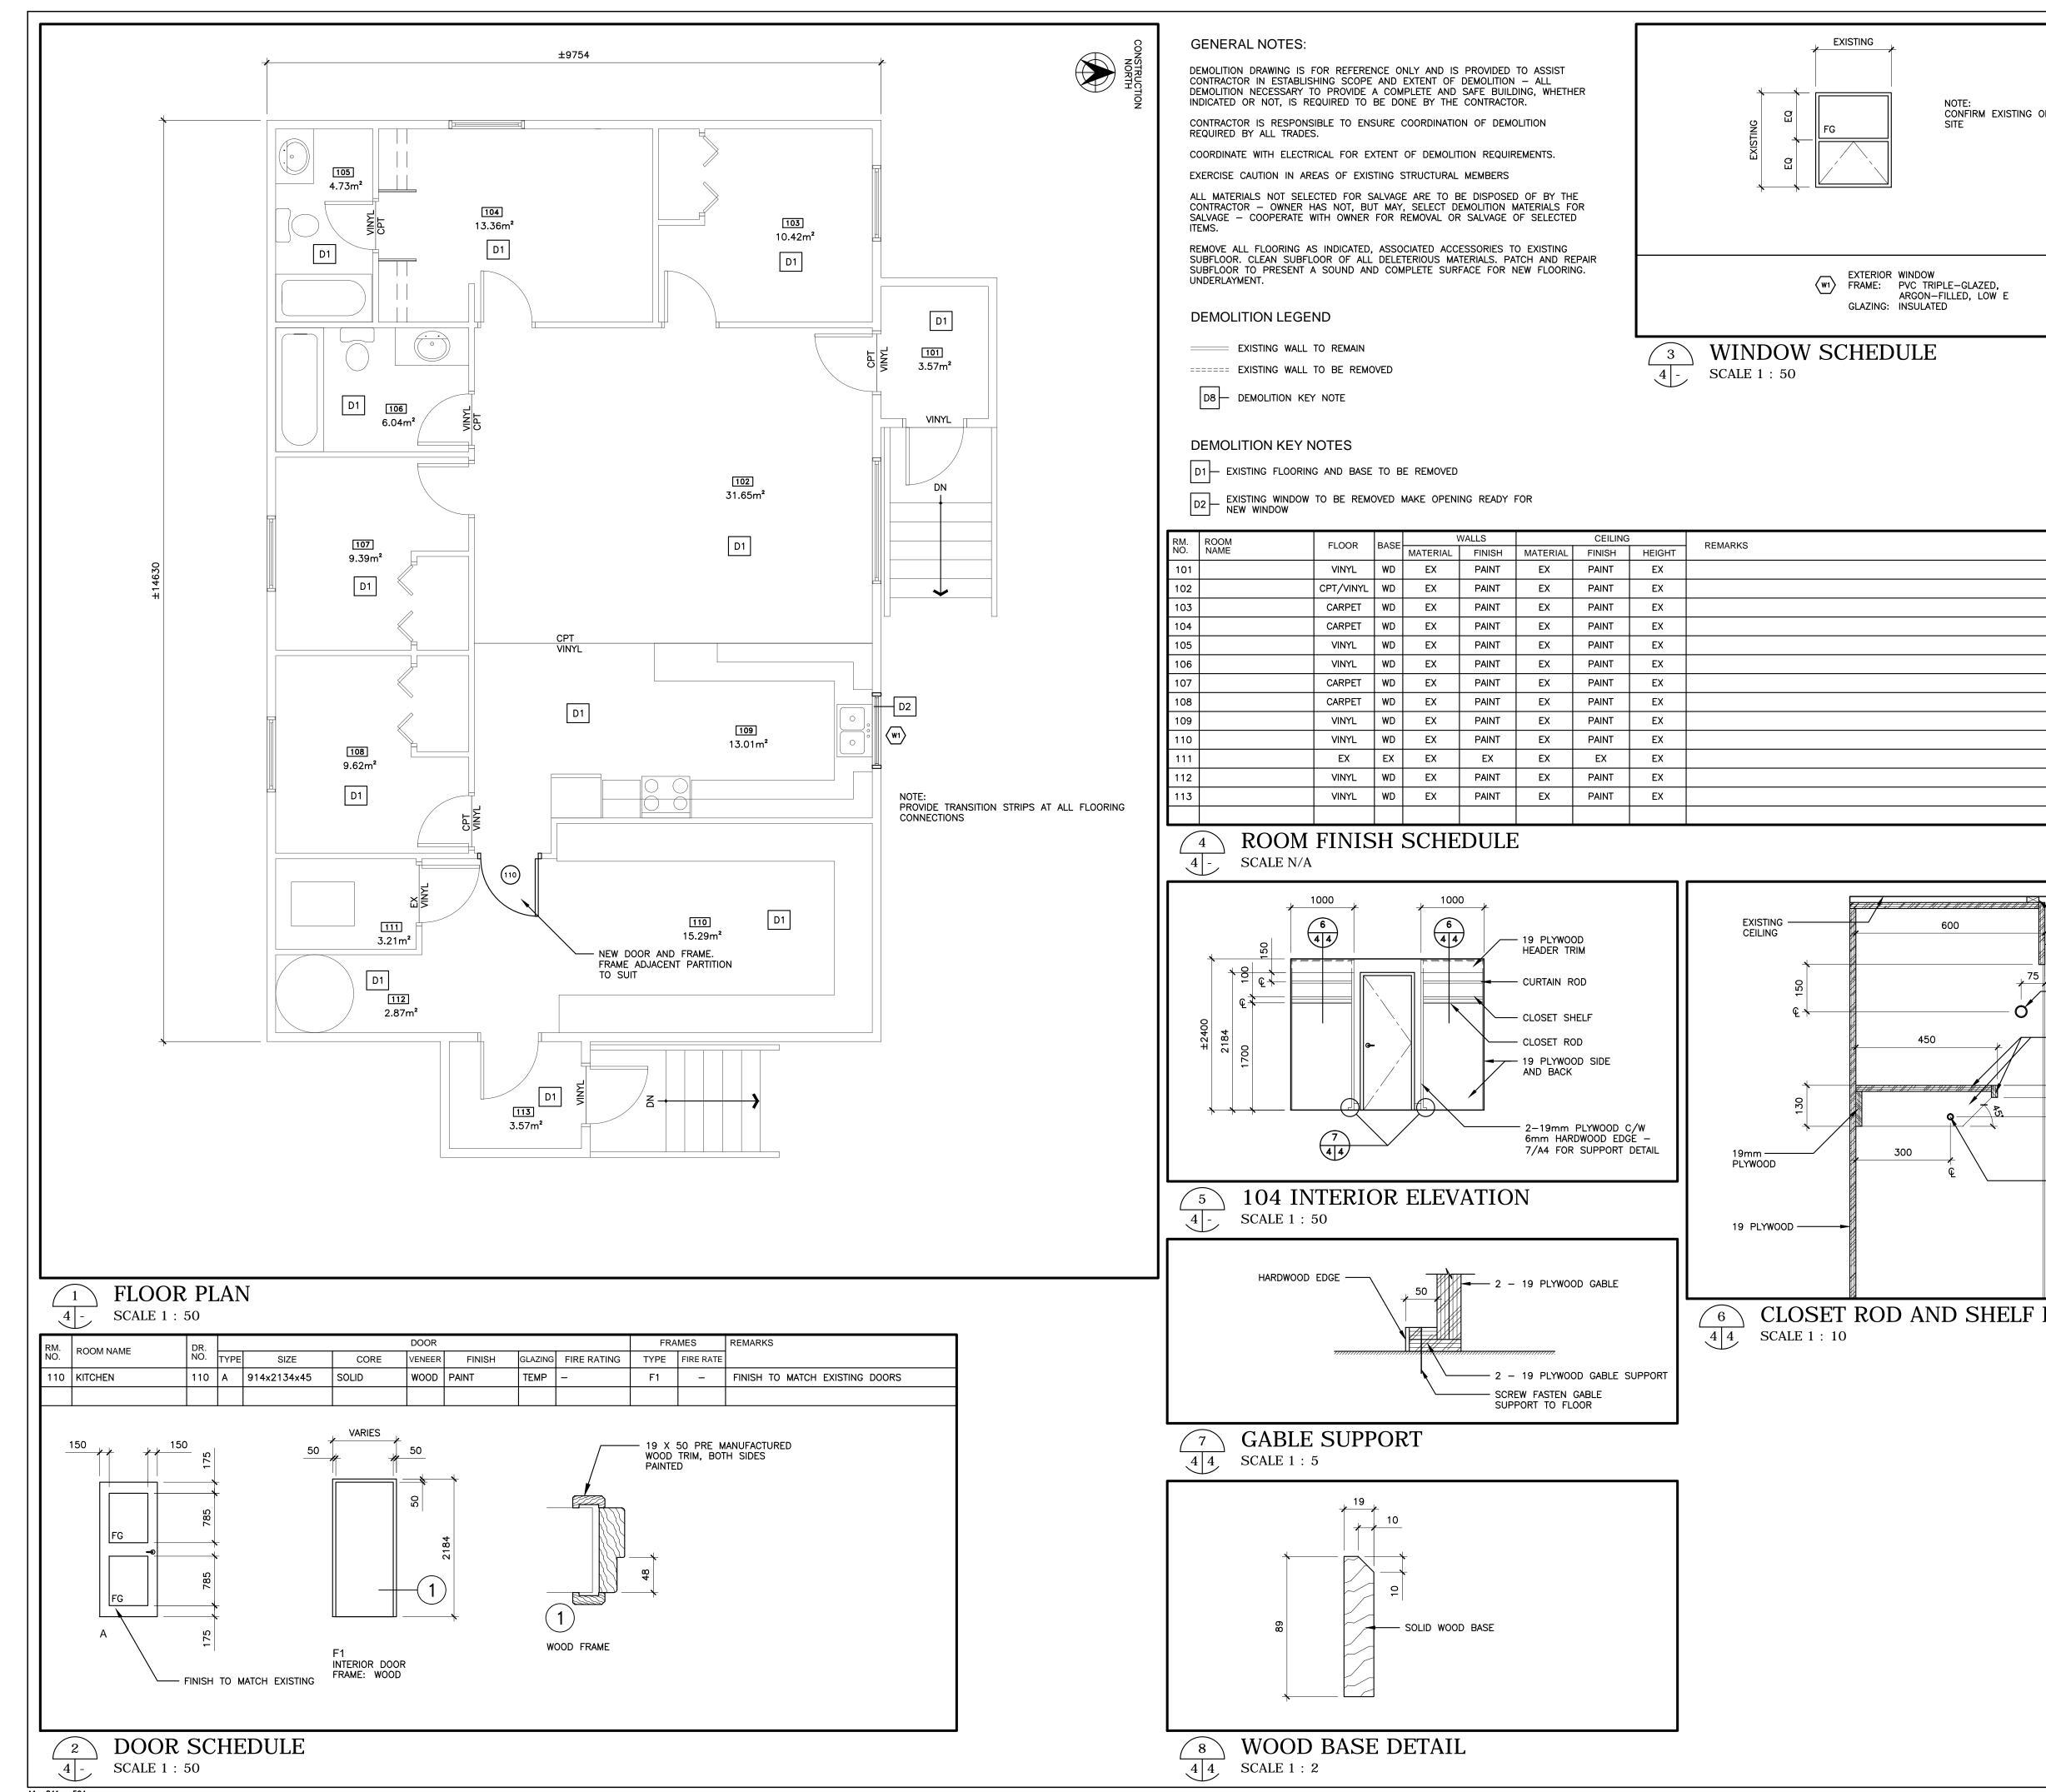


RM.	ROOM	FLOOR	BASE WALLS		VALLS	CEILING			REMARKS
NO.	ROOM NAME	FLOOR	DASE	MATERIAL	FINISH	MATERIAL	FINISH	HEIGHT	KEWIARNO
101		VINYL	WD	EX	PAINT	EX	PAINT	EX	
102		CPT/VINYL	WD	EX	PAINT	EX	PAINT	EX	
103		CARPET	WD	EX	PAINT	EX	PAINT	EX	
104		CARPET	WD	EX	PAINT	EX	PAINT	EX	
105		VINYL	WD	EX	PAINT	EX	PAINT	EX	
106		VINYL	WD	EX	PAINT	EX	PAINT	EX	
107		CARPET	WD	EX	PAINT	EX	PAINT	EX	
108		CARPET	WD	EX	PAINT	EX	PAINT	EX	
109		VINYL	WD	EX	PAINT	EX	PAINT	EX	
110		VINYL	WD	EX	PAINT	EX	PAINT	EX	
111		EX	EX	EX	EX	EX	EX	EX	
112		VINYL	WD	EX	PAINT	EX	PAINT	EX	
113		VINYL	WD	EX	PAINT	EX	PAINT	EX	

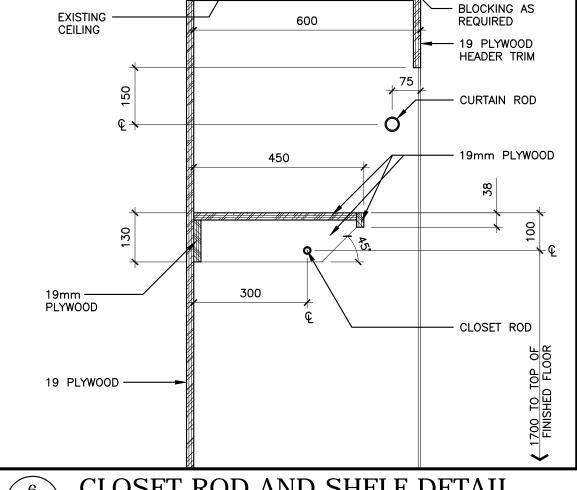

CONFIRM EXISTING OPENING ON

CLOSET ROD AND SHELF DETAIL

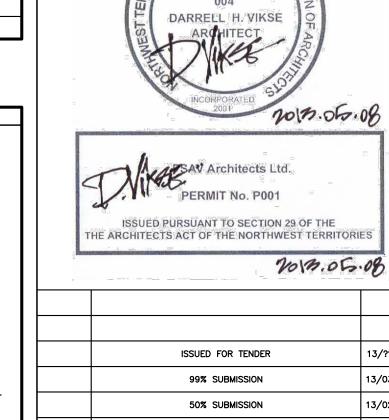

ABBREVIATIONS

FG NSV VINYL WD

FIXED GLAZING NON-SLIP VINYL

VINYL FLOORING WOOD

ı		ISSUED FOR TENDER	13/??/??
ı		99% SUBMISSION	13/03/07
ı		50% SUBMISSION	13/02/20
ı		DESIGN DEVELOPMENT	12/02/05
ı	REVISIONS	DESCRIPTION	DATE
	A	A detail number number du detail B source drawing no.	A


detail sur dessin no. titre du projet **RENOVATIONS TO GOVERNMENT OF CANADA** BUILDING


C detail on drawing no.

ULUKHAKTOK, NWT


drawing title titre du dessin FLOORPLAN, NOTES, **SCHEDULES AND DETAILS**

designed by				concu pa
	G.D.			
drawn by				dessine pa
	AM			
approved by			o	pprouve pa
	G.D.			
Project Manager		,	Administrateu	r de Projet
	D.V.			
scale		echelle	sheet	feuille
	AS NOTED		_	_
project no.	E # R.023085.00	projet no.		4
date		date	OF	04

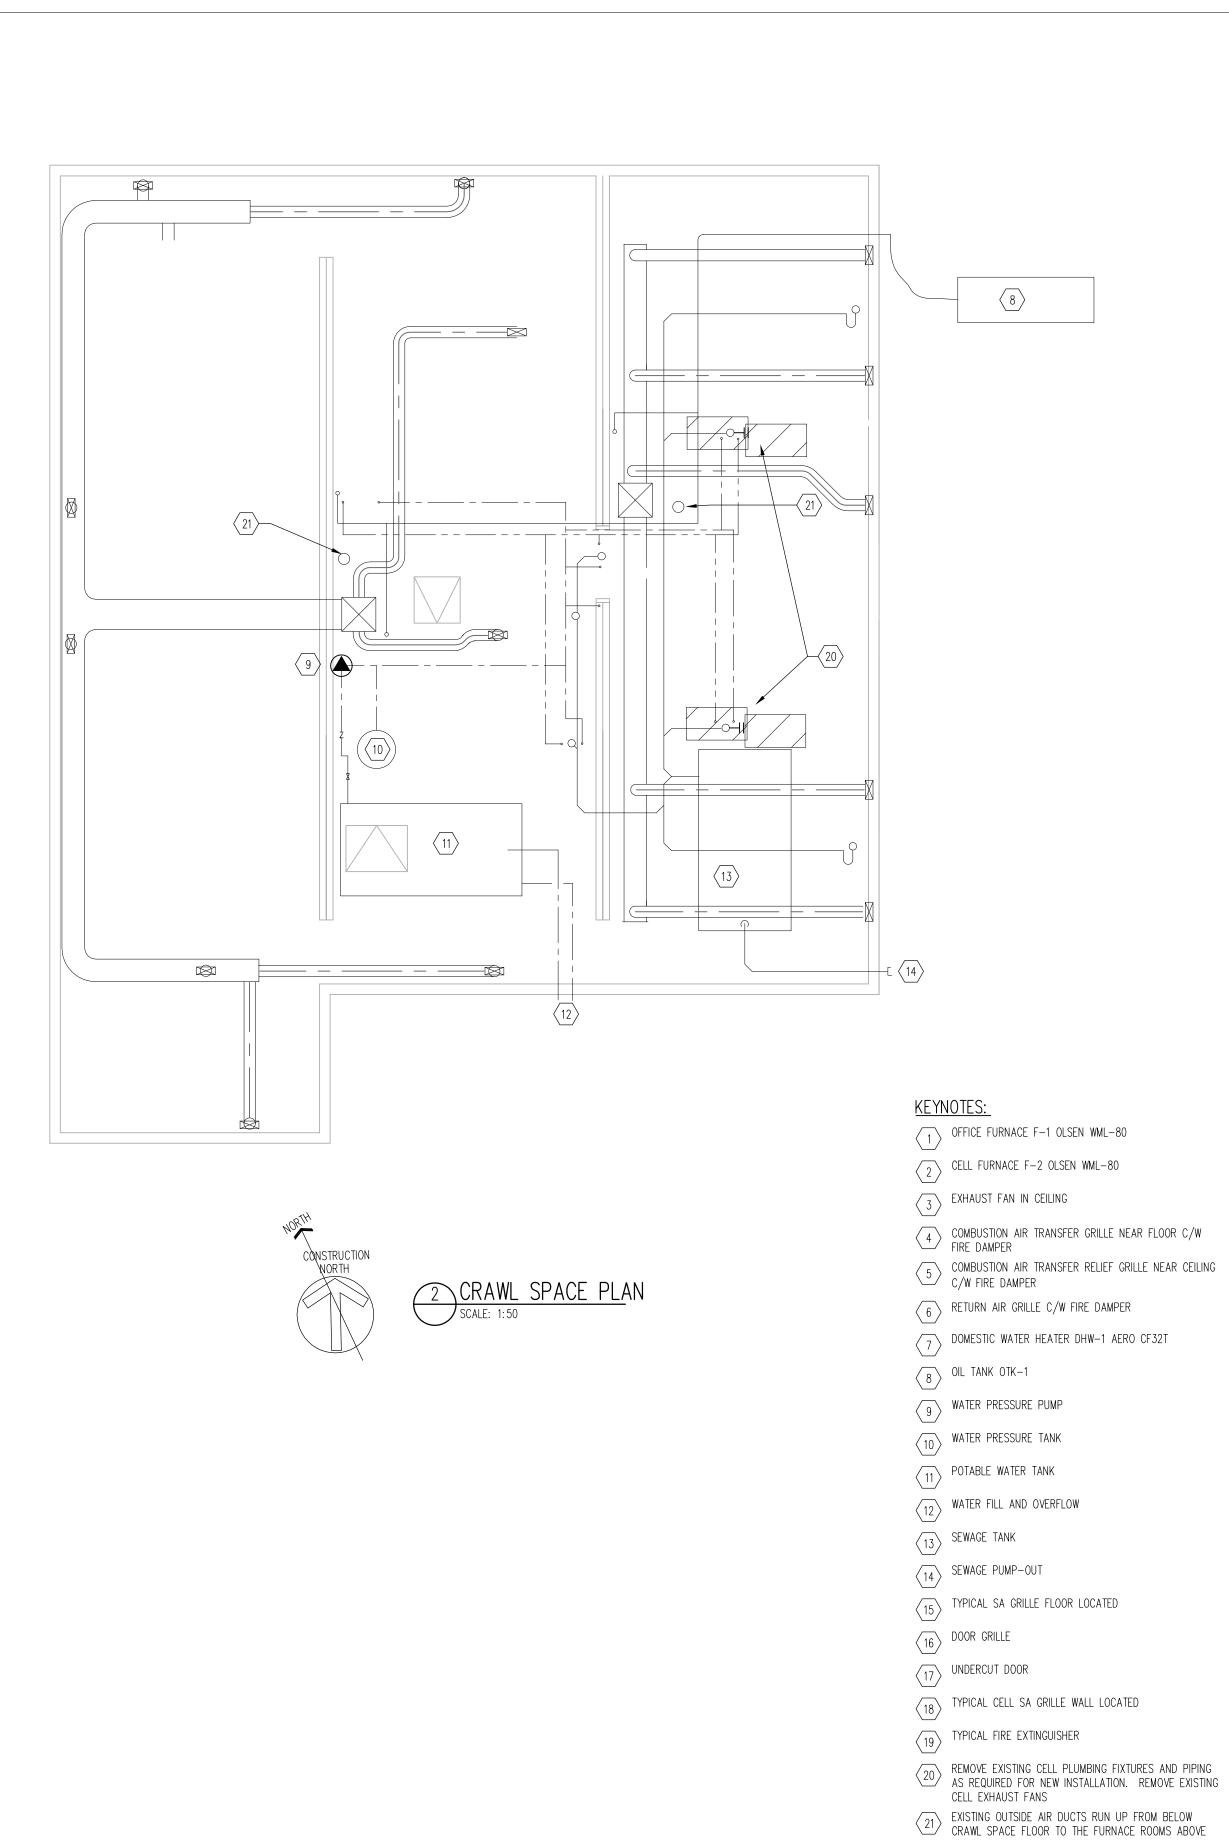

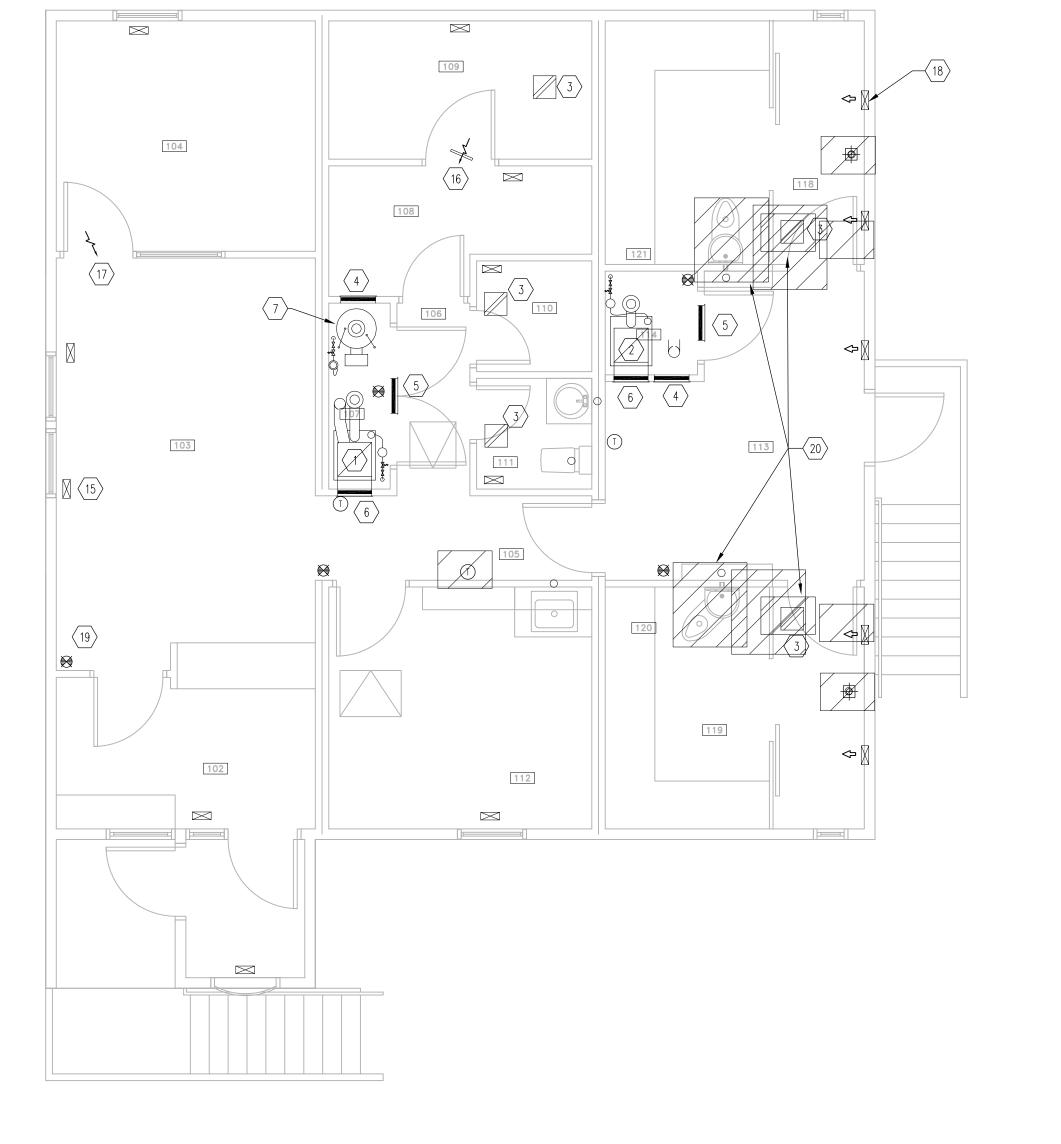

1 MAIN FLOOR PLAN
SCALE: 1:50

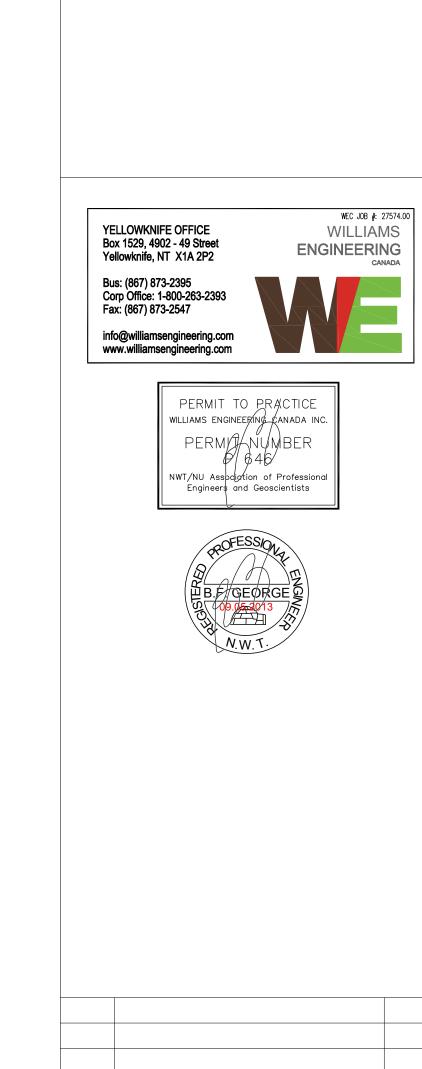

roject title titre du projet

RENOVATIONS TO

GOVERNMENT OF CANADA

BUILDING ULUKHAKTOK, NWT

ISSUED FOR TENDER

DESCRIPTION

number du detail

B source drawing no. de dessin no.

C detail on drawing no.

A detail number

REVISIONS

2013.05.09

DATE

A

BC

title titre du dessin

MECHANICAL

EXISTING PLANS

designed by BFG concu par

drawn by BFG dessine par

approved by approuve par

Project Manager Administrateur de Projets

project no.
WBSE # R.023085.001


date


MAY 2013

echelle
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M101

OF 4



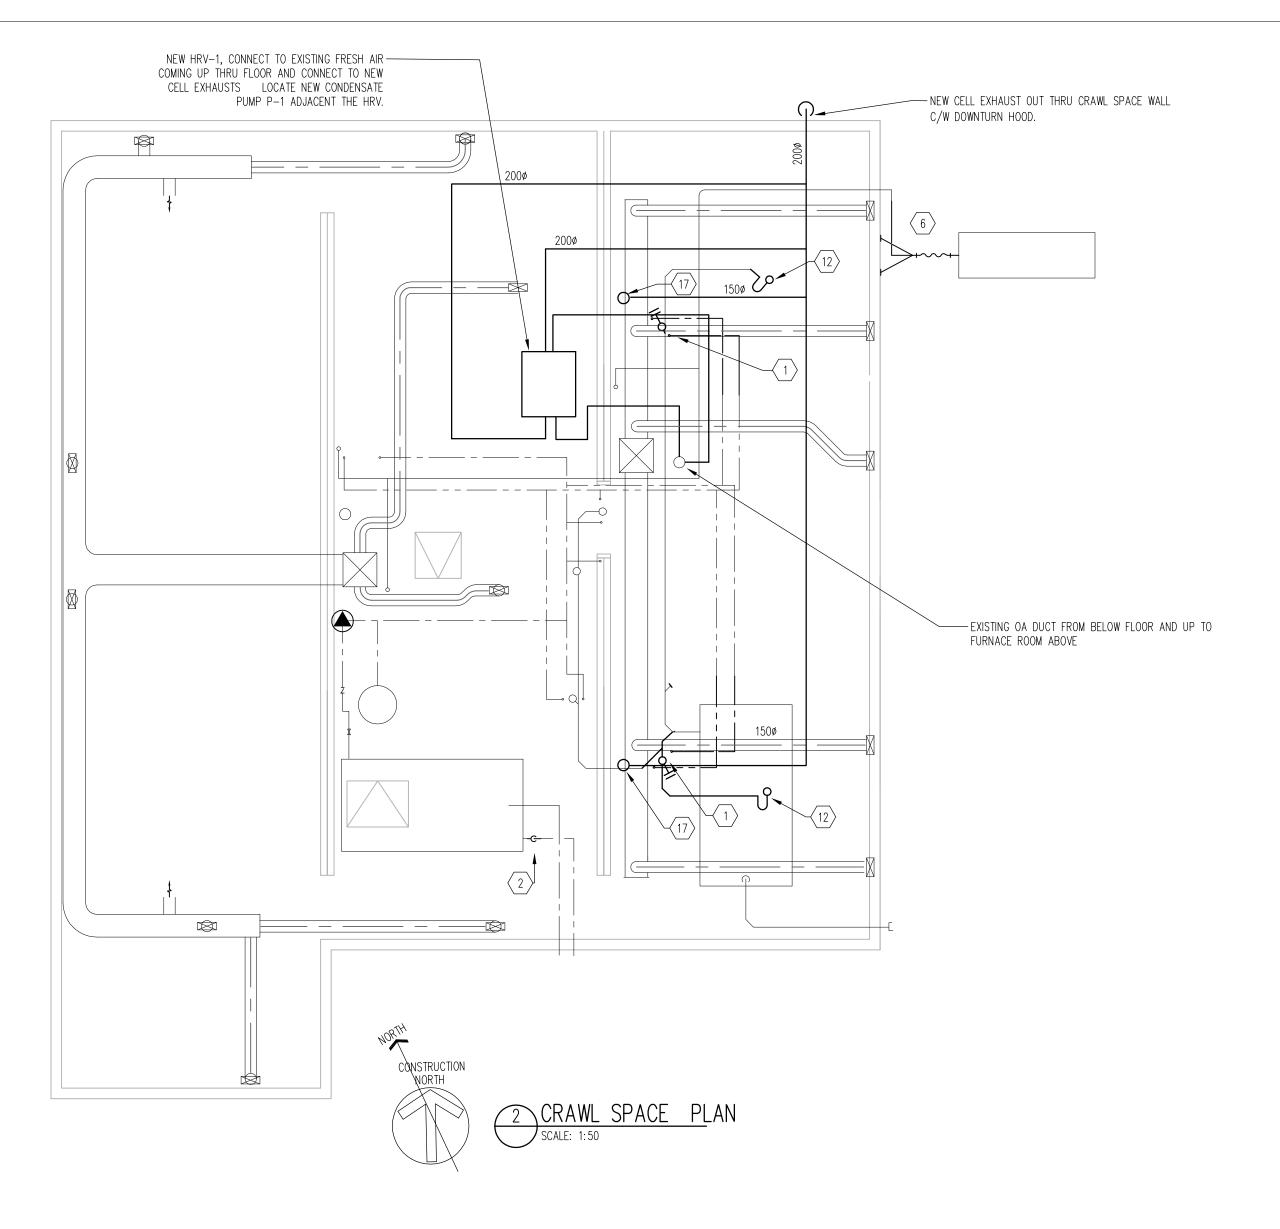

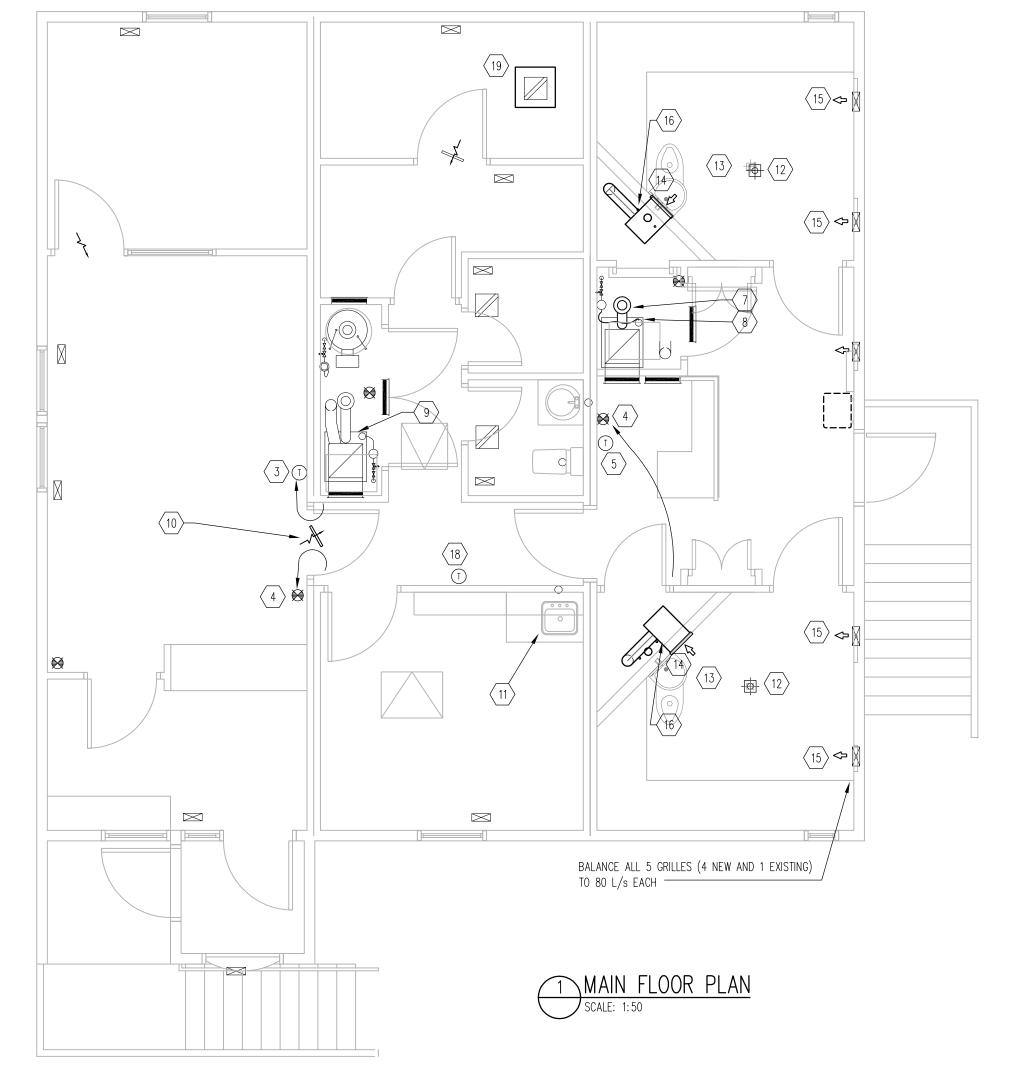



Engineers and Geoscientists


- RUN NEW SANITARY AND WATER LINES TO NEW CELL FIXTURES
- OFFSET WATER FLOW LINE TO TOP OF WATER TANK AND SLOPE LINE OUT TO ORIGINAL BUILDING OVERFLOW
- RELOCATE THERMOSTAT TO OFFICE, REPLACE THERMOSTAT WITH NEW THERMOSTAT
- $\left\langle \begin{array}{c} 4 \end{array} \right\rangle$ RELOCATE FIRE EXTINGUISHERS AS SHOWN (2)
- 5 REPLACE THERMOSTAT WITH NEW THERMOSTAT
- REPLACE EXISTING PIPING BETWEEN OIL TANK AND BUILDING WITH NEW PIIPING AND SHORTNED FLEX.
 PROVIDE RIGID HANGERS OFF OF BUILDING TO SUPPORT
- 7 REPLACE EXISTING CHIMNEY AND BREECHING ON F-2.
- REPIPE EXISTING FLEXIBLE CONNECTION TO EXISTING TIGER LOOP SO THAT FURNACE COVER CAN BE PROPERLY INSTALLED. INSTALL FURNACE COVER. 9 INSTALL EXISTING FURNACE COVER.
- NEW DOOR GRILLE 550x500 PRICE ATGH HEAVY DUTY ALUMINUM DOOR GRILLE ARRANGEMENT B MOUNTING.
- RELOCATE EXISTING KITCHEN SINK INTO NEW COUNTER, PROVIDE NEW TRIM REMOVE EXISTING FLOOR DRAIN IN THE CELLS AND REPLACE WITH A NEW FLOOR DRAIN INSTALLED SLIGHTLY
- BELOW GRADE WITH SECURITY SCREWS. RELOCATE FLOOR


 ORAIN AND ADJUST NEW FLOOR DRAIN FOR NEW PLYWOOD

 PROVIDE NEW DRIP SHIELD UNDER THE EXISTING EXHAUST

 FAN. SEE DETAIL 8 DRAWING M102 DRAIN AND ADJUST NEW FLOOR DRAIN FOR NEW PLYWOOD UNDERLAYMENT IN CELLS (SEE ARCHITECTURAL). ROUTE OUT FACE OF PLYWOOD TO 3mm DEPTH TO ALLOW GRILLE FRAME TO BE FLUSH WITH PLYWOOD, AND APPLY EPOXY SEALANT TO ENTIRE PERIMETER OF FLOOR DRAIN

- REMOVE EXISTING SS WATER CLOSETS AND REPLACE WITH NEW WATER CLOSETS IN THE NEW LOCATION, AND CONNECT ALL THE PLUMBING PIPING AS REQUIRED. TYPICAL OF 2. APPLY EPOXY SEALANT TO ENTIRE PERIMETER OF NEW WATER CLOSET WHERE UNIT MEETS THE FLOOR AND WALL.
- REMOVE EXISTING EA GRILLES FROM CEILING AND REPLACE WITH NEW 311X311 SECURITY GRILLES IN THE NEW LOCATION ON THE WALL (TYPICAL OF 2 GRILLES IN EACH CELL) AND CONNECT ALL THE DUCTED FANS AS REQUIRED. ROUTE OUT FACE OF PLYWOOD TO 3mm DEPTH TO ALLOW GRILLE FRAME TO BE FLUSH WITH PLYWOOD FACE, AND APPLY EPOXY SEALANT TO ENTIRE PERIMETER OF GRILLE FRAME.
- REMOVE EXISTING 356X152 SA GRILLES FROM WALL AND REPLACE WITH NEW 356X152 SECURITY GRILLES (TYPICAL OF 4 GRILLES). ROUTE OUT FACE OF PLYWOOD TO 3mm DEPTH TO ALLOW GRILLE FRAME TO BE FLUSH WITH PLYWOOD FACE, AND APPLY EPOXY SEALANT TO ENTIRE PERIMETER OF GRILLE FRAME.
- REMOVE EXISTING EXHAUST FANS FROM THE CEILING AND REPLACE WITH NEW EXHAUST FANS (BROAN MODEL L250, 120 V, 830 rpm, 2.1 AMPS, 166 WATTS AND 260 cfm, 2030 DUCT CONNECTOR) IN THE NEW LOCATION ON THE
- 17) NEW EXHAUST FROM MAIN FLOOR
- NEW LOW TEMPERATURE ALARM. WIRE TO ALARM LIGHT AND HORN. SEE ELECTRICAL.

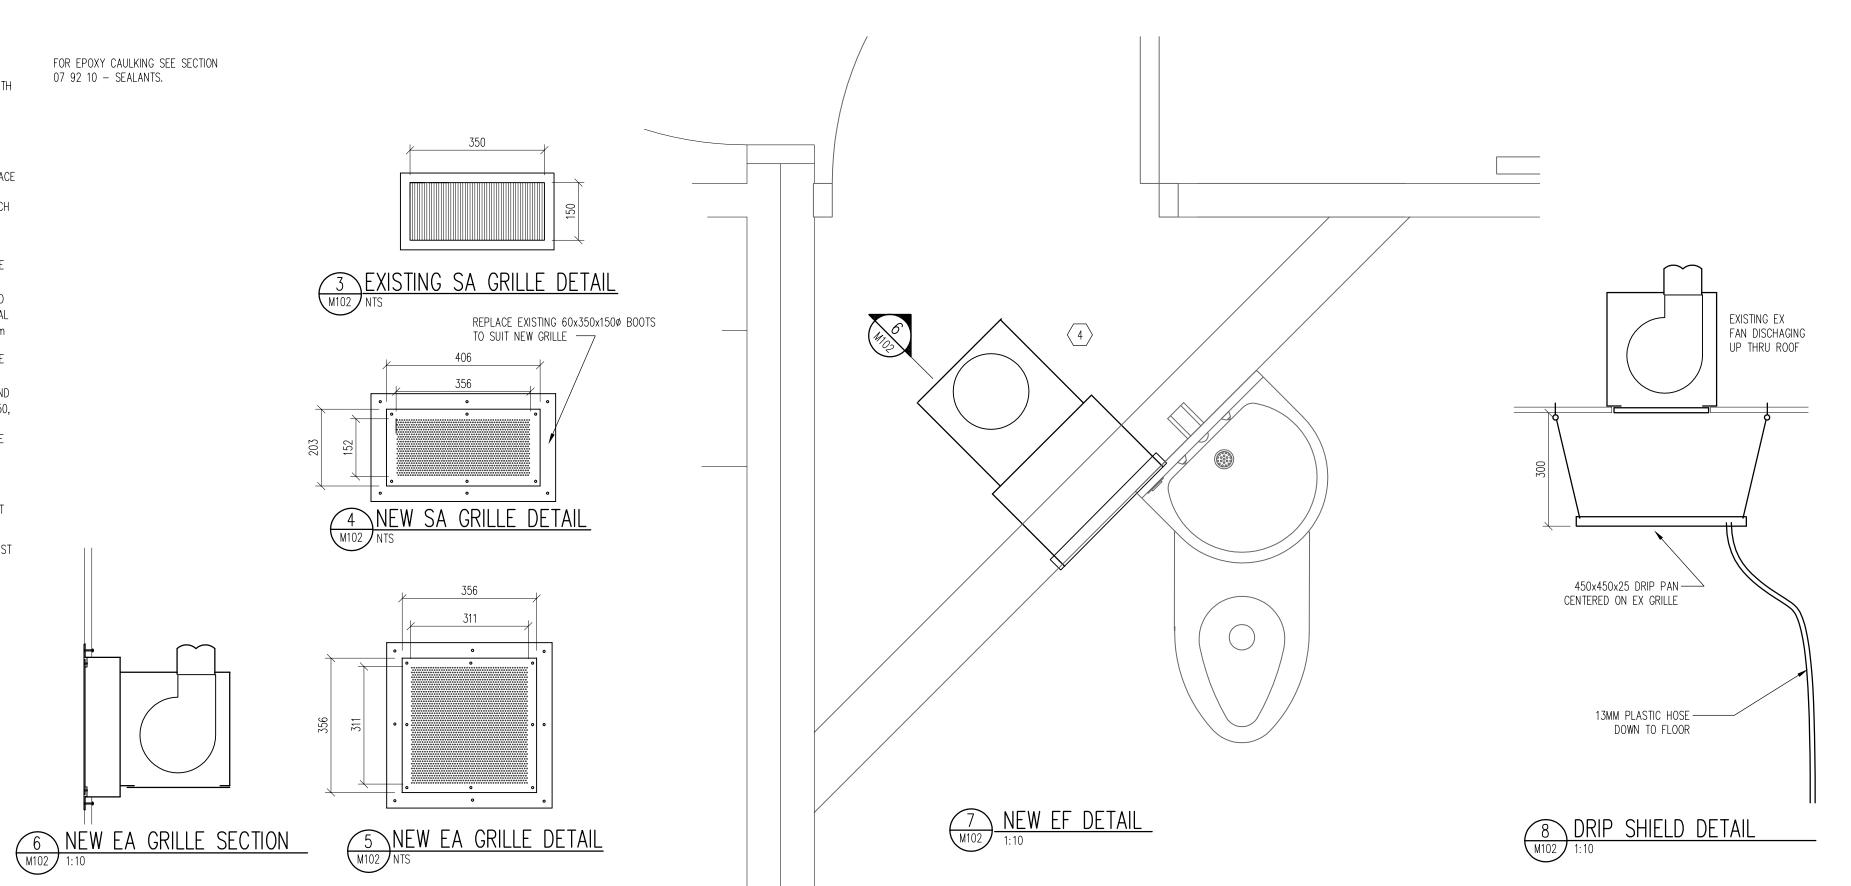

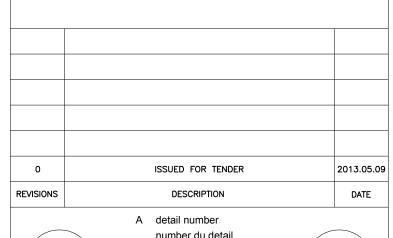


REVISIONS		DESCRIPTION	DATE
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project tit	le	titre	du proje

RENOVATIONS TO GOVERNMENT OF CANADA BUILDING ULUKHAKTOK, NWT


MECHANICAL

titre du dessin

NEW PLANS designed by concu par drawn by dessine par approuve par Project Manager Administrateur de Projets feuille echelle sheet project no.
WBSE # R.023085.001
projet no.

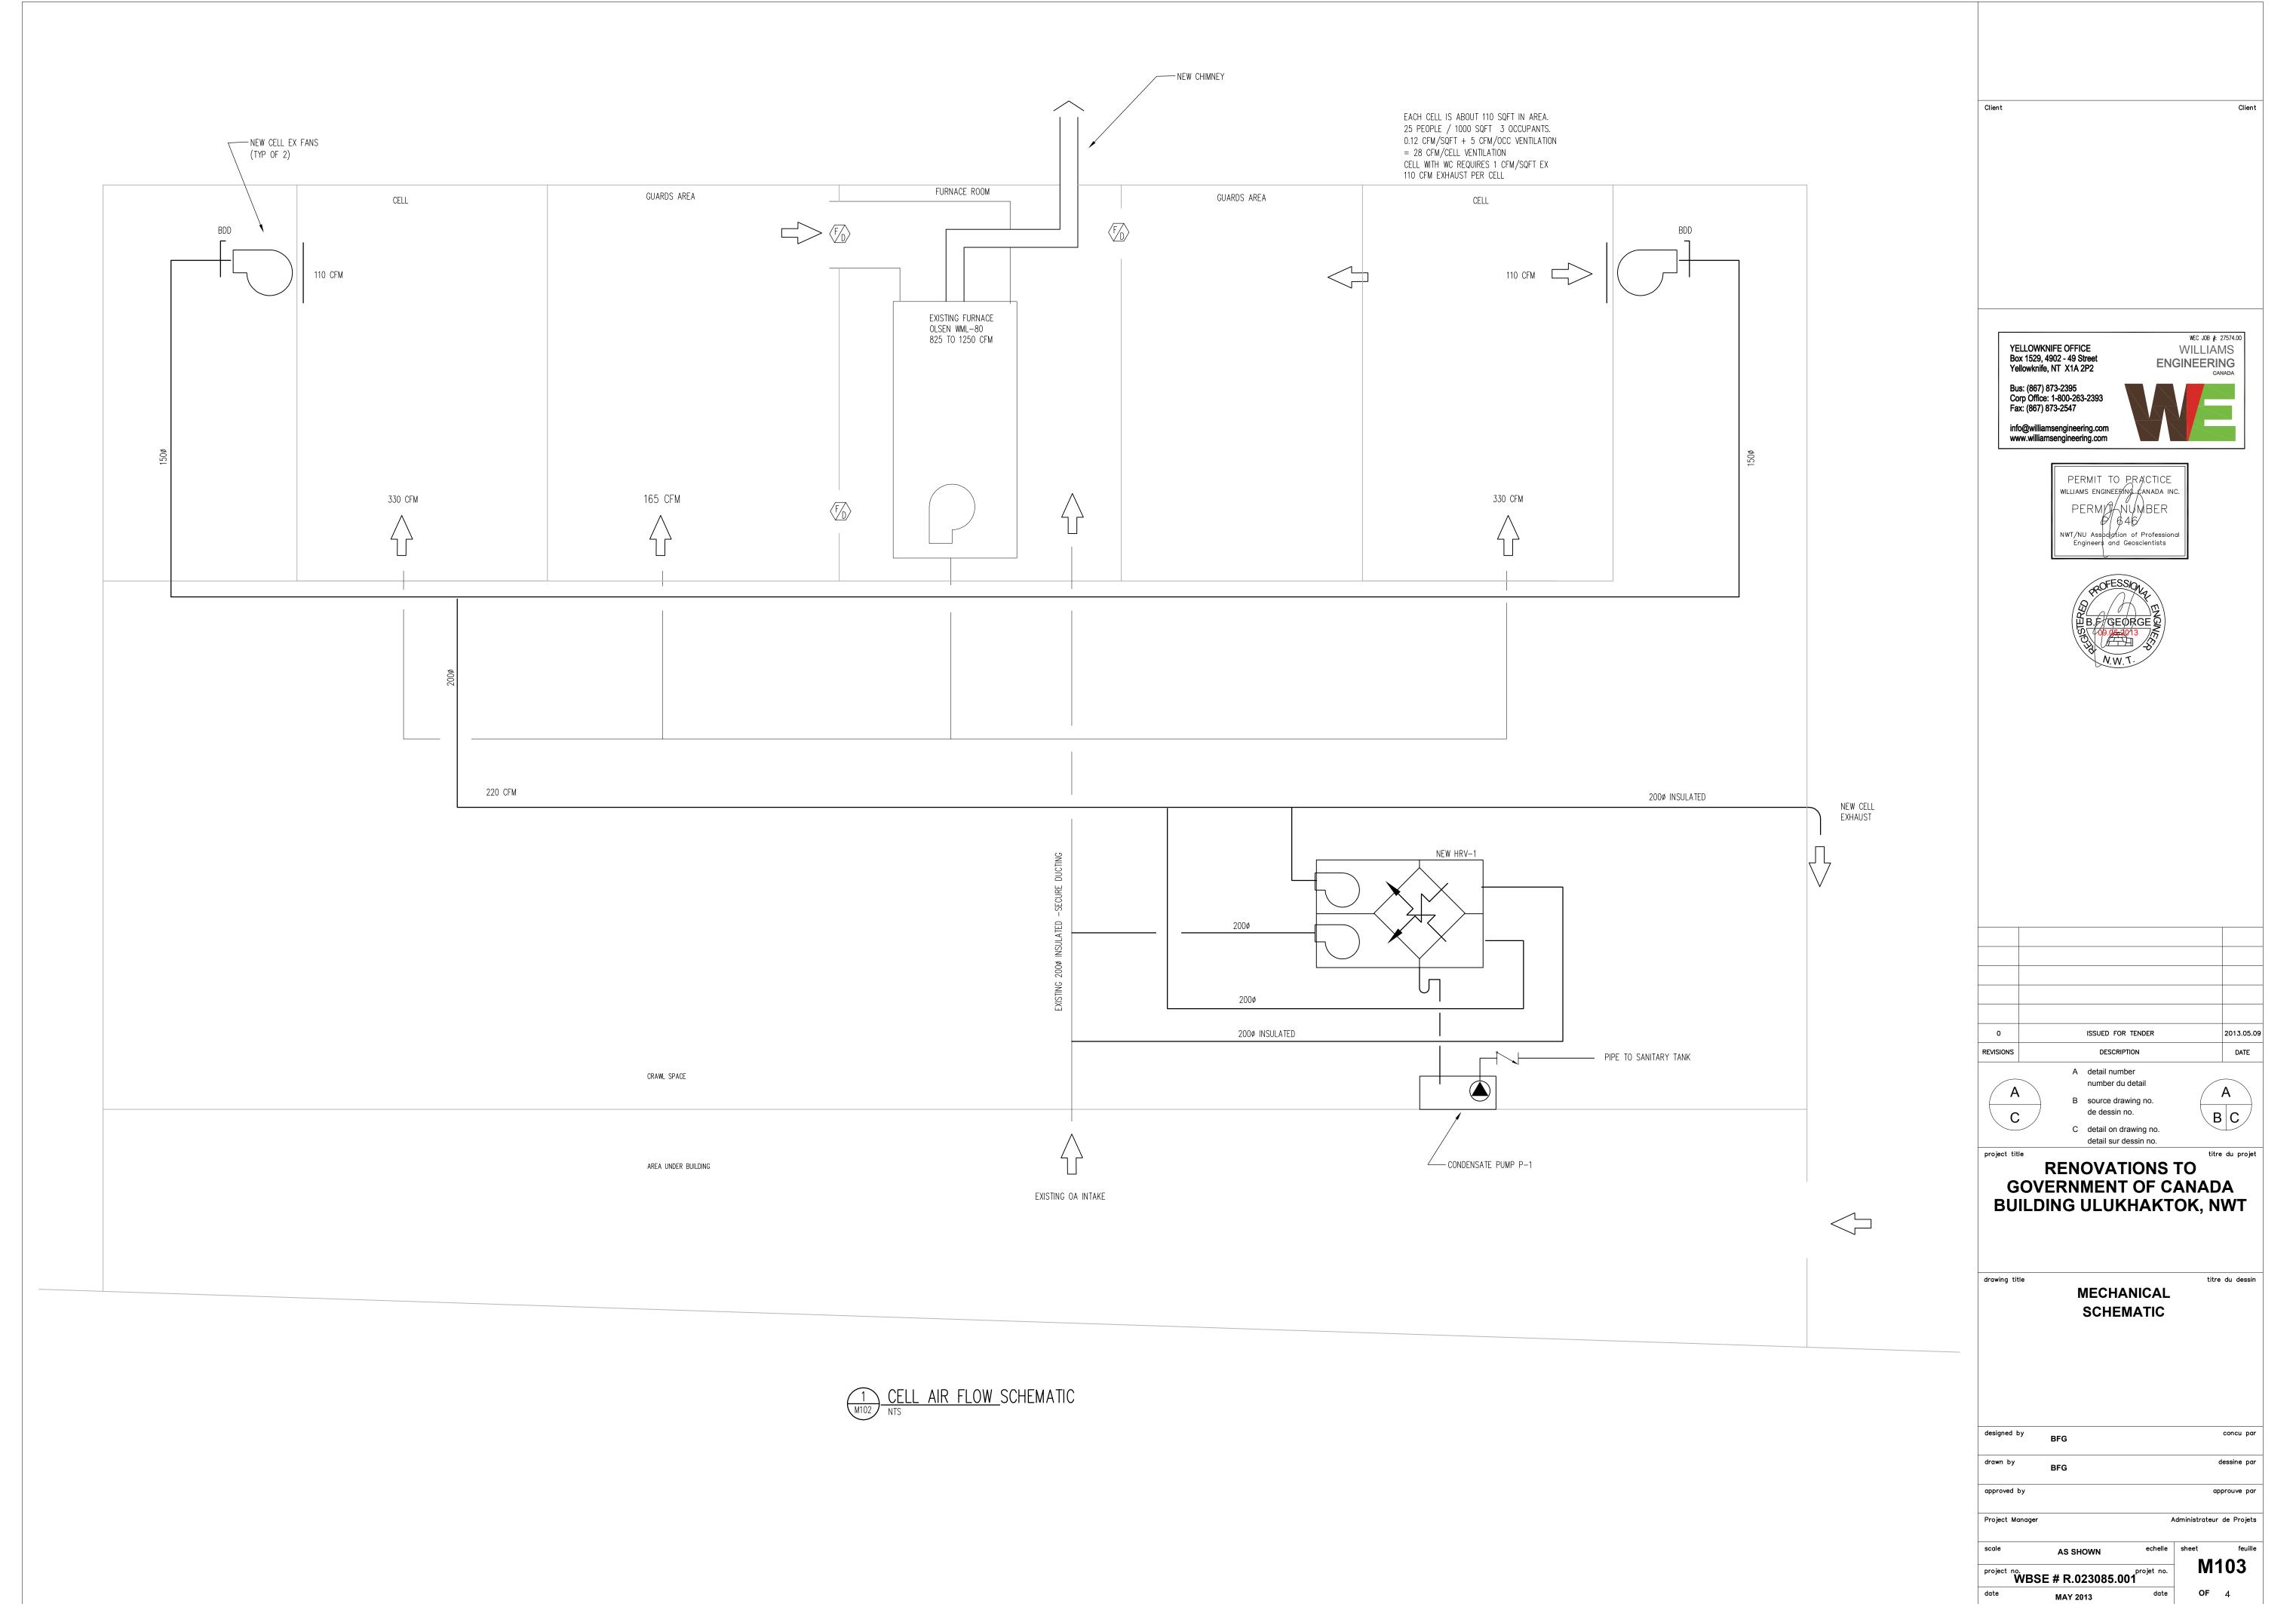


A1 841 x 594

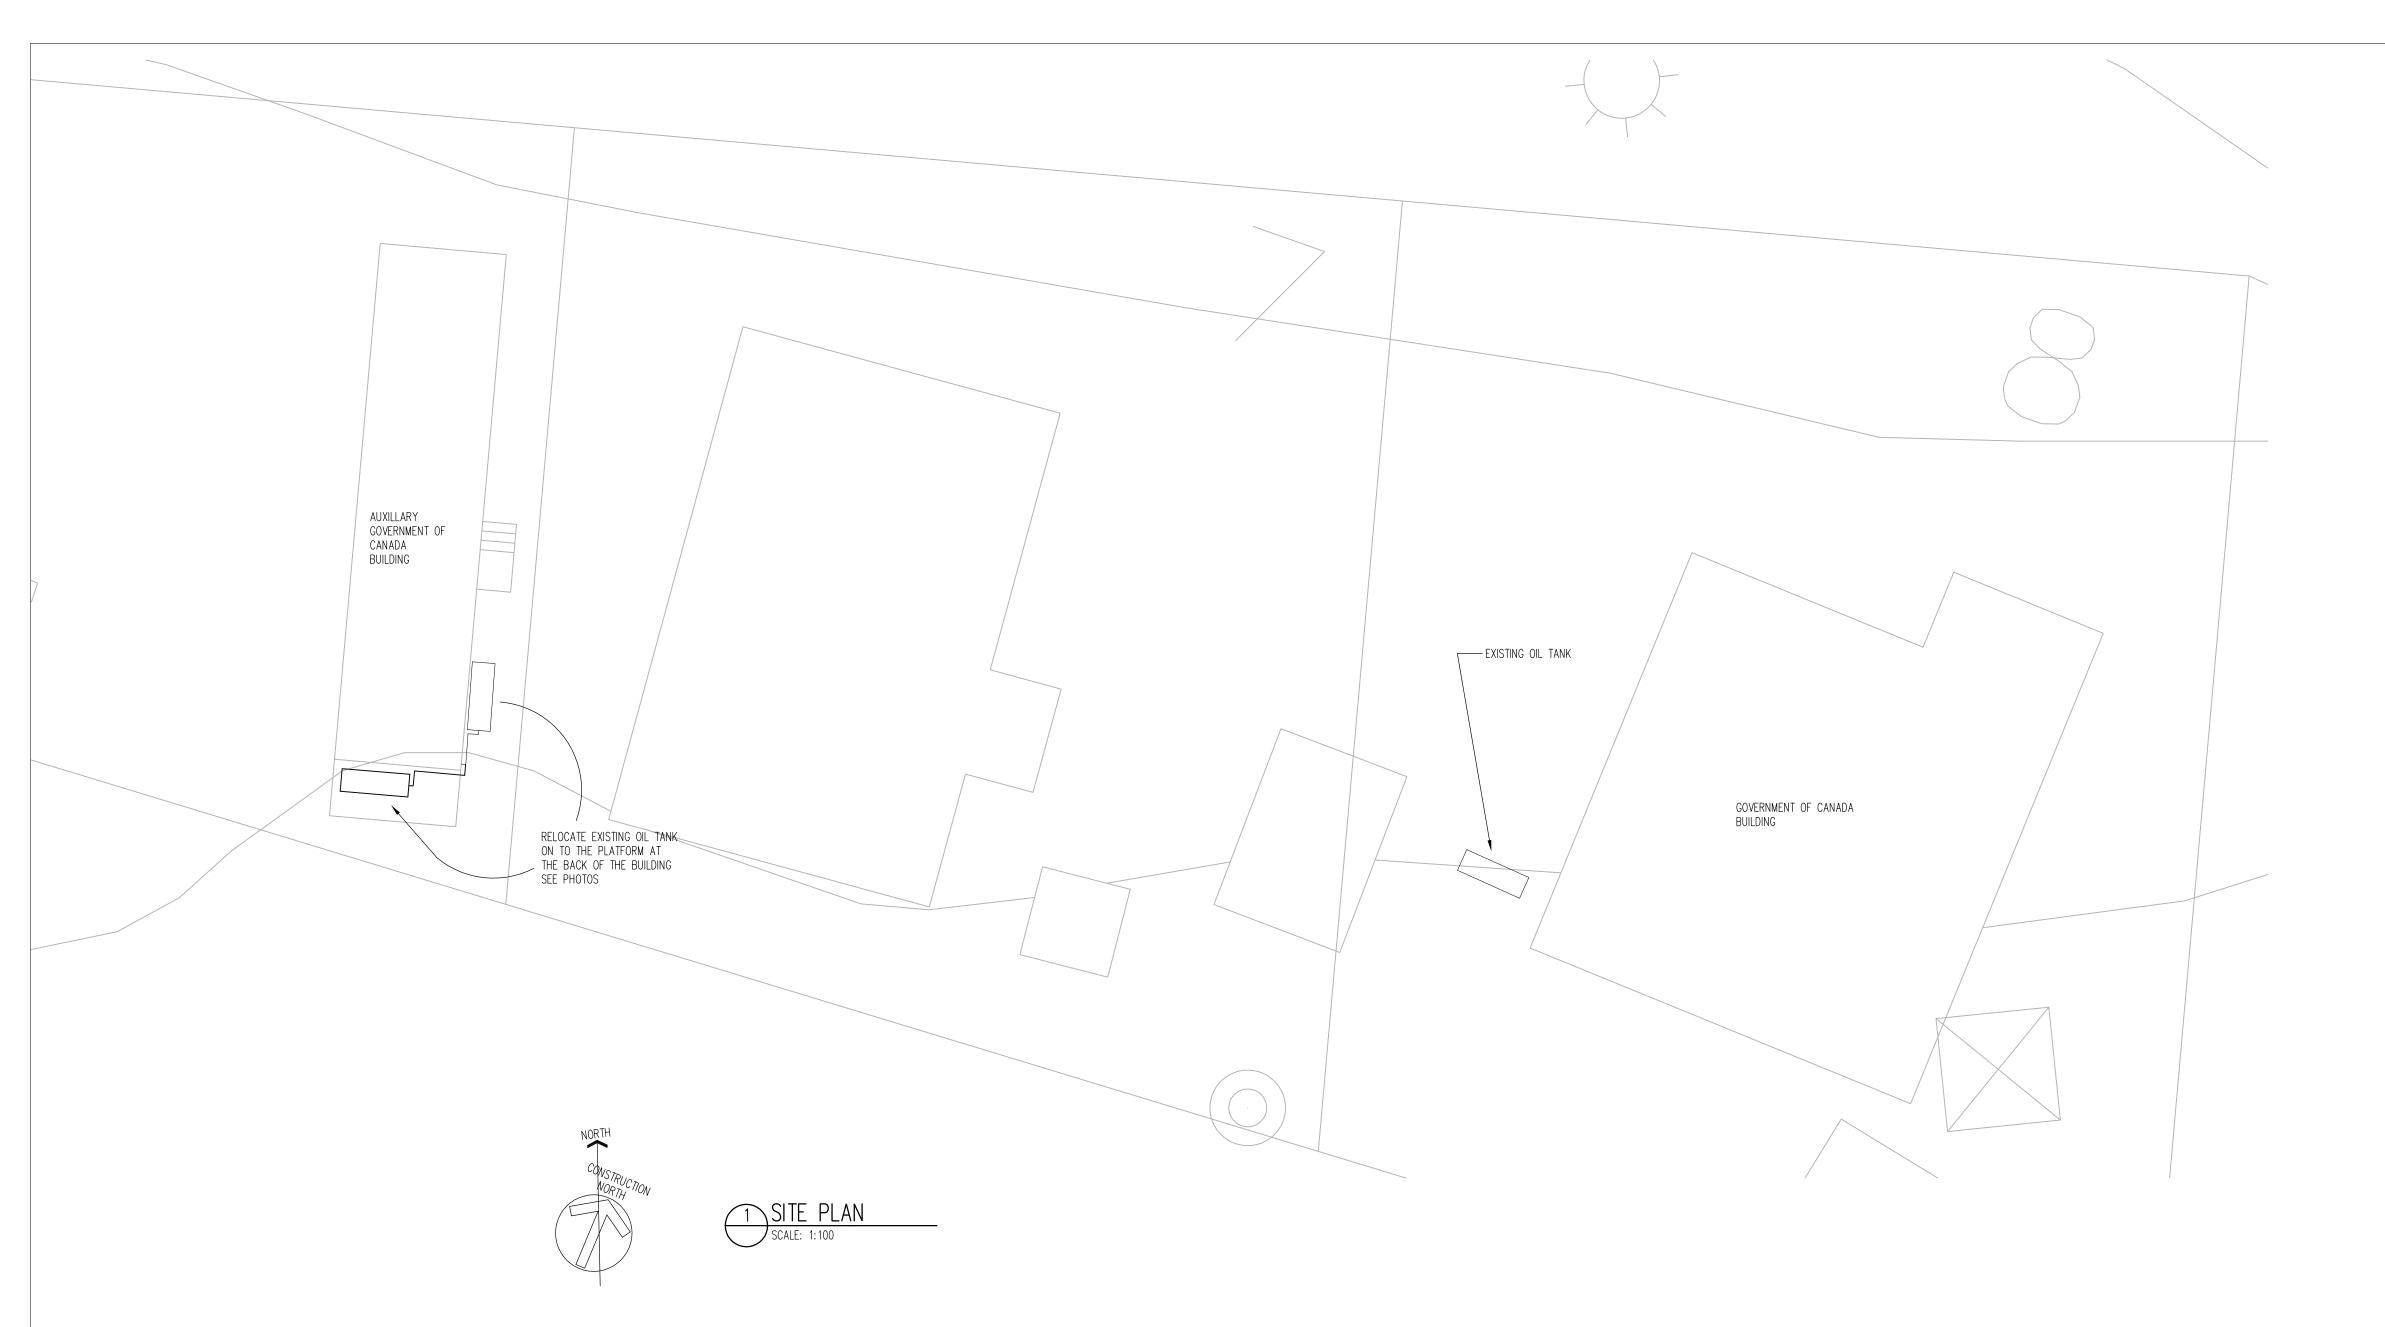




2 EXISTING OIL TANK ARRANGEMENT SCALE: NTS



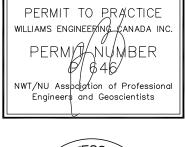



0	ISSUED FOR TENDER	2013.05.0
REVISIONS	DESCRIPTION	DATE
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 B source drawing no. de dessin no.
 C detail on drawing no. detail sur dessin no.
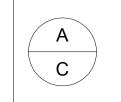
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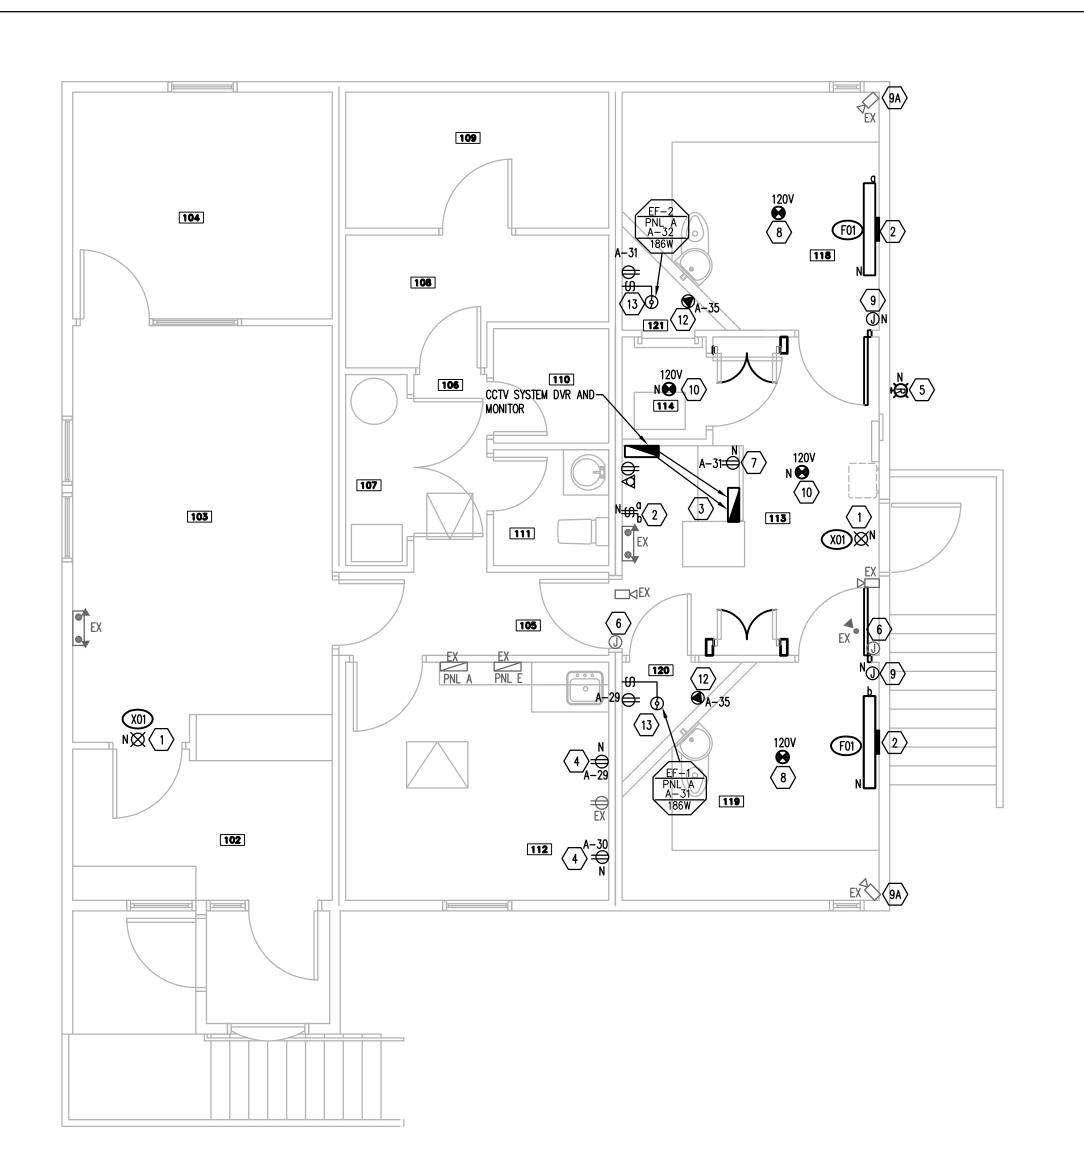
RENOVATIONS TO GOVERNMENT OF CANADA BUILDING ULUKHAKTOK, NWT


MECHANICAL
SITE PLAN

designed by	BFG	concu pa
drawn by	BFG	dessine pa
approved by		approuve pa

Project Manager Administrateur de Projets

scale	AS SHOWN	echelle	sheet	1
project no.		projet no.	M	104
W	BSE # R.023085.0	01		
date	MAY 2013	date	OF	4



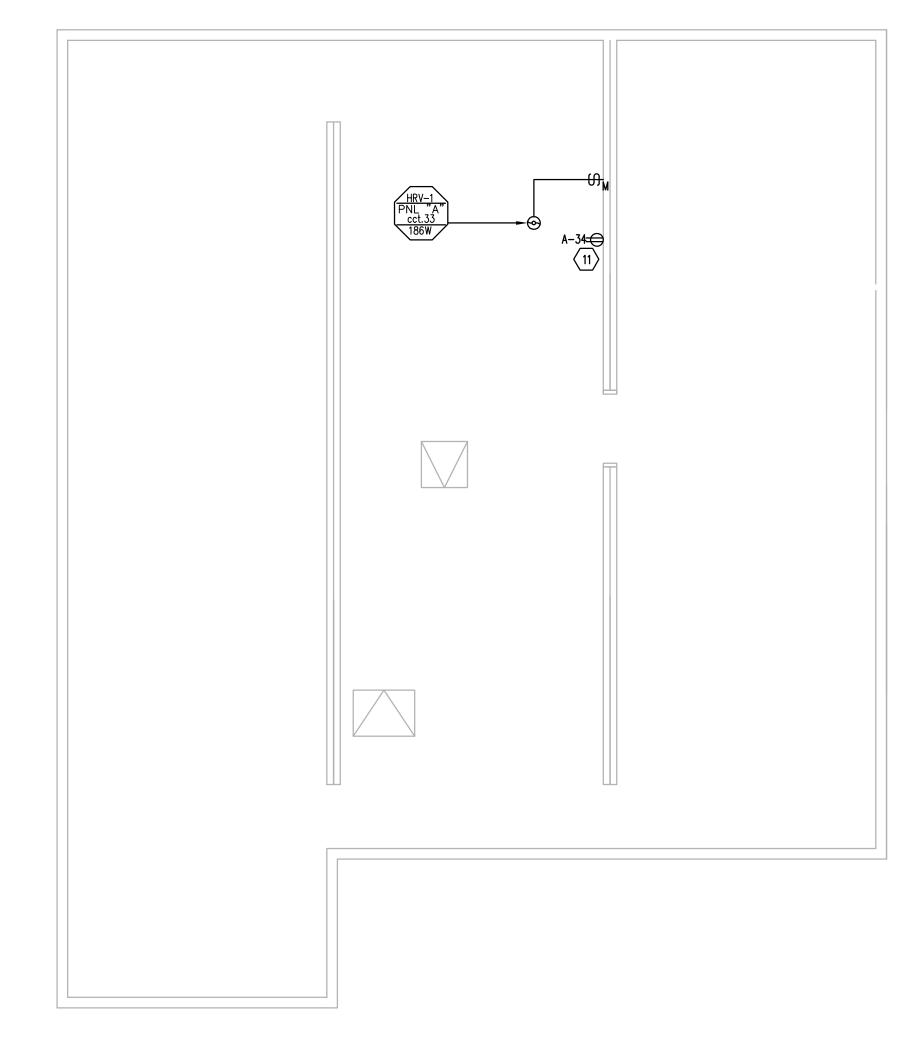



<u>KE</u>

- REMOVE EXISTING EXIT SIGNS AND REPLACE WITH NEW RUNNING MAN PICTOGRAM AS PER 2010 NBC REQUIREMENTS AS INDICATED IN THE LUMINAIRE SCHEDULE. TO BE CONNECTED TO THE EXISTING CIRCUIT.
- REMOVE EXISTING CELL LIGHT FIXTURES AND REPLACE WITH NEW COMPACT FLUORESCENT LIGHT FIXTURE AS INDICATED IN THE LUMINAIRE SCHEDULE. APPLY SECURITY CAULKING AROUND PERIMETER OF NEW LIGHT FIXTURE WHERE UNIT MEETS THE CEILING AND WALL. PROVIDE NEW WIRING AND CONTROL SWITCHES AT THE NEW GUARD STATION. TO BE CONNECTED TO EXISTING CIRCUIT OF THE EMERGENCY PANEL.
- EXISTING CCTV SYSTEM DVR AND MONITOR TO BE RELOCATED TO THE DESKTOP. RELOCATE ALL THE ASSOCIATED POWER AND DATA OUTLETS TO THE SAME LOCATION UNDER THE DESK.
- PROVIDE NEW DEDICATED DUPLEX RECEPTACLES (TOTAL OF 2). TO BE CONNECTED CIRCUIT AS INDICATED c/w 1P-15A BREAKER FOR EACH.
- PROVIDE NEW FLASHING BEACON LIGHT UP HIGH FOR LOW BUILDING TEMPERATURE, TO BE CONNECTED TO NEW THERMOSTAT LOCATED IN CORRIDOR 105. COORDINATE WITH MECHANICAL FOR THE CONNECTIONS.
- EXPOSED JUNCTION BOX AND CONDUIT FOR THE CCTV SYSTEM TO BE BURIED IN THE WALL.
- 7 PROVIDE NEW RECEPTACLE c/w 1P-15A BREAKER FOR BREATHALYZER TO BE CONNECTED TO THE NEXT AVAILABLE CIRCUIT AS INDICATED.
- REPLACE EXISTING CELL SMOKE DETECTORS AND GUARDS WITH NEW 120V LOCAL SMOKE/CO ALARM c/w BATTERY BACKUP. PROVIDE POWER FROM THE NEXT AVAILABLE SPACE IN THE EXISTING PANEL A. SMOKE ALARMS MUST BE INTERCONNECTED SO THAT ACTUATION OF ONE ALARM CAUSES ALL OTHER ALARMS IN THE CELL DETACHMENT TO SOUND.TEST NEW DETECTORS FOR OPERATION ONLY.
- PROVIDE NEW JUNCTION BOX BURIED IN THE WALL c/w CONDUIT AND WIRING BACK TO THE GUARD STATION TO MATCH THE EXISTING FOR THE FUTURE SECURITY CAMERAS. COORDINATE WITH OWNER FOR THE EXACT LOCATION AT SITE.
- REMOVE EXISTING CAMERA. REMOVE WIRING UP TO THE NEAREST JUNCTION BOX.
- PROVIDE A NEW 120V LOCAL SMOKE/CO ALARM c/w
 BATTERY BACKUP. PROVIDE POWER FROM THE NEXT
 AVAILABLE SPACE IN THE EXISTING PANEL A. SMOKE
 ALARMS MUST BE INTERCONNECTED SO THAT ACTUATION
 OF ONE ALARM CAUSES ALL OTHER ALARMS IN THE CELL
 DETACHMENT TO SOUND.TEST NEW DETECTORS FOR
 OPERATION ONLY.
- PROVIDE NEW RECEPTACLE FOR NEW CONDENSATE PUMP (P-1). COORDINATE WITH MECHANICAL
- PROVIDE NEW HARDWIRE CONNECTION FOR WATER CLOSET,
 TO BE CONNECTED TO EXISTING PANEL A c/w 15AMP
 CIRCUIT BREAKER AS SHOWN ON THE DRAWING.
 COORDINATE WITH MECHANICAL.
- REMOVE EXISTING EXHAUST FAN CONNECTION AND DISCONNECT SWITCH AND WRING BACK TO NEAREST ACCESSIBLE JUNCTION BOX. PROVIDE NEW EXHAUST FAN CONNECTION AND DISCONNECT SWITCH AS INDICATED. COORDINATE WITH MECHANICAL.

E	LECTRICAL SYMBOL LEGEND
DESCRIPTORS:	N = NEW DEVICE EX = EXISTING TO REMAIN
₫Ф	SHADED DEVICES ARE INDICATIVE OF EXISTING DEVICES TO REMAIN
	LUMINAIRE, FLUORESCENT, WALL MOUNT
F01	DESCRIPTOR-LUMINAIRE (FIXTURE TAG); E.G. F01 = LUMINAIRE TYPE F01
蔥	LIGHT, STROBE R = RED
×	EXIT SIGN, CEILING MOUNT
⊶	CIRCUIT BREAKER
€	RECEPTACLE, DUPLEX, WALL MOUNT
0	JUNCTION BOX
\forall	SERVICE ENTRANCE WEATHERHEAD
•	SPECIAL POWER CONNECTION
⊗	MOTOR CONNECTION
T	THERMOSTAT — LINE VOLTAGE
90	SWTCH, MANUAL TRANSFER
0	CABINET, UTILITY METER
•	ALARM, SMOKE/CO
	CAMERA, FIXED
◁	JACK, LOCAL AREA NETWORK (LAN), WALL MOUNT

GENERAL NOTES:

<u>WIRING METHOD</u>

INSULATION.

1. WIRING SHALL BE OF NMD90 CABLE.

CONNECTION TO FIXTURES.

<u>CIRCUITING GUIDELINES</u>

SEPARATED BY MINIMUM OF 300mm.

CIRCUIT C/W ZONE SENSING RELAY.

5. MINIMUM OF 10% SPACES BE ALLOWED IN NEW PANEL.

2. 120-V POWER WIRING OF BE MINIMUM #12 AWG COPPER WITH XLPE RW90

3. CONCEALED BX (AC90) CABLE MAY BE USED IN SHORT LENGTHS FOR FINAL

4. ELECTRICAL DEVICE BOXES SHOULD NOT BE INSTALLED BACK TO BACK AND

5. ALL PENETRATIONS THROUGH FIRE WALLS ARE TO BE FIRE—SEALED.

1. LIGHTING CIRCUITS TO BE LOADED TO 1200 WATTS MAXIMUM PER 15 AMP

2. A MAXIMUM OF 4 RECEPTACLES PER CIRCUIT BE PROVIDED FOR GENERAL

3. GROUNDING AND BONDING CONDUCTORS BE PROVIDED AS PER C.E.C.

PURPOSE LOADS. DESIGNATED KITCHEN EQUIPMENT BE FED A DEDICATED

4. EXIT SIGNS AND EMERGENCY LIGHTING TO BE ON THE SAME SINGLE DEDICATED

- CONTRACTOR TO ENSURE WIRING AND CONDUITS TO BE RE-USED ARE TO BE VERIFIED FOR THEIR CONDITION, OTHERWISE PROVIDE NEW.
- 2. DURING CONSTRUCTION, REMOVE/DISCONNECT DVR AND MONITOR AND KEEP OUT OF CONSTRUCTION SITE IN THE DETACHMENT AREA. COORDINATE WITH OWNER.
- 3. COVER AND SEAL EXISTING CAMERAS TO PREVENT CONTAMINATION WITH DUST/DEBRIES.
- 4. WHEN RELOCATING CABLING FOR THE VIDEO SIGNAL AND CAMERA POWER, DO NOT SPLICE OR EXTEND CABLING.
- 5. BNC CONNECTORS CAN NOT BE "TWIST-ON TYPE", ONLY
- "CRIMP—TYPE" OR "PRESS—ON TYPE" IS ACCEPTABLE.
 6. IF CABLING REPLACEMENT IS REQUIRED, CONTACT G. DIV.

PTSS FOR SPECIFICATION AND/OR POSSIBLE SUPPLY.

09/05/2013 III J. BALAKRISHNAN ON THE PROPERTY OF THE PROPERT

YELLOWKNIFE OFFICE

Box 1529, 4902 - 49 Street

Yellowknife, NT X1A 2P2

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info@williamsengineering.com www.williamsengineering.com

PERMIT TO PRACTICE WILLIAMS ENGINEERING CANADA INC.

PERMIT NUMBER P 646

NWT/NU Association of Professional Engineers and Geoscientists

0	issued for tender	2013.05.09
REVISIONS	DESCRIPTION	DATE



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 B source drawing no.
 de dessin no.

 C detail on drawing no.
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WEC JOB # 27574.00

WILLIAMS

ENGINEERING

RENOVATIONS TO GOVERNMENT OF CANADA BUILDING ULUKHAKTOK, NWT

detail sur dessin no.

drawing title titre du dessin

ELECTRICAL LAYOUT

MAIN FLOOR

& CRAWL SPACE

designed by	M.S.M/MC	concu par
drawn by	M.S.M/MC	dessine par
approved by	JAB/MS	approuve par
Project Manager		Administrateur de Proiets

sheet feu	echelle sheet	AS NOTED	scale
E101	projet no.	/BSE # R.023085	project no.
	01	/BSE # R.023085	WE
OF 2	date (MAY 2013	date

1 MAIN FLOOR PLAN SCALE 1:50


	LUMINAIRE SCHEDULE								
TYPE	MANUFACTURER	CATALOG NO.	DESCRIPTION	LAMPS	BALLAST	MOUNTING			
F01	COOPER LIGHTING	FCC-X-232-120-86-EB82	TWO (2) TUBE FLUORESCENT CORNER LIGHT FIXTURE.	2 X 32 W T8	ELECTRONIC	WALL MOUNT			
X01	LUMACELL	LS1WUTP	EMERGENCY LIGHTING EXIT SIGN, SINGLE FACE, RUNNING MAN PICTOGRAM	LED	N/A	UNIVERSAL MOUNT 120VAC / 24VDC			

MECHANICAL EQUIPMENT SCHEDULE																
EQUIP.				VOLT/	STARTER AND ACCESSORIES REMOTE OF BREAKER						FEEDER	REMARKS				
No.	DESCRIPTION	LOCATION	W (HP)	PHAŚE	SIZE	MAN.	MAG.	ON/OFF	P.L.	H.O.A.	V.F.D.	CONTROL	CCT. No.	SIZE	FELDER	NEMARKS
EF-1	EXHAUST FAN-1	ROOM 120	186 W	120V / 1ø				Х	X				A-31	1P-15A	16C-2 # 12	NOTE 1
EF-2	EXHAUST FAN-2	ROOM 121	186 W	120V / 1ø				X	X				A-32	1P-15A	16C-2 # 12	NOTE 1
HRV-1	HEAT RECOVERY VENTILATOR	CRAWL SPACE	186 W	120V / 1ø		х			Х				A-33	1P-15A	16C-2 # 12	NOTE 1

NOTES: 1. PROVIDE DISCONNECTION SWITCH AND CONTROL WIRING AS PER CEC; CONTROLS BY MECHANICAL

A1 841 x 594


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RESIDENCE HOUSE FLOOR PLAN

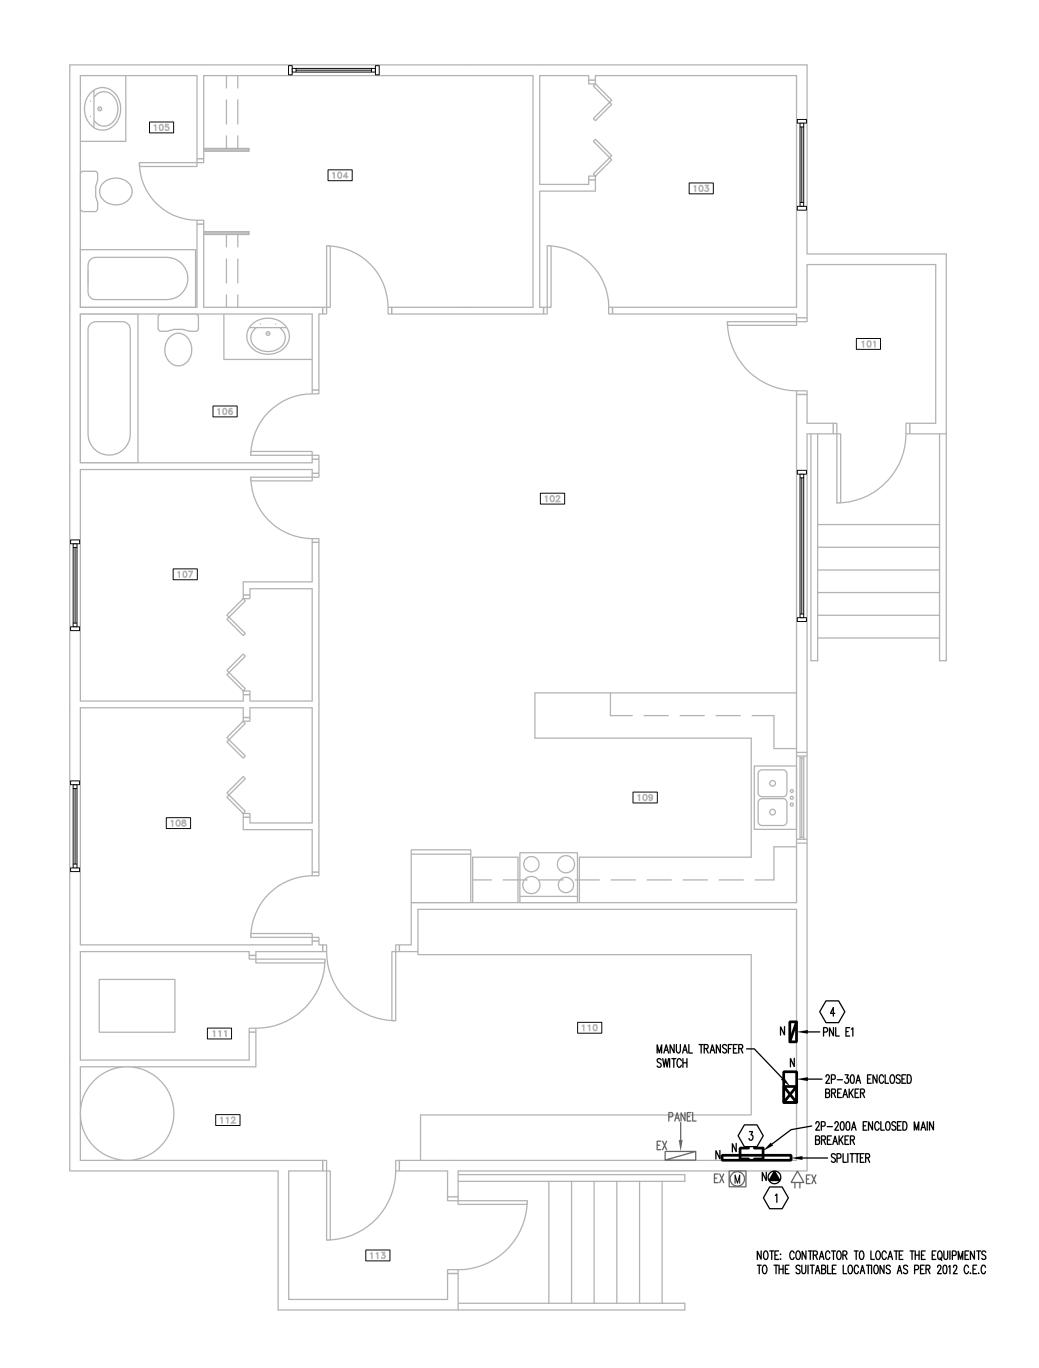ED-2 SCALE 1:50

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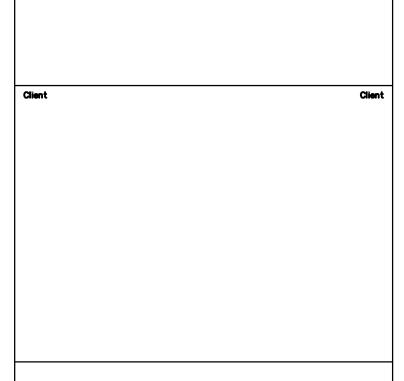
2 MODIFIED SINGLE LINE DIAGRAM
ED-2 SCALE: NTS

KEYNOTES:


- PROVIDE L6-30R TWIST-LOCK RECEPTACLE ON EXTERIOR OF BUILDING FOR CONNECTION OF PORTABLE GENSET.
- PROVIDE NEW 10, 120/240V, 30A MANUAL TRANSFER SWITCH TO PROVIDE EMERGENCY POWER TO NEW PANEL E1 FROM PORTABLE GENSET.
- PROVIDE NEW 2P-200A MAIN BREAKER. FEEDERS TO MATCH THE EXISTING AND AS REQUIRED BY THE LATEST CANADIAN ELECTRICAL CODE.
- PROVIDE NEW 10, 120/240V, 30A, 24 CIRCUITS SURFACE MOUNT EMERGENCY PANEL (PNL E1) c/w 100A BUS BAR. CONTRACTOR TO RELOCATE THE EMERGENCY LOAD FROM THE EXISTING PANEL TO THE NEW EMERGENCY PANEL (PNL E1).

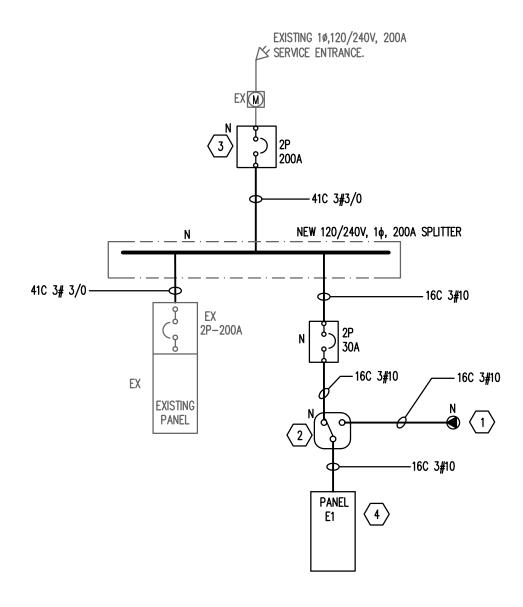GENERAL NOTES:

ASSUMING EMERGENCY LOAD ARE HEATING SYSTEMS AND NIGHT LIGHTS. CONTRACTOR TO ENSURE THE EMERGENCY LOAD IS NOT EXCEEDING THE L6-30R TWIST-LOCK RECEPTACLE CAPACITY. COORDINATE WITH THE OWNER FOR THE EXACT REQUIREMENTS AT SITE.




YELLOWKNIFE OFFICE Box 1529, 4902 - 49 Street Yellowknife, NT X1A 2P2 Bus: (867) 873-2395 Corp Office: 1-800-263-2393 Fax: (867) 873-2547 info@williamsengineering.com www.williamsengineering.com

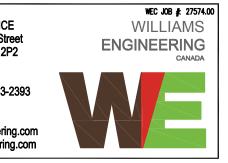

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drawing title

A detail number number du detail

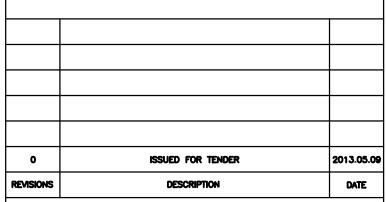B source drawing no. de dessin no.

C detail on drawing no.



RENOVATIONS TO GOVERNMENT OF CANADA **BUILDING ULUKHAKTOK, NWT**

detail sur dessin no.

titre du dessin **ELECTRICAL LAYOUT RESIDENCE HOUSE**

FLOOR PLAN & SINGLE LINE DIAGRAM

designed by	M.S.M	concu p
drawn by	M.S.M	dessine p
approved by	JAB/MS	approuve p

Project Manager E102 project no. WBSE # R.023085.001 projet no. OF 2

CADFLNM