



TRAFFIC CONTROL PANEL (CP-6)


SCALE 1 1/2"=1'-0"

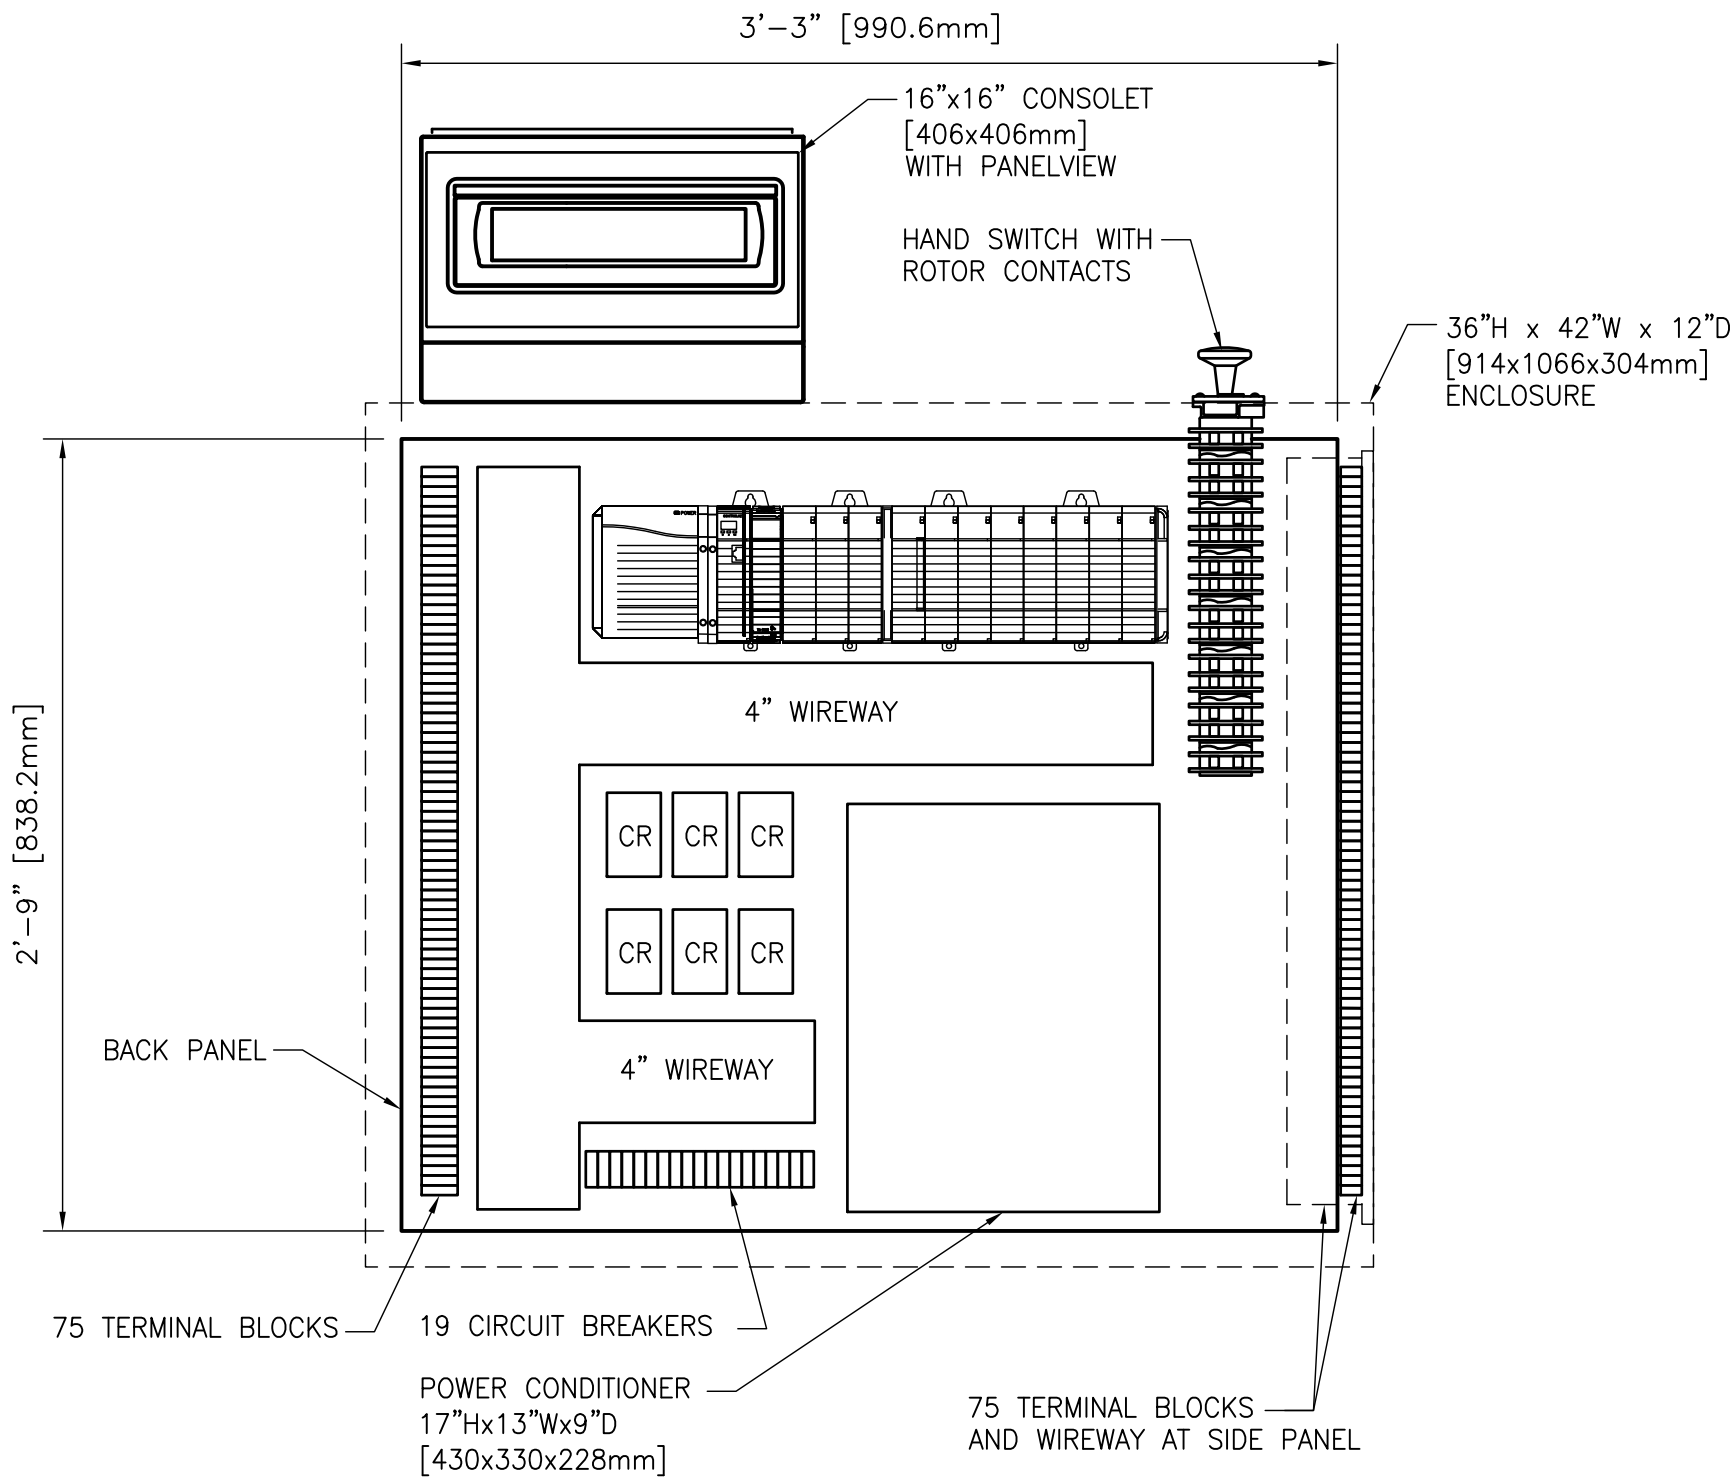

SIDE VIEW

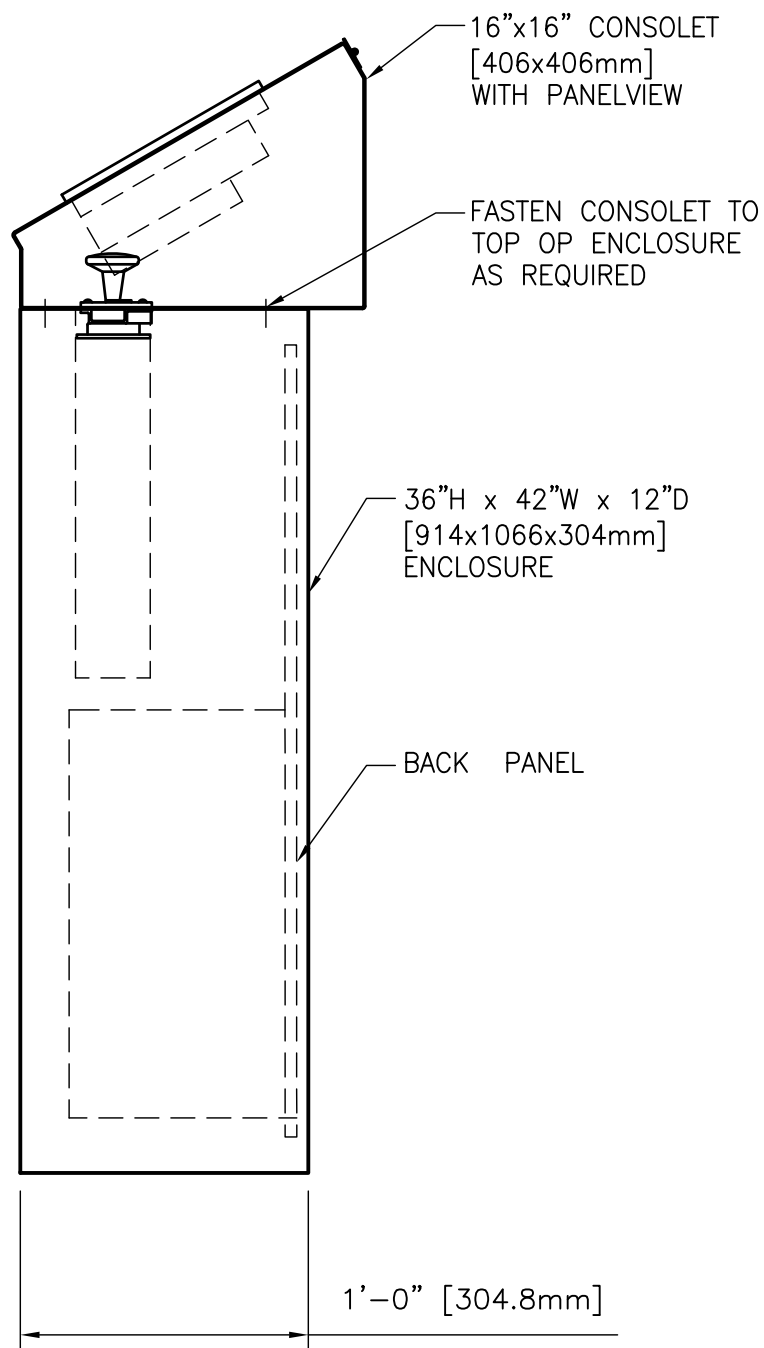

SIDE VIEW

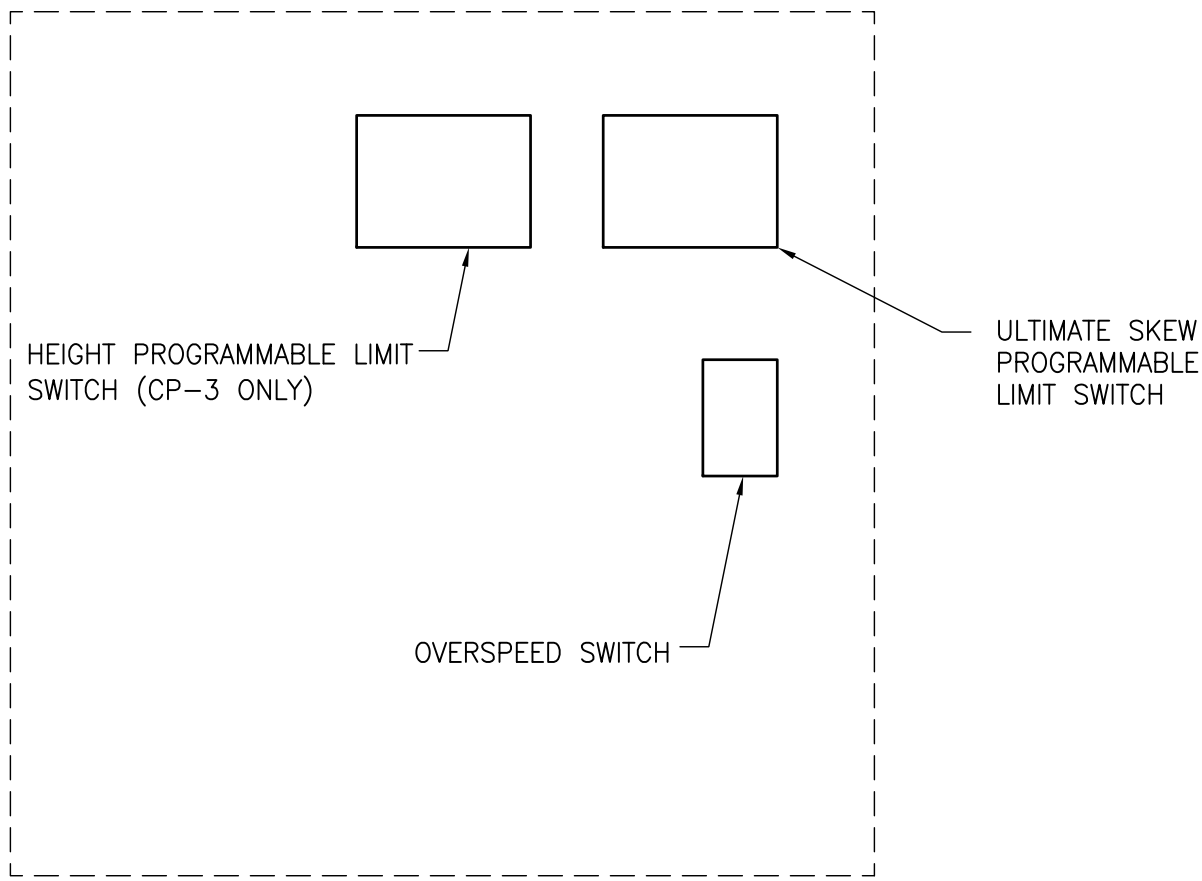

DOOR (FRONT VIEW)

NORTH AND SOUTH I/O PANEL (CP-3 & CP-4)

SCALE 1 1/2"=1'-0"

- NOTES:
1. FOR LOCATIONS OF PANELS CP-3 AND CP-4, REFER TO DRAWINGS E-12 AND 2-13.

*Mark VanDeRee* 2013-07-08



07	FOR TENDER 2	2013-06-30
06	FOR TENDER	2013-06-04
05	FINAL DESIGN COMPLETION	2013-05-31
04	99% DESIGN COMPLETION	2013-05-31
03	90% DESIGN SUBMITTAL	2013-03-31
02	66% DESIGN SUBMITTAL	2013-02-14
01	33% DESIGN SUBMITTAL	2012-12-10

revision		date
Do not scale drawings. Verify all dimensions and conditions on site and immediately notify the Departmental Representative of all discrepancies.		

A	Detail No. No. du détail
B	drawing no. - where detail required dessin no. - où détail exigé
C	drawing no. - where detailed dessin no. - où détaillé

project title  
titre du projet

**HAMILTON ONTARIO  
BURLINGTON CANAL  
VERTICAL LIFT BRIDGE  
REPLACEMENT OF CONTROLS,  
DRIVES AND OVERHEAD CABLES**

drawing title  
titre du dessin

**ELECTRICAL DETAILS 1**

drawn by  
dessiné par

**J. Perez**

designed by  
conc par

**G. Patino/B. Crouthamel**

approved by  
approuvé par

**M. Vanderee**

bid  
soumission

**A. Ghubril**

project manager  
administrateur de projets

project date  
date du projet

**2013-05-31**

project no.  
no. du projet

**R.012641.001**

drawing no.  
dessiné no.

**E-94**