



GROUND FLOOR PLAN

SCALE 1/4"=1'-0"

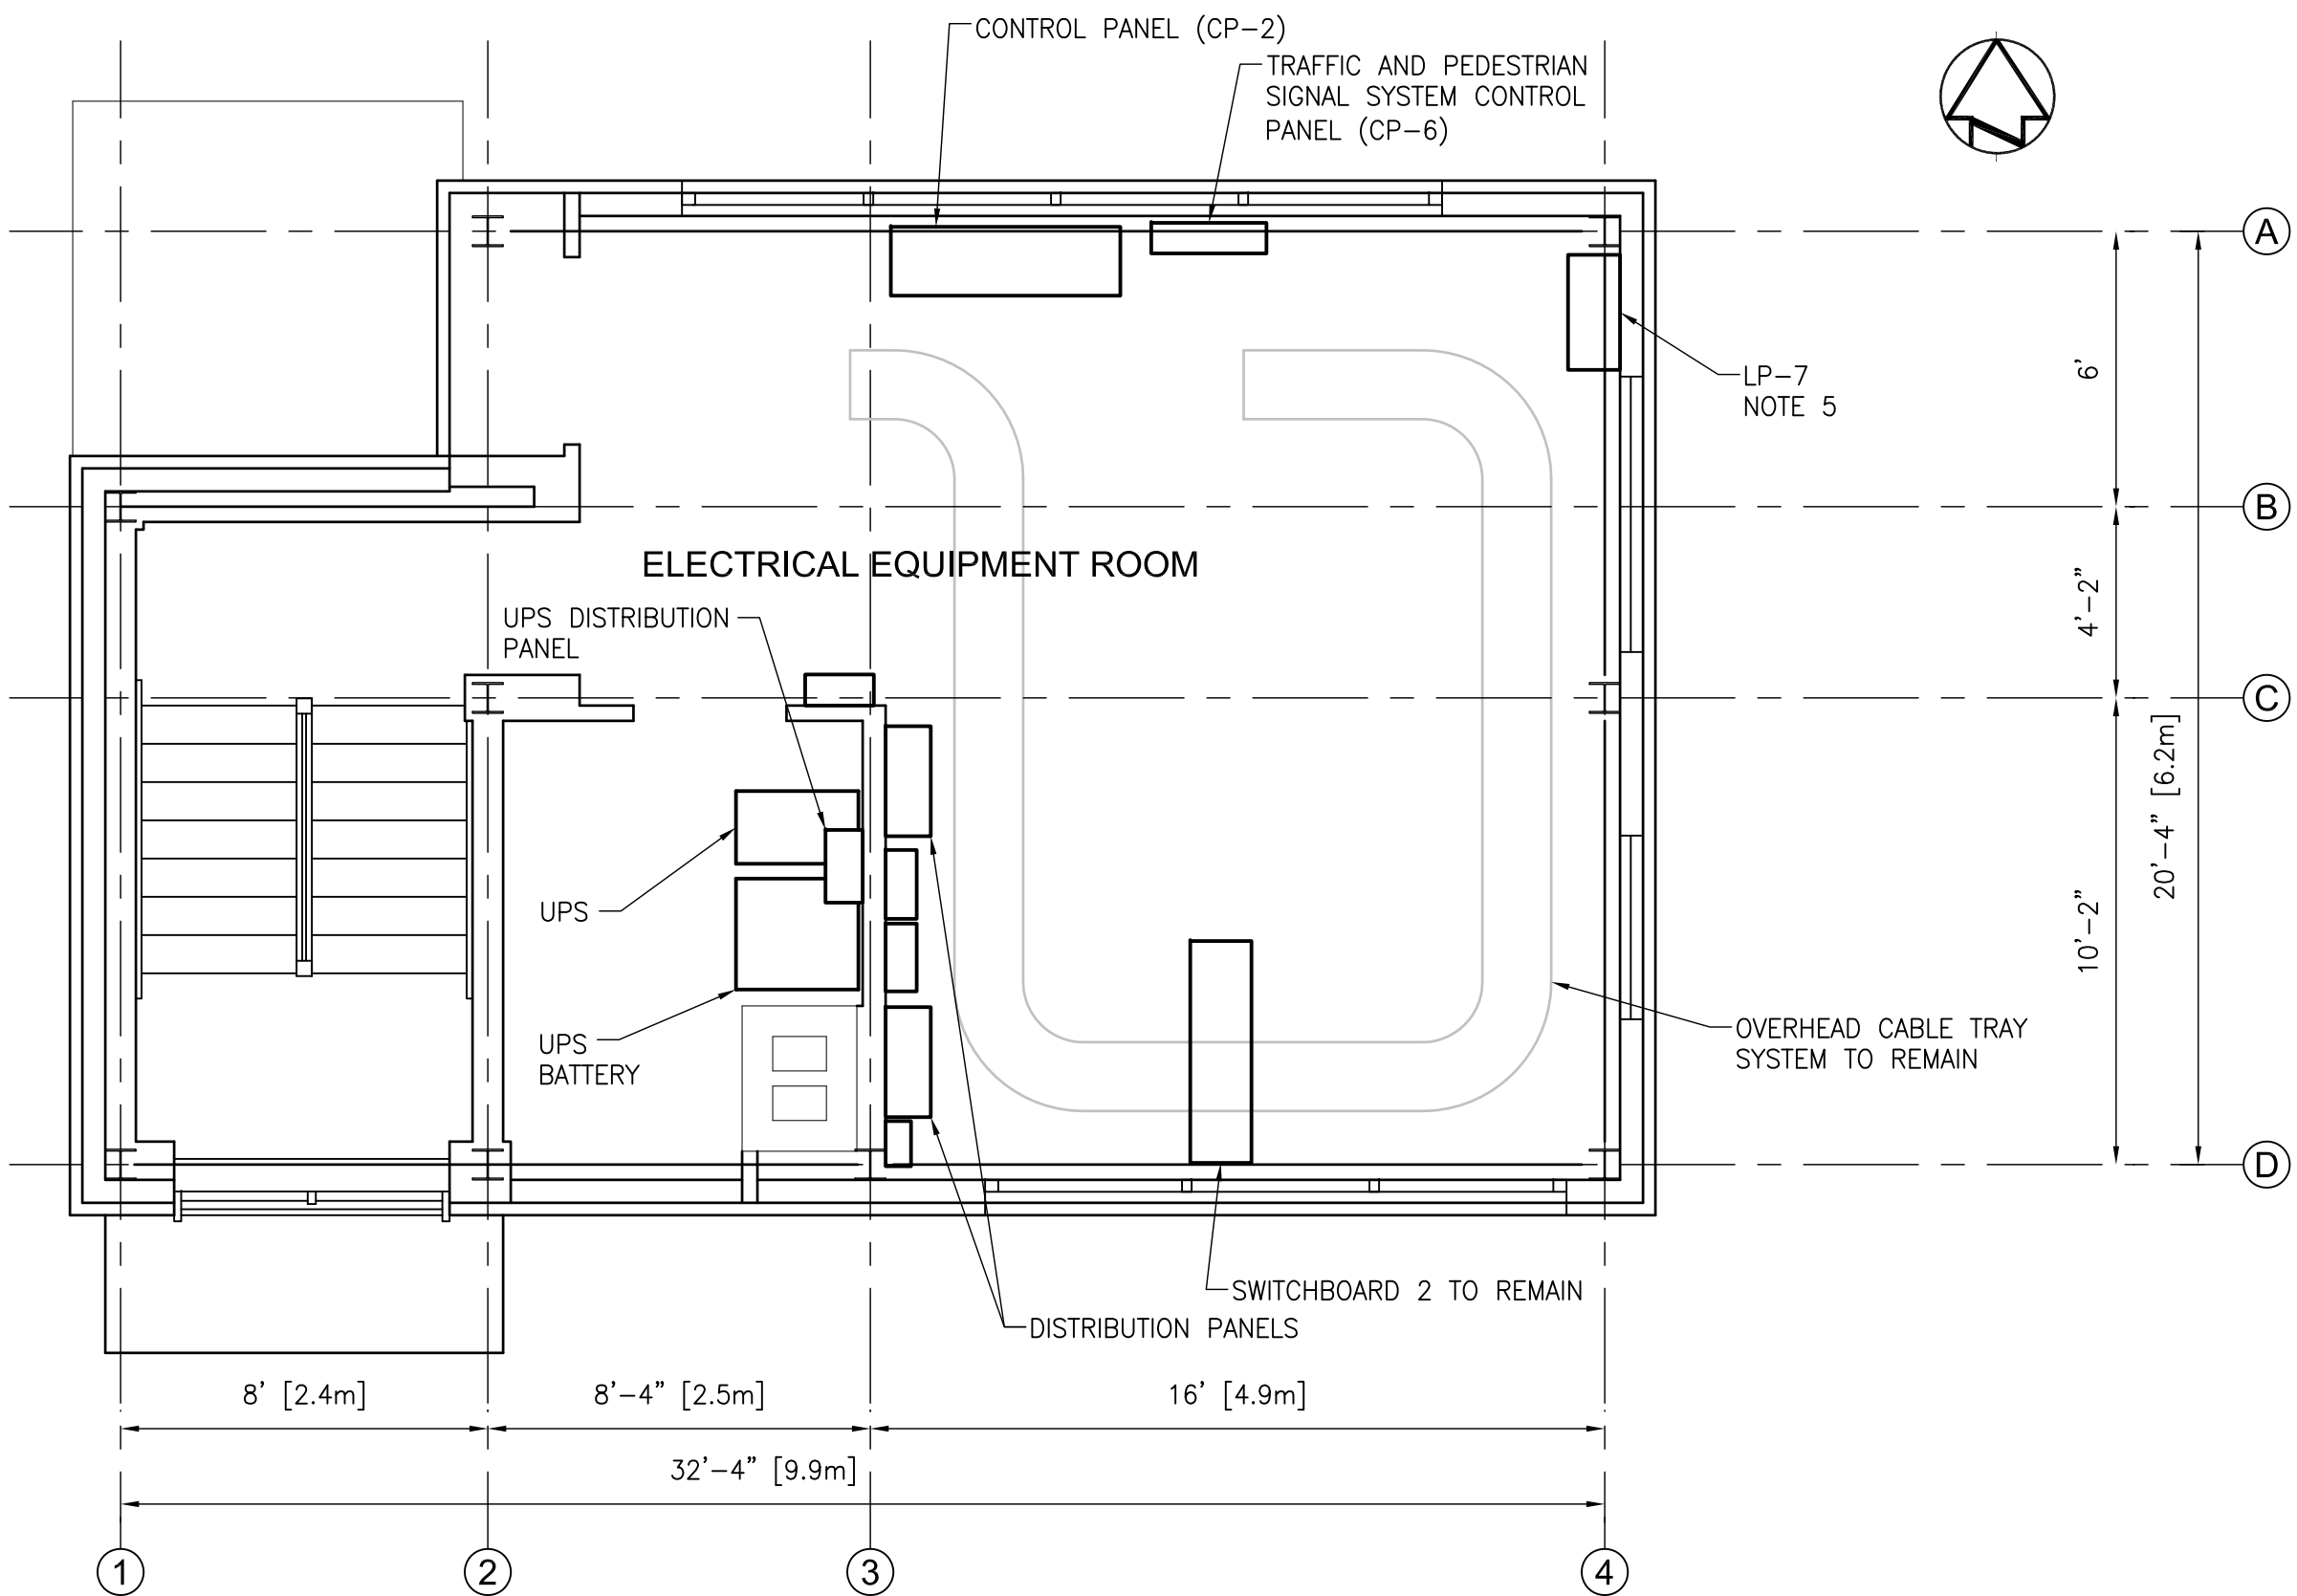

SECOND FLOOR PLAN

SCALE 1/4"=1'-0"

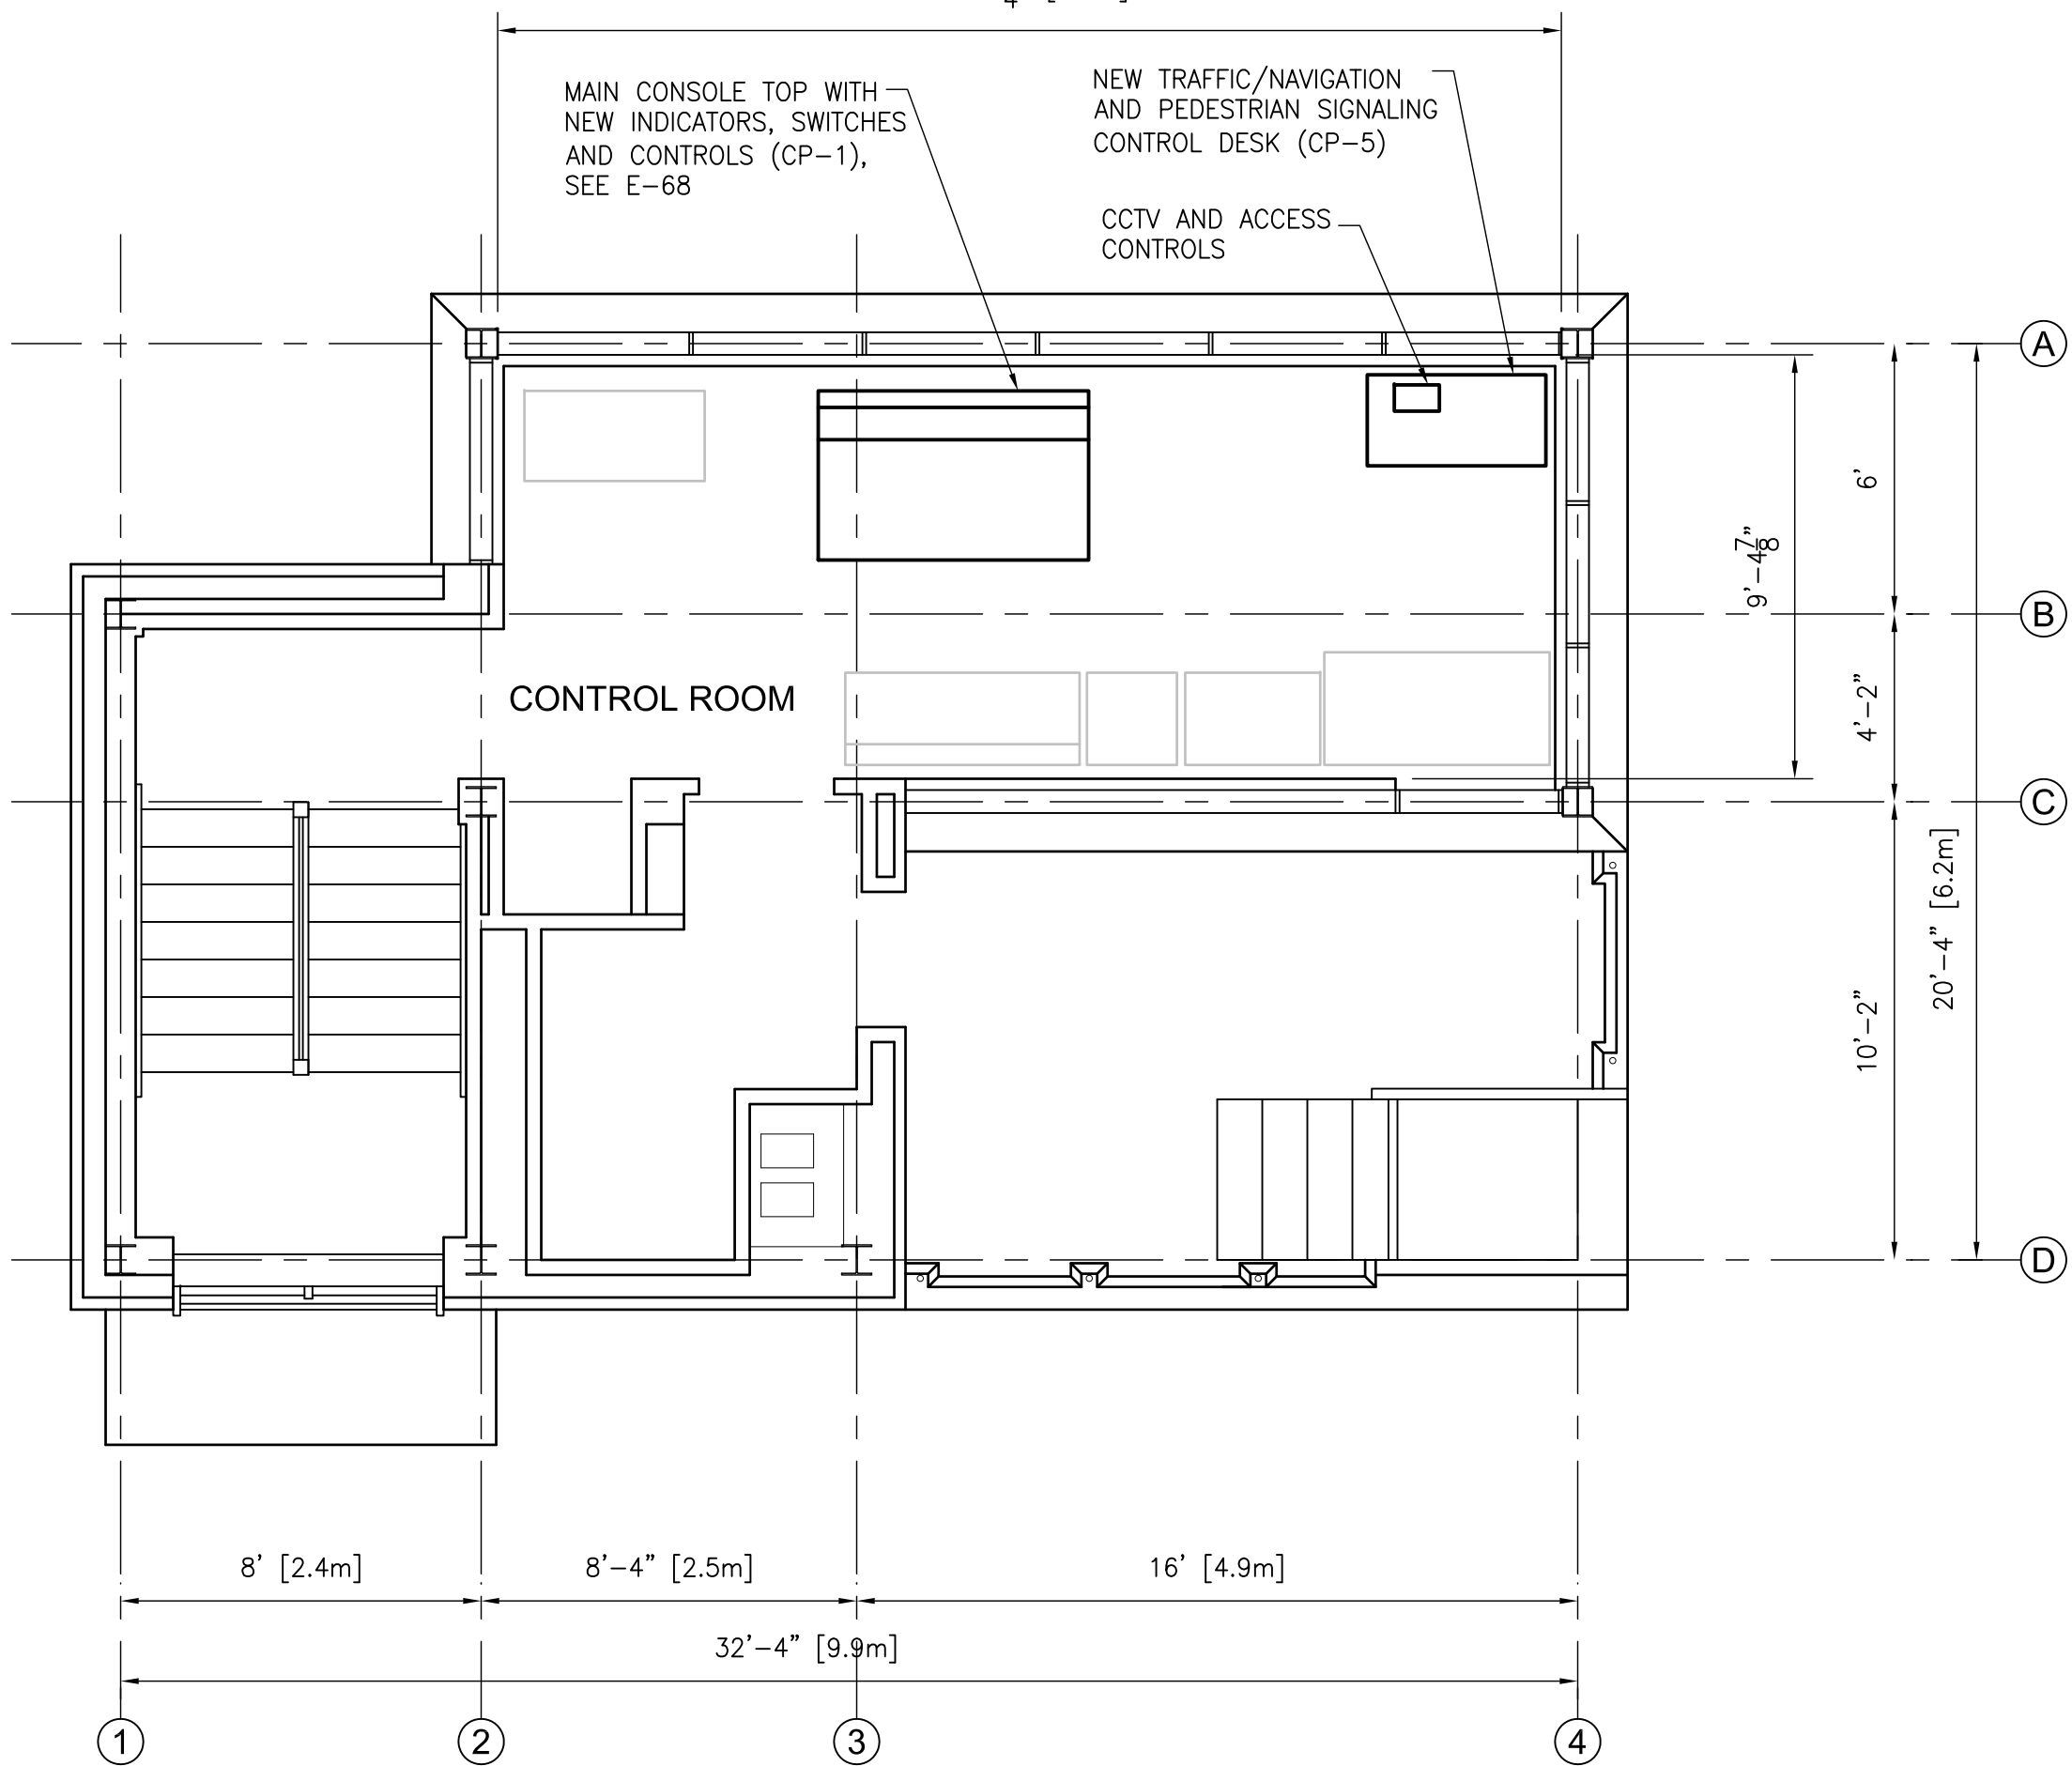

THIRD FLOOR PLAN

SCALE 1/4"=1'-0"

- NOTES:
1. REFER TO DEMOLITION DRAWINGS FOR ADDITIONAL INFORMATION.
 2. DIMENSIONS SHOWN FOR REFERENCE ONLY. FIELD VERIFICATION REQUIRED.
 3. REPLACE EXISTING UPS UNIT WITH NEW UPS UNIT AND EXTERNAL BATTERY PACK.
 4. EXISTING SWITCHBOARD NO. 2 TO REMAIN.
 5. REMOVE AND RELOCATE ROADWAY LIGHTING CONTROLS FROM CONTROL CUBICLES (REFER TO E-10) AND INSTALL IN NEW PANEL LP-7.

**PARSONS
BRINCKERHOFF**

2300 YONGE STREET, SUITE 2300
TORONTO, ONTARIO
CANADA M4P 1E4
PHONE: 416-487-5256 FAX: 416-487-9766
WWW.PBWORLD.COM

Professional Engineers
Ontario

Temporary Licensee

Name: Mark VanDeRee
Number: 100181047-02
Limitations: Electrical system design for the Burlington
Canal Bridge in Burlington, Ontario for Public Works and
Government Services Canada

Collaborator: Zvonko Trajkovic, P. Eng.
Expiry Date: July 31, 2013
Association of Professional Engineers of Ontario

Mark VanDeRee 2013-07-08



07	FOR TENDER 2	2013-06-30
06	FOR TENDER	2013-06-04
05	FINAL DESIGN COMPLETION	2013-05-31
04	99% DESIGN COMPLETION	2013-05-31
03	90% DESIGN SUBMITTAL	2013-03-31
02	66% DESIGN SUBMITTAL	2013-02-14
01	33% DESIGN SUBMITTAL	2012-12-10

revision		date
----------	--	------

Do not scale drawings.
Verify all dimensions and conditions on site and
immediately notify the Departmental Representative
of all discrepancies.

A	Detail No.
B	No. du détail
C	drawing no. - where detail required dessin no. - où détail exigé
	drawing no. - where detailed dessin no. - où détaillé

project title
titre du projet
HAMILTON BURLINGTON CANAL VERTICAL LIFT BRIDGE
REPLACEMENT OF CONTROLS, DRIVES AND OVERHEAD CABLES

drawing title
titre du dessin
ELECTRICAL PLANS, ELECTRICAL ROOM, AND CONTROL ROOM

drawn by
dessine par
J. Perez

designed by
conc par
G. Patino/B. Crouthamel

approved by
approuve par
M. Vanderee

bid
soumission
A. Ghubril

project manager
administrateur
de projets

project date
date du projet
2013-05-31

project no.
no. du projet
R.012641.001

drawing no.
dessin no.
E-14