


1 TYPICAL MAIN FLOOR DATA COMMUNICATIONS SYSTEM SCHEMATIC
E3.2 SCALE NTS


- TYPICAL MAIN FLOOR DATA COMMUNICATIONS SYSTEM SCHEMATIC NOTE LEGEND:
- NEW FLOOR MOUNT RACK AS SPECIFIED.
 - PATCH PANEL AS SPECIFIED.
 - RACK MOUNT FIBRE PATCH PANEL AS SPECIFIED.
 - DATA COMMUNICATIONS CABLE AS SPECIFIED. RUN IN CEILING SPACE, LAID NEATLY IN CABLE HOOKS AS SPECIFIED.
 - RUN CABLE TO WALL OUTLET IN CONDUIT STUBBED INTO CEILING SPACE.
 - DATA OUTLET C/W COVERPLATE AS SPECIFIED. PROVIDE QUANTITY OF JACKS IN EACH OUTLET AS INDICATED ON FLOOR PLANS.
 - DATA COMMUNICATIONS CABLE AS SPECIFIED. RUN IN FLOOR SPACE, RUN IN CABLE TRAY AS SPECIFIED.
 - FLOOR MOUNTED DATA OUTLET C/W COVERPLATE AS SPECIFIED, INSTALLED BELOW RAISED FLOOR. PROVIDE QUANTITY OF JACKS IN EACH OUTLET AS INDICATED ON FLOOR PLANS.
 - EXISTING CABLE TRAY IN RAISED FLOOR SYSTEM. PROVIDE NEW LENGTHS OF CABLE TRAY AS NOTED ON DRAWINGS.
 - 12/24 STRAND SINGLE MODE FIBRE OPTIC CABLE AS SPECIFIED. RUN IN 13mm FLEXIBLE, PVC JACKETED, METAL CONDUIT, IN CEILING SPACE BETWEEN FLOOR MOUNT RACKS. LAY CABLE NEATLY IN CABLE HOOKS AS SPECIFIED. RUN FIBRE TO EXISTING FLOOR MOUNT RACK THROUGH ADJACENT TENANT SPACES BETWEEN THE HOURS OF 5:00PM AND 7:00AM OR ON WEEKENDS. SCHEDULE WORK PRIOR TO BEGINNING WITH DEPARTMENTAL REPRESENTATIVE.
 - EXISTING FLOOR MOUNT RACK IN ROOM 112.02 TO REMAIN.
 - PATCH CABLE. PROVIDE TWO (2) PATCH CABLES FOR EVERY DROP INSTALLED. PROVIDE THE FOLLOWING:

LENGTH	QUANTITY
2135mm	60% PER TERMINATED JACKS IN PATCH PANELS. (TYPICAL) - BLUE IN COLOUR
2135mm	20% PER TERMINATED JACKS IN PATCH PANELS. (TYPICAL) - ORANGE IN COLOUR
2135mm	10% PER TERMINATED JACKS IN PATCH PANELS. (TYPICAL) - WHITE IN COLOUR
2135mm	10% PER TERMINATED JACKS IN PATCH PANELS. (TYPICAL) - GREEN IN COLOUR
3050mm	50% PER TERMINATED JACKS AT DESKS. (TYPICAL) - GREEN IN COLOUR
3050mm	50% PER TERMINATED JACKS AT DESKS. (TYPICAL) - BLUE IN COLOUR
 - #6 TO BUILDING GROUND.

TYPICAL MAIN FLOOR DATA COMMUNICATIONS SYSTEM SCHEMATIC GENERAL NOTES:
ELECTRICAL CONTRACTOR TO REMOVE ALL EXISTING DATA COMMUNICATIONS CABLING BACK TO EXISTING PATCH PANELS AT EXISTING FLOOR MOUNT RACKS. REMOVAL OF CABLING AND OUTLETS MUST BE PERFORMED WHILE DEPARTMENTAL REPRESENTATIVE IS ON SITE TO ENSURE CORRECT CABLING AND OUTLETS ARE REMOVED.

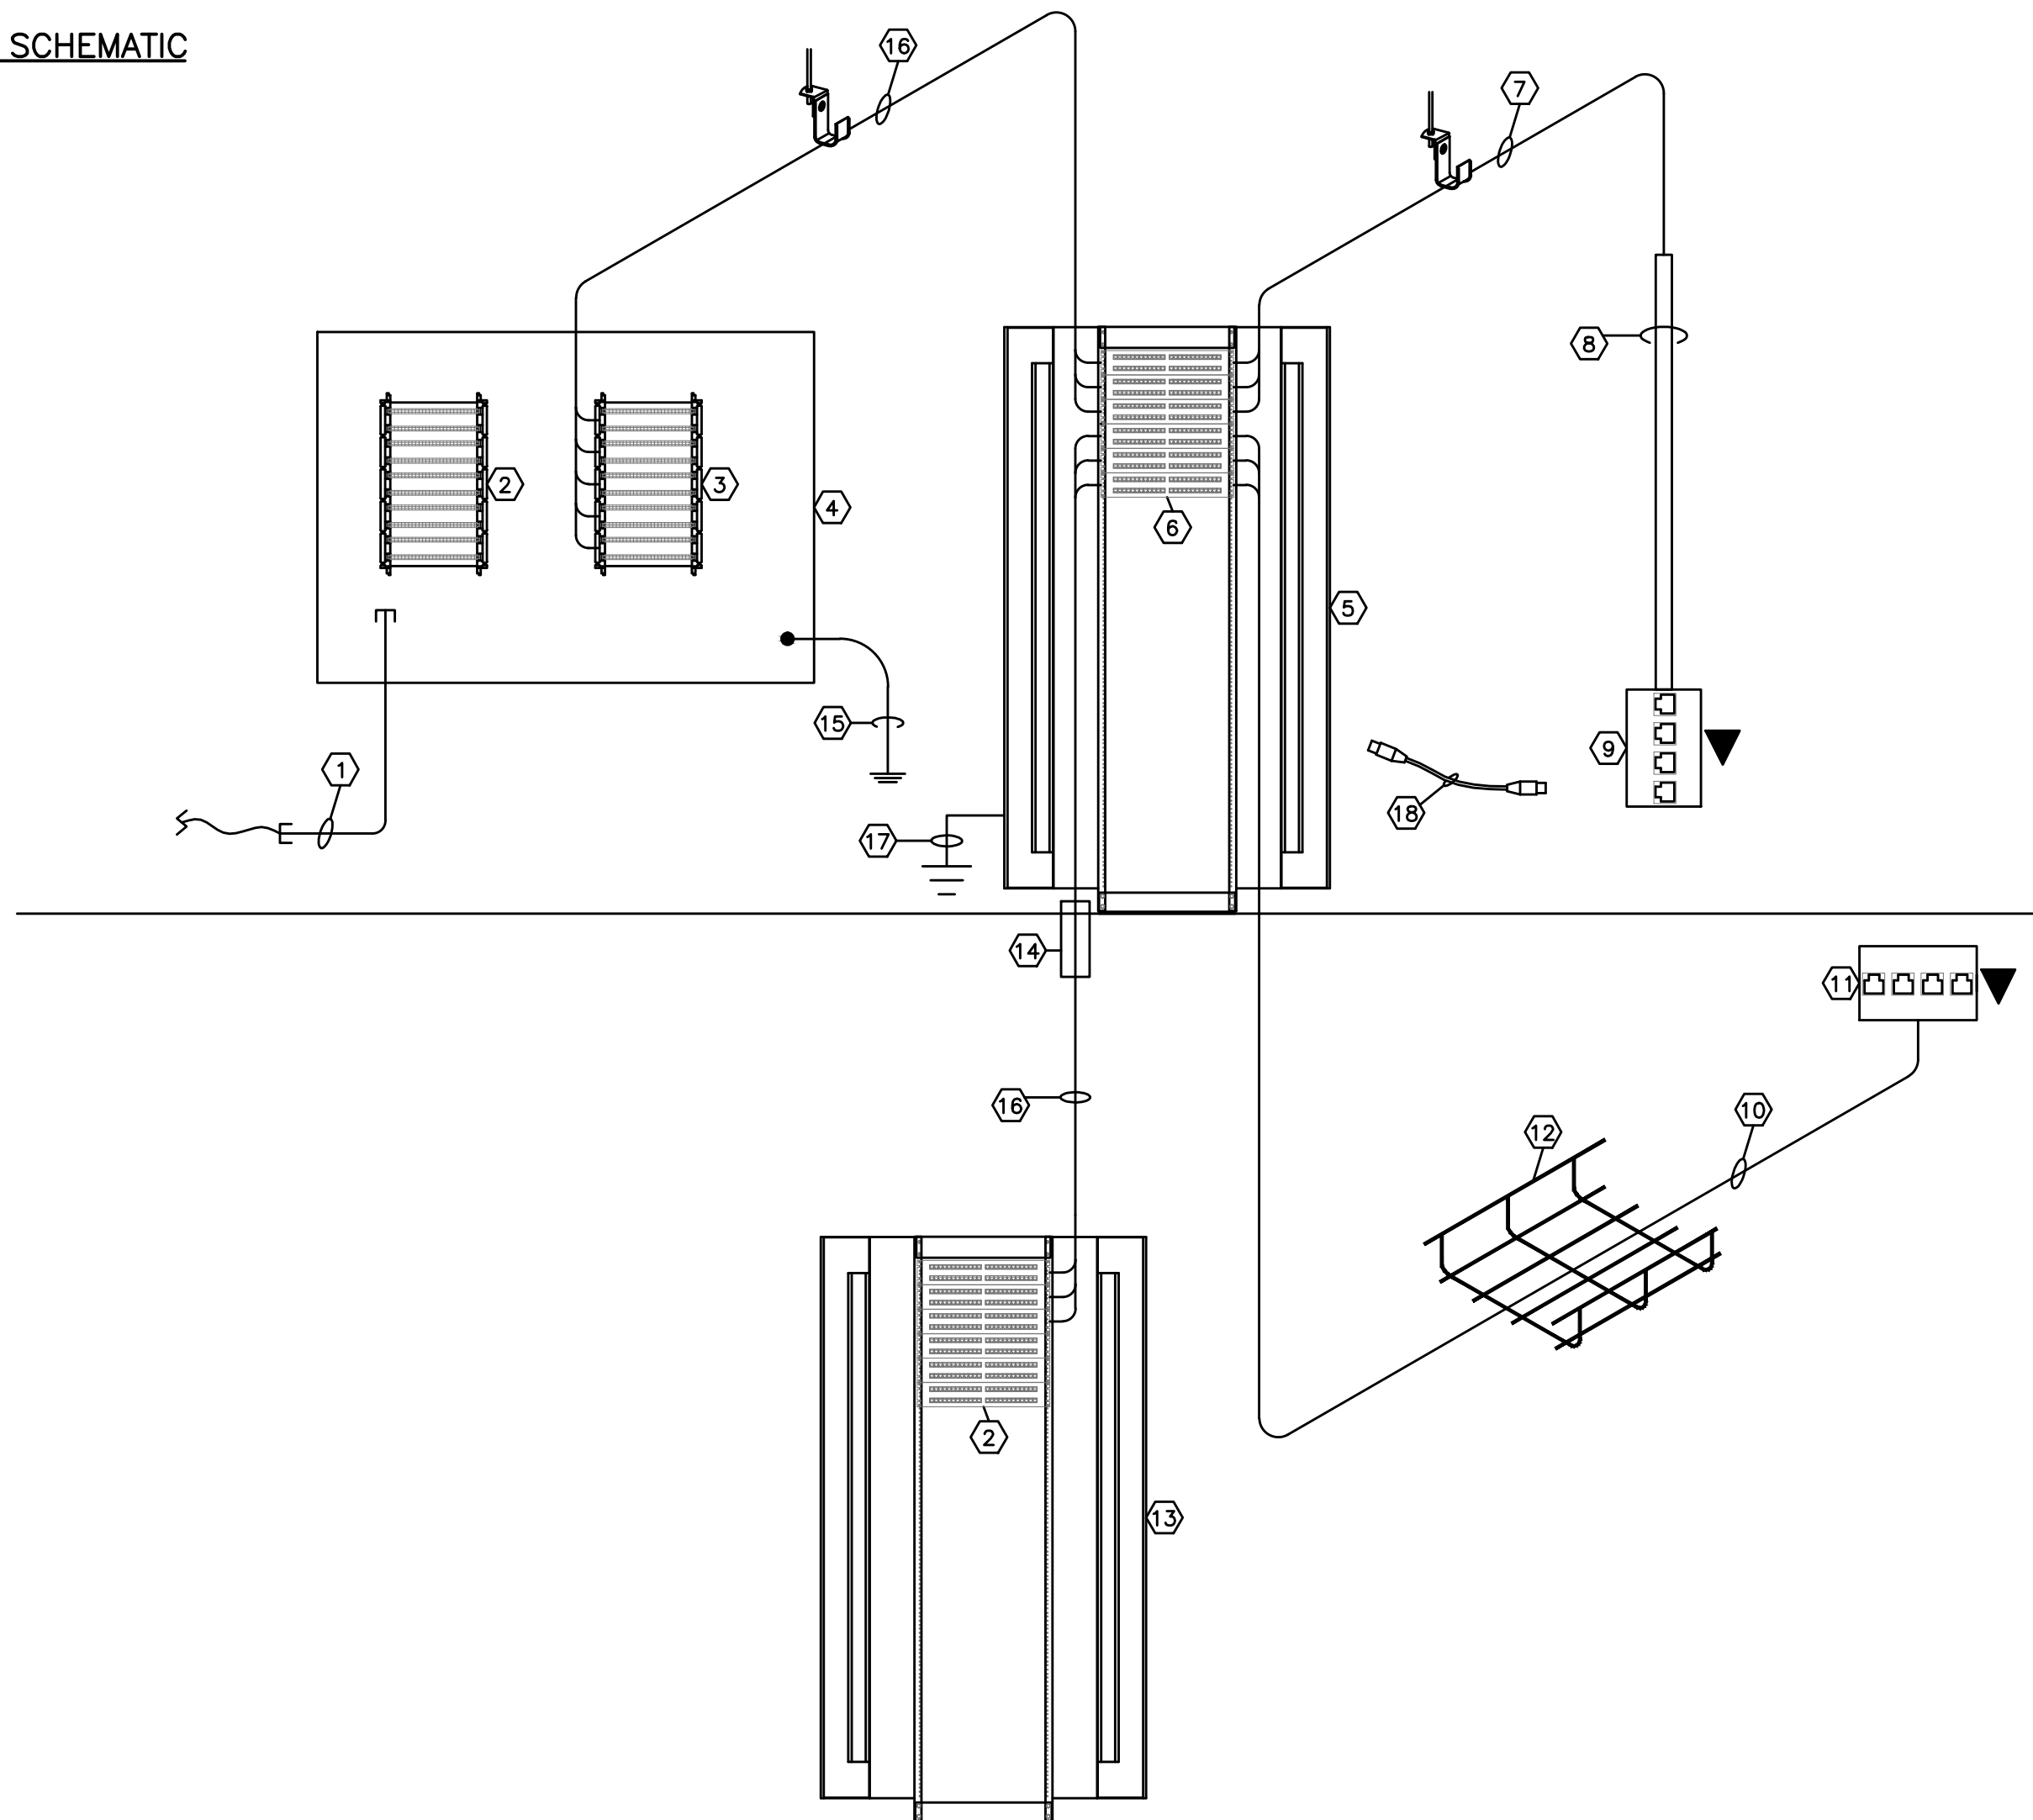

2 TYPICAL MAIN FLOOR VOICE COMMUNICATIONS SYSTEM SCHEMATIC
E3.2 SCALE NTS

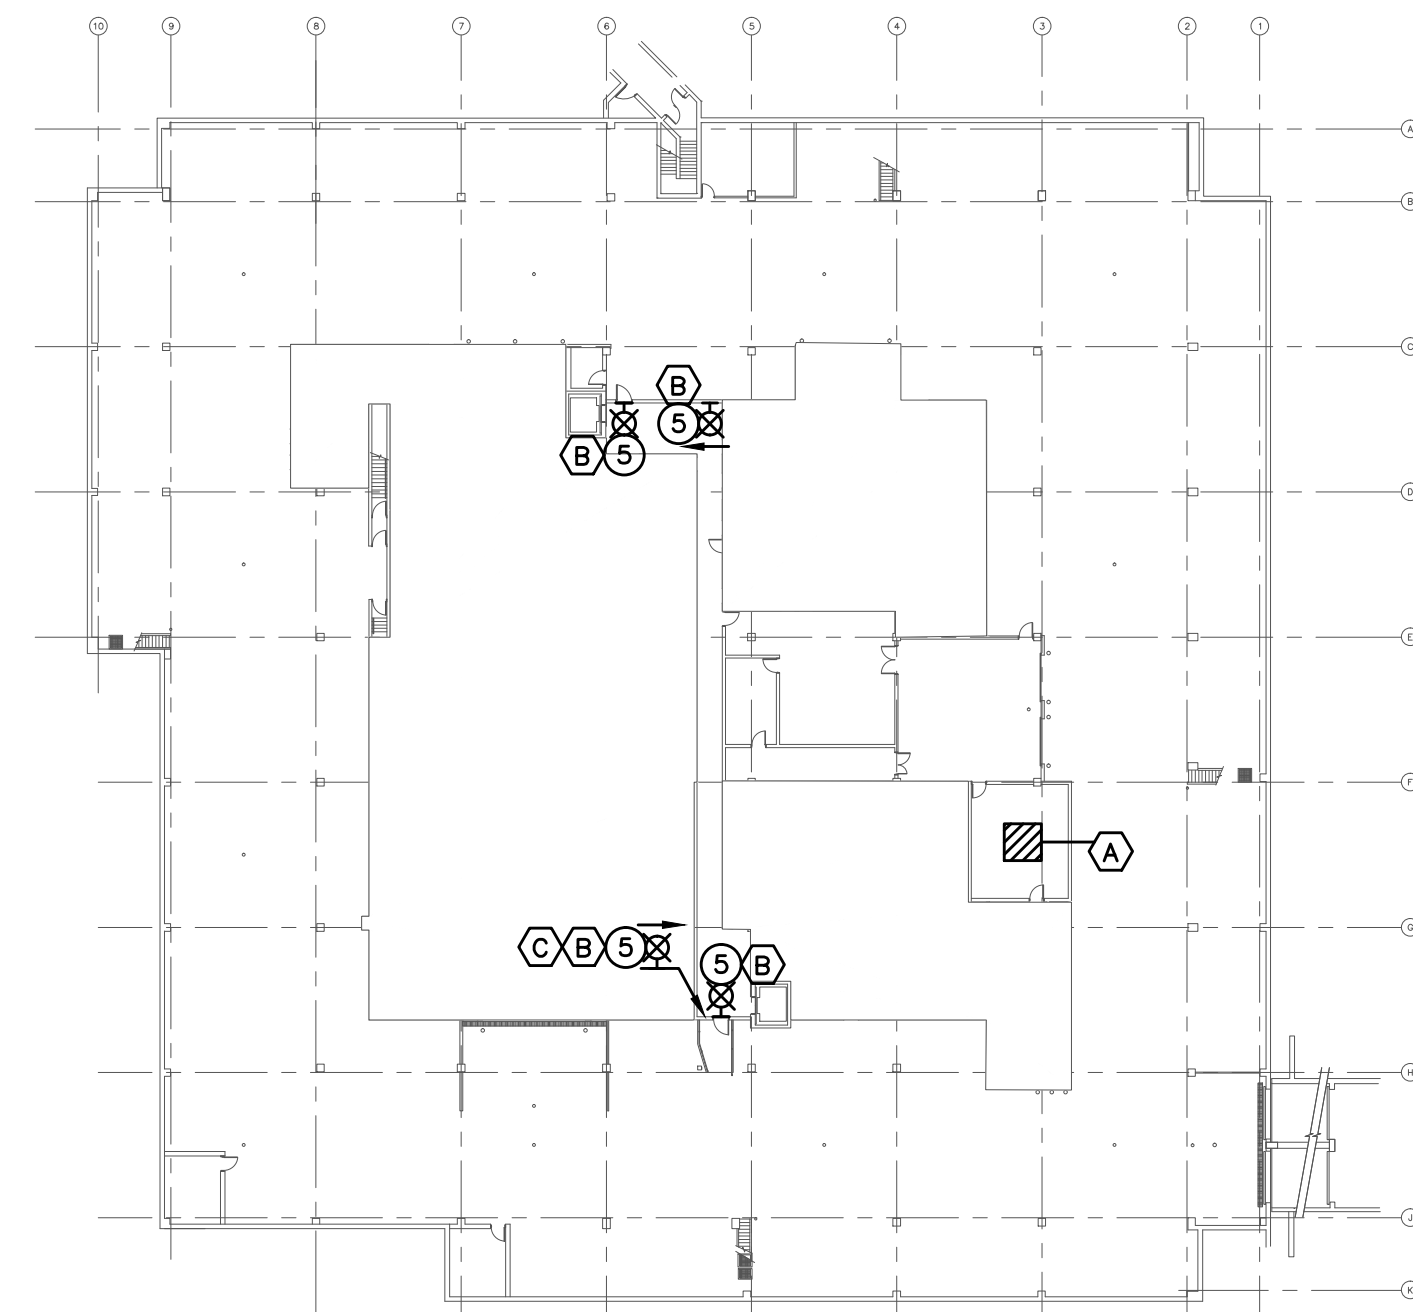

3 BASEMENT FLOOR KEY PLAN
E3.2 SCALE 1:500

- BASEMENT KEY PLAN NOTE LEGEND:
- EXISTING FLOOR MOUNT RACK IN ROOM 003.08 TO REMAIN. INSTALL NEW RISER CABLE AND PATCH PANELS AS PER TYPICAL MAIN FLOOR VOICE COMMUNICATIONS SYSTEM SCHEMATIC, DETAIL 2/E3.2.
 - CONNECT NEW EXIT LIGHT FIXTURES TO THE EXISTING BASEMENT EMERGENCY POWER EXIT LIGHT CIRCUIT.
 - INSTALL NEW EXIT LIGHT WITH DIRECTIONAL ARROW AT END OF CORRIDOR.


TYPICAL MAIN FLOOR VOICE COMMUNICATIONS SYSTEM SCHEMATIC NOTE LEGEND:

- EXISTING BUILDING ENTRY CABLE TO REMAIN.
- EXISTING BUILDING TELEPHONE DEMARCATION EQUIPMENT IN ROOM TO REMAIN.
- NEW WALL MOUNT IDC/IDC VOICE CONNECTORS AS SPECIFIED.
- EXISTING EQUIPMENT PLYWOOD IN ROOM 100.21 TO REMAIN.
- NEW FLOOR MOUNT RACK AS SPECIFIED.
- PATCH PANEL AS SPECIFIED.
- VOICE COMMUNICATIONS CABLE AS SPECIFIED. RUN IN CEILING SPACE, LAID NEATLY IN CABLE HOOKS AS SPECIFIED.
- RUN CABLE TO WALL OUTLET IN CONDUIT STUBBED INTO CEILING SPACE.
- VOICE OUTLET C/W COVERPLATE AS SPECIFIED. PROVIDE QUANTITY OF JACKS IN EACH OUTLET AS INDICATED ON FLOOR PLANS.
- VOICE COMMUNICATIONS CABLE AS SPECIFIED. RUN IN FLOOR SPACE, RUN IN CABLE TRAY AS SPECIFIED.
- FLOOR MOUNTED VOICE OUTLET C/W COVERPLATE AS SPECIFIED, INSTALLED BELOW RAISED FLOOR. PROVIDE QUANTITY OF JACKS IN EACH OUTLET AS INDICATED ON FLOOR PLANS.
- EXISTING CABLE TRAY IN RAISED FLOOR SYSTEM. PROVIDE NEW LENGTHS OF CABLE TRAY AS NOTED ON DRAWINGS.
- EXISTING FLOOR MOUNT RACK IN ROOM 003.08 TO REMAIN.
- RUN CABLES BETWEEN FLOORS IN NEW 103mm CONDUIT SLEEVE THROUGH CONCRETE FLOOR.
- EXISTING GROUND TO REMAIN.
- 100 PAIR INSIDE RISER CABLE IN 53mm CONDUIT AS SPECIFIED.
- #6 TO BUILDING GROUND.
- PATCH CABLE. PROVIDE TWO (2) PATCH CABLE FOR EVERY DROP INSTALLED. PROVIDE THE FOLLOWING:

LENGTH	QUANTITY
2135mm	100% PER TERMINATED JACKS IN PATCH PANELS. (TYPICAL) - WHITE IN COLOUR
3050mm	90% PER TERMINATED JACKS AT DESKS. (TYPICAL) - WHITE IN COLOUR
3050mm	10% PER TERMINATED JACKS AT DESKS. (TYPICAL) - ORANGE IN COLOUR

TYPICAL MAIN FLOOR VOICE COMMUNICATIONS SYSTEM SCHEMATIC GENERAL NOTES:

ELECTRICAL CONTRACTOR TO REMOVE ALL EXISTING VOICE COMMUNICATIONS CABLING AND RISER CABLES BACK TO EXISTING BICS BLOCKS AT EQUIPMENT PLYWOODS AND PATCH PANELS AT EXISTING FLOOR MOUNT RACKS. REMOVAL OF CABLING, OUTLETS AND RECONFIGURATION OF EXISTING PATCH PANELS MUST BE PERFORMED WHILE DEPARTMENTAL REPRESENTATIVE IS ON SITE TO ENSURE CORRECT CABLING AND OUTLETS ARE REMOVED AND RECONFIGURED. REMOVE ALL EXISTING VOICE CONNECTORS AND CABLING ON EQUIPMENT PLYWOOD IN ROOM 102.02.

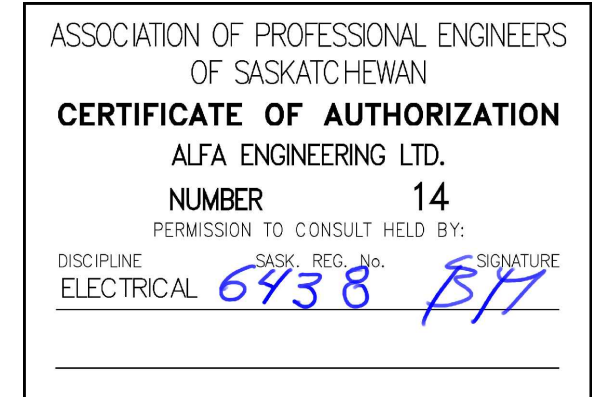

revisions	description	date
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Client	R.050172.002 FOR PWGSC
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project title	OFFICE RENOVATIONS REGINA, SASKATCHEWAN
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approved by	
designed by	PLJ
drawn by	PLJ
PWGSC Project Manager	MJ
PWGSC, Architectural and Engineering Resources Manager	KD
Client	KL

drawing title	MAIN FLOOR COMMUNICATIONS DETAILS
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project no.	sheet	revision no.
R.050172.001	E3.2	