


CONDUIT CLAMPED IN SPAN AREAS

SCALE: N.T.S.


1
2 | 2

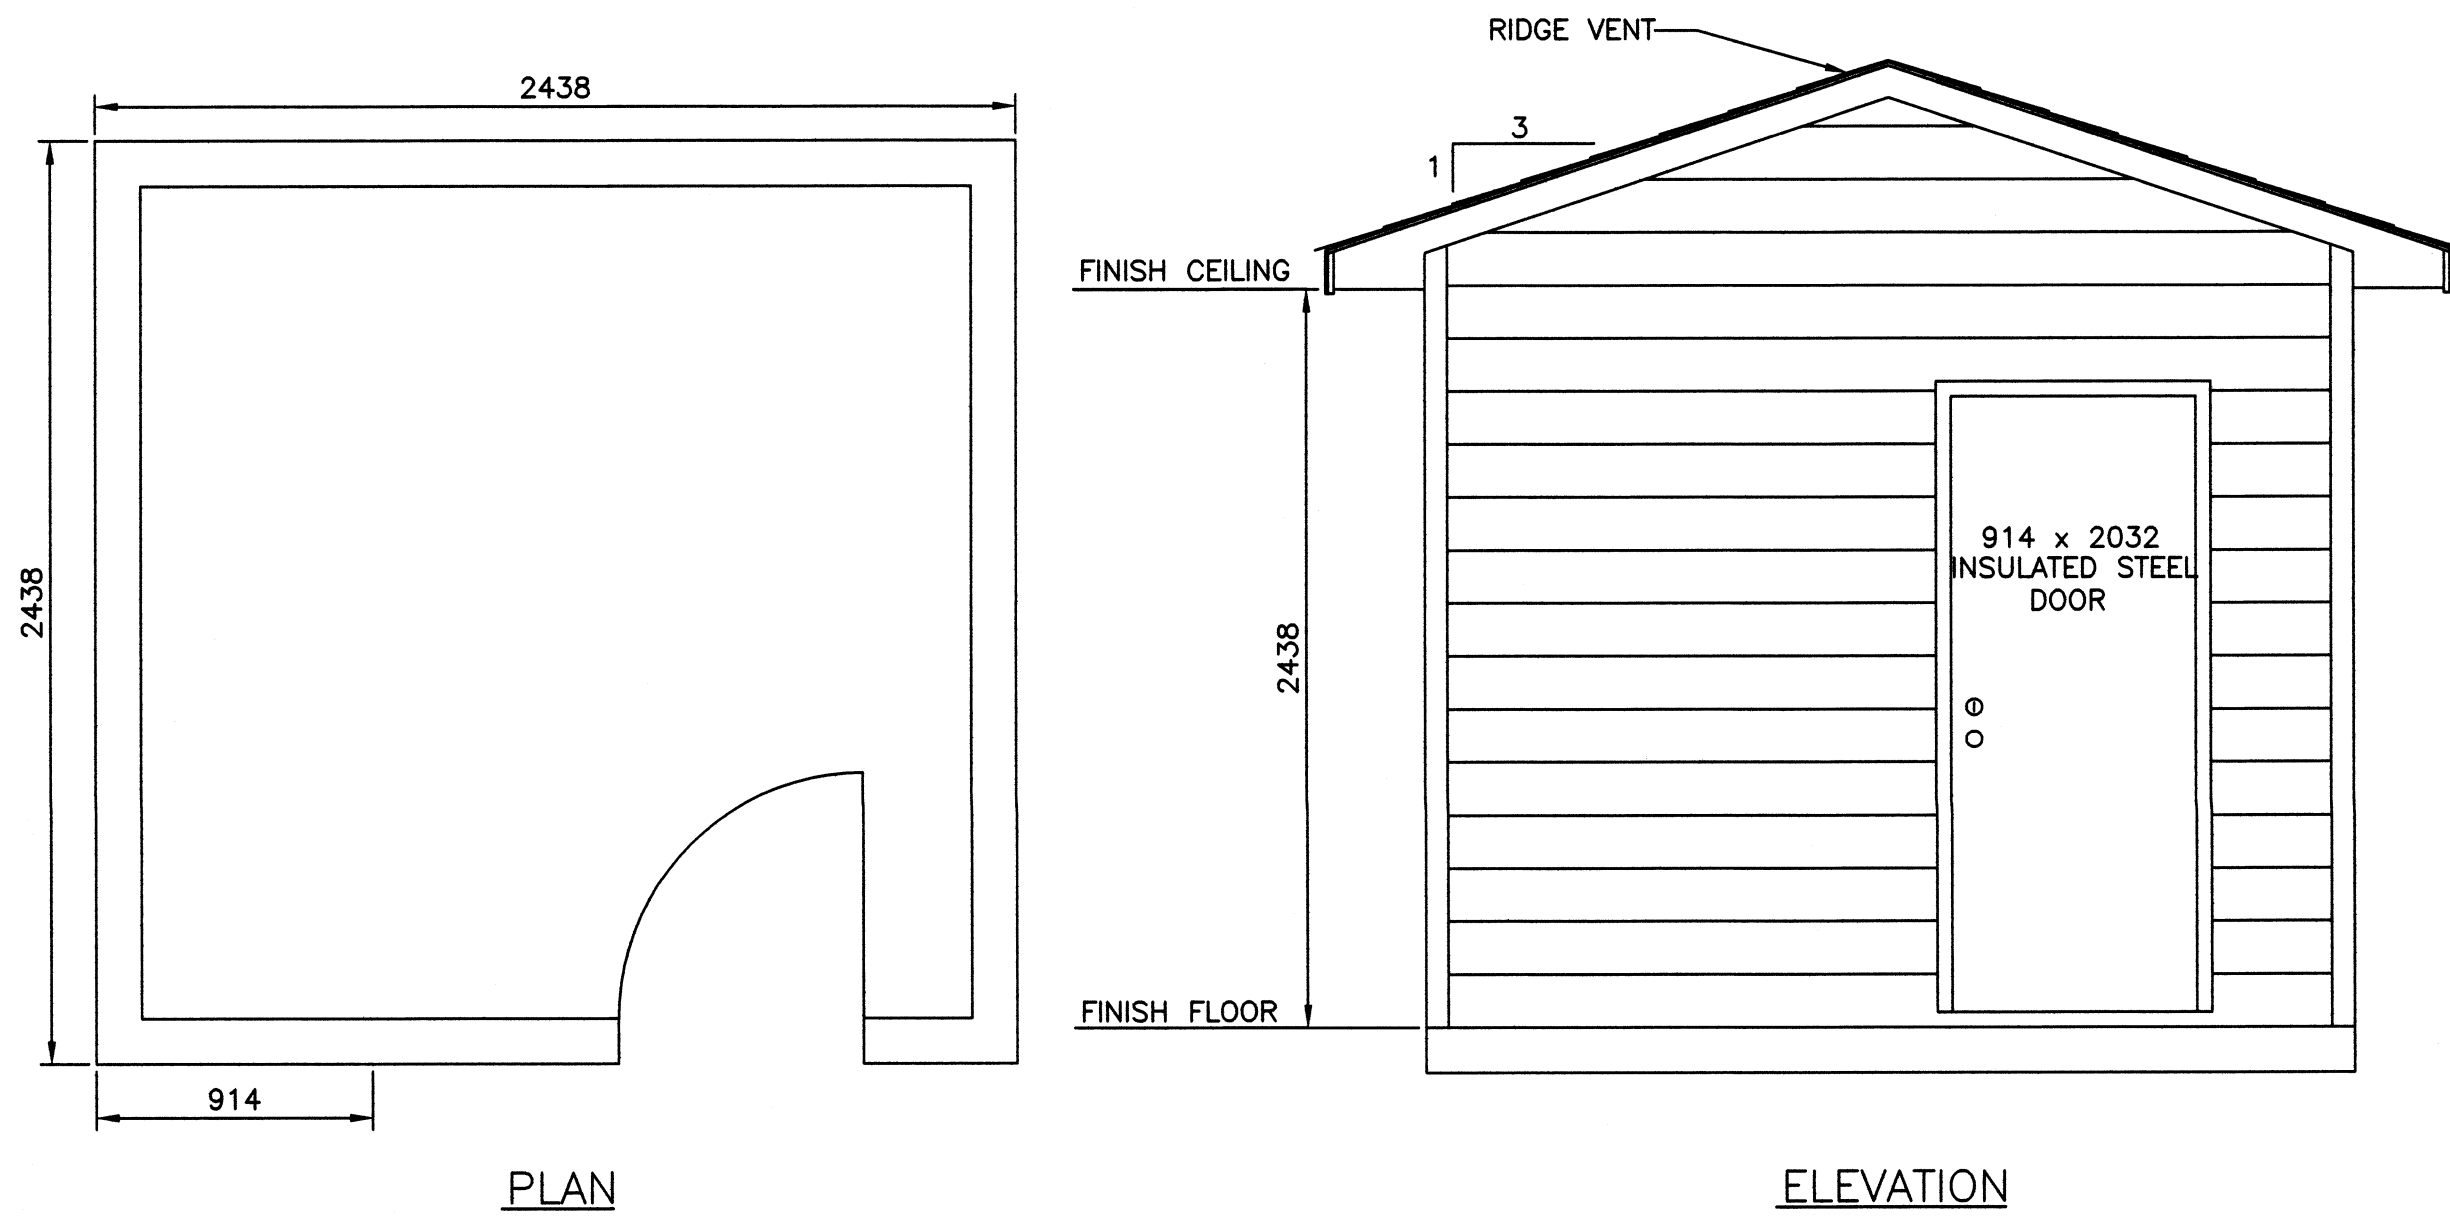

NEW ELECTRICAL SHED - PLAN & ELEVATION (WEST END)

SCALE: N.T.S.


2
2 | 2

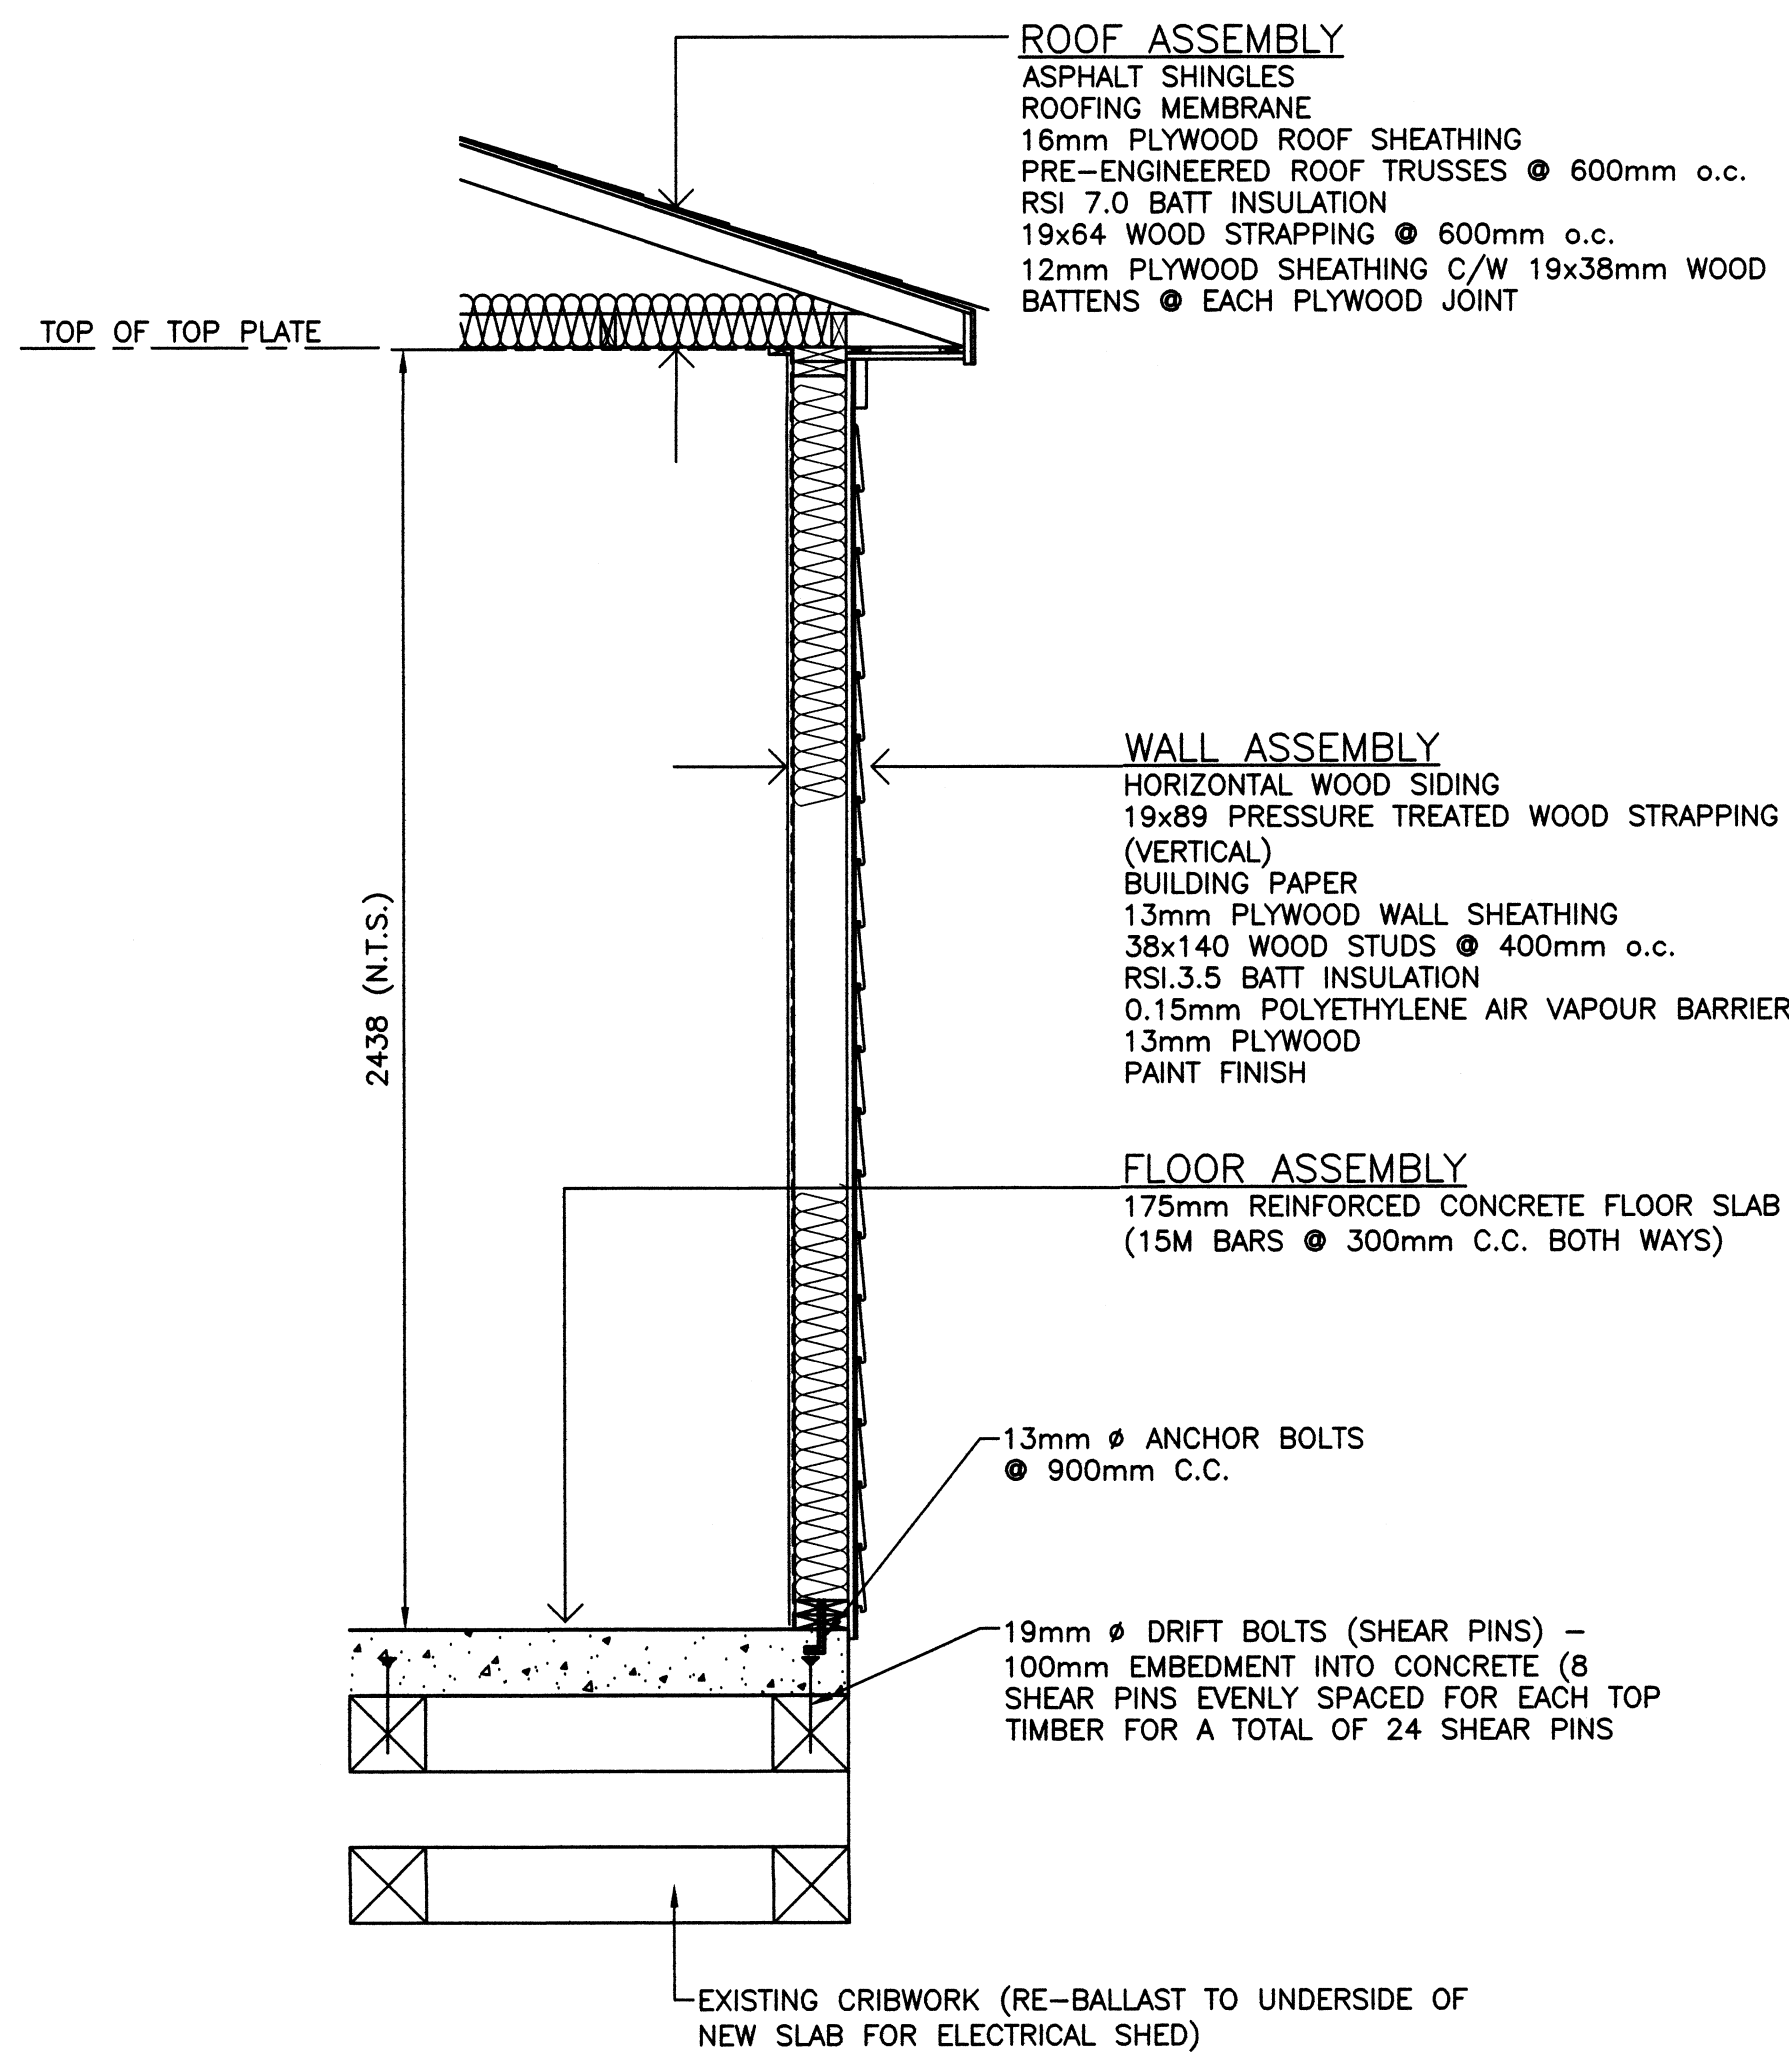

NEW ELECTRICAL SHED - WALL SECTION

SCALE: N.T.S.


3
2 | 2

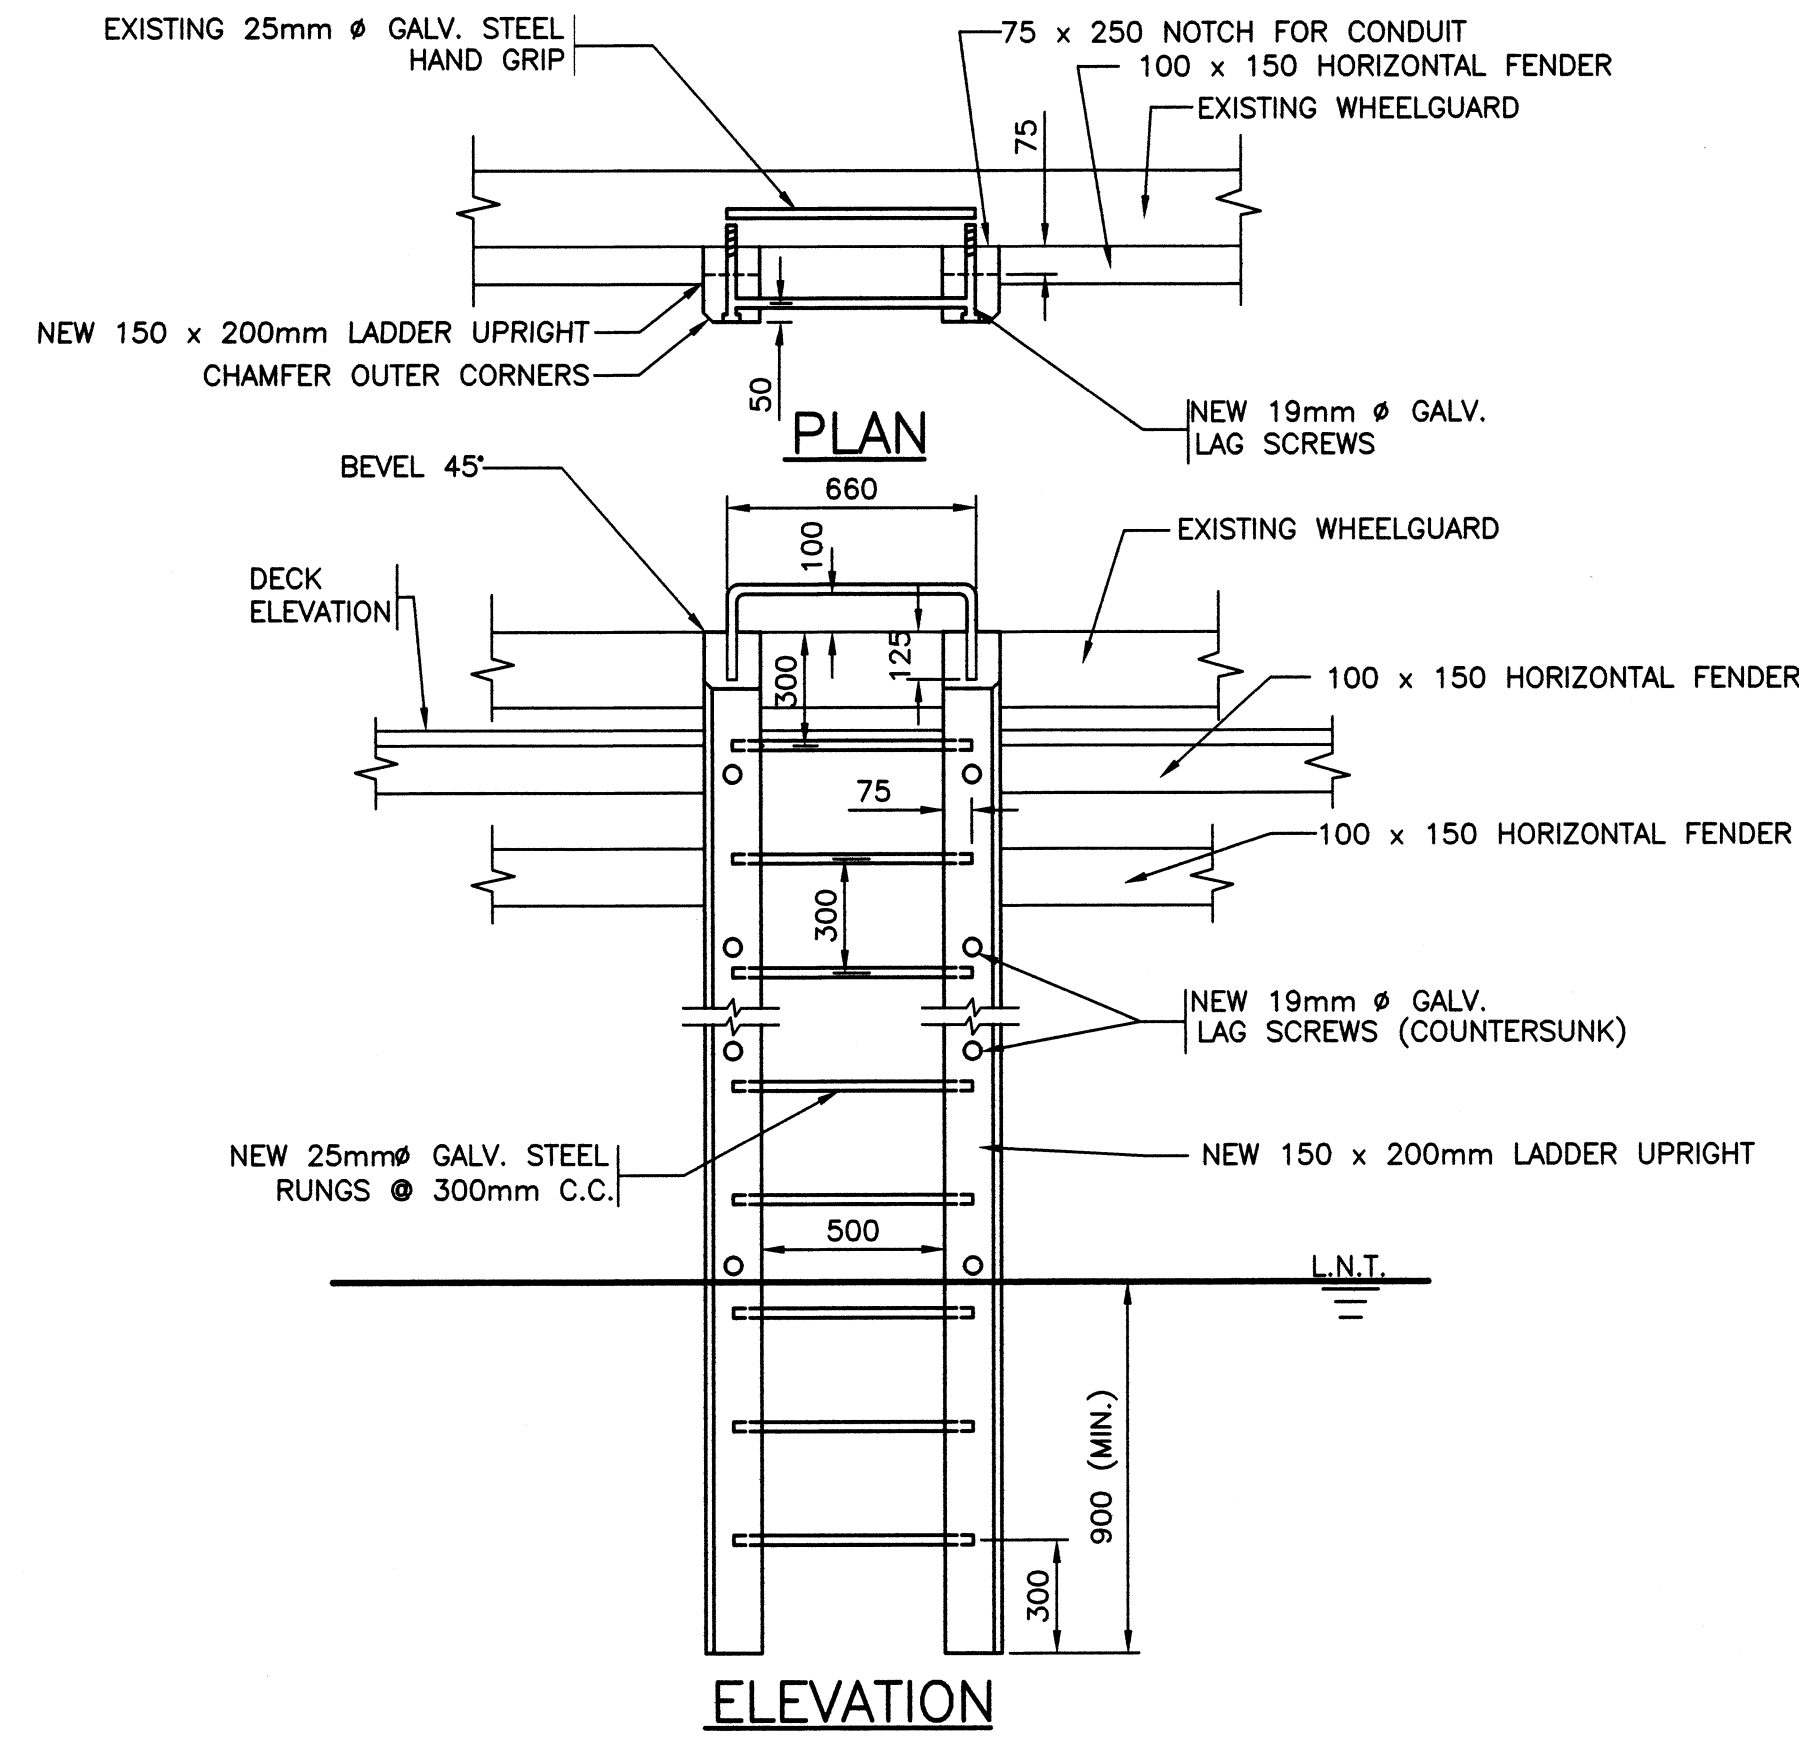

NEW LADDER

SCALE: N.T.S.

4
2 | 2

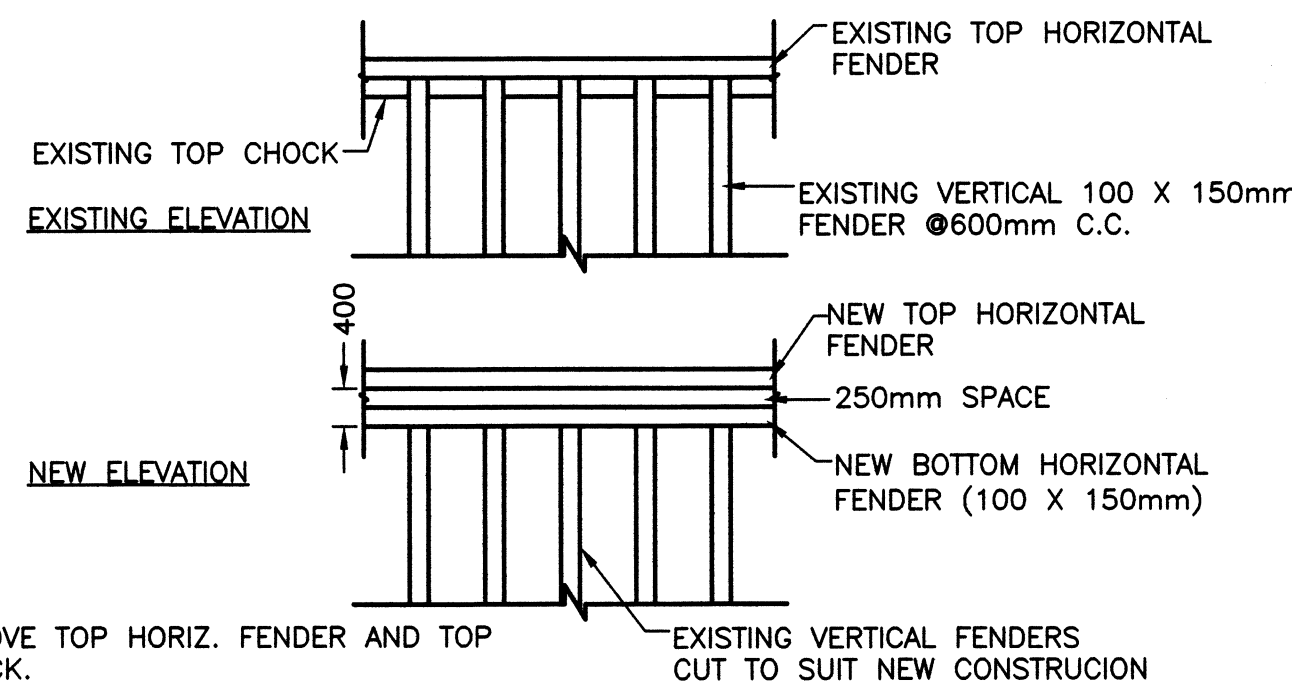


NOTES:

1. REMOVE TOP HORIZ. FENDER AND TOP CHOCK.
2. CUT TOPS OF EXISTING FENDERS AS SHOWN.
3. INSTALL NEW TOP AND BOTTOM HORIZONTAL FENDERS SECURED WITH 16mm LAG SCREWS @ 1500mm C.C.
4. CLAMP NEW CONDUITS IN SPACE AS DIRECTED BY DEPARTMENTAL REPRESENTATIVE. USE STANDARD RADIUS BENDS FOR CONDUIT WHEN DIRECTION CHANGES. PROVIDE SUFFICIENT CLAMPS TO ENSURE NO SAG IN CONDUIT.
5. CONSIDER DETAIL AS APPROXIMATE AS SITE CONDITIONS (INCLUDING FENDERING SYSTEM) MAY VARY. IF CONDITIONS DIFFER FROM DETAIL SHOWN, COORDINATE WORK PLAN IN THE FIELD WITH THE DEPARTMENTAL REPRESENTATIVE.

FENDER WORK TO ACCOMODATE CONDUIT

SCALE: N.T.S.

5
2 | 2

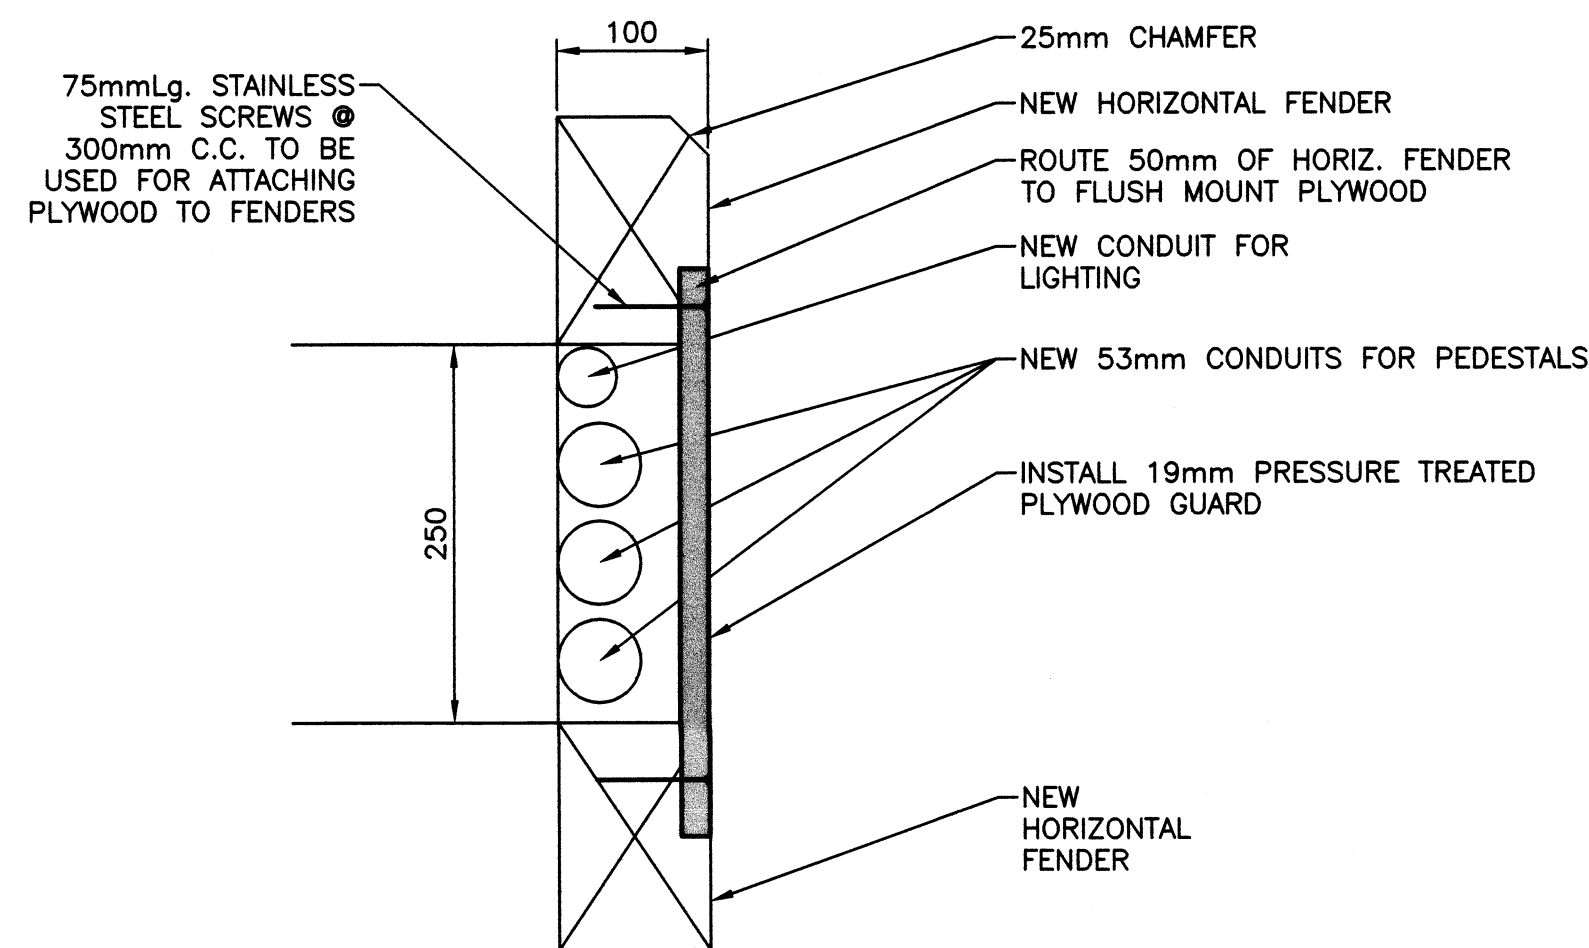


PLYWOOD PROTECTION COVER

SCALE: N.T.S.

6
2 | 2

NOTES:

1. ALL ELEVATIONS ARE IN METRES UNLESS OTHERWISE NOTED.
2. ALL DIMENSIONS ARE IN MILLIMETRES UNLESS OTHERWISE NOTED.

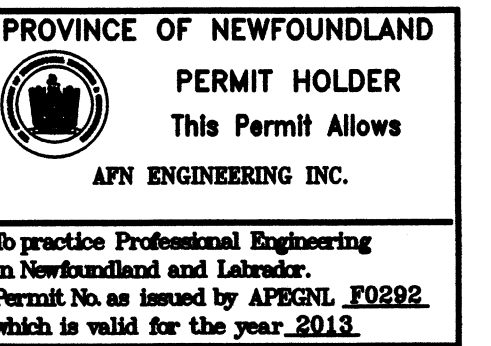

ISSUED FOR TENDER 13/08/01
revisions
project GREENSPOND WHARF ELECTRICAL UPGRADES
GREENSPOND, NL
drawing dessin

DETAILS - CIVIL

designed N.H. concu
date JULY 25, 2013
drawn P.H. dessine
date JULY 25, 2013
approved approve
Tender Paul Curran Soumission
DFO Project Manager
project number 720198 no. du projet
drawing no. C2 no. du dessin