




1 STRUCTURAL DETAIL
SCALE / ÉCHELLE - N.T.S.

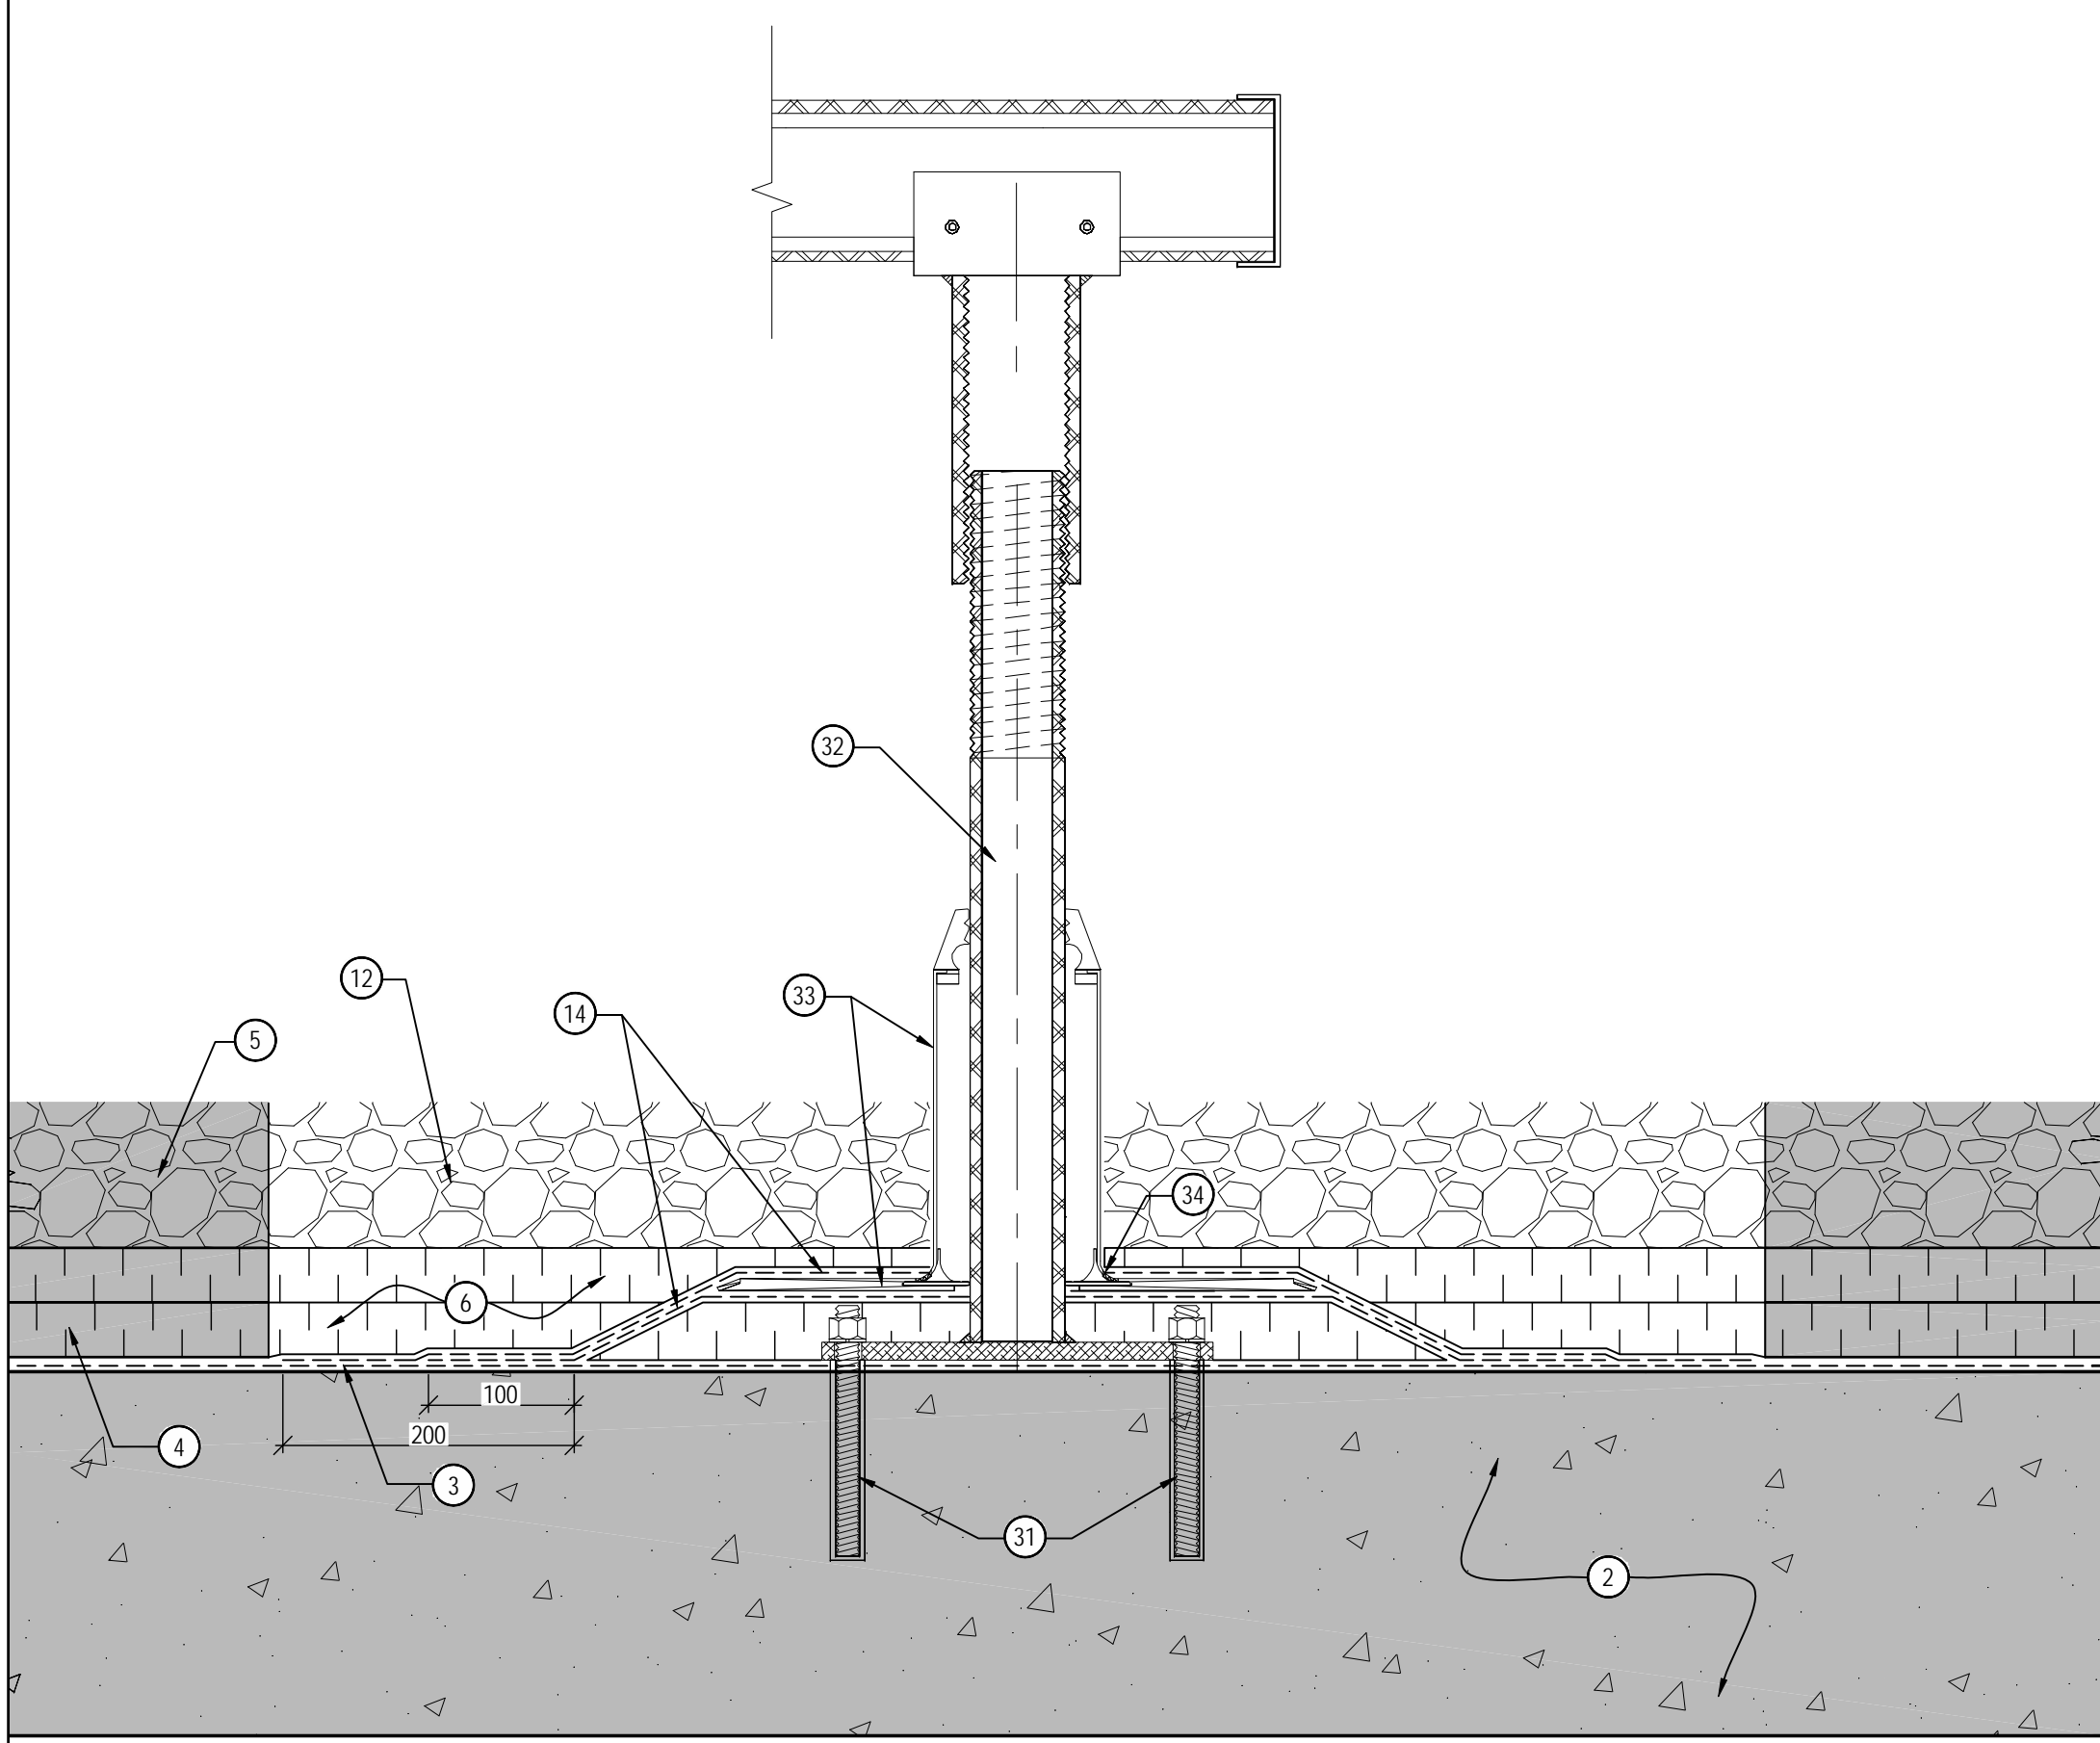


4 CONDENSER CURB
SCALE / ÉCHELLE - 1:5

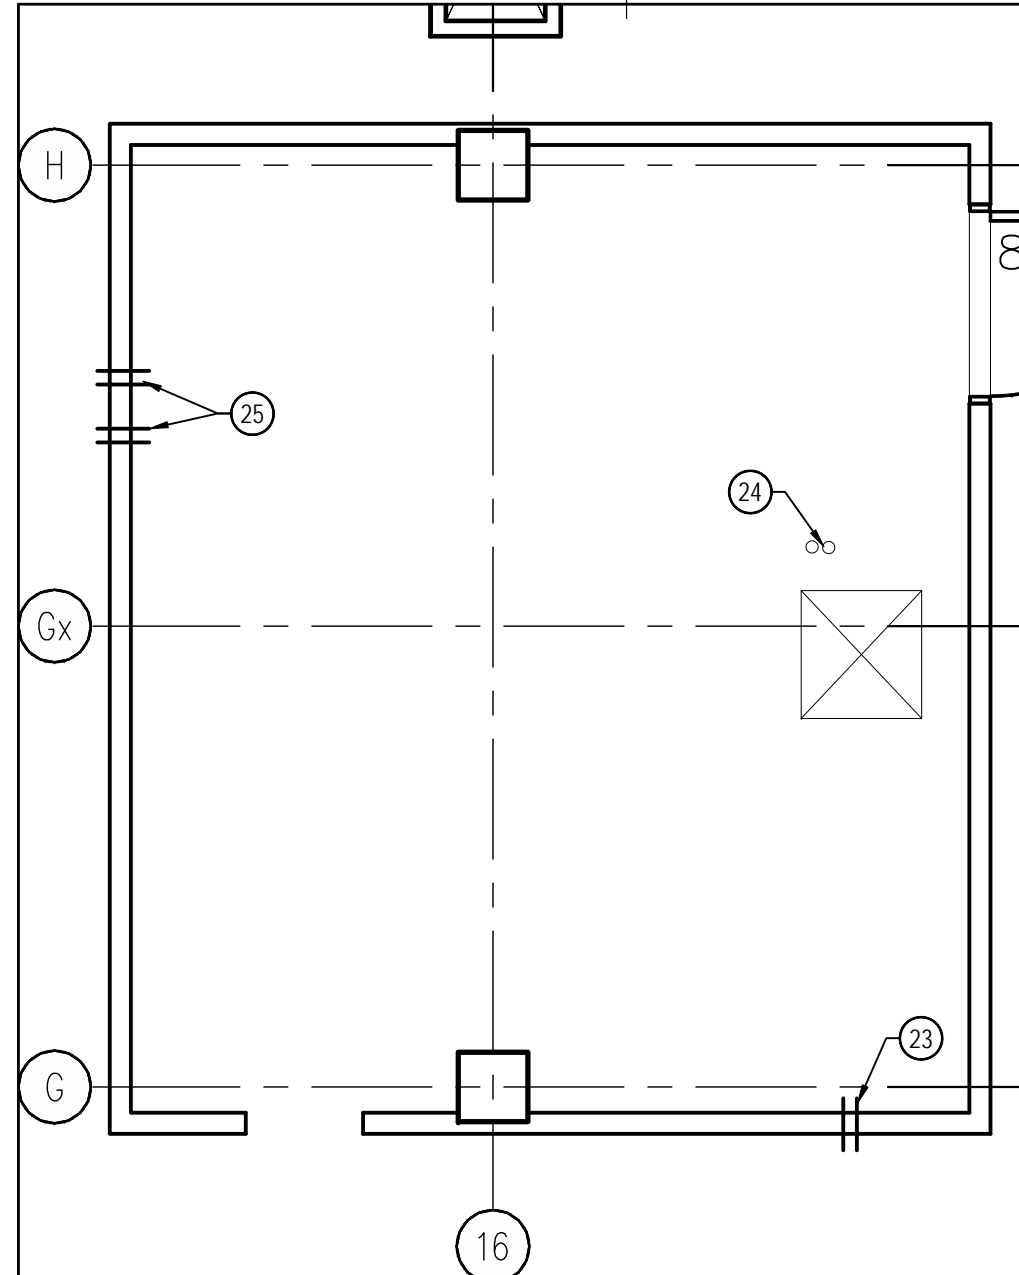


2 PARTIAL PLAN ENLARGEMENT- ELEVATOR 4 & 5 MACHINE ROOM
SCALE / ÉCHELLE - 1:50

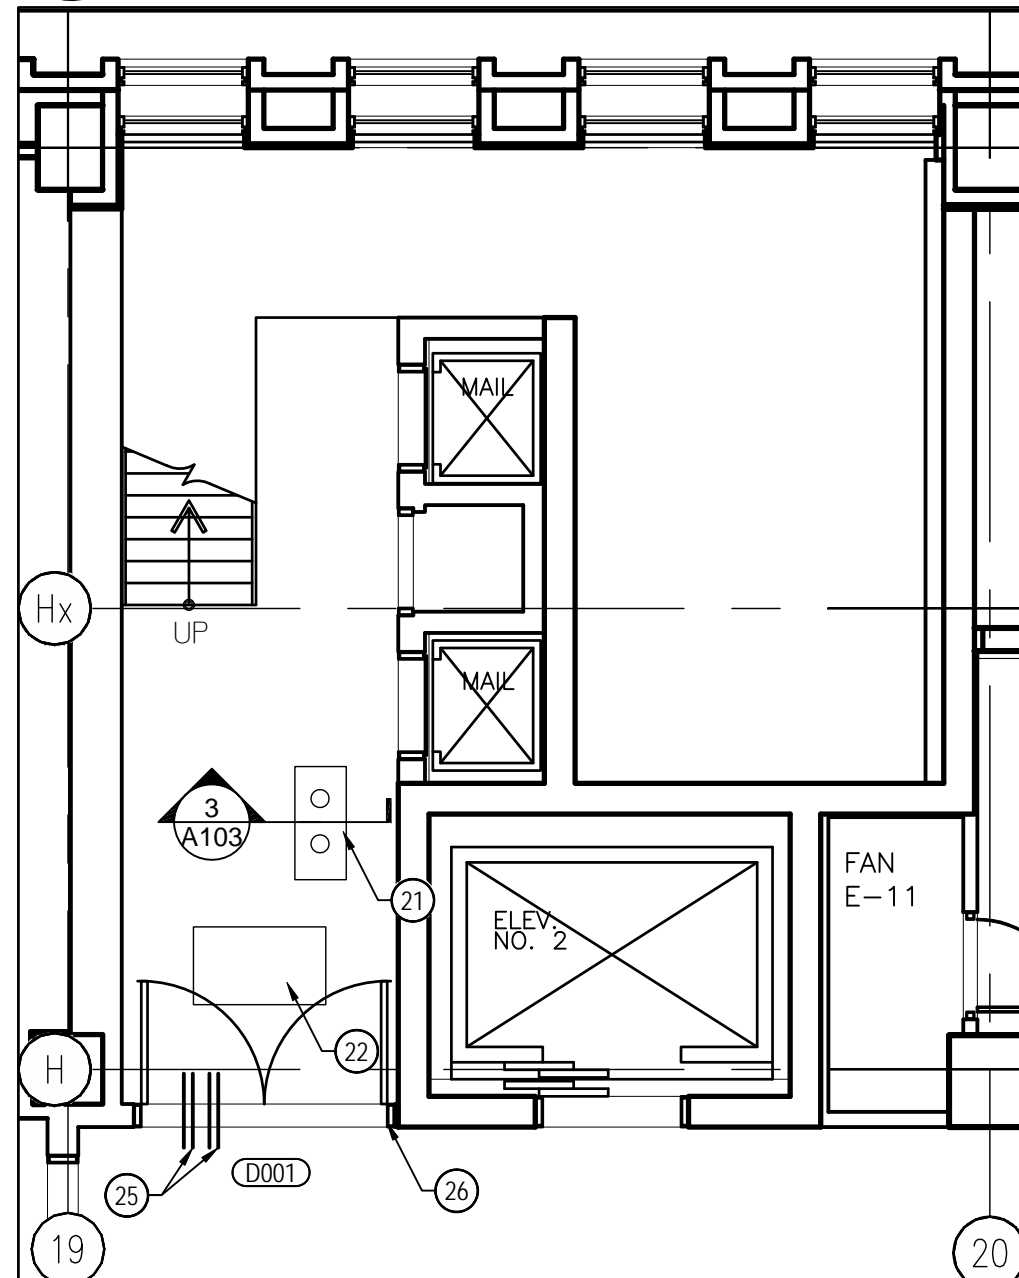


5 PARTIAL PLAN ENLARGEMENT- ELEVATOR 2 MACHINE ROOM
SCALE / ÉCHELLE - 1:50

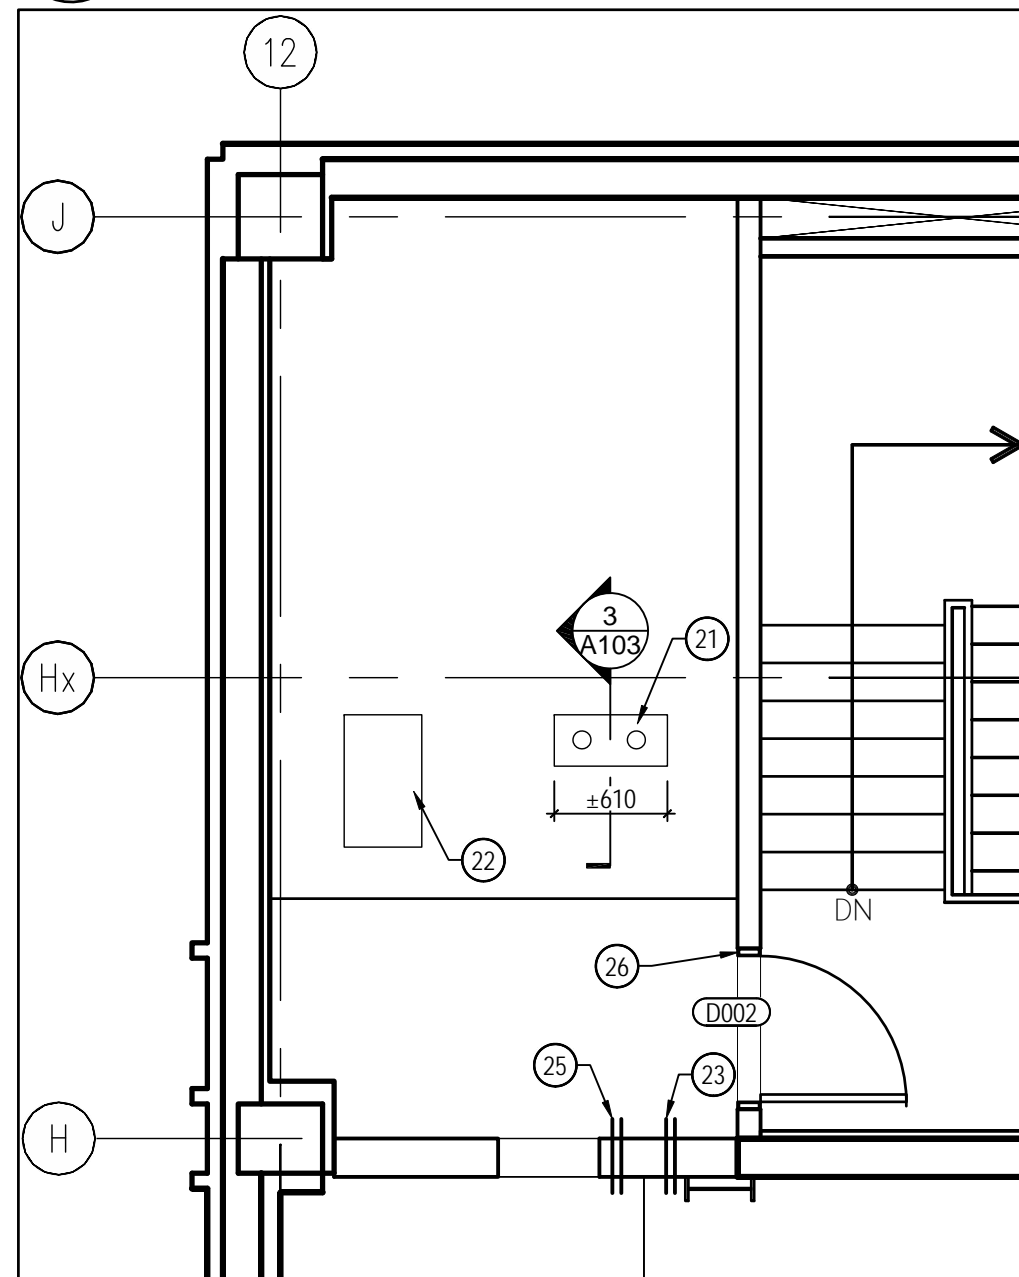


7 PARTIAL PLAN ENLARGEMENT- ELEVATOR 1 MACHINE ROOM
SCALE / ÉCHELLE - 1:50

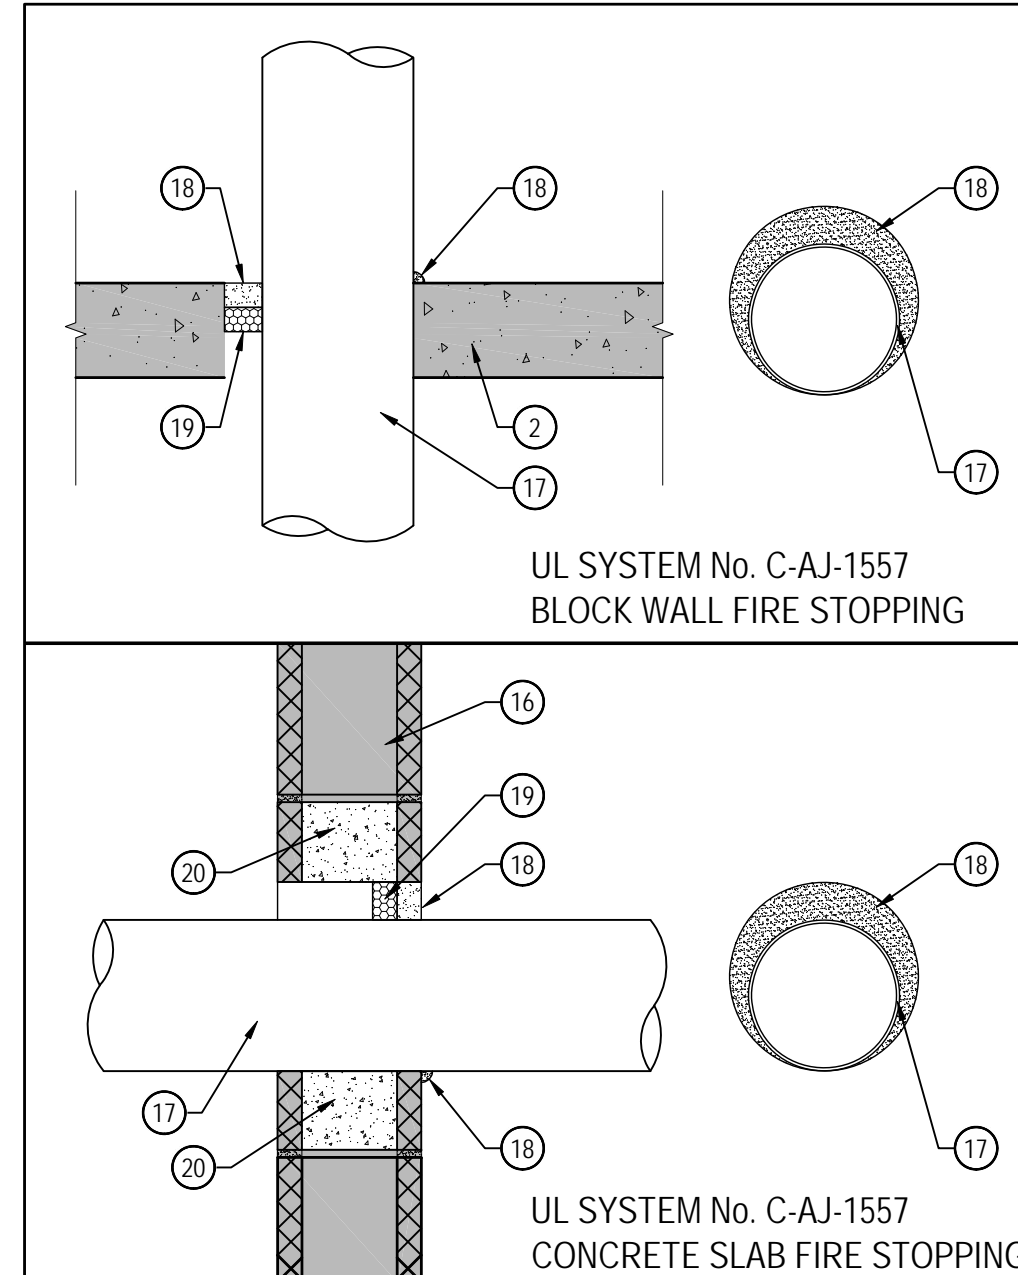

3 TYPICAL FIRE STOPPING DETAIL
SCALE / ÉCHELLE - 1:10

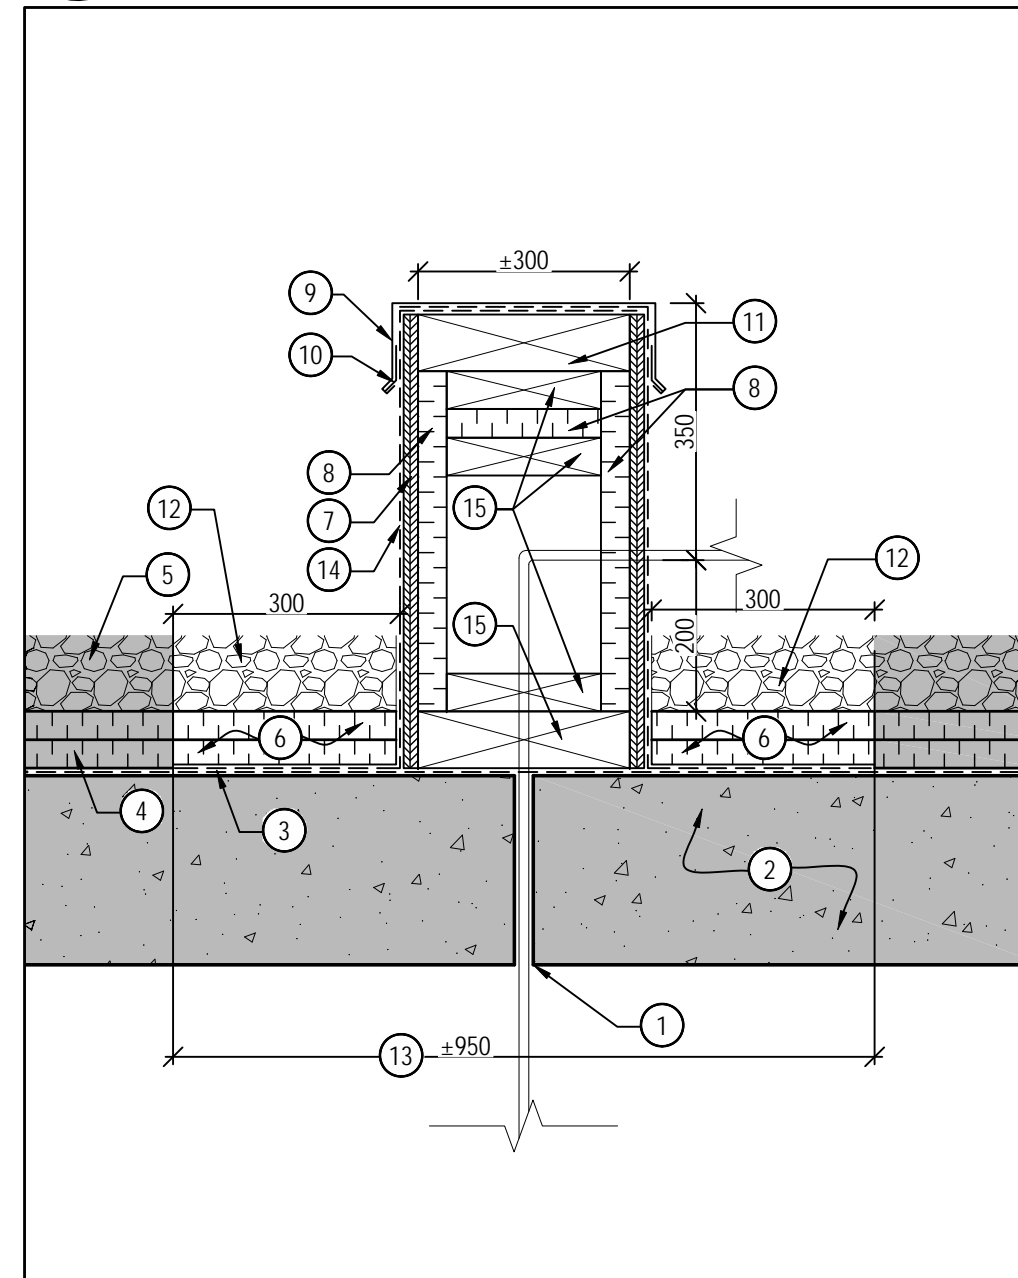


6 TYPICAL ROOF DETAIL
SCALE / ÉCHELLE - 1:10

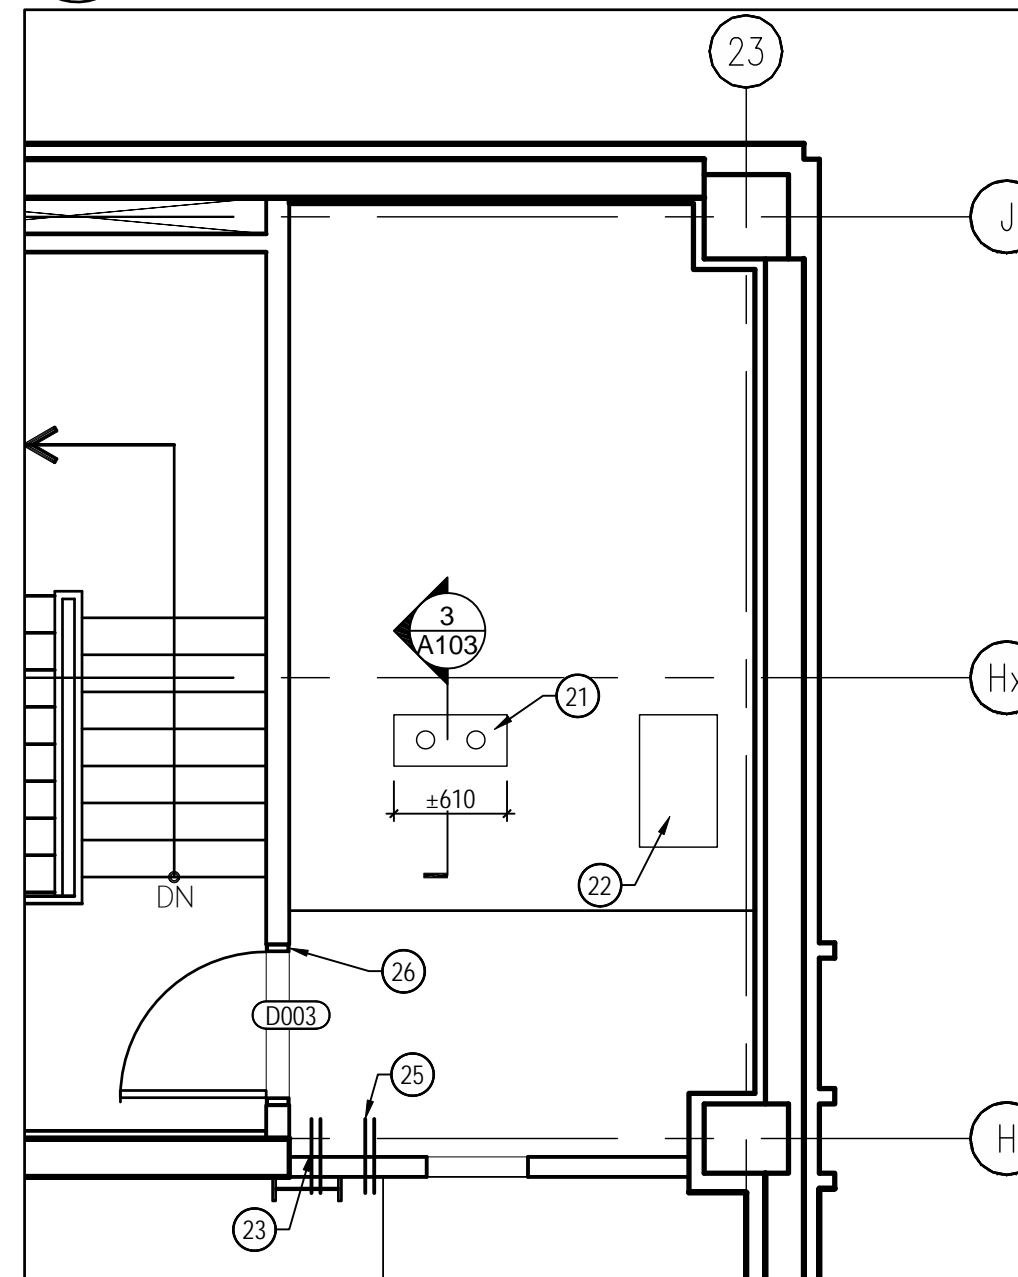

8 PARTIAL PLAN ENLARGEMENT- ELEVATOR 3 MACHINE ROOM
SCALE / ÉCHELLE - 1:50

NOTES

- CONCRETE CORE FOR REFRIGERANT LINES. REFER TO MECHANICAL CONTRACTOR TO SCAN /X REF AREAS PRIOR TO CUTTING.
- EXISTING CONCRETE SLAB.
- EXISTING ASPHALT ROOFING.
- EXISTING 76mm RIGID INSULATION.
- EXISTING 100mm (APPROX.) CRUSH STONE.
- REINSTATE RIGID INSULATION AFTER PATCHING.
- 19mm PLYWOOD.
- 38mm RIGID INSULATION.
- PRE-FINISHED SLOPED METAL CAP FLASHING.
- CONTINUOUS REGLET CLIP.
- N/A
- REINSTATE CRUSHED STONE.
- AREA OF RIGID INSULATION REMOVAL.
- 2 PLY HOT APPLIED ASPHALT ROOFING PATCH.
- WOOD BLOCKING CUT TO SUIT.
- CONCRETE BLOCK WALL.
- STEEL PIPE / ELECTRICAL CONDUIT PENETRATION.
- FIRE STOP SYSTEM. FILL, VOID OR CAVITY.
- FIRE STOP SYSTEM PACKING MATERIAL.
- CONCRETE GROUT.
- AREA OF ROOF DUCT ABOVE ON ROOF. REFER TO DETAIL 6 / A103. PROVIDE 2 CORES AS INDICATED IN MECHANICAL & ELECTRICAL PLANS.
- LOCATION OF CONDENSER ABOVE ON ROOF.
- PROVIDE CONCRETE CORE AND FIRE STOPPING FOR MECHANICAL CONDENSATE LINE. CONTRACTOR TO SCAN /X REF AREAS PRIOR TO CUTTING.
- PROVIDE SLAB CORES FOR REFRIGERATION LINES (2 CORES) CONTRACTOR TO SCAN /X REF AREAS PRIOR TO CUTTING.
- PROVIDE CORING AND FIRE STOPPING FOR ELECTRICAL CONDUIT COMMUNICATION LINES. CONTRACTOR TO SCAN /X REF AREAS PRIOR TO CUTTING.
- REMOVE EXISTING DOOR FRAME AND HARDWARE. REPLACE. REFER TO DOOR SCHEDULE 5 / A100 AND SPECIFICATIONS.
- EXISTING WALL FINISH.
- SURFACE MOUNTED 3mm STAINLESS STEEL PLATE.
- SUPPORT WALL.
- CALL BUTTON.
- ADHESIVE BOLT FASTENERS.
- MULTIPLE SATELLITE DISH SUPPORT.
- METAL SLEEVE FLASHING.
- SEAL BONDED TO METAL SLEEVE.

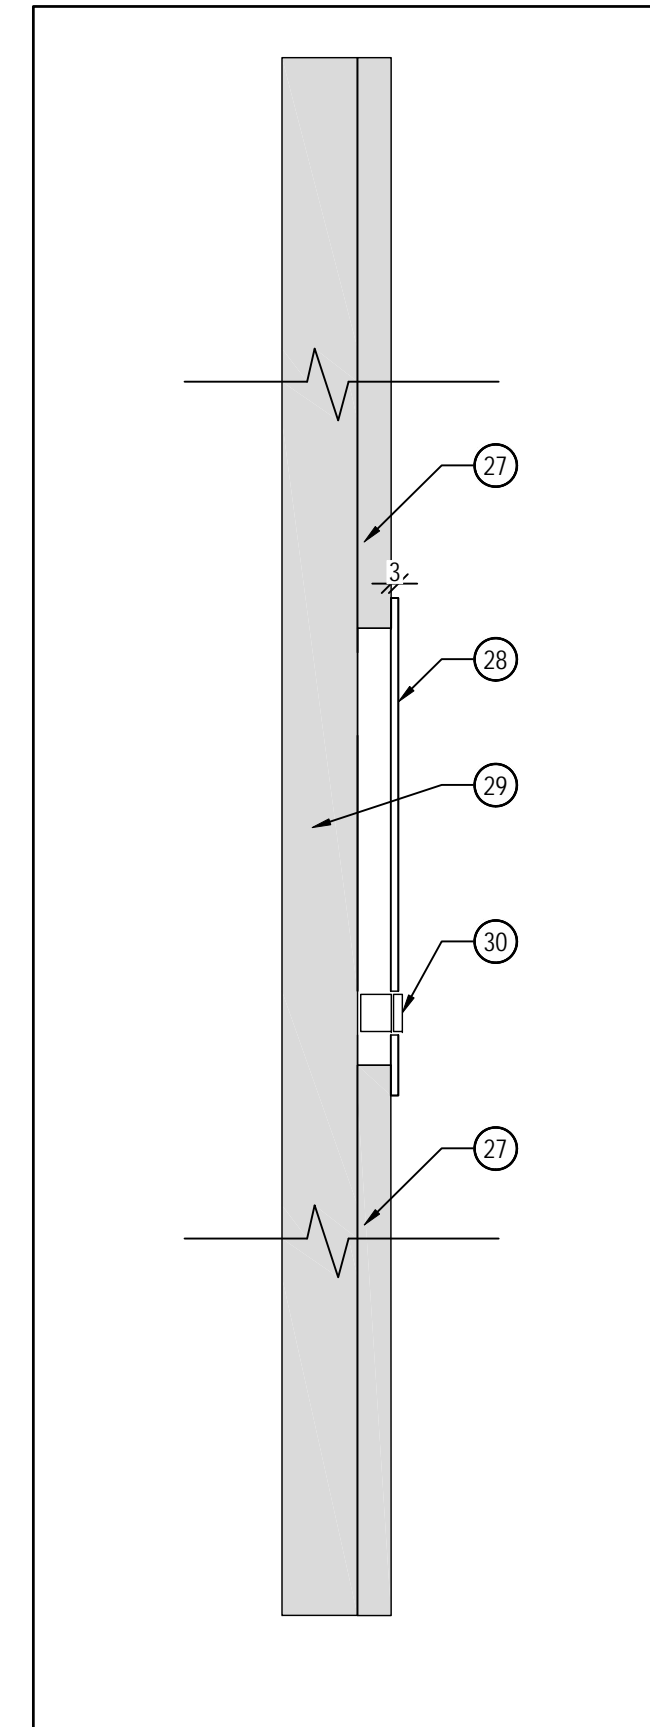

9 HALL STATION CALL BUTTON PLATE
SCALE / ÉCHELLE - N.T.S.

Publics Works and
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KEY PLAN
PLAN - REPÈRE

Contractor to verify all dimensions
& conditions on site and immediately
notify the engineer of all discrepancies.

1	ISSUED FOR TENDER	2013/04/04
revisions	description	date
A	detail no.	
B	location drawing no.	
C	drawing no.	

project

project

PUBLIC ARCHIVES
NATIONAL LIBRARY
ELEVATOR MODERNIZATION

395 WELLINGTON STREET

drawing

dessin

DETAILS

Designed By
L. BOONSTRA
2012/09/27

Conçu par
L. BOONSTRA
(yyyy/mm/dd)

Drawn By
N. BARRETO
2012/09/28

Dessiné par
N. BARRETO
(yyyy/mm/dd)

Reviewed By
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2012/10/10

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(yyyy/mm/dd)

Approved By
D. ROBERTSON
2012/10/10

Approuvé par
D. ROBERTSON
(yyyy/mm/dd)

Tender
MARC SAUCIER
Project Manager

Soumission
Administrateur de projets

Project no.
R.042454.002

No. du projet

Drawing no.
A103

No. du dessin