




**lectec**  
electrical engineering consultants  
Francis Sheel  
Lower Sackville, NS  
Phone (902) 250-7255  
Fax (902) 250-0729  
W W W . e e b c i . c o m

1	ISSUED FOR ADDENDUM	18 SEP 13
0	ISSUED FOR TENDER	19 AUG 13
B	ISSUED FOR 99% REVIEW	16 JUL 13
A	ISSUED FOR 60% REVIEW	28 JUN 13
revisions		date

project  
CANADA REVENUE AGENCY  
SPACE OPTIMIZATION PROJECT  
CASH COUNTER RENOVATIONS  
RALSTON BLDG – 1557 HOLLS STREET  
HALIFAX – NS


drawing	design
LEVEL 300 REFLECTED CEILING PLAN & SINGLE LINE DIAGRAM	
designed DC	conçu
date JUNE 2013	
drawn RBJ	dessiné
date JUNE 2013	
approved	approuvé
date	
Tender ALLAN MCNEILL	Submission
PMWSC Project Manager	Administrateur de projet TPSCC
project number R.053258.004	no. du projet

drawing no. E2  
no. du dessin

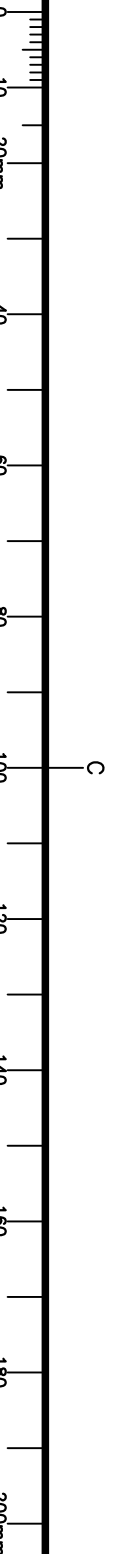

SCALE : 1:100  
0m 1m 2m 3m 4m 5m 6m 7m 8m 9m 10m

1 REFLECTED CEILING PLAN  
E2

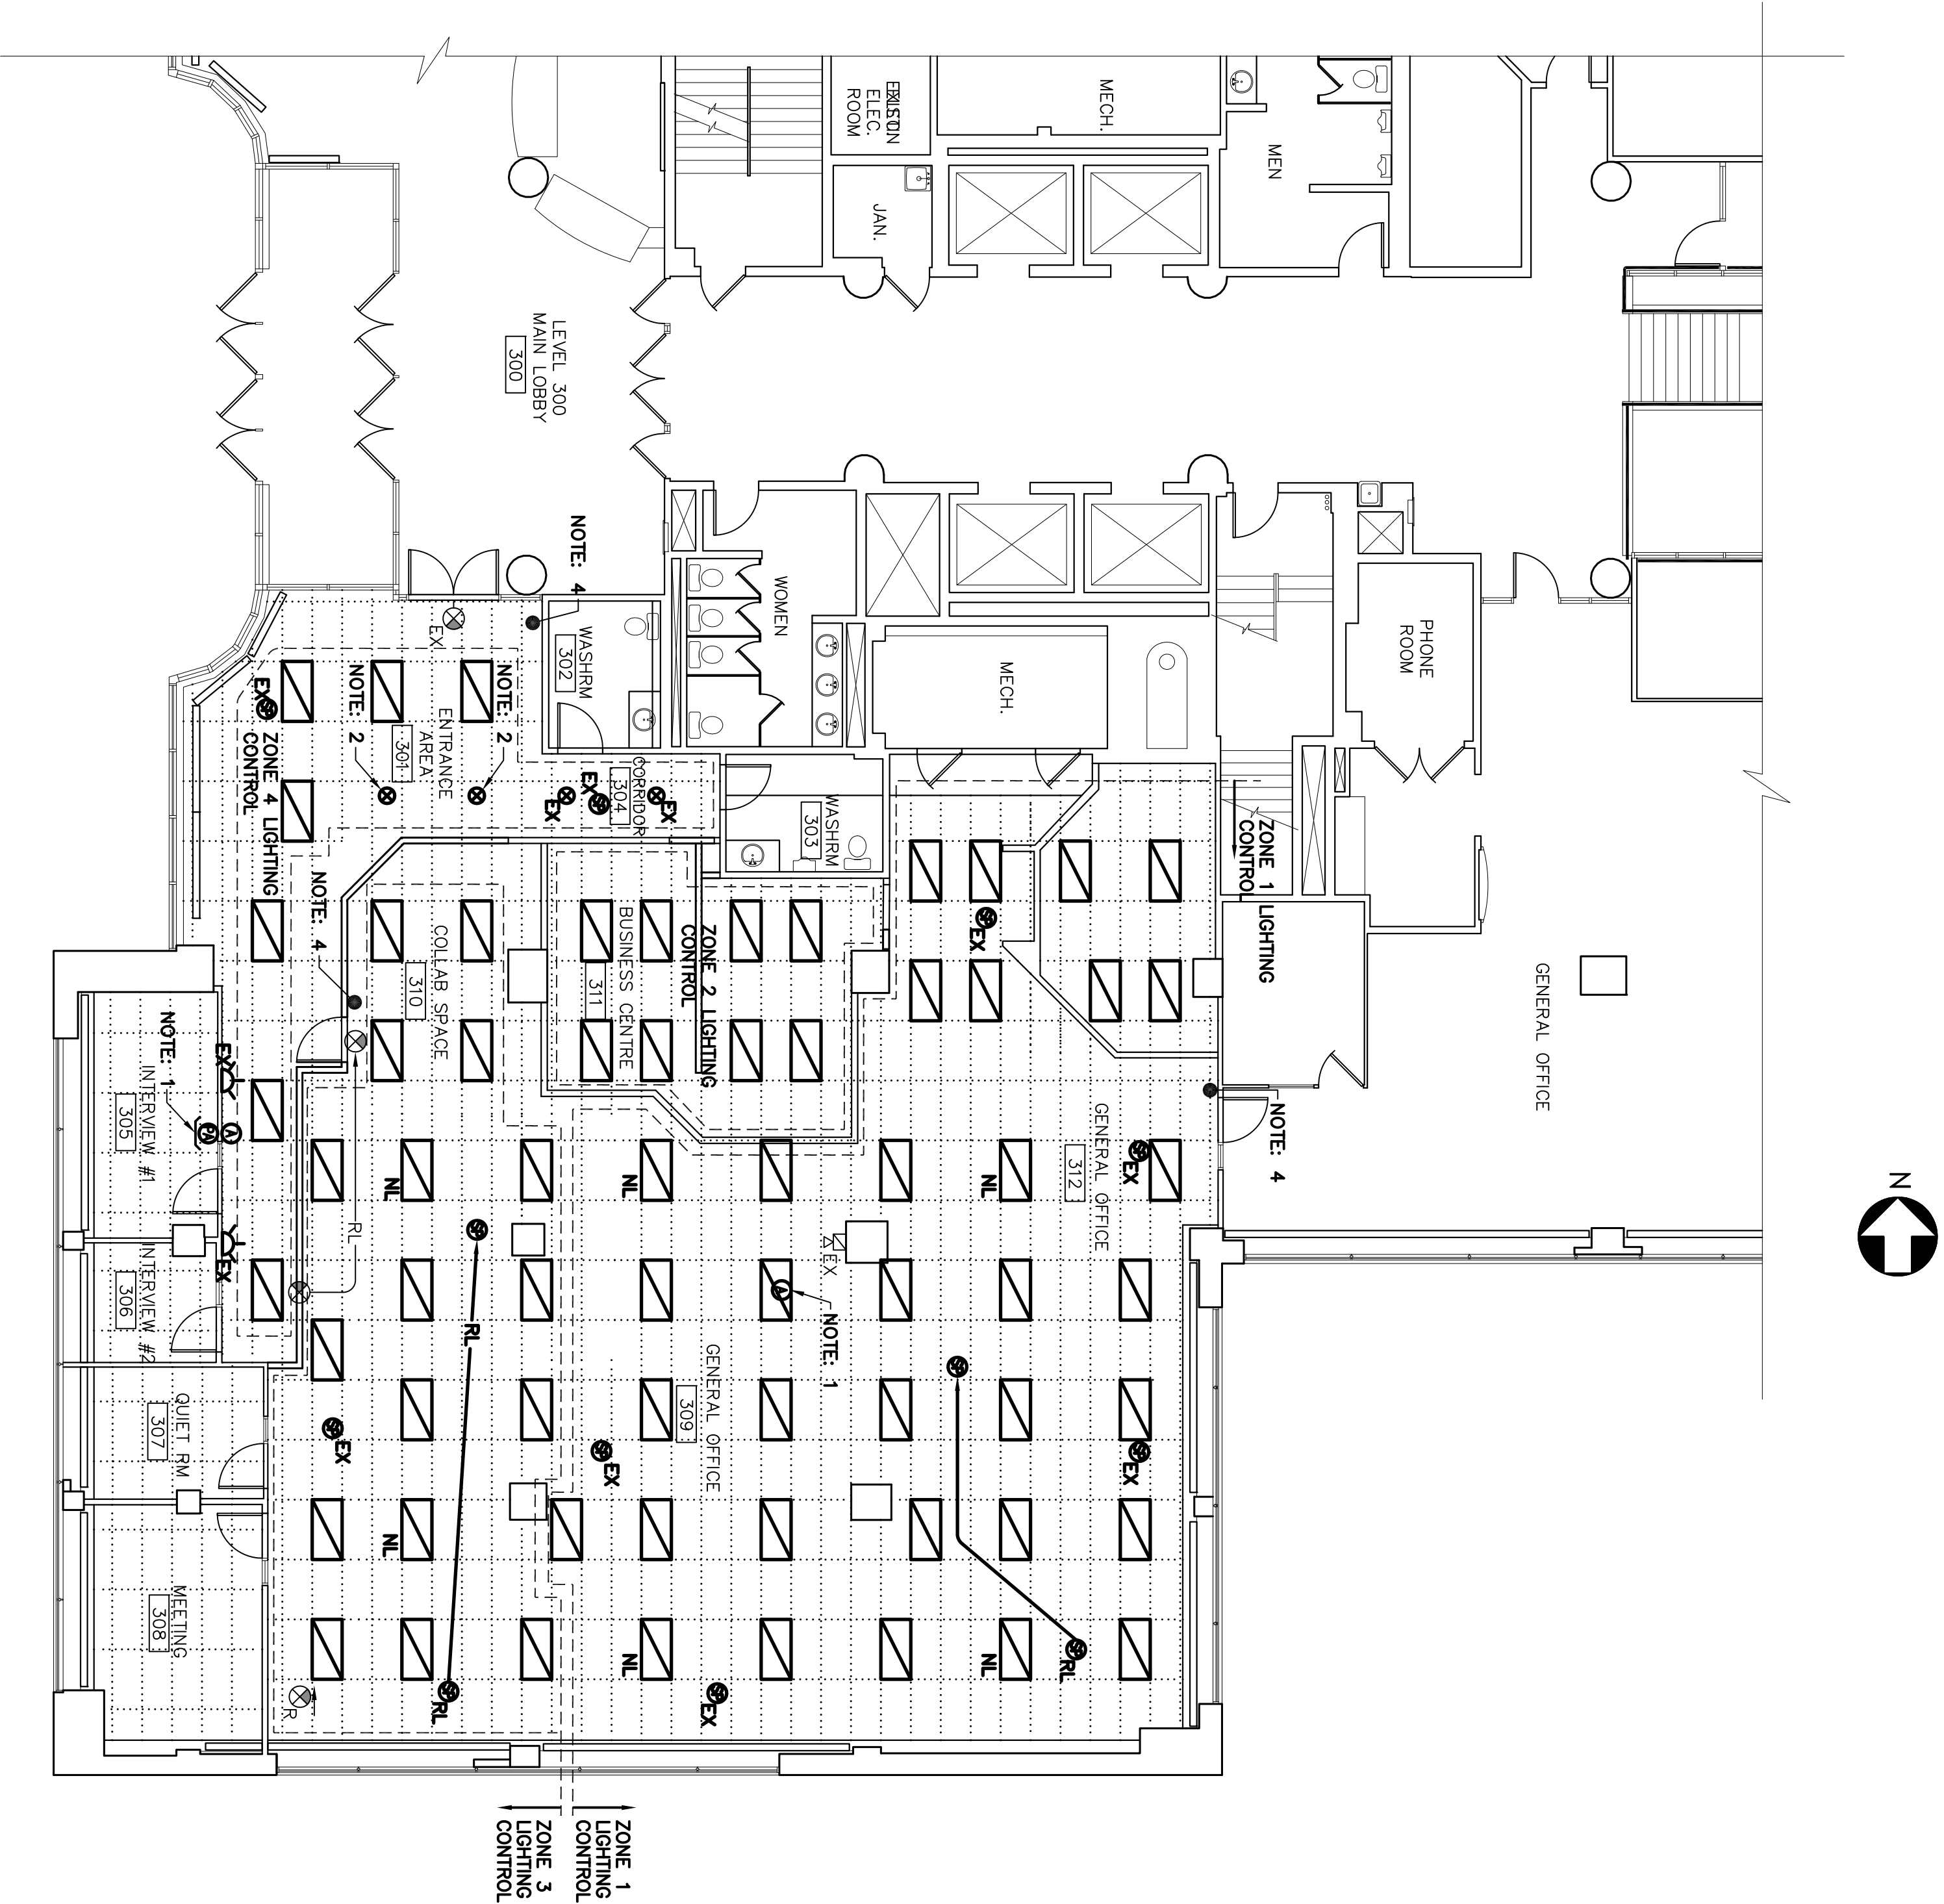

- LEGEND
- EXISTING RECESSED POT LIGHT
  - ⊗ EXISTING WALL MOUNTED EXIT/SORTIE LIGHT FIXTURE
  - ⊗ EXISTING CEILING MOUNTED EXIT/SORTIE LIGHT FIXTURE
  - SPEAKER
  - AMBER LIGHT – PART OF THE SECURITY SYSTEM
  - ⊗ PANIC ALARM PUSH BUTTON – PART OF THE SECURITY SYSTEM
  - ⊗ FIRE ALARM COMBINATION HORN/STROBE
  - ⊗ INDICATES EXISTING EQUIPMENT TO BE REMOVED
  - R INDICATES EXISTING EQUIPMENT TO BE RELOCATED
  - RL INDICATES EXISTING EQUIPMENT TO REMAIN
  - N INDICATES NEW EQUIPMENT
  - INDICATES LOCATION OF RELOCATED AND EXISTING LIGHT SWITCHES
  - ⊗ EXISTING AND NEW PARABOLIC LIGHTING FIXTURES
  - NL – INDICATES A NIGHT LIGHT

NOTES.

- RELOCATION OF AMBER LIGHT AND DURESS ALARM BY THE TENANTS SECURITY CONTRACTOR. ELECTRICAL CONTRACTOR SHALL SUPPLY AND INSTALL 120 VOLT WIRING AND CONDUIT IN THE WALL FOR AMBER LIGHT AND DURESS ALARM.
- RELOCATE 2 EXISTING POT LIGHTS AND CONNECT POWER TO THE EXISTING POT LIGHTS.
- ELECTRICAL CONTRACTOR SHALL RELOCATE EXISTING FLUORESCENT, RECESSED FIXTURES AND SUPPLY NEW FIXTURES TO MATCH EXISTING.
- REMOVE A FLEXIBLE LIGHTING LAYOUT AS SHOWN/INDICATE NEW AND EXISTING FIXTURES FOR ZONES 1 TO 4 SHOWN ON THIS DRAWING.
- REMOVE EXISTING BRANCH CIRCUIT WIRING TO SUPPLY POWER TO THE REMOVED LIGHTING LAYOUT. REMOVE BRANCH CIRCUIT WIRING AND/OR CONDUIT NO LONGER REQUIRED FOR THE REVISED LIGHTING LAYOUT.
- PROVIDING CIRCUITING AS REQUIRED FOR THE NIGHT LIGHTS.
- AT THE TIME OF FINAL CLEANING, CLEAN ALL LIGHT FIXTURE REFLECTORS, LENSES (INSIDE AND OUTSIDE) LAMPS AND OTHER LIGHTING SURFACES THAT HAVE BEEN EXPOSED TO CONSTRUCTION DUST AND DIRT.

