BLAINE LAKE POLICE BUILDING RENOVATIONS - BLAINE LAKE,

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EGEND

DRAWING REFERENCE SYMBOLS

(No.) GRID-LINE IDENTIFICATION

NO. DETAIL SHEET

No. SHEET WALL SECTION

No. SHEET BUILDING SECTION

Z O. ELEVATION DEMARCATION ROOM NUMBER

NAME No. ROOM ROOM NUMBER

No. DOOR IDENTIFICATION

≻ ASSEMBLY IDENTIFICATION

 \bigcirc (REFER TO SCHEDULE)

(<u>s</u> FINISH IDENTIFICATION

PLAN ELEVATION IDENTIFICATION

œ

ABBREVIATIONS

BOTH SIDES CLEANOUT ABOVE FINISHED FLOOR

A.F.F. B/S C.O.

DETENTION DOOR DETENTION FRAME COMPLETE WITH

무응 DOOR

묾 EACH

EXP. \mathbb{F} **EXPOSED**

F.E.C. F.R.R. GB FIRE EXTINGUISHER CABINET FIRE RESISTANT RATING GYPSUM BOARD

FLOOR DRAIN

무유

FD

MAT'L. HARDWARE HOLLOW CORE HOLLOW METAL MATERIAL

N.I.C. NOT IN CONTRACT ON CENTRE PAINT

P.C. SIMILAR

SHEET VINYL

UNLESS NOTED UNDERSIDE OF WELDED STEEL TYPICAL

GENERAL NOTES

- WORK TO BE DONE IN ACCORDANCE WITH THE 2010 NATIONAL BUILDING CODE OF CANADA; CAN/SCA B651-95 BARRIER-FREE DESIGN; AND LOCAL/PROVINCIAL REGULATIONS OF AUTHORITIES HAVING JURISDICTION. (IN CASE OF CONFLICTING REQUIREMENTS, THE MORE RIGOROUS SHALL APPLY).
- 2 OWNER TO HAVE FIRST RIGHT OF REFUSAL ON ALL SALVAGE MATERIALS, TYPICAL.
- ы PATCHING: MAKE GOOD SURFACES AFFECTED BY NEW CONSTRUCTION TO MATCH EXISTING IN ACCORDANCE WITH FINISH SCHEDULES, EVEN WHEN AFFECTED SURFACE IS NOT WITHIN CONTRACTED RENOVATION AREAS. PATCH FLUSH AND SMOOTH WITH EXISTING. BUILD UP, TAPE, FILL AND SAND SURFACES SCHEDULED TO RECEIVE NEW FINISHES, FOR A SEAMLESS VISUAL APPEARANCE. MAKE GOOD VAPOUR BARRIERS WHERE AFFECTED.
- WASTE MANAGEMENT: REMOVE AND DISPOSE OF UNWANTED ITEMS. SEPARATE MATERIALS INTO SEPARATE STREAMS FOR RECYCLING WHERE FACILITIES EXIST
- ঢ় EXISTING STRUCTURE: OBTAIN CONSULTANT'S APPROVAL BEFORE CUTTING, BORING, OR SLEEVING LOAD-BEARING MEMBERS.
- ტ FIRE RATINGS: MAINTAIN CONTINUITY OF EXISTING ASSEMBLIES IDENTIFIED AS REQUIRING A FIRE RATING. PROVIDE FIRE—STOPPING AND DAMPERS AT NEW PENETRATIONS THROUGH RATED ASSEMBLIES. PROVIDE RATED PANELS WHERE REQUIRED TO ACCESS SERVICES CONCEALED IN RATED ASSEMBLIES.
- ALL PLUMBING; MECHANICAL; AND ELECTRICAL WORK SHALL BE AND DONE IN COMPLIANCE WITH ALL LOCAL CODES AND BYLAW THE NATIONAL CODES OF CANADA. CARRIED OUT AS WELL AS
- EXISTING EMERGENCY LIGHTING AND EXIT LIGHTING TO REMAIN OPERATIONAL, THROUGHOUT DURATION OF RENOVATION, TYPICAL.
- DO ALL MASONRY IN ACCORDANCE WITH CAN/CSA-A371-04.

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<u>.</u>

ALL ROOFING WORK IS TO BE DONE IN IN CONFORMANCE WITH CRCA STANDARDS.

LIST OF DRAWINGS:

<u>ARCHITECTURAL:</u>

A000 COVER SHEET, LEGEND, ABBREVIATIONS, GENERAL NOTES,
AND LIST OF DRAWINGS
A100 SITE PLAN: EXISTING

MAIN FLOOR PLAN: EXISTING/DEMOLITION BASEMENT AND CRAWL SPACE PLAN: EXISTING,

A202 A201 MAIN FLOOR PLAN: EXISTING/PROPOSED

A203 SECOND FLOOR PLAN: EXISTING/REFERENCE

A206 A205 A204 MAIN FLOOR REFLECTED CEILING PLAN: EXISTING/DEMOLITION /PROPOSED

SECOND FLOOR REFLECTED CEILING PLAN: EX

A400 A207 A208 A209 ROOM FINISH SCHEDULES AND ASSEMBLIES DETAILS: ROOM 109 FINISHES

PLAN DETAILS: DEMOLITION PLAN DETAILS: PROPOSED

Janada

E200 E201 E202 BASEMENT PLAN: ELECTRICAL MAIN FLOOR PLAN: ELECTRICAL

SECOND FLOOR PLAN: ELECTRICAL MAIN FLOOR PLAN: SECURITY

/PROPOSED

BASEMENT REFLECTED CEILING PLAN: EXISTING

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MAIN FLOOR REFLECTED CEILING PLAN: EXISTI ISTING/REFERENCE NG/PROPOSED

DOOR AND HARDWARE SCHEDULES

INTERIOR ELEVATIONS

MECHANICAL:

M300 M201 M200 MECHANICAL BASEMENT PLAN PROPOSED PLUMBING MECHANICAL BASEMENT PLAN EXISTING/PROPOSED HVAC MECHANICAL MECHANICAL MAIN FLOOR PLAN EXISTING/PROPOSED PLUMBING MECHANICAL MAIN FLOOR PLAN EXISTING/PROPOSED HVAC **SCHEDULES**

ELECTRICAL:

E301 E302 SECURITY DETAILS

BLAINE LAKE, SASKATCHEWAN

POLICE BUILDING RENOVATIONS

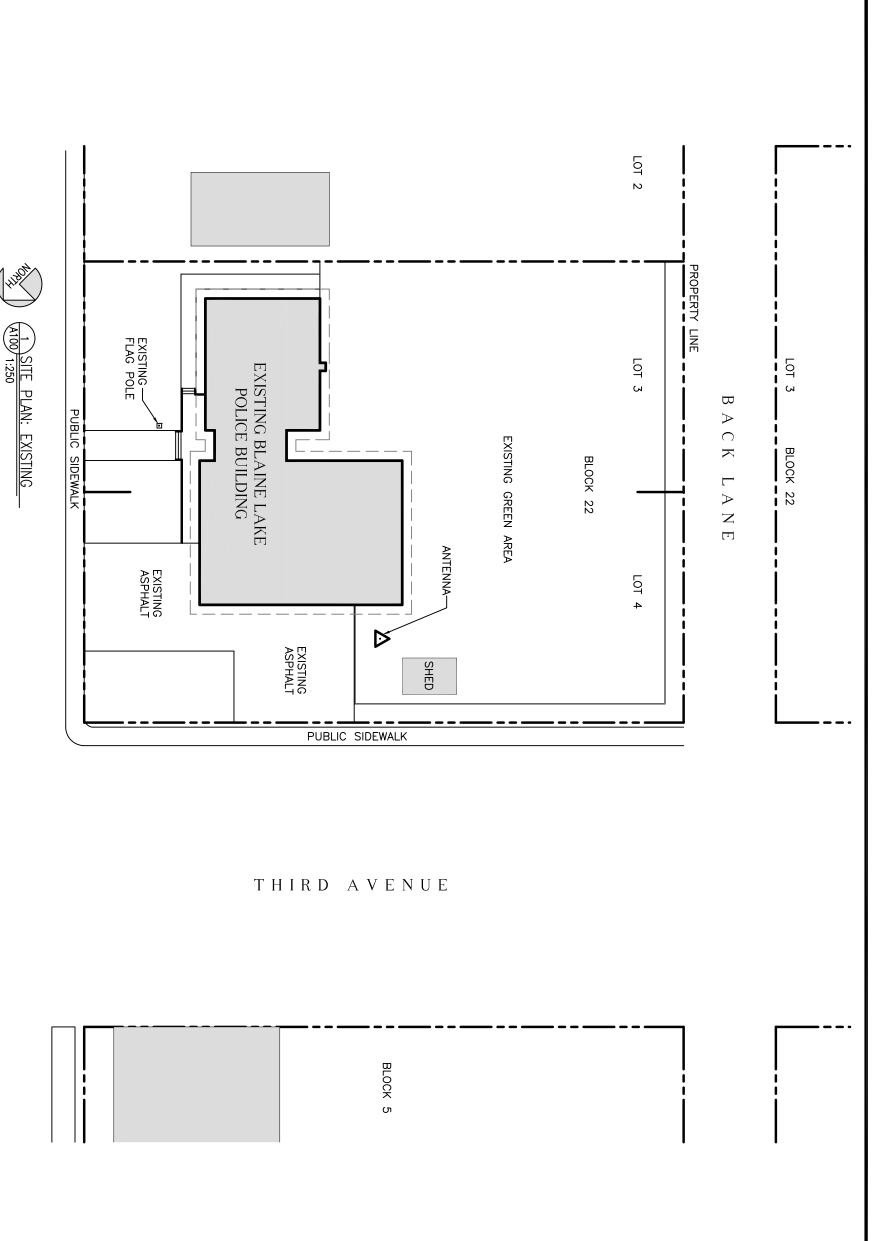
BLAINE LAKE

DRAWING:

LEGEND, ABBREVIATIONS GENERAL NOTES AND LIST OF DRAWINGS COVER SHEET,

PROJECT No:	SCALE:
651b-13	AS NOTED
DATE:	DRAWN BY:
2013/10/11	LS, CG

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BLAINE LAKE

POLICE BUILDING RENOVATIONS

BLAINE LAKE, SASKATCHEWAN

DRAWING:

SITE PLAN: **EXISTING**

PROJECT No: 651b-13 SCALE: AS NOTED

MAIN

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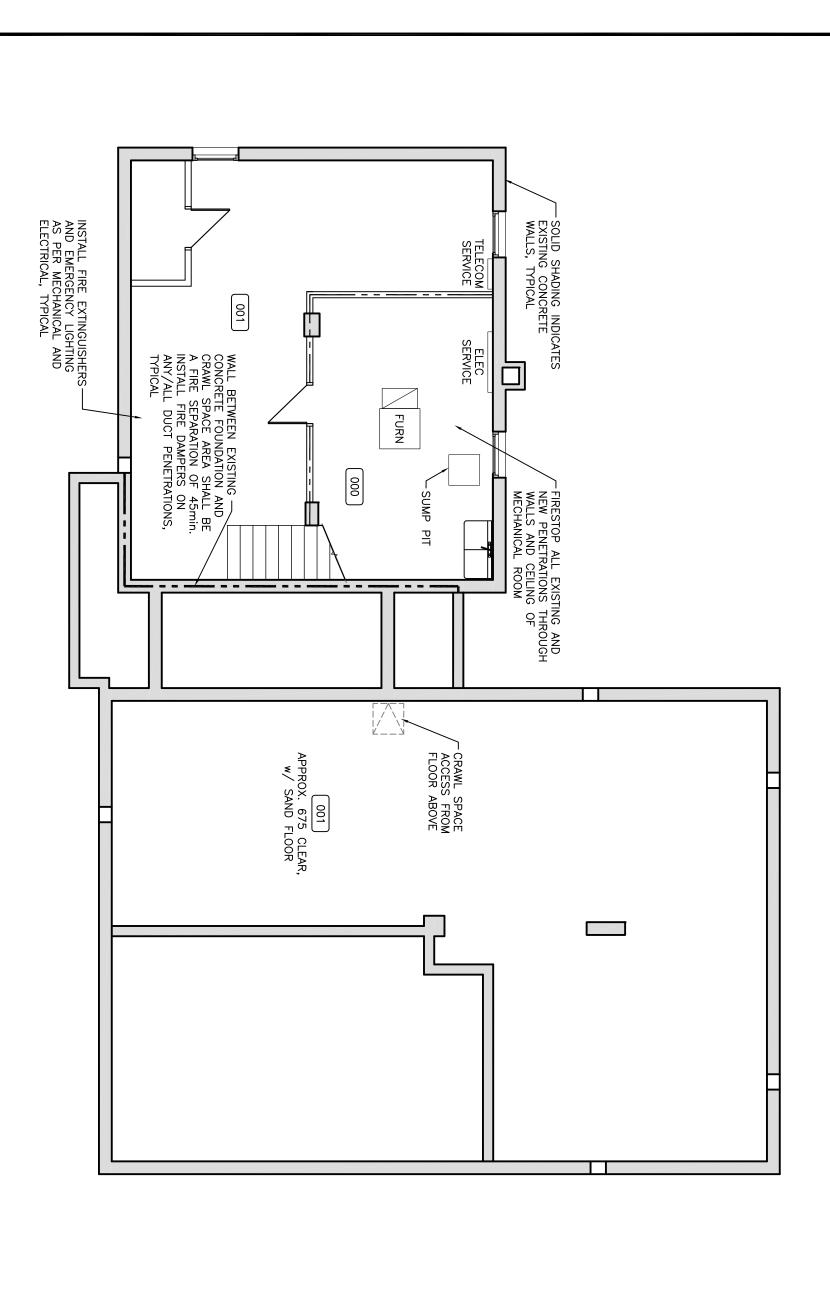
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DATE: 2013/10/11

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PLOT No:

BASEMENT PLAN: EXISTING/PROPOSED

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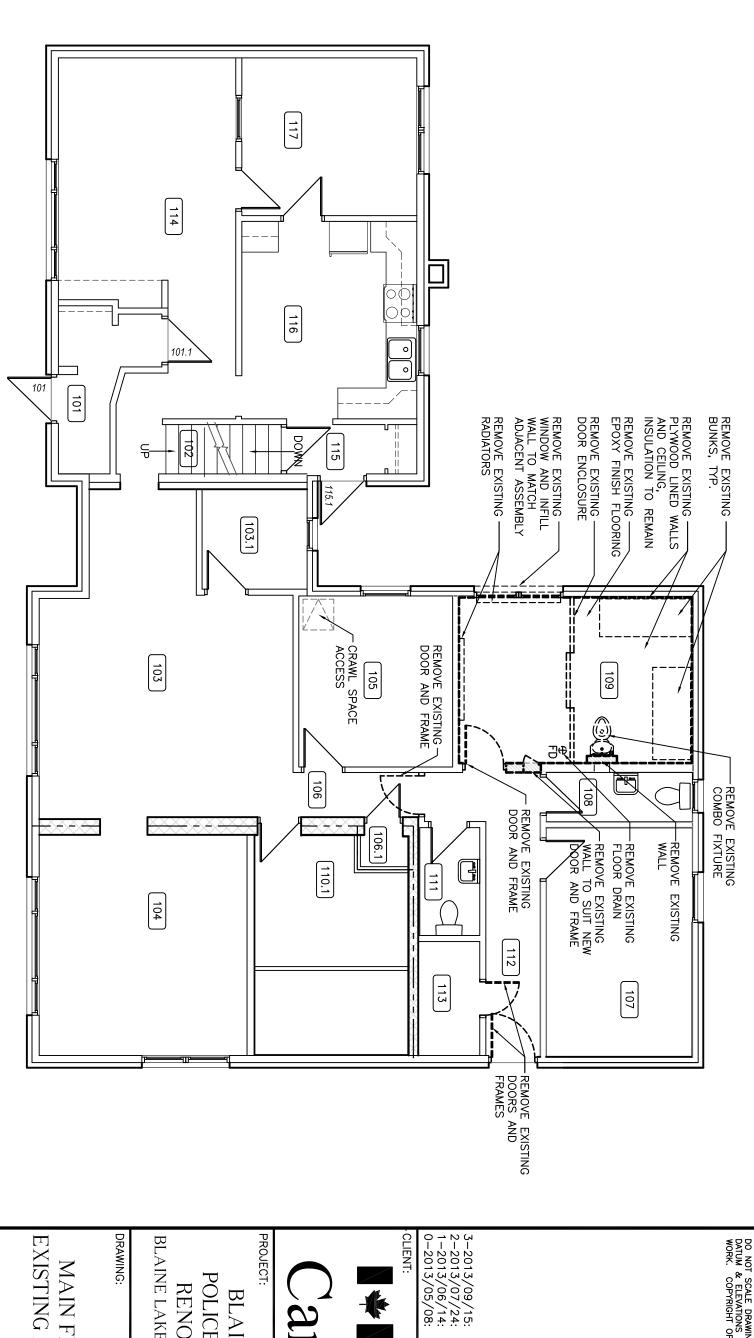
RENOVATIONS

BLAINE LAKE, SASKATCHEWAN

DRAWING:

EXISTING / PROPOSED CRAWL SPACE PLAN: **BASEMENT AND**

DATE: 2013/10/11 651b-13 PROJECT No: DRAWN BY: LS, CG AS NOTED





MAIN FLOOR PLAN: EXISTING/DEMOLITION

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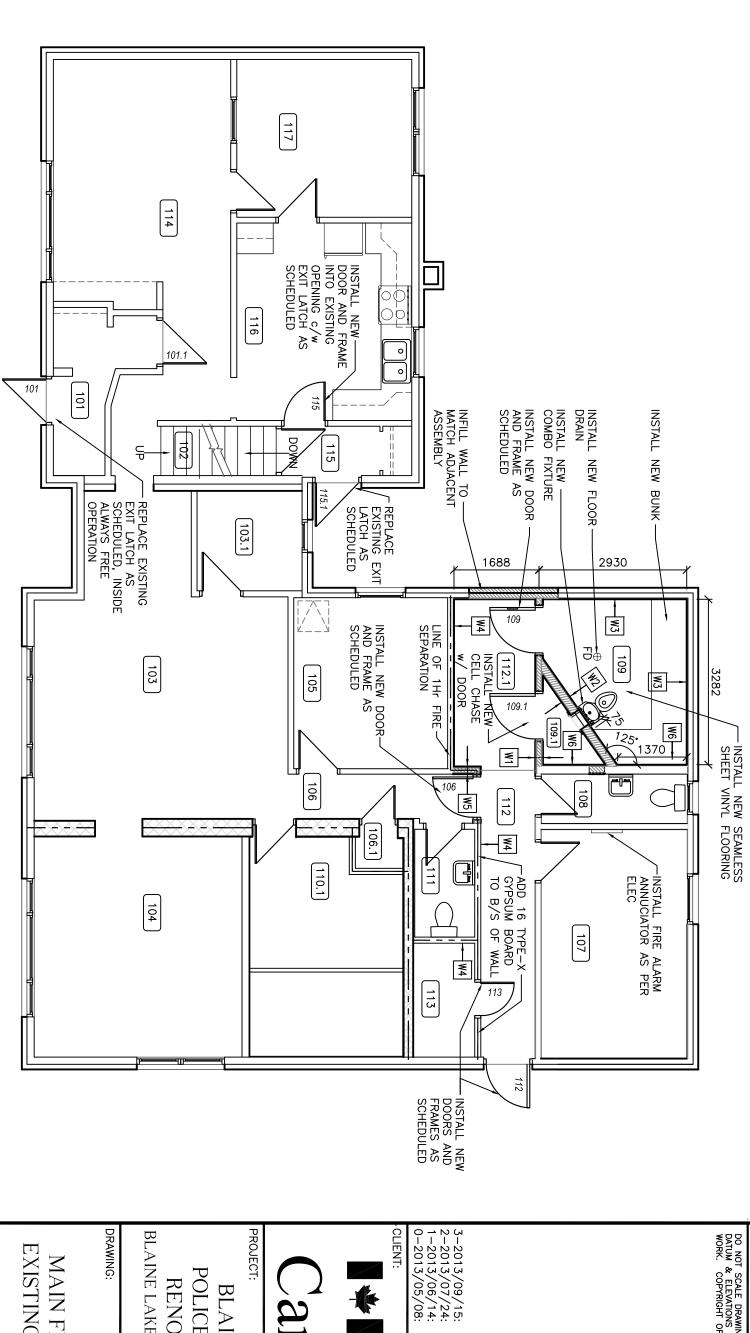
BLAINE LAKE, SASKATCHEWAN

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POLICE BUILDING RENOVATIONS **BLAINE LAKE**

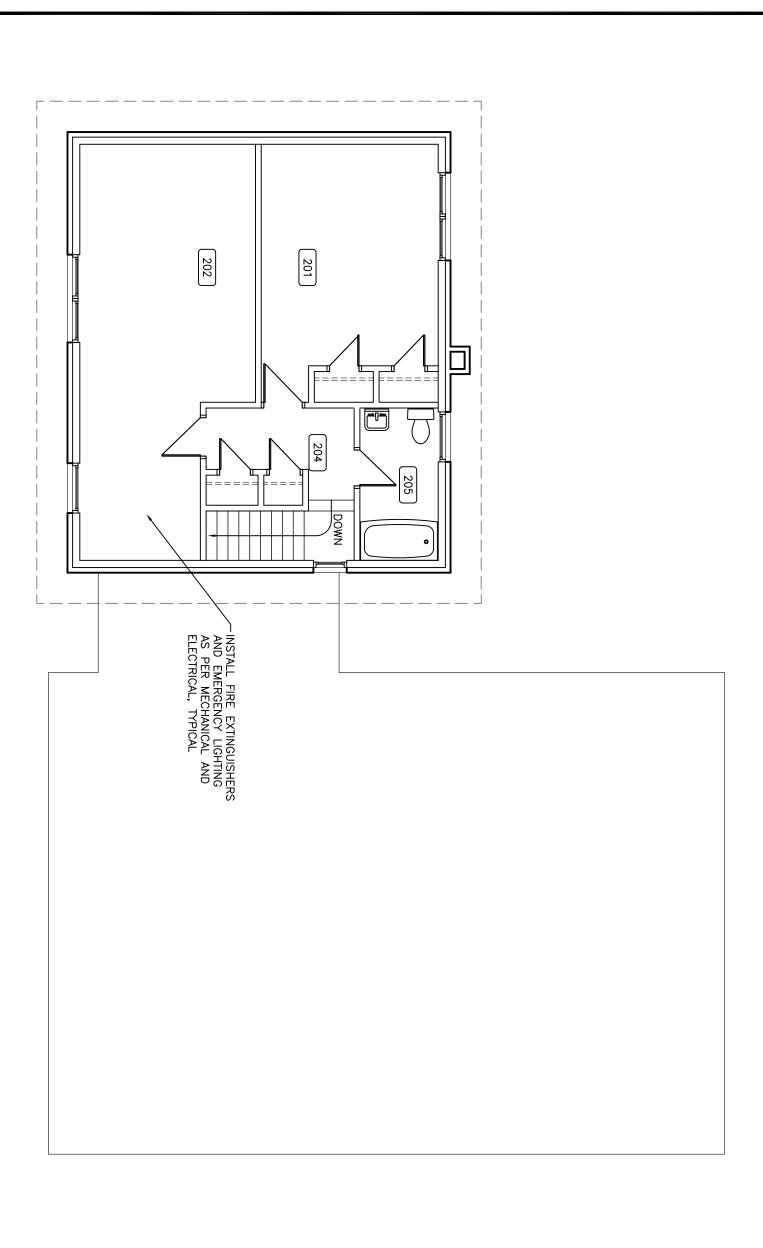
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SECOND FLOOR PLAN: EXISTING / REFERENCE



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POLICE BUILDING RENOVATIONS **BLAINE LAKE**

BLAINE LAKE, SASKATCHEWAN

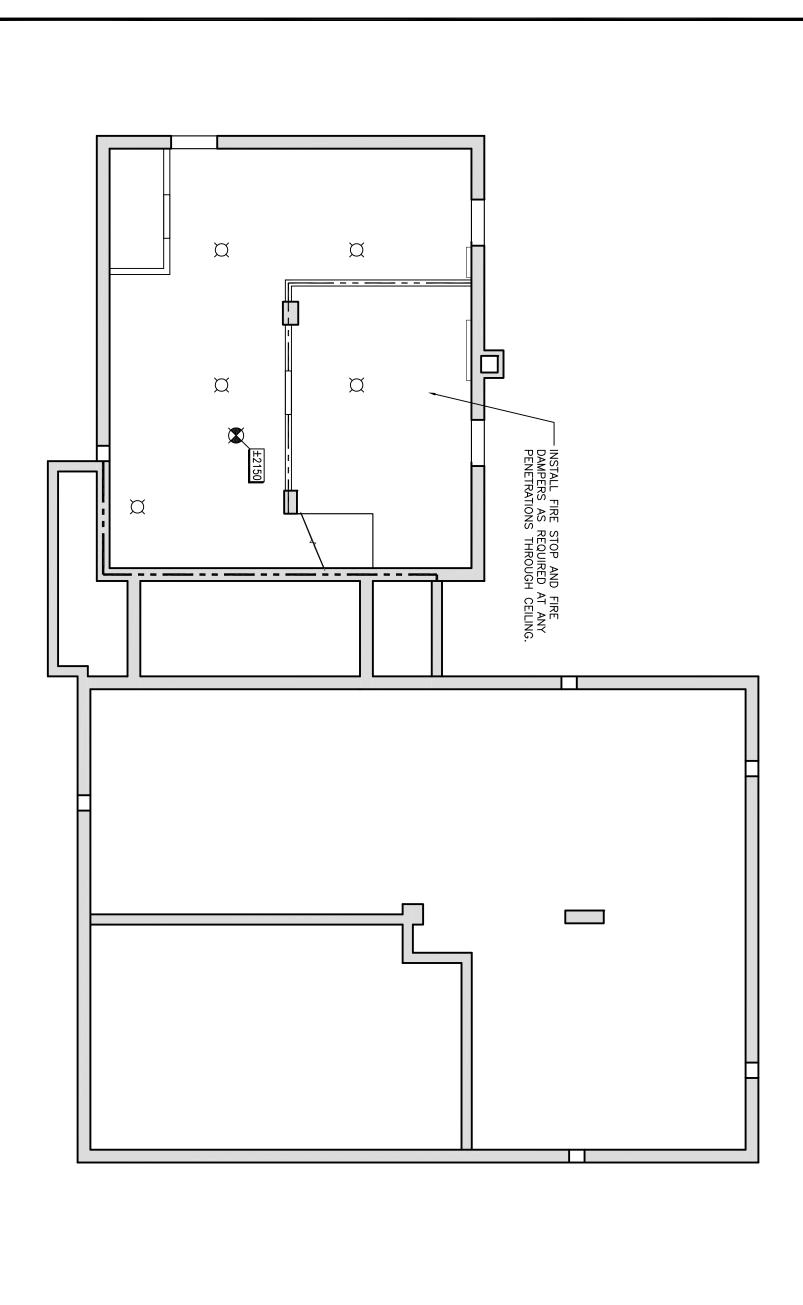
DRAWING:

EXISTING / REFERENCE SECOND FLOOR PLAN:

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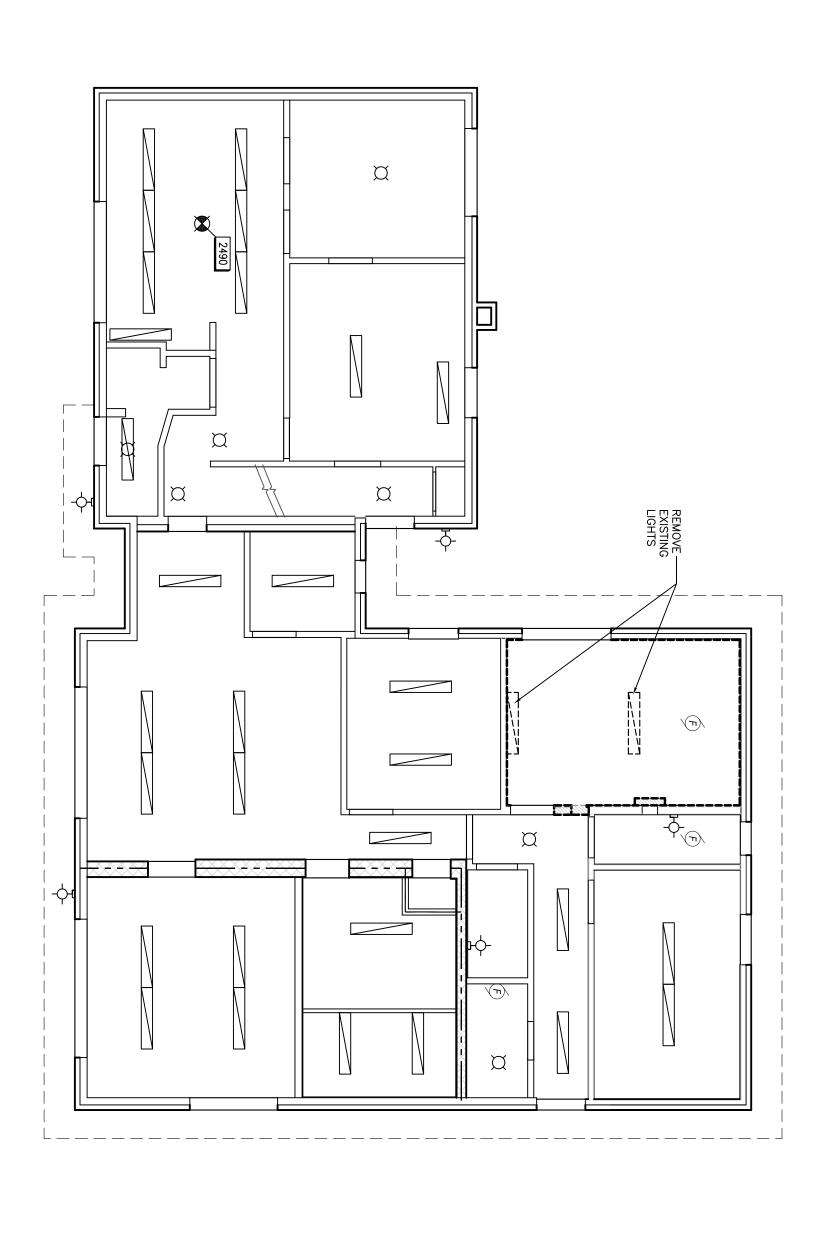
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POLICE BUILDING RENOVATIONS **BLAINE LAKE**

BLAINE LAKE, SASKATCHEWAN

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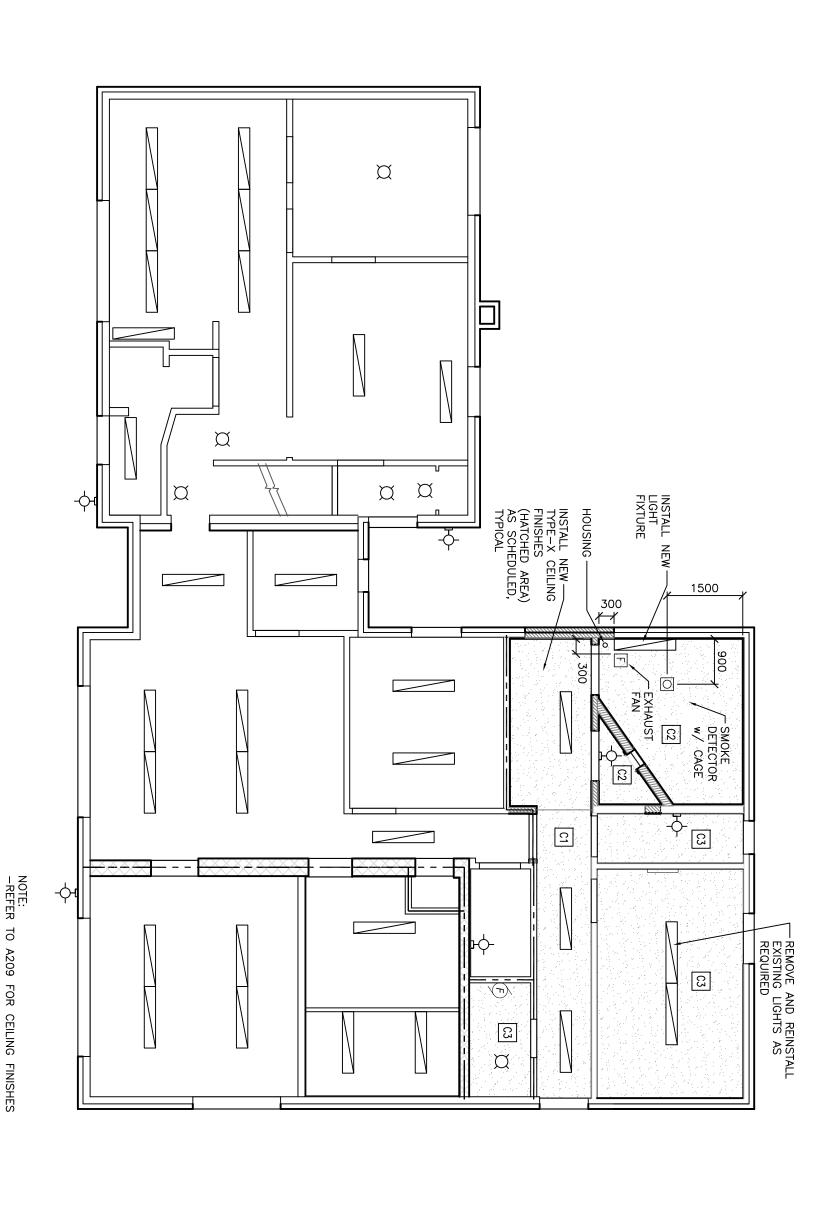
PROJECT: POLICE BUILDING **BLAINE LAKE**

BLAINE LAKE, SASKATCHEWAN RENOVATIONS

MAIN FLOOR REFLECTED DRAWING: **EXISTING / DEMOLITION** CEILING PLAN:

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POLICE BUILDING RENOVATIONS **BLAINE LAKE**

BLAINE LAKE, SASKATCHEWAN

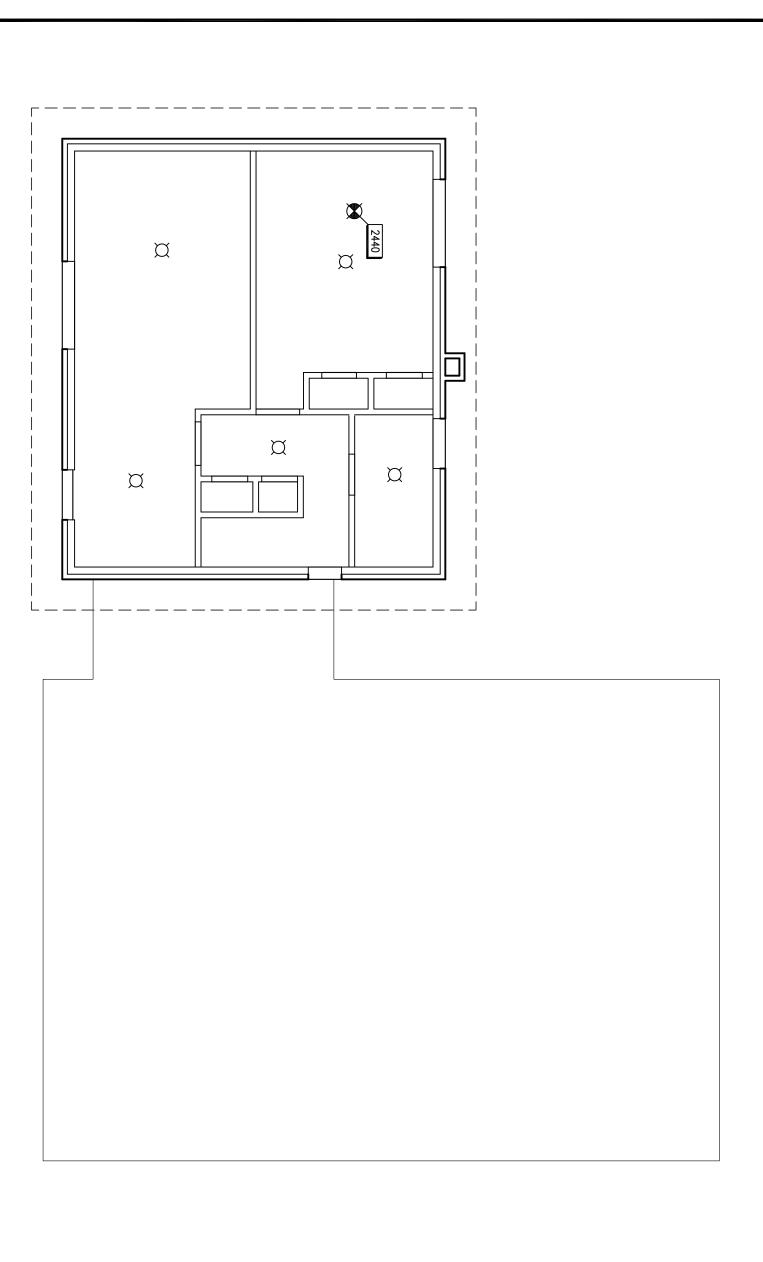
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MAIN FLOOR REFLECTED **EXISTING / PROPOSED** CEILING PLAN:

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POLICE BUILDING RENOVATIONS **BLAINE LAKE**

BLAINE LAKE, SASKATCHEWAN

REFLECTED CEILING PLAN EXISTING / REFERENCE SECOND FLOOR

PROJECT No:	SCALE:
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DOOR NO. 113 112 101 115.1 115 109.1 106 101.1 109 DOOR LOCATION ROOM NO. 109.1 115 113 112 109 106 101 101 115.1 ±800 ±800 × ±800 × DOOR 900 × 900 × 800 × **EXISTING** EXISTING **EXISTING** \Box SIZE 2150 2150 2150 ±2032 ±2050 ±2050 0 0 TYPE 2 _ И 刀 EXISTING **EXISTING** EXISTING MAT'L ⊥ **≤** . ≅ ⊥ **≤** D.D. . ĭ ± .× S DOOR \bigcirc FINISH PT.5 PT.5 PT.5 PT.5 PT.5 工 Ш TYPE N С W.S.(DF) EXISTING EXISTING EXISTING MAT'L ₩.S. \subset ₩.S. ₩.S. ¥.s. W.S. FRAME FINISH PT.4 PT.4 PT.4 PT.4 PT.4 PT.4 Ш 45min 20min 45min LABEL ULC 1 F18 F14 F07 F15 F13 F15 F01 F14 Cincion (Mo, 16.) <u>≯</u> \gtrsim $\stackrel{\mathsf{A}}{\sim}$ ₽ $\stackrel{\mathsf{A}}{\sim}$ 1 ΥES YES YES YES Closers YES YES ΥES YES (FCFRIATES 1 I (PLSH PULLS 1 $\frac{7}{2}$ \tilde{c} $\tilde{\omega}$ Σ \mathcal{Z} $\tilde{\zeta}$ Stops WESTRIES RIDENC 1 1 I 1 (THRESHOLDS 1 2/L1 2-L1 (B/S) L ACCES ORIES CONFIRM SIZE ON SITE, KNOB-CORRIDOR SIDE / KEYED DEADBOLT RE-USE EXISTING DOOR. CYLINDER FINGER PULL RE-USE CONFIRM SIZE ON CONFIRM DOOR LOCK w/ KNOB HARDWARE, SLAM RE-USE EXISTING DOOR. REMARKS SIZE ON EXISTING DOOR. SITE, SITE. < KNOB CORRIDOR NOTE NOTE NOTE NOTE KNOB <u>_</u> 4 4 LATCH LOCK SIDE/KEYED B/S \overline{S} PROHIBITED DEADBOLT B/S DO NOT SCALE DRAWINGS. VERIFY ALL DIMENSIONS, DATUM & ELEVATIONS PRIOR TO COMMENCEMENT OF WORK. COPYRIGHT OF RBM ARCHITECTURE INC.

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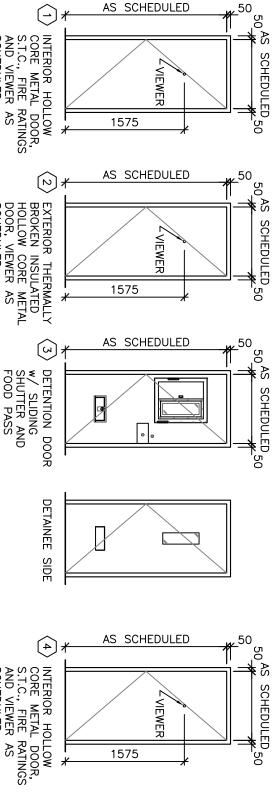
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DOOR AND П IJ AME TYPE S



U) O O R ഗ FRAME ഗ œ HARD . W A R.E.

EXTERIOR DOORS & FRAMES SHALL WEATHER-STRIPPED. INSULATE JAMB DETAILS BE INSULATED & EXTENSIONS AS PER

SCHEDULED 50

- 5 ACOUSTICAL FRAMES: INSULATE TO INSTALL SEAL AND SWEEP AS PER EQUAL DOOR HARDWARE S.T.C.
- ы RATED DOORS $\rm w/$ DOOR VIEWERS TO MAINTAIN FIRE PROTECTION RATING AS REQUIRED. DOOR MANUFACTURER TO INSTALL DOOR VIEWERS IF NECESSARY TO MAINTAIN RATING

VIEWER

1575

- INSTALL DOOR VIEWER AS PER "ADVANCED SAFETY DEVICES" MODEL No. DS238 DOOR SCOPE (www.safety-devices.com)
- ù INTERIOR DOORS SCHEDULED FOR DOOR VIEWERS WILL HAVE TWO VIEWERS IN BOTH DIRECTIONS.
- 6 SLIDING SHUTTER LEXAN/MARGUARD POLY-CARBONATE GLAZING TO ACHIEVE MINIMUM OF 75 FLAME SPREAD RATING AS PER CAN/ULC S102.2-03
- SUBMIT SHOP DRAWINGS FOR DOORS, FRAMES, HARDWARE

SCHEDULED

SCHEDULED

SCHEDULED

- œ CAULK PERIMETER OF INTERIOR DOOR FRAMES TO SUIT
- ALL SALVAGED OWNER KEYS ₽ND LOCKS 7 ΒE TURNED OVER TO
- KEYING INFORMATION TO BE PROVIDED BY CLIEN

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- 11. DOOR FRAMES TYPE-3
 WELDED SECURE SHALL BE ANCHORED IN--PLACE AND
- 12. ALL EXISTING DOORS EQUIPPED w/CONDITION SHALL BE RE—ATTACHED CODE REQUIREMENTS, TYPICAL. CLOSERS TO MEET IN DETACHED FIRE SAFETY
- 13. CONFIRM DOOR SIZES SHOWN FOR ALL FINAL SIZES ON SITE REFERENCE ONLY,
- 14. REPLACE EXISTING THUMB TURN DOOR EXIT HARDWARE WITH NEW SINGLE RELEASE OPERATION DOOR EXIT HARDWARE, IN ACCORDANCE WITH NBCC 2010 3.3.1.13, AND 3.4.6.16

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POLICE BUILDING RENOVATIONS **BLAINE LAKE**

BLAINE LAKE, SASKATCHEWAN

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HARDWARE SCHEDULES DOOR, AND

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	±2385	EX'G PT 16 TYPE-X GB / PT.1	GB	EX'G PT	EX'G GB	EX'G PT	EX'G GB	EX'G GB EX'G PT EX'G GB EX'G PT EX'G GB EX'G PT EX'G	EX'G	EX'G RB	EX'G SV	113
	±2385	16 TYPE-X GB / PT.1	GB PT.1	PT.1	GB	PT.1	GB	PT.1	GB	SV-1	SV-1	112.1
	±2385	16 TYPE-X GB / PT.1	EX'G GB PT.1	PT.1	EX'G GB	PT.1	EX'G GB	GB PT.1	EX'G GB	SV-1	SV-1	112
_	±2385	16 TYPE-X GB / PT.1	GB EX'G PT	EX'G PT	EX'G GB EX'G PT EX'G	EX'G PT	EX'G GB	EX'G GB EX'G PT EX'G GB EX'G PT	EX'G	EX'G RB	EX'G SV	111
ı	±2385	16 TYPE-X GB / PT.1	GB PT.1	PT.1	GB	PT.1	GB	PT.1	GB	SV-1	SV-1	109.1
	±2370	16 TYPE-X GB/PLY/PT.2	PLY PT.2	PT.2	PLY	PT.2	PLY	PT.2	PLY	SV-1	SV-1	109
_	±2385	16 TYPE-X GB / PT.1	EX'G GB PT.1	PT.1	EX'G GB	PT.1	EX'G GB	GB PT.1	EX'G GB	RB-1	SV-1	108
1	±2385	EX'G PT 16 TYPE-X GB / PT.1	GB	EX'G GB EX'G PT EX'G		EX'G GB EX'G PT		EX'G GB EX'G PT	EX'G	EX'G RB	EX'G SV	107
_	±2385	EX'G GB/EX'G PT	EX'G GB EX'G PT	PT.1	GB	PT.1	GB	EX'G GB EX'G PT	EX'G	EX'G RB	EX'G SV	106
REMARKS	HEIGHT AFF	MATERIAL/FINISH	NORTH-WEST	I-WEST	SOUTH-WEST	SOUTH-EAST	SOUTH	NORTH-EAST	NOF	MATERIAL	MATERIAL	N _o
		CEILINGS		HSIN	WALLS — MATERIAL FINISH	LS - MA	WAL			BASE	FLOOR	ROOM

Ш R 0 J FINIS I Ш S

U AINTE U SURFACES

- (WALL AND CEILINGS)
- 2 (ROOM 109 WALLS AND CEILINGS)
- W (EXTERIOR DOOR AND FRAME)
- 4 (DOOR FRAME)
- PAINT 5 (DOOR)

WALL PANEL:

106.1: SHEET WALL PROTECTION PANEL AS PER "ALTRO—WHITEROCK" HYGIENIC WALL SYSTEM. INSTALL SEAMLESS W/ TEXTURED FINISH, CAULK PERIMETER EDGES TO WALL W/ TRANSLUCENT CAULKING.

0 0 RING:

- RESILIENT BASE: SHEET VINYL BASE TO CONTINUOUS W/ FLOORING TO EXTEND 100 c/w METAL COVE BACKER. BE ROLLED
 UP WALL
- SHEET VINYL, INSTALLED SEAMLESS WITHIN EACH ROOM, AS SCHEDULED REFER TO DETAILS AT WALL JUNCTIONS, TYPICAL AS PER "FORBO-MARMOLEUM REAL-SERIES" AS PER SPECIFICATIONS.

|⊅ ഗ ഗ Ш MBLIES

- FIRE-STOP AND SMOKE SEAL WALLS w/ FIRE RESISTANCE RATINGS AS REQUIRED
- INSTALL SOLID BLOCKING IN STUD WALLS FOR ALL WALL HUNG FIXTURES, AND EQUIPMENT, TYPICAL

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- **¥**1 WALL TYPE—1: INTERIOR WALL:
 13 G1S FIRE RETARDANT EPOXY PAINTED PI
 13 PLYWOOD BACKER BOARD
 38x89 WOOD STUDS @ 300o.c.
 13 PLYWOOD BACKER BOARD
 13 TYPE—X GYPSUM BOARD

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W2

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- WALL TYPE-2: INTERIOR WALL:
 13 G1S FIRE RETARDANT EPOXY PAINTED PL
 13 PLYWOOD BACKER BOARD
 38×140 WOOD STUDS @ 300o.c.
 140 MINERAL WOOL BATT INSULATION
 13 PLYWOOD BACKER BOARD
 13 TYPE-X GYPSUM BOARD
- W3 WALL TYPE-3: EXISTING EXTERIOR WALL:
 EXISTING BRICK CLADDING
 EXISTING AIR SPACE
 EXISTING AIR BARRIER/SHEATHING WRAP
 EXISTING SHEATHING
 EXISTING WOOD STUDS
 EXISTING BATT INSULATION EXISTING BATT INSULATION
 NEW 6mil POLY VAPOR BARRIER
 13 PLYWOOD BACKER BOARD
 13 G1S FIRE RETARDANT EPOXY PAINTED PLYWOOD

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4.

- W4 WALL TYPE-4: EXISTING INTERIOR 1Hr FIR 13 G1S FIRE RETARDANT EPOXY PAINTED TWO LAYERS 16 TYPE-X GYPSUM BOARD 89 MINERAL WOOL BATT INSULATION EXISTING 38x89 WOOD STUDS @ 300o.c. EXISTING GYPSUM BOARD PLYWOOD
- ₩5 WALL TYPE-5: INTERIOR 1Hr RATED FIRE SEPARATION
 13 G1S FIRE RETARDANT EPOXY PAINTED PLYWOOD
 16 TYPE-X GYPSUM BOARD
 89 MINERAL WOOL BATT INSULATION
 38x89 WOOD STUDS @ 300o.c.
 16 TYPE-X GYPSUM BOARD
- W6 EXISTING WOOD STUDS
 EXISTING GYPSUM BOARD WALL TYPE-6: INTERIOR WALL:
 13 G1S FIRE RETARDANT EPOXY PAINTED PLYWOOD
 13 PLYWOOD BACKER BOARD

三 NISHE ഗ AND MISC. HARDWARE

TYPICAL: PAINTING SHALL INCLUDE, BUT NOT BE LIMITED TO: INTERIOR AND EXTERIOR EXPOSED DUCTWORK, LOUVERS, AND MISC. TRIM OTHER THAN ARCHITECTURAL STAINLESS STEEL

3-2013/09/15: 2-2013/07/24: 1-2013/06/14: 0-2013/05/08:

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- TYPICAL PAINT NOTE: AS PER 0-VOC, HIGHLY WASHABLE, SCRUBBABLE, ONE (1) COAT PRIMER, MINIMUM TWO (2) COATS FINAL. STANDARD OF ACCEPTANCE NO VISIBLE DEFECTS FROM 1m DISTANCE. COLOURS BY OWNER
- ALL PAINT WITHIN ROOMS 107, 108, 109, 112 ARE TO BE EPOXY PAINT. APPROVED PRODUCT IS PRIMER FLAME CONTROL 1010, TOP COAT IS FLAME CONTROL 2020. EPOXY PAINT APPLIED OVER PLYWOOD IN THE PROVOST AREA SHALL HAVE A FLAME SPREAD RATING OF 25 OR LESS AS PER NBCC 2010; 3.1.12.1 AND 3.1.13.2
- ALL FASTENERS IN ROOM 109 INTERIORS TO BE TAMPER SECURITY SCREWS, U.N.O. (CENTRE PINNED SECURITY TORX HEAD) RESISTANT

PROJECT:

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- ALL FINISHES AS PER SPECIFICATION, CONFIRM APPROV. COLORS PRIOR TO EXECUTION FINAL PAINT COLORS TO PRIOR TO ORDERING, TYPICAL AL OF FINAL BE APPROVED,
- PREPARE ALL SURFACES AS REQUIRED FOR FINISHES AS PER SPECIFICATION AND IN ACCORDANCE WITH MANUFACTURERS WRITTEN INSTRUCTIONS, TYPICAL

6

- 7. REFER TO REFLECTED CEILING PLANS & SCHEDULES FOR FINISHES
- œ APPROVED SECURITY SEALANT AS PER THE FOLLOWING MANUFACTURERS: "BASF-EPOLITH G"; PECORA-DYNAPOXY EP-430 FAST"; PECORA-DYNAPOXY EP-1200"; "SIKA-ANCHOR FIX-3"; AND "TREMCO-PERMAQUIK 2252".

CEILING:

C1

- EPOXY PAINT c/w SECURITY SEALANT AS SPECIFIED FIRE RETARDANT G.1.S. PLYWOOD 16 TYPE-X GYPSUM BOARD EXISTING CEILING BOARD AS ASSEMBLY CEILING FINISH:
- S CEILING FINISH:

 EPOXY PAINT c/w SECURITY SEALANT AS SPECIFIED FIRE RETARDANT G.1.S. PLYWOOD

 2-LAYERS 12mm TYPE-X GYPSUM BOARD

С3

EXISTING

TYPE-X GYPSUM BOARD ISTING CEILING BOARD AS

ASSEMBLY

SCHEDULES AND ROOM FINISH ASSEMBLIES

DRAWING:

BLAINE LAKE, SASKATCHEWAN

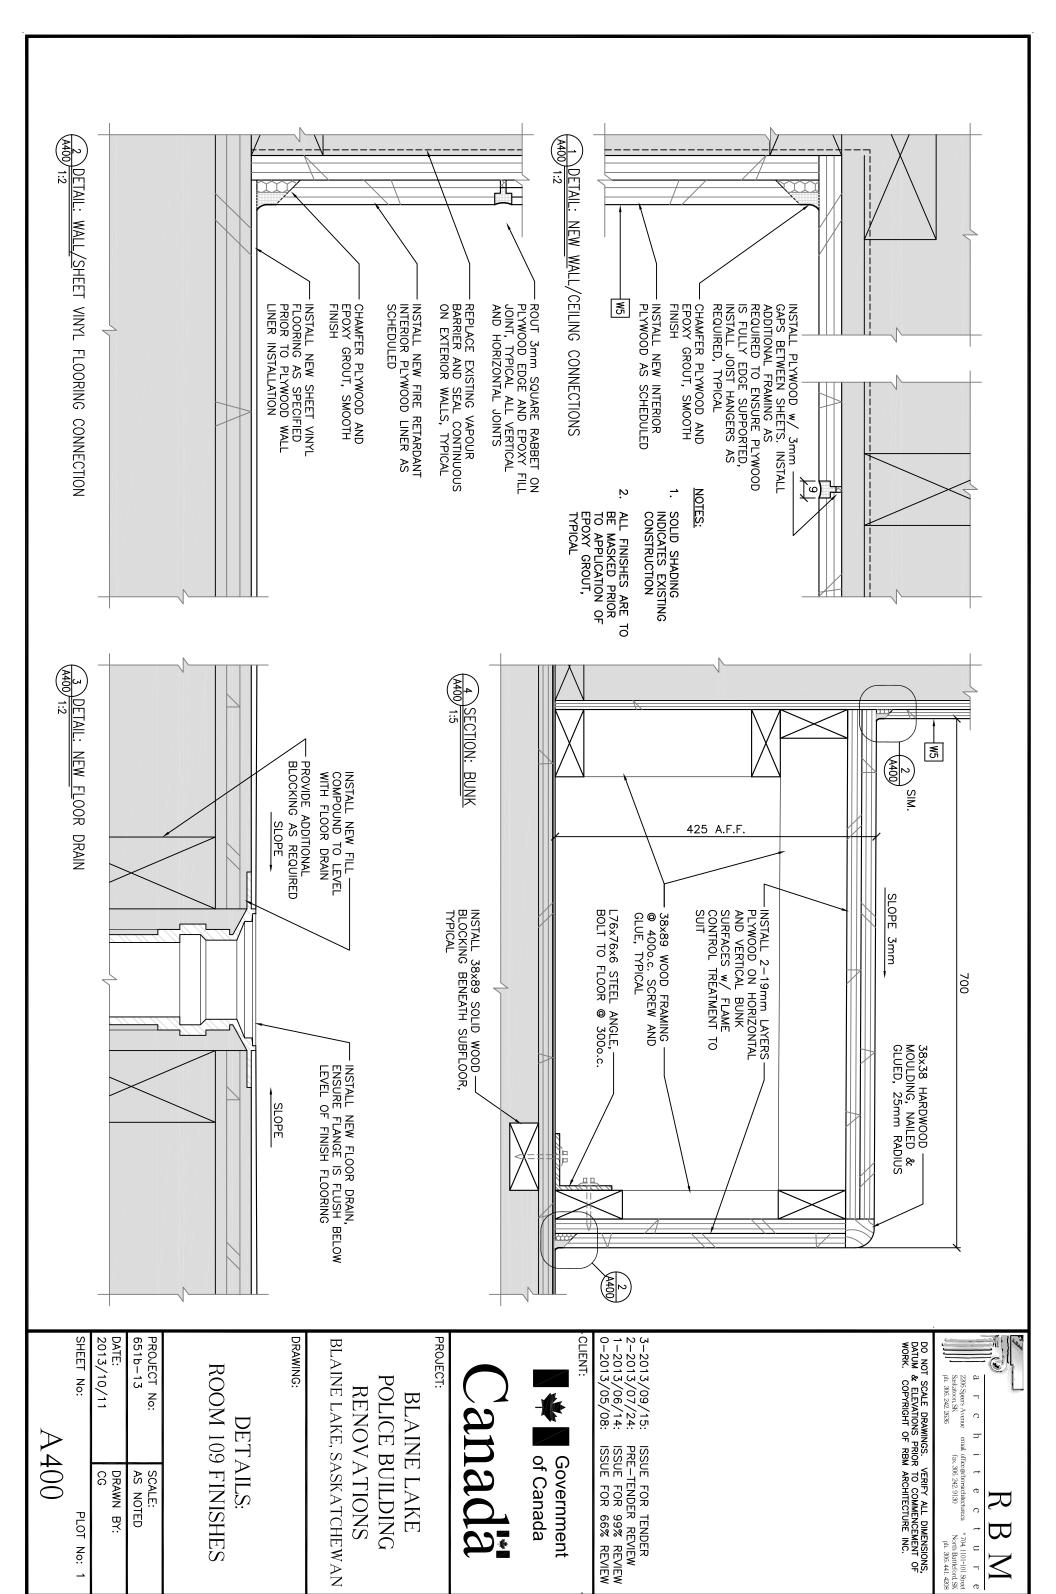
RENOVATIONS

POLICE BUILDING

BLAINE LAKE

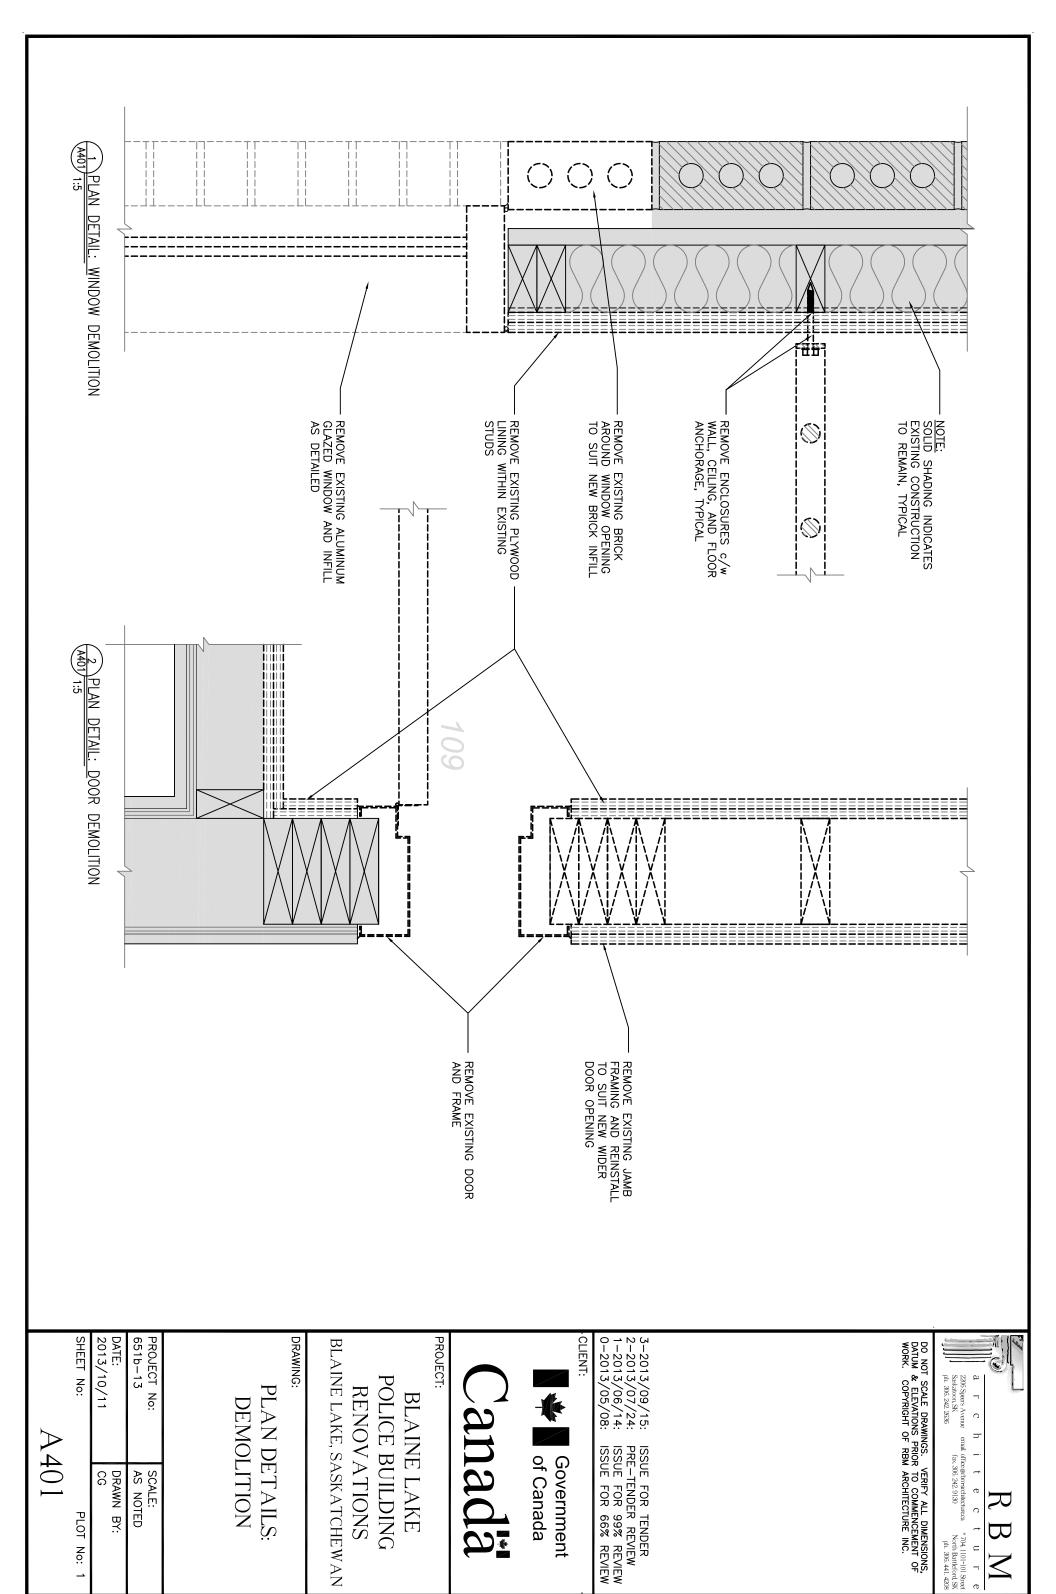
SCALE:
AS NOTED
DRAWN BY:
LS, CG

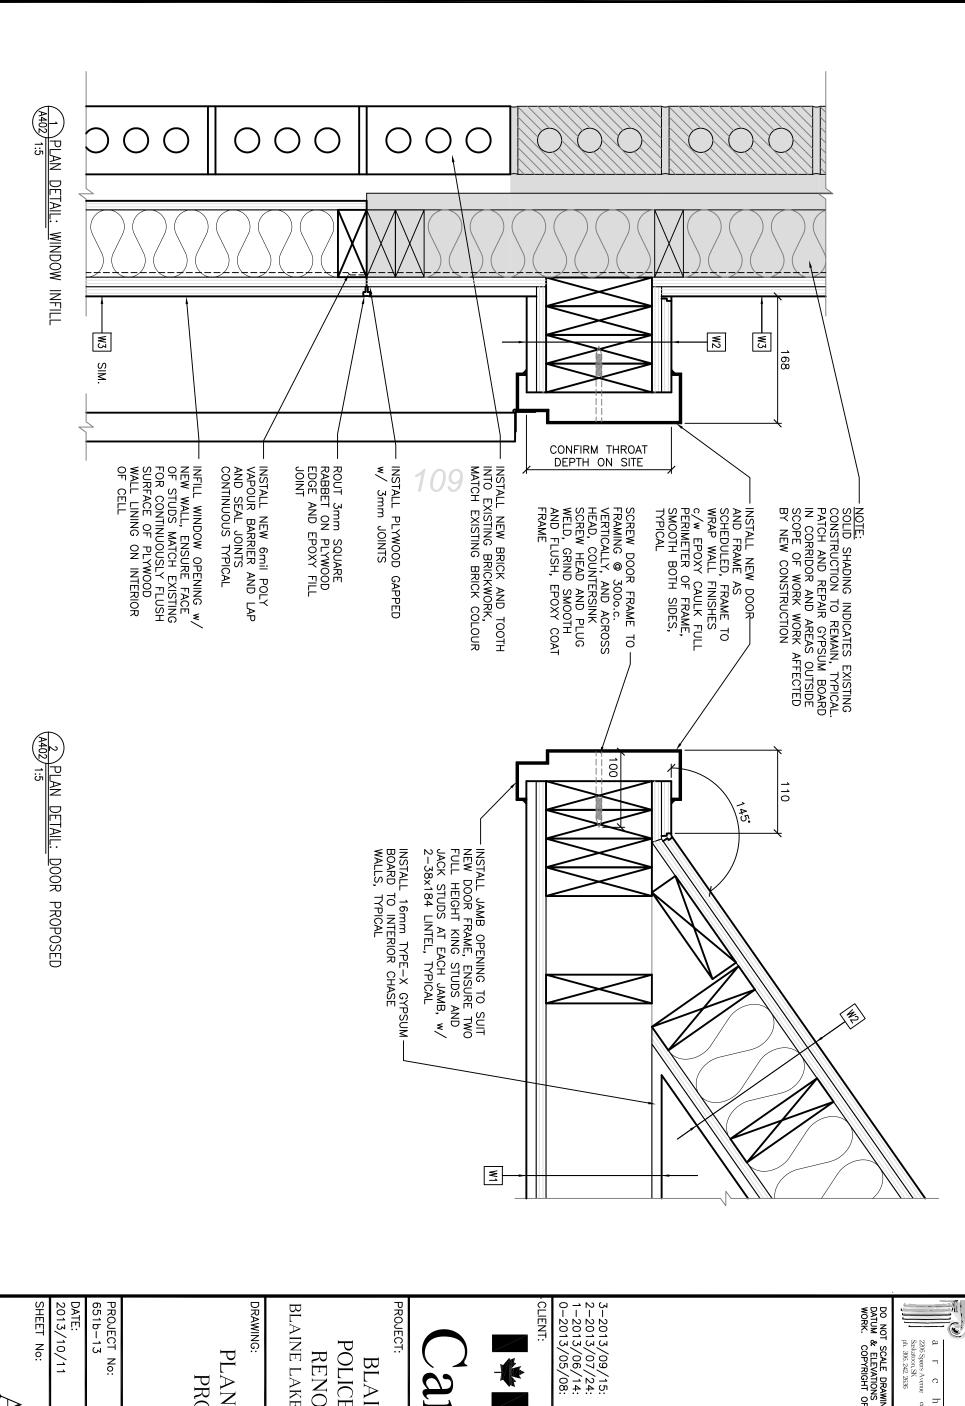
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* 704, 1101–101 Street North Battleford, SK ph. 306, 441, 4208

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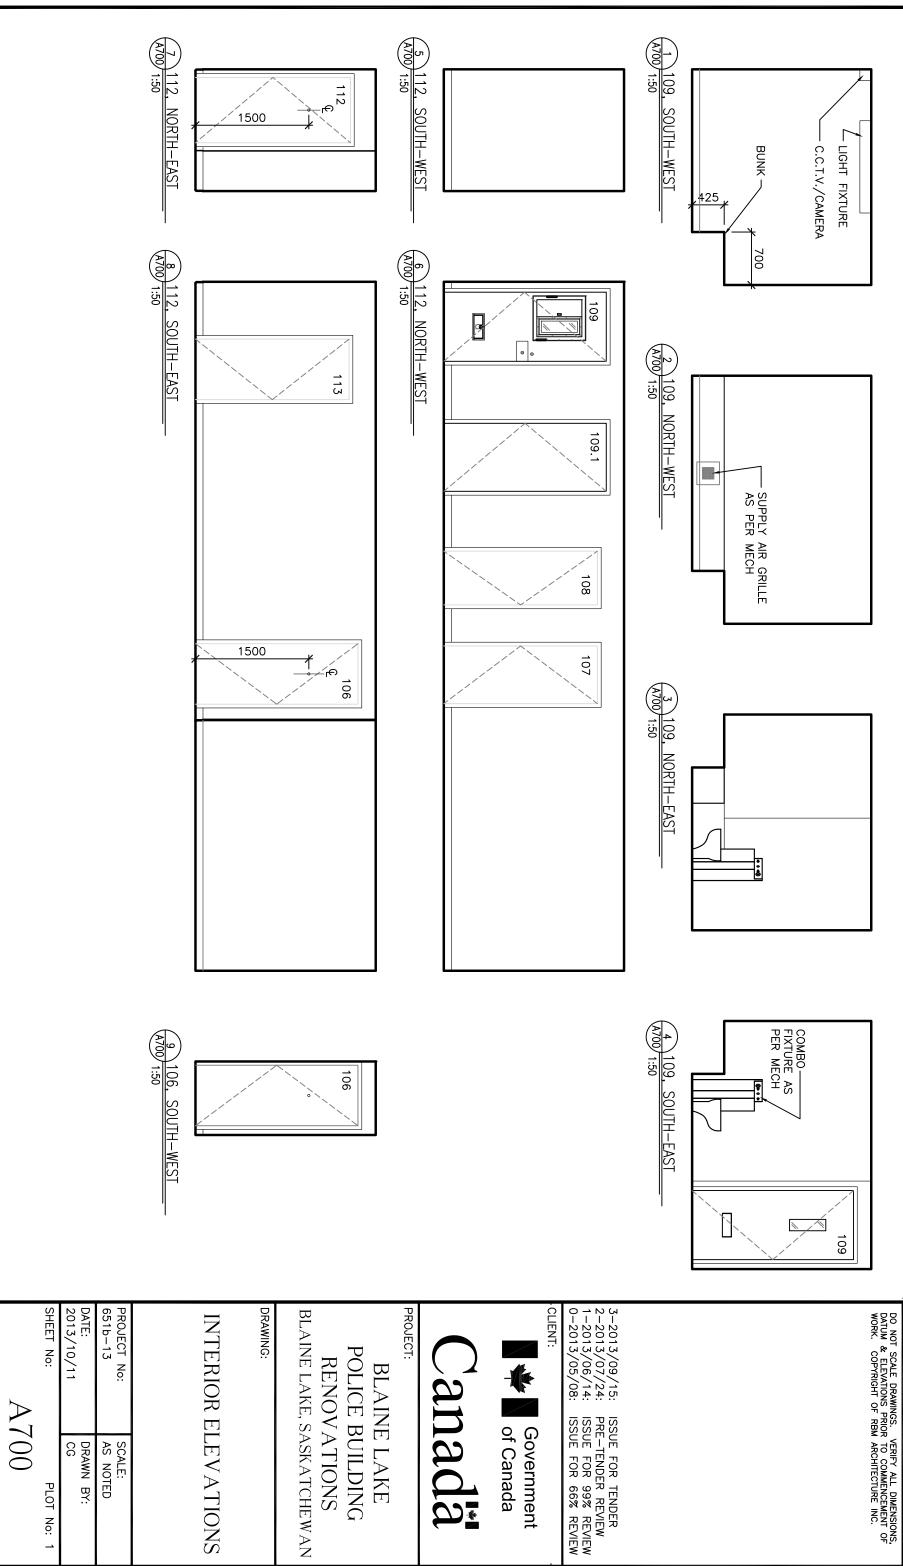
Canada

BLAINE LAKE, SASKATCHEWAN POLICE BUILDING RENOVATIONS **BLAINE LAKE**

PLAN DETAILS: **PROPOSED**

DATE: 2013/10/11 651b-13 PROJECT No: DRAWN BY: CG SCALE: AS NOTED

A402



architec 2206 Sperts Avenue email. office@rbnrarchitecture.ca Saskatoon, SK fax. 306, 242, 9130 ph. 306, 242, 2636 otation \square * 704, 1101-101 Street North Battleford, SK ph. 306, 441, 4208

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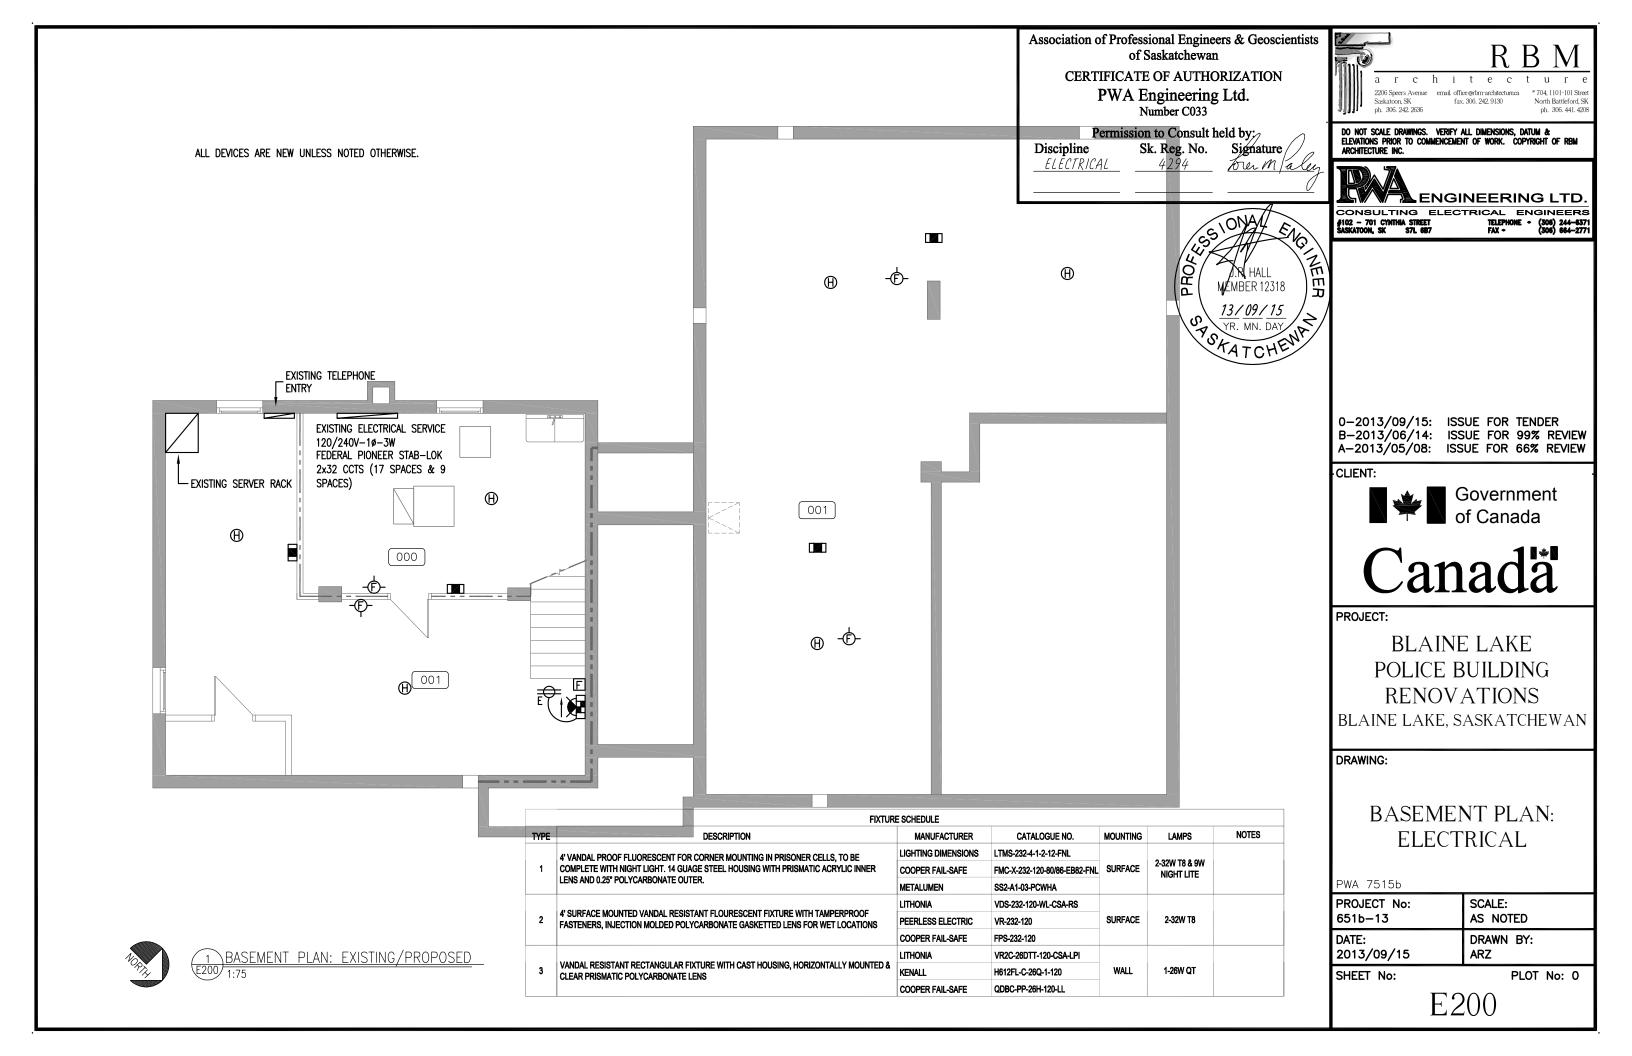
Canada

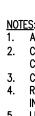
POLICE BUILDING **BLAINE LAKE**

BLAINE LAKE, SASKATCHEWAN

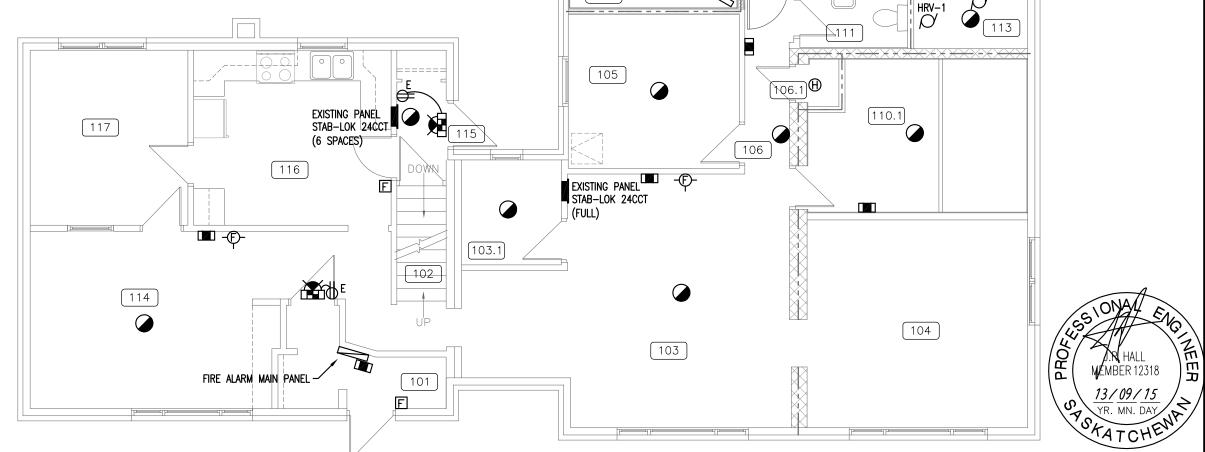
INTERIOR ELEVATIONS

DRAWN BY: AS NOTED SCALE:





- ALL DEVICES ARE NEW EXCEPT AS NOTED.
- CIRCUIT AND SWITCH TYPE '2' FIXTURE TO EXISTING ROOM 112 LIGHTING CIRCUIT
- CIRCUIT TYPE '3' FIXTURE TO EXISTING AREA LIGHTING CIRCUIT.
 REPLACE EXISTING ROOM 109 LIGHT, EXTEND CIRCUIT. REMOVE SECOND FIXTURE
- LIGHT SWITCH FOR CELL FIXTURE TO BE AS PER SPEC SECTION 26 27 26, TOP POSITION FOR FLUORESCENT LIGHT, BOTTOM POSITION FOR NIGHT LIGHT. LOCATE SWITCH TO CLEAR CELL DOOR WHEN OPENED. TYPICAL.
- REMOVE CAMERA IN ROOM 109 AND STORE IN ROOM 107 ON TOP OF EXISTING SECURITY RACK. ALL OTHER EXISTING CAMERAS SHALL REMAIN.
- CIRCUIT NEW BATTERY/COMBO RECEPTACLE IN 112 WITH EXISTING BATTERY RECEPTACLE IN 112.
- CIRCUIT BATTERY/COMBO RECEPTACLE IN 114 WITH BATTERY RECEPTACLE IN 102.
- CIRCUIT BATTERY/COMBO RECEPTACLE IN 106 WITH CORRIDOR LIGHTS.
- 10. PROVIDE NEW 15A,1P CIRCUIT FOR RECEPTACLE IN CELL MECHANICAL CHASE.
- 11. REFER TO ARCHITECTURAL PLANS FOR EXACT LOCATIONS OF EF-1 AND TF-1. LOCATE SWITCH FOR EF-1 WITHIN LIGHT SWITCH BANK IN CORRIDOR 112.



REFER TO ARCH FOR

EXACT LOCATION

108

109

112.1

107

- FIRE ALARM ANNUNCIATOR

112

Association of Professional Engineers & Geoscientists of Saskatchewan

> CERTIFICATE OF AUTHORIZATION PWA Engineering Ltd. Number C033

Permission to Consult held by:

Discipline ELECTRICAL

Sk. Reg. No. 4294

Signature / Tour M/ale

MEMBER 12318

13/09/15



email. office@rbm-architecture.ca North Battleford, SK ph. 306. 441. 4208 fax. 306. 242. 9130

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- EXISTING SECURITY RACK

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BLAINE LAKE POLICE BUILDING RENOVATIONS

BLAINE LAKE, SASKATCHEWAN

DRAWING:

MAIN FLOOR PLAN: ELECTRICAL

PWA 7515b

PROJECT No: SCALE: 651b-13 AS NOTED DATE: DRAWN BY: 2013/09/15

SHEET No:

PLOT No: 0

E201

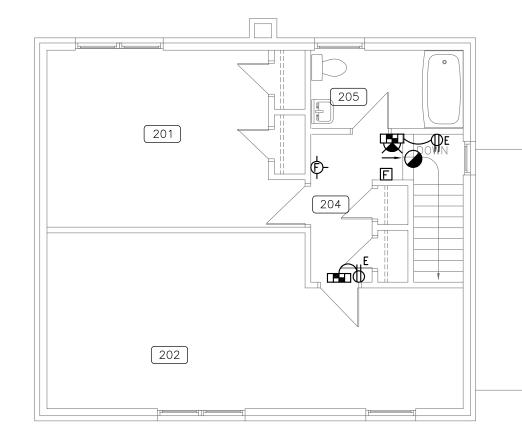


MAIN FLOOR PLAN: EXISTING/PROPOSED

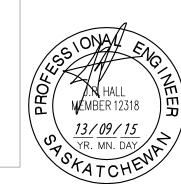
						Motor a	ınd Mechanical Equ	ipment Sched	ule		
NO	DESCRIPTION	VOLT	PH	HP	W	FLA	FEEDER	BREAKER	CIRCUIT	CONTROL	NOTES
HRV-1	HEAT RECOVERY VENTILATOR	120	1Ø		150	1.3	2#12, 21mmC	15A,1P	A-1	3 POSITION SWITCH WITH UNIT	PLUG-IN
DH1	ELECTRIC DUCT HEATER	240	1Ø			9.6	3#12, 21mmC	15A,2P	A-3/5	INTEGRAL TEMP CONTROLLER	
EF-1	EXHAUST FAN	120	1Ø		19		2#12, 21mmC	15A,1P	A-7	ON/OFF SWITCH	
TF-1	TRANSFER FAN	120	1Ø		19		2#12, 21mmC	15A,1P	A-7	FAN TO RUN CONTINUOUSLY	

CIRCUIT NUMBERS SHOWN FOR QUANTITY ONLY, CONTRACTOR TO CIRCUIT EQUIPMENT FROM NEAREST PANEL WITH SPACE AND TO UPDATE RECORD DRAWINGS ACCORDINGLY.

ALL DEVICES ARE NEW UNLESS NOTED OTHERWISE.



	LEGEND							
SYMBOL	DESCRIPTION							
	FLOURESCENT FIXTURE — CEILING MOUNT							
	FLUORESCENT FIXTURE — WALL MOUNT							
XX	INCANDESCENT/HID FIXTURE - SURFACE/WALL MOUNT							
\boxtimes	EXIT LIGHT - SURFACE/WALL MOUNT; SHADING INDICATES LIT FACE							
\ominus	DUPLEX RECEPTACLE; • =COUNTER HEIGHT							
₩ P	DUPLEX RECEPTACLE; WP=WEATHERPROOF							
<u> </u>	JUNCTION BOX / DIRECT CONNECTION							
	NORMAL POWER PANEL AS INDICATED							
	SMOKE DETECTOR							
\oplus	HEAT DETECTOR							
F	FIRE ALARM PULL STATION							
- E -	FIRE ALARM HORN/STROBE							
	EMERGENCY BATTERY UNIT C/W LIGHTING HEADS							
	REMOTE EMERGENCY LIGHTS, SINGLE & DOUBLE							
	COMBINATION EXIT SIGN EMERGENCY BATTERY UNIT WITH HEADS							
	CCTV CAMERA							
0	MOTOR							
	DISCONNECT SWITCH							
#	SECURITY DEVICE REFER TO SPECIFICATION SECTION 28 23 00							
DEVICES MARKED 'I	2° are existing to remain							



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> CERTIFICATE OF AUTHORIZATION PWA Engineering Ltd.
> Number C033

Permission to Consult held by;

Discipline ELECTRICAL

Sk. Reg. No. Signature bren Male 2206 Speers Avenue email. office@rbm-architecture.ca fax. 306. 242. 9130

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BLAINE LAKE POLICE BUILDING RENOVATIONS

BLAINE LAKE, SASKATCHEWAN

DRAWING:

SECOND FLOOR PLAN: ELECTRICAL

PWA 7515b

PROJECT No: SCALE: 651b-13 AS NOTED DATE: DRAWN BY: 2013/09/15

SHEET No:

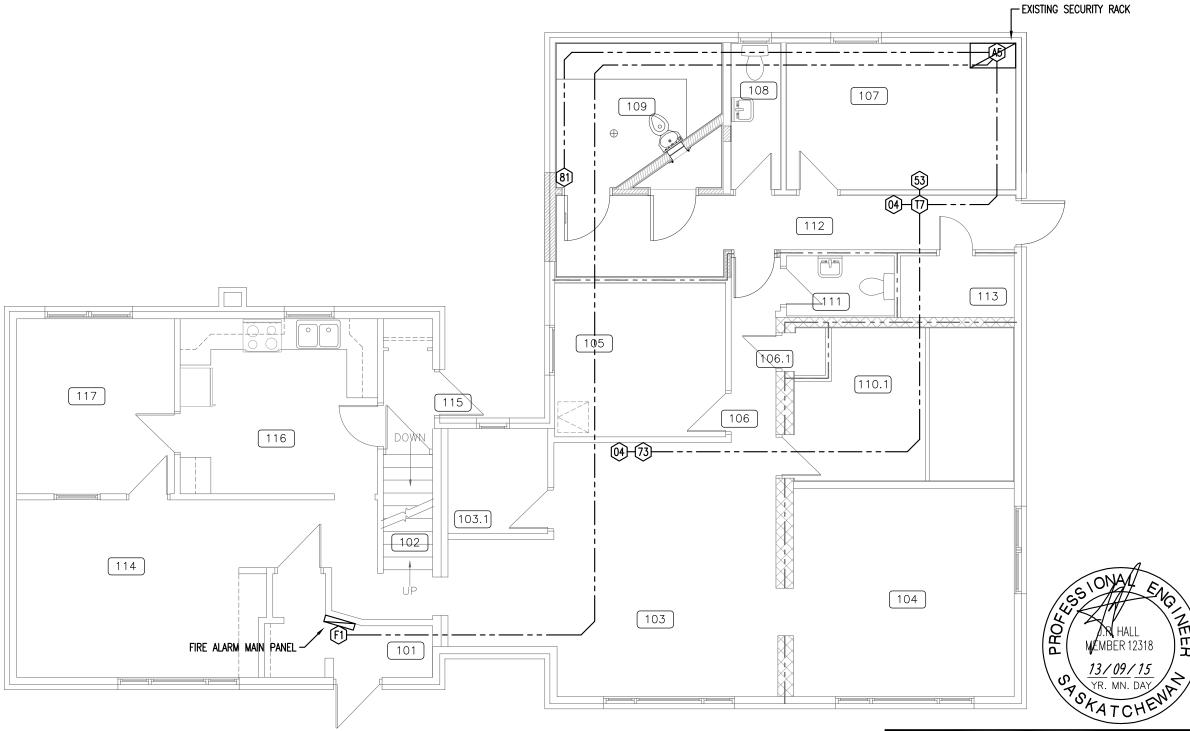
PLOT No: 0

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SECOND FLOOR PLAN: EXISTING/PROPOSED

--- 13mm CONDUIT



MAIN FLOOR PLAN: EXISTING/PROPOSED

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BLAINE LAKE POLICE BUILDING RENOVATIONS

BLAINE LAKE, SASKATCHEWAN

DRAWING:

MAIN FLOOR PLAN: **SECURITY**

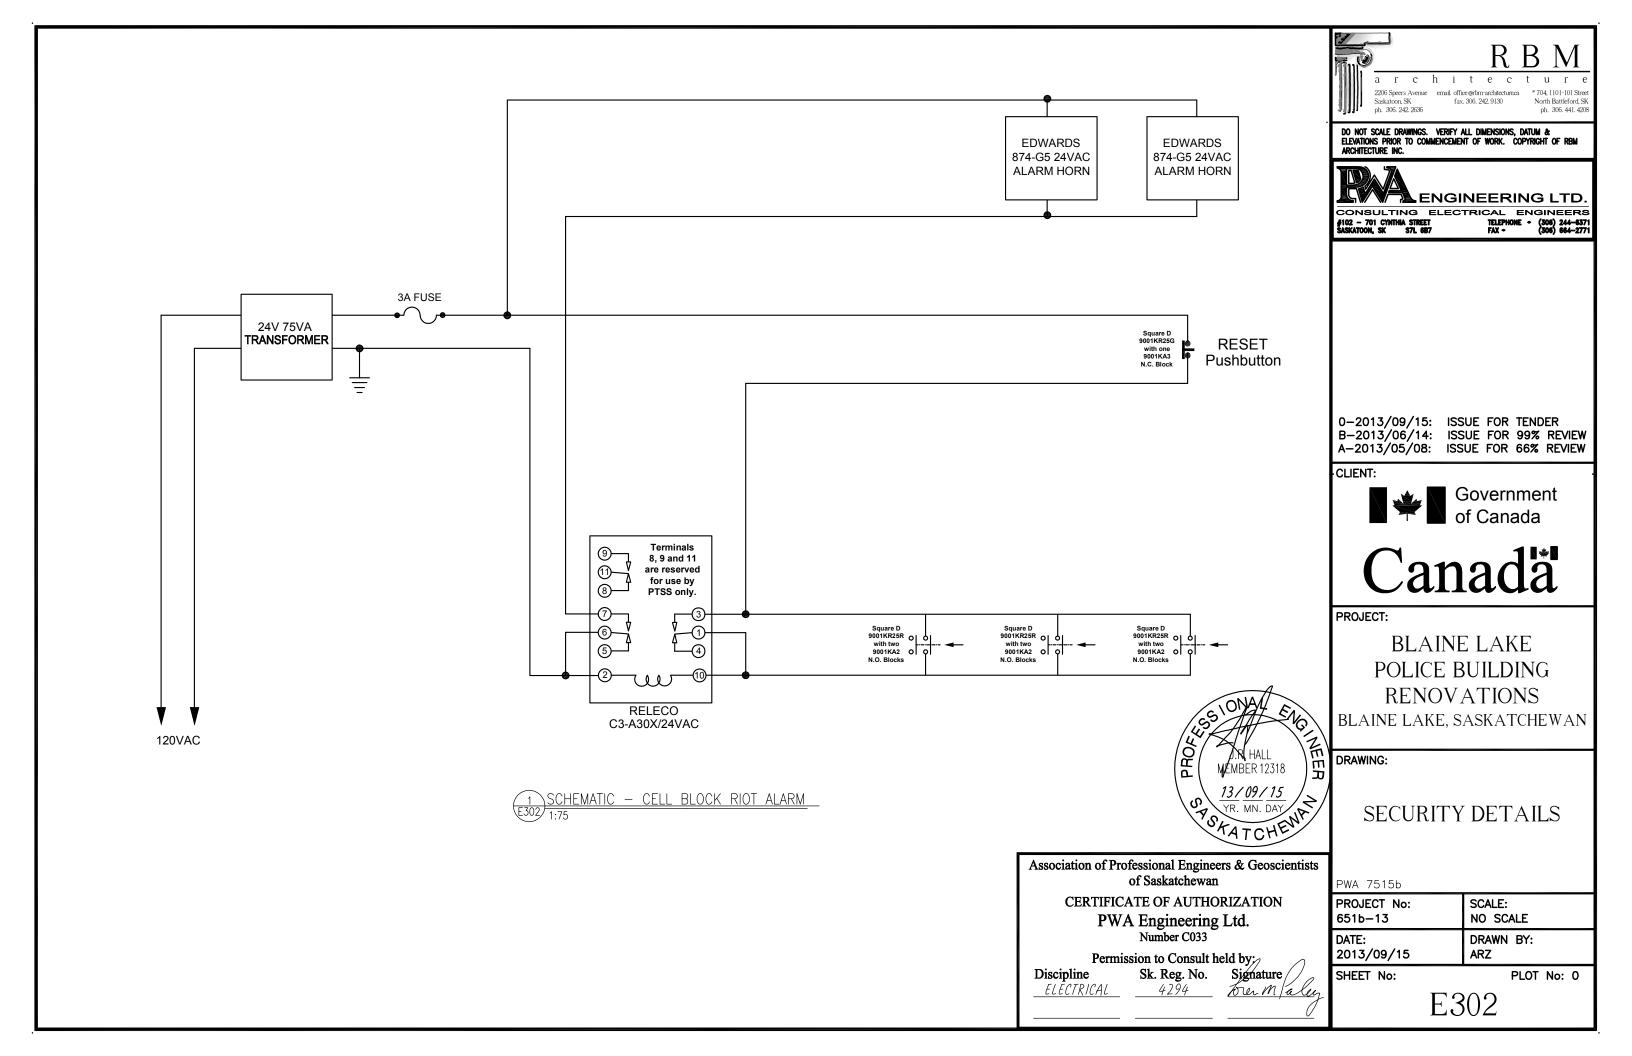
PWA 7515b

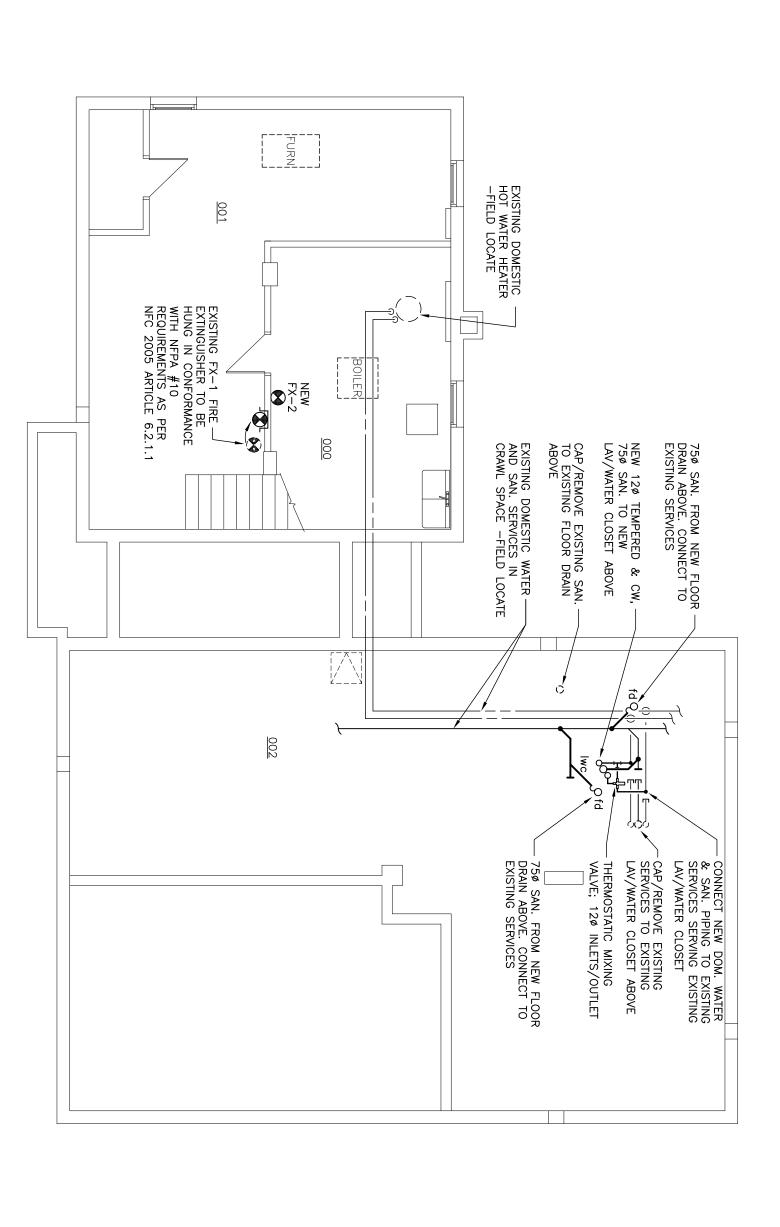
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SHEET No:

PLOT No: 0

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PROJECT:

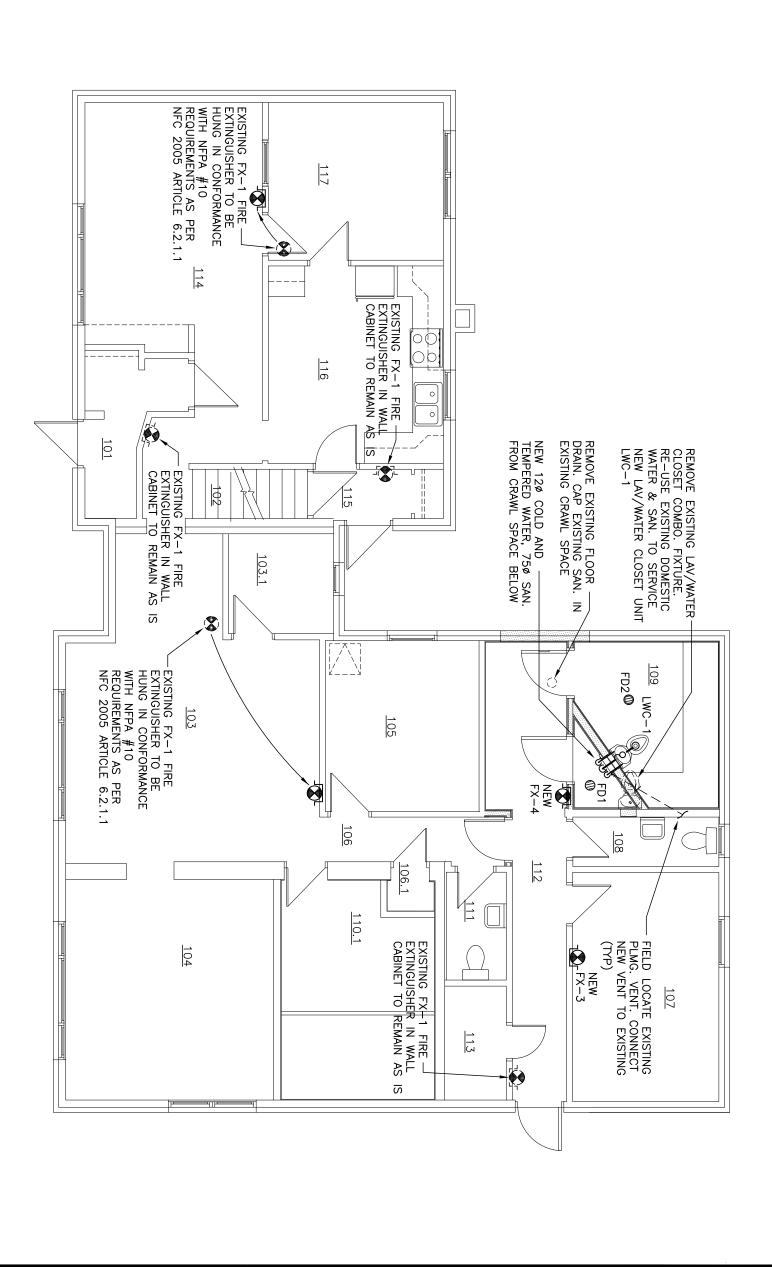
BLAINE LAKE, SASKATCHEWAN POLICE BUILDING RENOVATIONS **BLAINE LAKE**

BASEMENT PLAN MECHANICAL

DRAWING:

DATE: 2013/10/11 651b-13 PROJECT No: **PLUMBING PROPOSED** BWO SCALE: DRAWN BY: AS NOTED

SHEET No:





MAIN FLOOR PLAN: PROPOSED



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PROJECT:

POLICE BUILDING RENOVATIONS **BLAINE LAKE**

BLAINE LAKE, SASKATCHEWAN

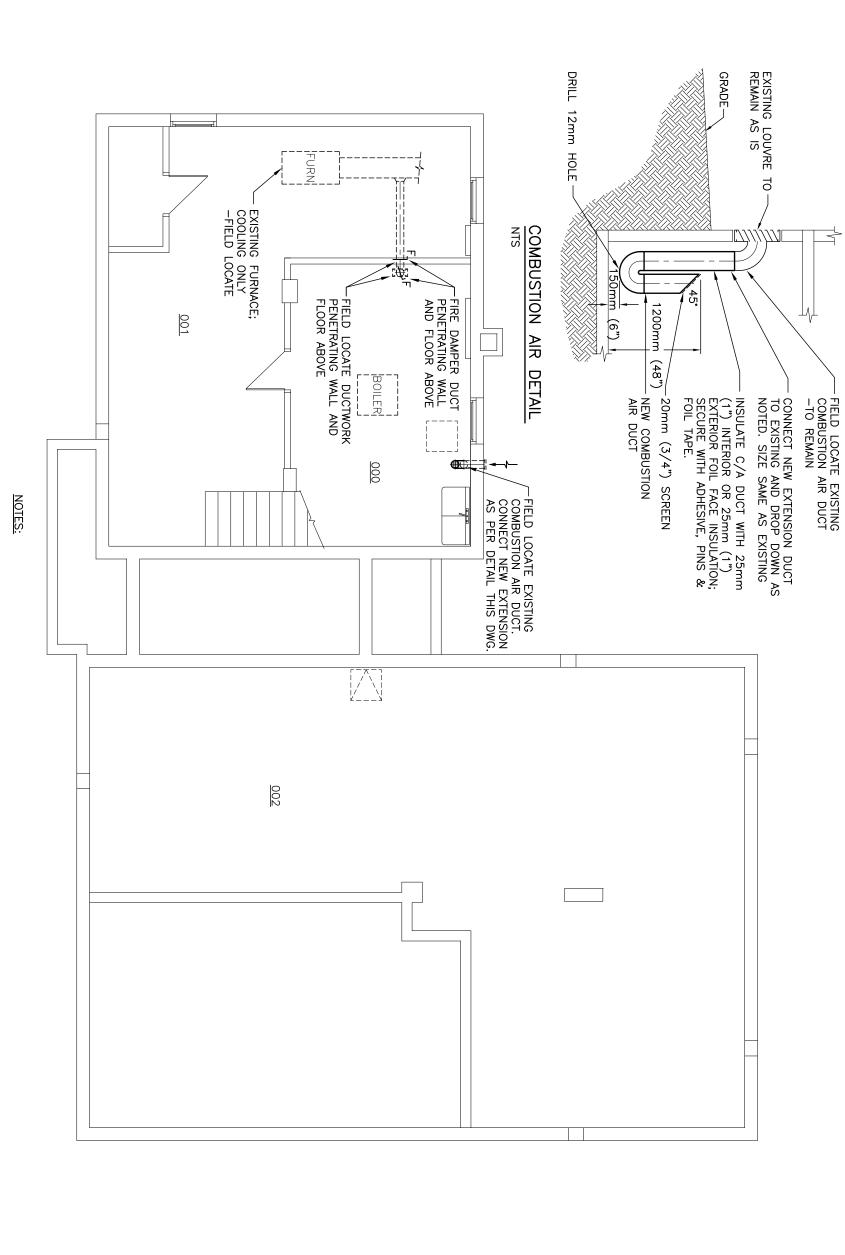
DRAWING:

EXISTING/PROPOSED MAIN FLOOR PLAN **MECHANICAL PLUMBING**

PROJECT No:	SCALE:
651b-13	AS NOTED
DATE:	DRAWN BY:
2013/10/11	BWO

M201

SHEET No:







-FIELD LOCATE AND DETERMINE SIZE FOR ALL DUCTWORK PENETRATING NEW AND EXISTING MECHANICAL ROOM FIRE RATED WALLS AND CEILINGS

-PROVIDE FIRE DAMPER FOR ALL DUCTWORK PENETRATING MECHANICAL ROOM WALLS AND ALL DUCTWORK PENETRATING MECHANICAL ROOMS

-ENSURE ALL PIPING PENETRATIONS THROUGH FIRE SEPARATIONS ARE SEALED WITH FIRE STOPPING SEALANTS AS PER NBC 2005 ARTICLES 3.1.8.3, 3.1.9.1, 3.1.9.3, 3.1.9.4.



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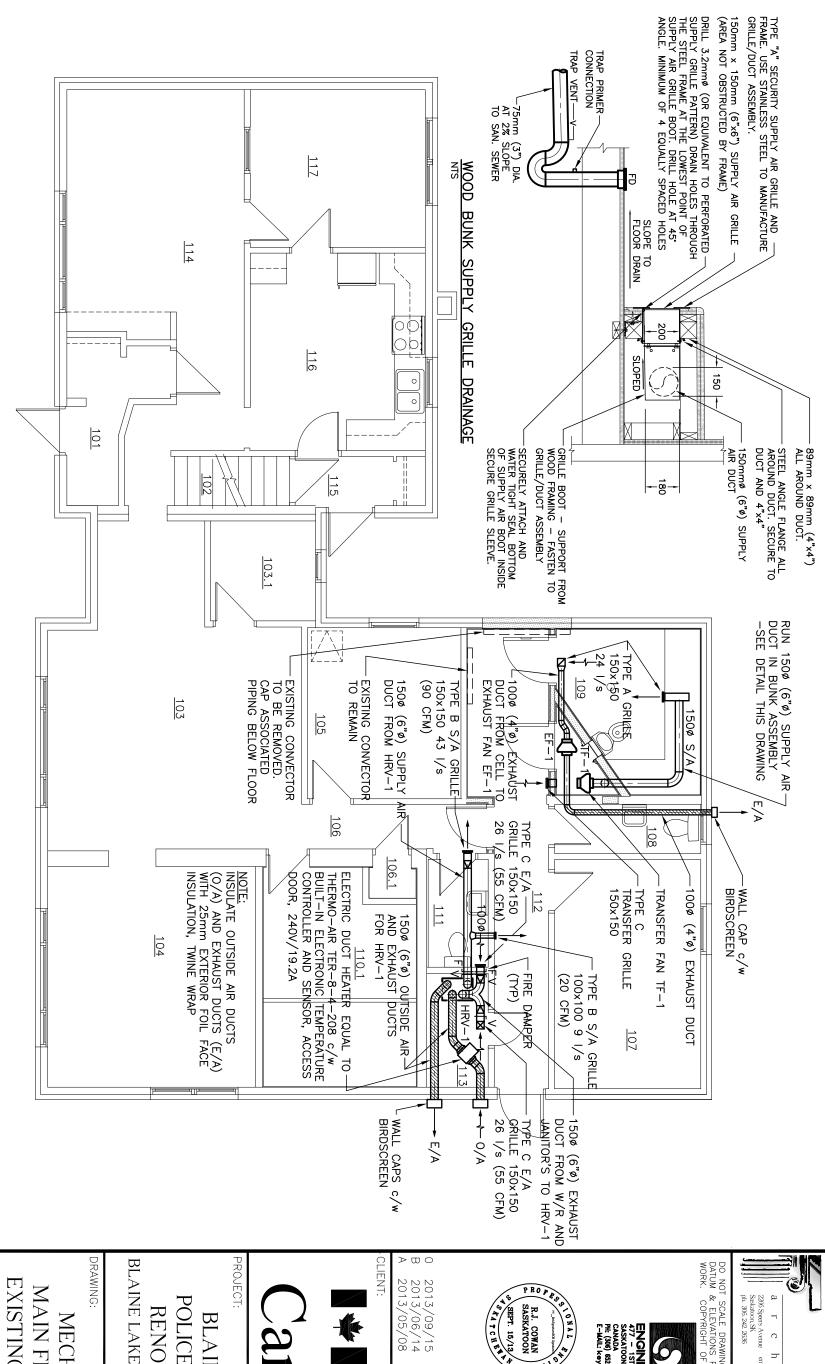
BLAINE LAKE

BLAINE LAKE, SASKATCHEWAN POLICE BUILDING RENOVATIONS

EXISTING/PROPOSED BASEMENT PLAN **MECHANICAL** HVAC

PROJECT No:	SCALE:
651b-13	AS NOTED
DATE:	DRAWN BY:
2013/10/11	BWO

SHEET No:



SHEET No:

2013/10/11

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PLOT No:

651b-13

AS NOTED DRAWN BY:

PROJECT No:

MAIN FLOOR PLAN: PROPOSED

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POLICE BUILDING RENOVATIONS **BLAINE LAKE**

BLAINE LAKE, SASKATCHEWAN

EXISTING/PROPOSED MAIN FLOOR PLAN **MECHANICAL** HVAC

FIXTURE SCHEDULE

FD1: JAY R. SMITH SERIES 2005A-P050 FLOOR DRAIN, ALL DUCO COATED CAST IRON BODY, REVERSIBLE FLASHING CLAMP WITH SEEPAGE OPENINGS AND ADJUSTABLE 5" (127MM) DIAMETER NICKEL BRONZE 1/4" (6.35MM) THICK STRAINER, SECURED WITH S.S. SCREWS, 4" (100MM) THROAT ON STRAINER, TRAP PRIMER CONNECTION.

FD2: JAY R. SMITH SERIES 2005AHD-P050-SS FLOOR DRAIN, ALL DUCO COATED CAST IRON BODY, REVERSIBLE FLASHING CLAMP WITH SEEPAGE OPENINGS AND ADJUSTABLE 5" (127MM) DAMETER STAINLESS STEEL 1/2" (12.7MM) THICK STRAINER, MAXIMUM ISMM DIAMETER STRAINER HOLES, SECURED WITH S.S. PIN TORQUE SCREWS AND MOUNTED USING LOCTITE LIQUID THREAD LOCKERS SERIES 262, MIL-SPEC S-46163A, TYPE II, GRADE 0. 4" (100MM) THROAT ON STRAINER, TRAP PRIMER CONNECTION "P".

CLEAN OUTS

CO1 FLOOR CLEANOUT - HEAVY TRAFFIC FINISHED AREAS: JAY R. SMITH SERIES 4100 TWIS-TO-FLOOR; FLOOR CLEANOUT, DUCO CORTEC CAST ROON BODY AND REMOVABLE POSITIVE GASKET SEAL CLOSURE PLUG AND HEAVY DUTY 6" (150MM) WITH EXTRA HEAVY NICKEL BRONZE COVER AND FRAME, SECURED WITH STAINLESS STEEL SCREWS, C.O. CAST IN COVER. (FOR WATER-PROOFED AREAS PROVIDE 'FC' FLANGE WITH FLASHING CLAMP).

CO2 LINE CLEANOUT: JAY R. SMITH SERIES 4420 LINE CLEANOUT, IN CAST IRON FERRULE WITH CAST BRONZE TAPERED THREAD PLUG, WITH FUILL SIZE PIPE OPENING. WHERE CLEANOUTS ARE CONCEALED BEHIND FINISHED WALLS ACCESS SHALL BE MADE BY SMITH 4422 ROUND STAINLESS STEEL PLATE AND SLOTTED FLAT HEAD STAINLESS STEEL SCREW.

WATER HAMMER ARRESTORS

SERIES SC MANUFACTURED BY P.P.P. INC..

WATER CLOSET (LWC)

SECURE TYPE WITH INTEGRAL LAWATORY.

COMBINATION BASIN AND TOILET, FLOOR MOUNTED, BACK OUTLET, 14 GAUGE (1.9MM) TYPE 304

S.S. WITH SATIN FINISH, COMPLETE WITH OVAL SHAPED HAND BASIN, 4" (100MM) HIGH

SPLASHBACK, SELF-DPARAINIG SOAP TRAY, BLOW-OUT FLUSH ACTION BOWL, 6L (1.6 GAL.) PER

FLUSH, WITH 3" (75MM) TOILET WASTE WALL OUTLET AND INTEGRAL CONTOURED SEAT. C.P. PENAL

FILLER BUBBLER, CONCEALED PENAL FLUSH VALVE 1-1/2" (38MM) NPT FEMALE SUPPLY, FACTORY

SET FLOW, QUIET ACTION DIAPHRAGM TYPE WITH NON-HOLD OPEN FEATURE, VACUUM BREAKER,

BACK-CHECK ANGLE STOP AND THRU WALL CONNECTOR, AIR-CONTROLLED SINGLE TEMPERATURE

PENAL VALVE, 1.9 LPM (0.5 GPM) FLOW CONTROL, 1/2" (12.7MM) SUPPLIES, WITH METERING,

NON-HOLD OPEN HEMISPHERICAL PENAL PUSH BUTTONS, TIMING ADJUSTABLE FROM 5 SEC. TO 60

SEC. GALVANIZED STEEL WALL SLEEVE FOR FIXTURE MOUNTING, AND NECESSARY FASTENERS FOR

PROPER INSTALLATION. PROVIDE CAST BRASS 'P' TRAP, 1-1/4" (32MM) WITH CLEANOUT FOR BASIN

LOCATED IN PIPE SPACE.

FOR THE FIXTURE ORIENTATION REFER TO ARCHITECTURAL DRAWINGS

ACCEPTABLE PRODUCT: ACORN ENGINEERING CO. ACORN 'PENAL-WARE' 1440-(CT)-2-BPH-03-M-FV-FVT-SW-PBH, WILLOUGHBY INDUSTRIES - MODEL ECW-1806-C-MOD-RCMP.

THERMOSTATIC MIXING VALVE

SYMMONS MAXLINE MODEL 5-225-CK-F THERMOSTATIC MIXING VALVE WITH 12¢ (1/2") FEMALE NPT INLETS/OUTLET AND INTEGRAL CHECKS. ALL BRASS BODY WITH DUAL STAINLESS STEEL STRAINERS. VANDAL-RESISTANT CAP/TEMPERATURE ADJUSTMENT HANDLE. STANDARD FINISH ROUGH BRASS. DUAL CERTIFIED TO ASSE 0.03-0.88 1/s (0.5-14 GPM)

FIRE EXTINGUISHERS

- FX-1: WILSON & COUSINS DRY CHEMICAL MULTIPURPOSE POWDER,
 MODEL ABC-050, WITH A ULC RATING OF 3A:40BC, 5 LB. C/W IE105R4-SS CABINET
 SUITABLE FOR A RECESSED OR SEMI-RECESSED INSTALLATION TYPE, EXTINGUISHER
 CABINET CONSTRUCTED OF 14 GAUGE #4 SATIN STAINLESS STEEL DOOR AND FRAME AND
 16 GAUGE COLD ROLLED STEEL DEEP PRIME COAT PAINTED STEEL TUB. CABINET HAS A
 FULL LENGTH PIANO HINGE, STAINLESS STEEL CONCEALED LATCH AND 3/16" (5MM)
 CLEAR GLASS.
- FX-2: WILSON & COUSINS DRY CHEMICAL MULTIPURPOSE POWDER, MODEL ABC-10G, 10 LB. MULTI-PURPOSE PRESSURIZED DRY CHEMICAL FIRE EXTINGUISHER WITH A ULC RATING OF 4A:80BC C/W WALL MOUNTING BRACKET.
- FX-3: WILSON & COUSINS CARBON DIOXIDE, MODEL CO2-050H, 5 LB WITH A ULC RATING OF 5BC, C/W 16105R4-SS CABINET SUITABLE FOR A RECESSED OR SEMI-RECESSED INSTALLATION TYPE, ENQUISHER CABINET CONSTRUCTED OF 14 GAUGE #4 SATIN STAINLESS STEEL DOOR AND FRAME AND 16 GAUGE COLD ROLLED STEEL DEEP PRIME COAT PAINTED STEEL TUB. CABINET HAS A FULL LENGTH PIANO HINGE, STAINLESS STEEL CONCEALED LATCH AND 3/16" (5MM) CLEAR GLASS.
- FX-4: WILSON & COUSINS DRY CHEMICAL MULTIPURPOSE POWDER, MODEL ABC-050, WITH A ULC RATING OF 3A-40BC, 5 LB. C/W 16105R4-SS CABINET SUITABLE FOR A RECESSED OR SEMI-RECESSED INSTALLATION TYPE, EXTINGUISHER CABINET CONSTRUCTED OF 14 GAUGE #4 SATIN STAINLESS STEEL DOOR AND FRAME AND 16 GAUGE COLD ROLLED STEEL DEEP PRIME COAT PAINTED STEEL TUB. CABINET HAS A FULL LENGTH PIANO HINGE, STAINLESS STEEL CONCEALED LATCH AND 1/4" (6MM) LEXAN CLEAR COVER.

EQUIPMENT SCHEDULE

1.0 . TE RECOVERY VENTILATOR HRV-1 (GENERAL VENTILAT

- POWER CORD w/ 20 kg (45 lbs) HRV-1 (GENERAL VENTILATION) - FANTECH MODEL VHR 1404
 52 |/s @ 150 Pa (110 CFM @ 0.6"WG), 120V 1# 1.3A 150W
 c/w INSULATED CABINET, TWO EBM MOTORS, WASHABLE ELECTROSTATIC PANEL TYPE
 AIR FILTERS, ALLUMINUM HEAT RECOVERY CORE, THREE POSITION (LOW/STAND
 BY/MEDIUM) ROCKER SWITCH, 150mm (6"#) INLETS/OUTLETS, 1m (3") PLUG-IN
 POWER CORD w/ 3-PRONG PLUG, INSTALLATION KIT. UNIT TO RUN CONTINUOUSLY.
- 2.0 <u> -</u> 뛰
- EXHAUST FAN
 EF-1: FANTECH MODEL FR 100 INLINE EXHAUST FAN, 24 LPS (50 (0.5 IN W.G.), 19 WATTS, 115V c/w ON/OFF SWITCH ADJACENT TO CFM) AT 124 Pa LIGHT SWITCH

3.0

- TF-1 TRANSFER FAN
 .1 TF-1: FANTECH MODEL FR 100 I
 (0.5 IN W.G.), 19 WATTS, 115V. INLINE TRANSFER FAN, 24 LPS (50 CFM) AT 124 Pa

4.0

- GRILLES/DIFFUSERS/LOUVERS

 1 BUNK SUPPLY EXHAUST TYPE A: 150x150 GRILLE FACE AREA (300x300 C/W STEEL FRAME) /W 150¢ BOOT CONNECTION, CONSTRUCT OUTER FRAME (FACE PLATE) OF 4.75 MM THICK STEEL WITH 50.8 MM OPENINGS AT 63.5 MM CENTERS TO RECEIVE 1.6 MM THICK PERFORATION PLATE. PERFORATION IN VENTILATING SECTION TO BE 2.38 MM DIA HOLES ON 3.55 MM CENTERS STAGGERED AT 60°, CIVING A DENSITY OF 9 HOLES PER SQUARE CENTIMETER, REINFORCED AREA TO BE PROTECTED BY A 4.76 MM THICK SQUARE CENTIMETER, REINFORCED AREA TO BE PROTECTED BY A 4.76 MM THICK HARDENED STEEL PLATE WELDED TO BACK OF FACEPLATE. PERFORATE PLATE WITH 50.8 MM HOLES ON 63.5 MM CENTERS BOTH WAYS. GRILLE TO BE FASTENED WITH SECURITY TORX VANDAL RESISTANT SCREWS AND BE COMPLETE WITH FACTORY POWDER COAT FINISH, WHITE. TORX VANDAL RESISTANT SCREWS AND BE COMPLETE WITH FACTORY FINISH, WHITE.
 ACCEPTABLE PRODUCT: CHUBB OP-20V, SIMPSON V-2, ENEROUND VENTILATION GRILLE OR VIRTUCOM SCO SECURITY. SECURITY TYPE
- TYPE B: E.H. PRICE MODEL 520D/F/L/A/B12 LOUVERED SUPPLY GRILLE, c/w VOLUME DAMPER, POWDER COAT FINISH, WHITE, SIZE AND AIR VOLUME AS NOTED.
- TYPE C: E.H. PRICE MODEL 530D/F/L/A/B12 LOUVERED EXHAUST GRILLE, c/w VOLUME DAMPER, POWDER COAT FINISH, WHITE, SIZE AND AIR VOLUME AS NOTED.

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DO NOT SCALE DRAWINGS. VERIFY ALL DIMENSIONS, DATUM & ELEVATIONS PRIOR TO COMMENCEMENT OF RBM ARCHITECTURE INC.









of Canada Government CLIENT:

Janada

PROJECT: POLICE BUILDING RENOVATIONS **BLAINE LAKE**

BLAINE LAKE, SASKATCHEWAN

DRAWING:

MECHANICAL **SCHEDULES**

PROJECT No:	SCALE:
6516-17	AS NOTED
1	
DATE:	DRAWN BY:
2013/10/11	SA

M400

SHEET No: