


LEGEND:

- B# DENOTES TIMBER BEAM. SEE TYPICAL TIMBER BEAM SCHEDULE & DETAIL 2 ON DRAWING S2 FOR DETAILS.
- P# DENOTES TIMBER POST. SEE TYPICAL TIMBER POST SCHEDULE & DETAIL 1.2 ON DRAWING S2 FOR DETAILS.

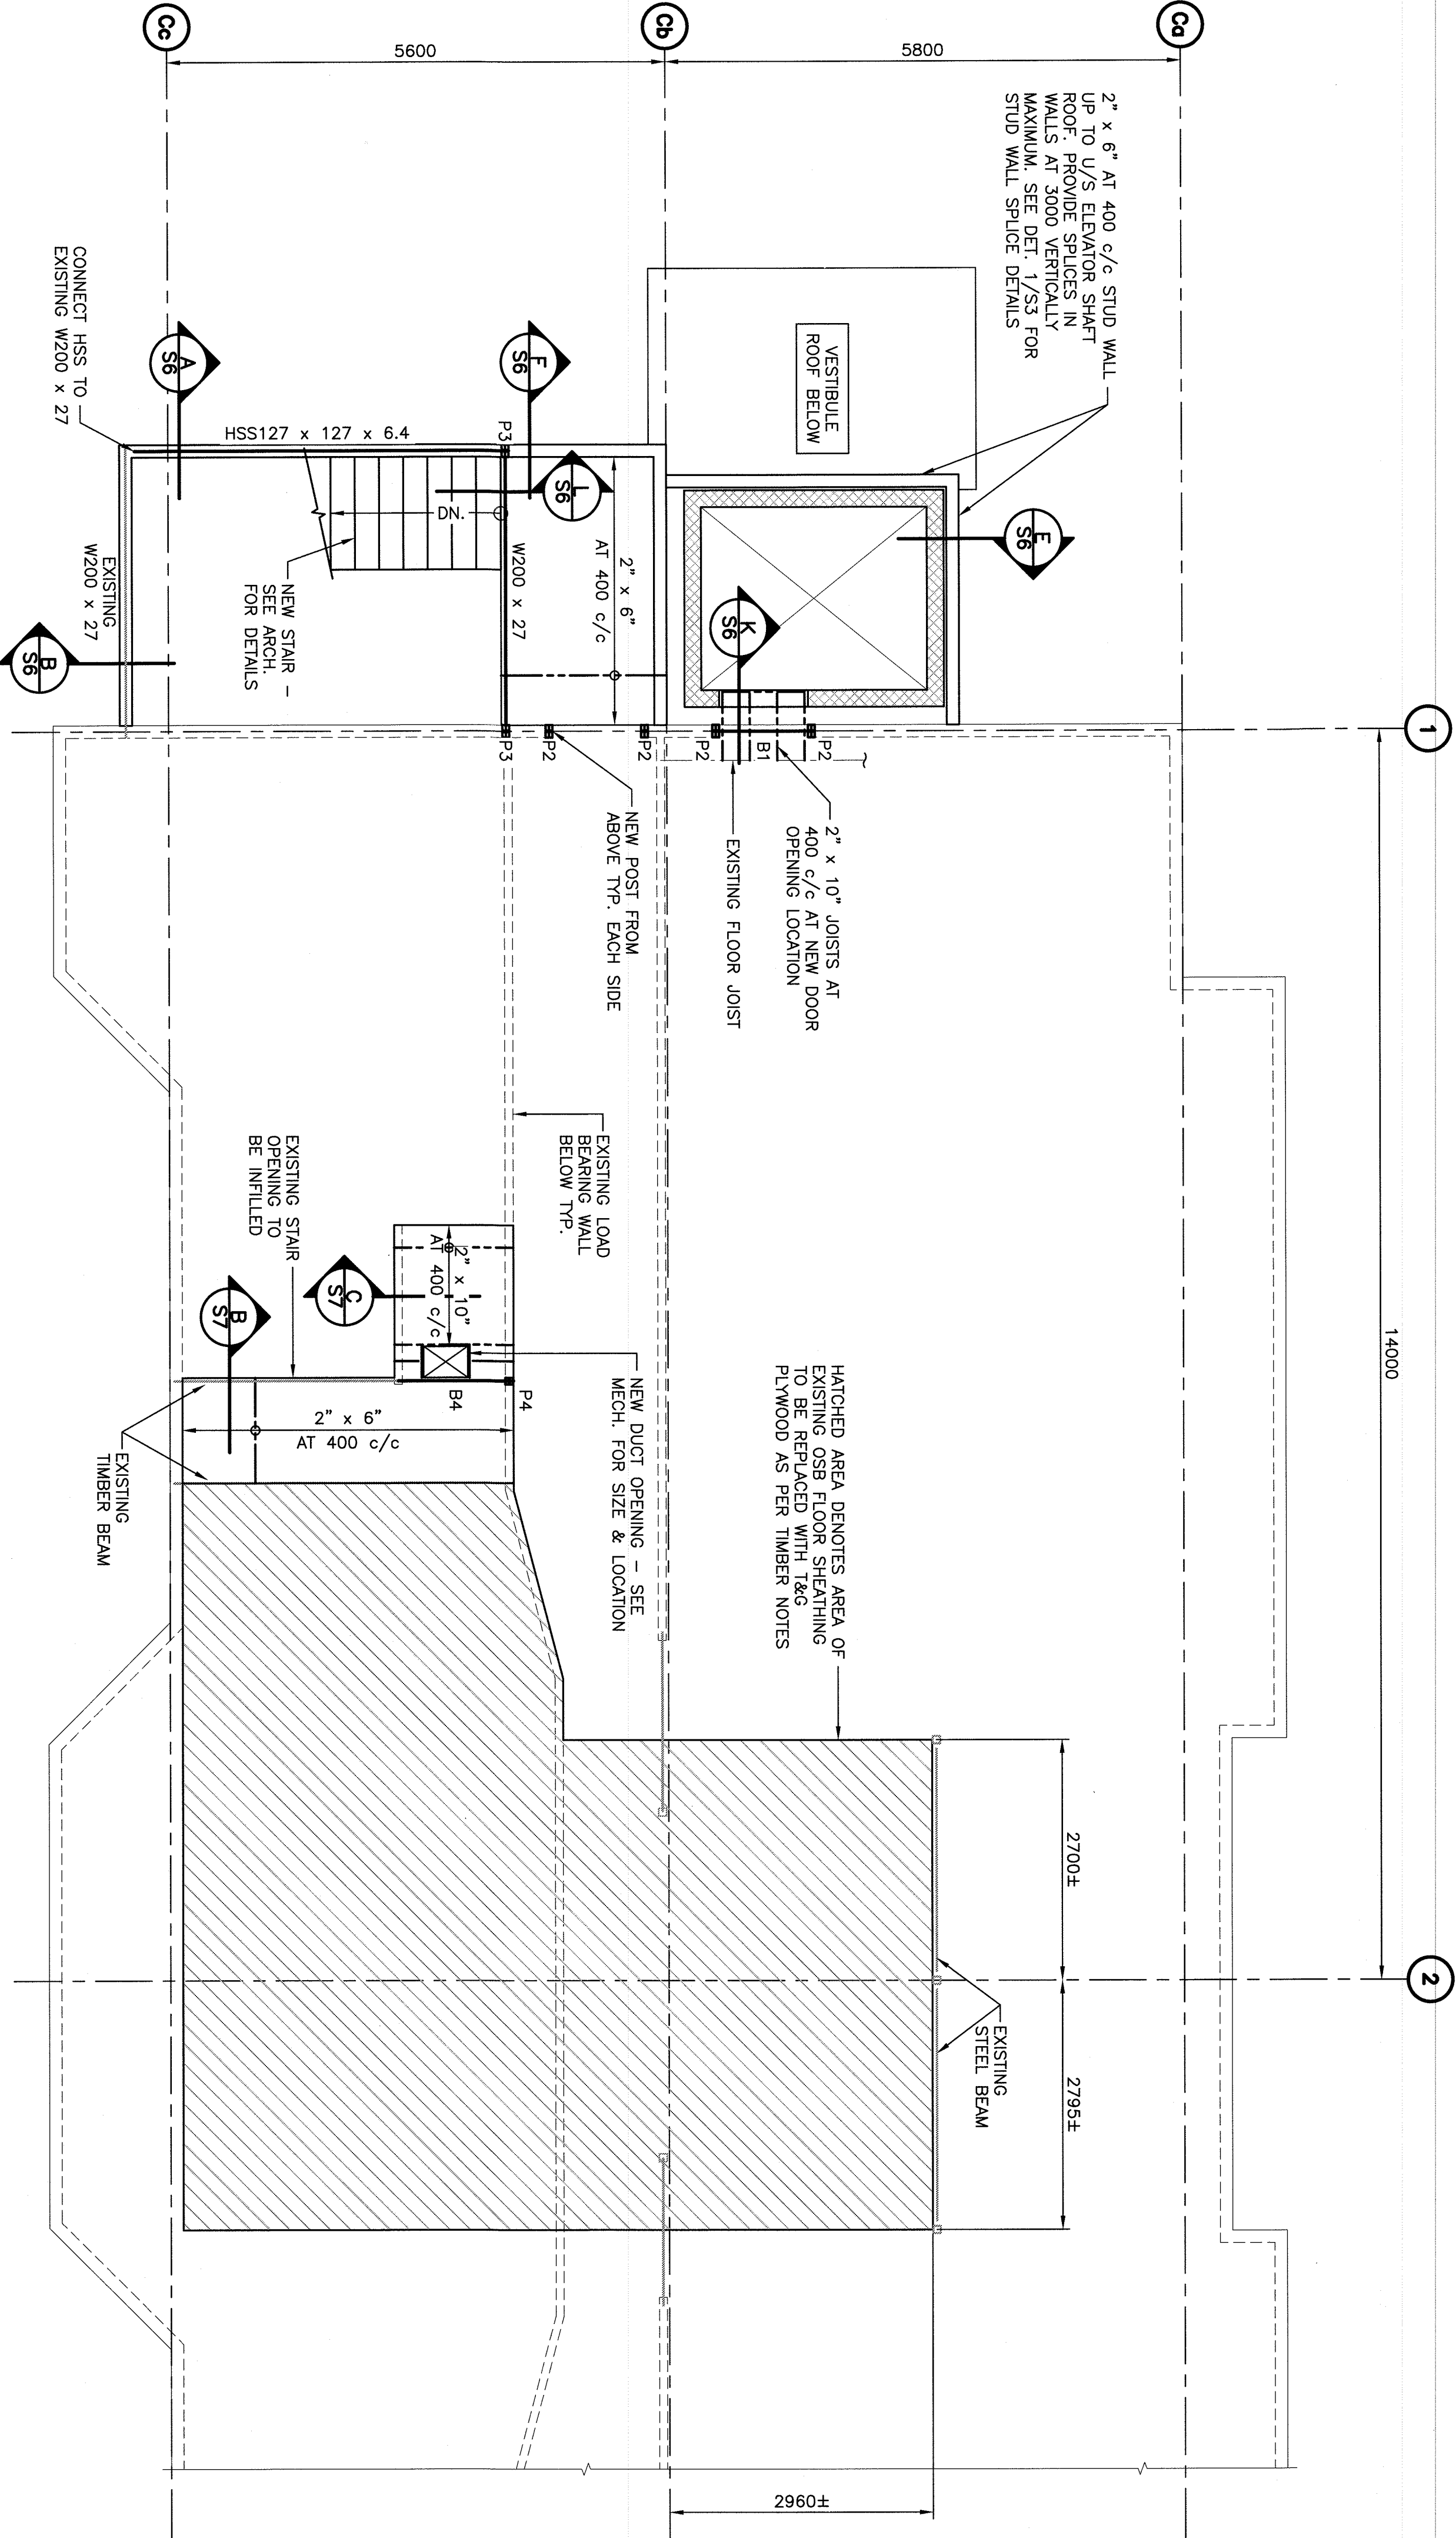

LEVEL 300 FRAMING PLAN

SCALE: 1/30

0m 1m 2m 3m 4m 5m

FLOOR INFILL DESIGN LOADS:

DEFLECTION CRITERIA: ..... L/360



DEAD LOAD: ..... 0.80 kPa

LIVE LOAD: ..... 2.40 kPa

DETAIL - STUD WALL SPLICE

SCALE: 1:10

0mm 100 200 300 400 500 600 700 800 900/1000mm

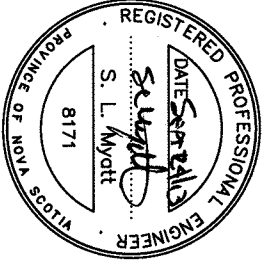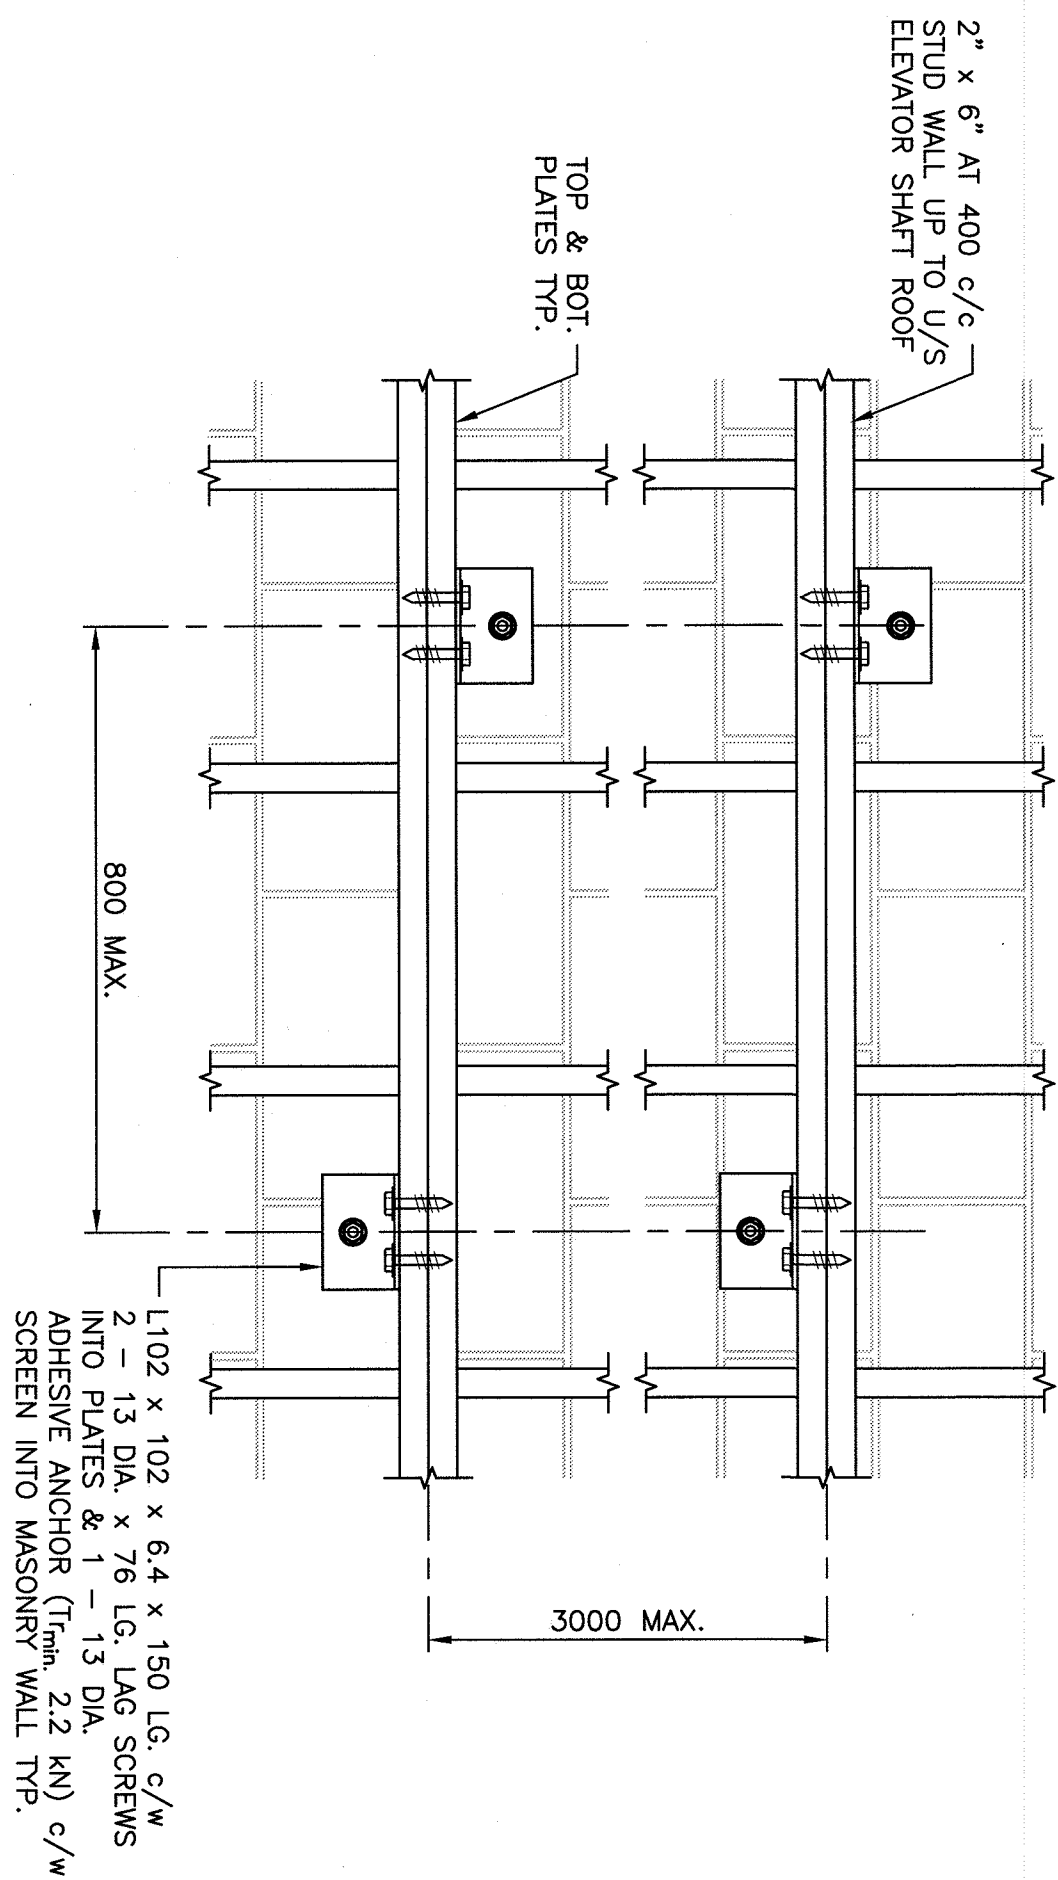

CANADIAN COAST  
GUARD COLLEGE  
MCIS RENOVATIONS  
SYDNEY, NS

STRUCTURAL  
LEVEL 300  
FRAMING PLAN

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date	JUNE 2013	
drawn	S. FRASER	designe
date	JUNE 2013	
approved	M. WOODMAN	approve
date	JUNE 2013	
Tender		Submission
Project Manager	Administrateur de projet	TSOC
Project Number	no. du projet	
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Drawing no.		no. du dessin
	S3	