

**POWER
MIDDEL**
architecture

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ISO 9001 CERTIFIED

GENERAL NOTES:

1. SEE DRAWING E1 FOR LEGEND, DEMOLITION NOTES (H) AND CONSTRUCTION NOTES (C)
2. CONNECT UNIT EMERGENCY LIGHTING EQUIPMENT TO UNSWITCHED LEG OF NORMAL LIGHTING CIRCUIT IN SPACE.
3. REMOVE EXISTING LIGHTING AND SWITCHES IN STAIRWAY, WIRING AND BOXES TO REMAIN AND BE RE-USED.
4. NEW LIGHTING AND SWITCHES TO BE INSTALLED AT EXISTING ROUGH-IN LOCATIONS UNLESS OTHERWISE NOTED.
5. REFER TO MECHANICAL DRAWINGS FOR DETAILS.
6. CONNECT LIGHTING OVER EMERGENCY LIGHTING CIRCUIT

CANADIAN COAST
GUARD COLLEGE
MCTS RENOVATIONS
SYDNEY, NS

ELECTRICAL
FLOOR PLANS
LEVEL 300

designed STEVE WOODENDO

drawn JARED HODGRIGHT

date JUNE 2013



approved

Submission

Project Number

R.049698.003


drawing no. E4

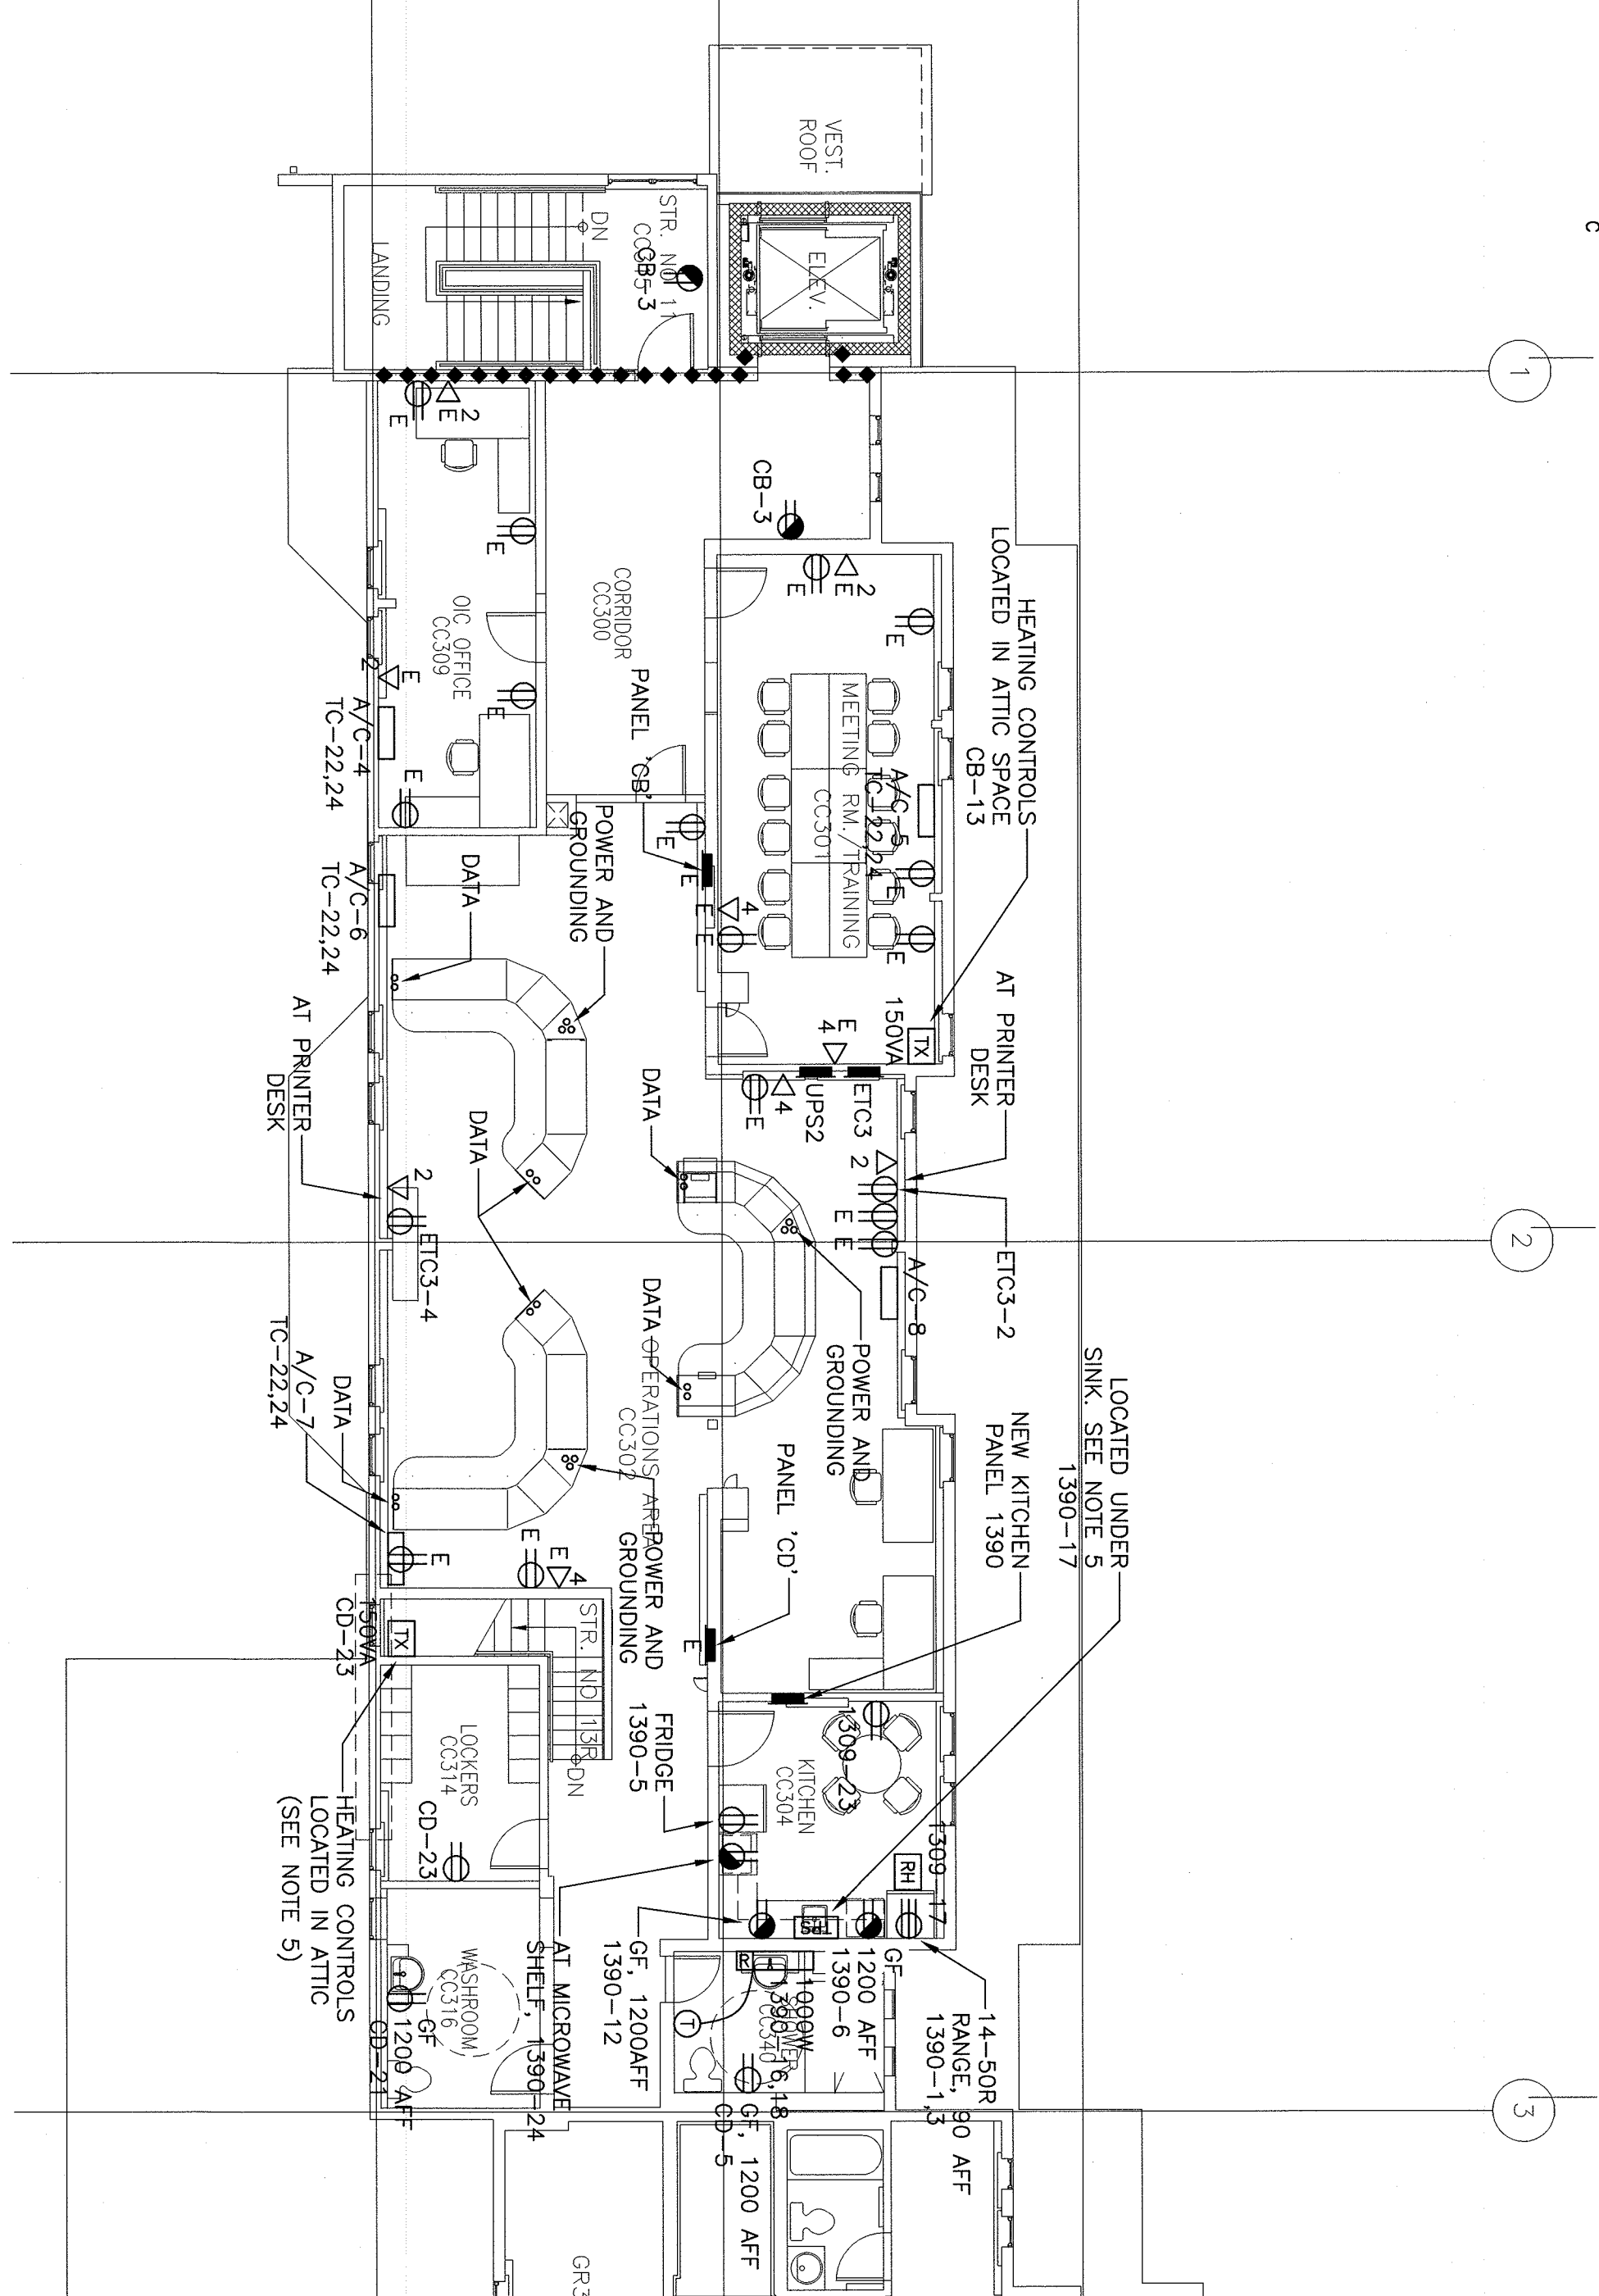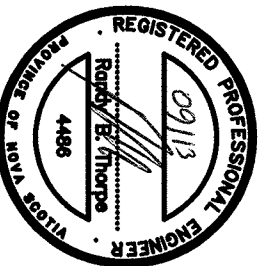

NEW FLOOR PLAN – LEVEL 300 – POWER & TELECOM.

SCALE : 1:100


0m 1m 2m 3m 4m 5m 6m 7m 8m 9m 10m

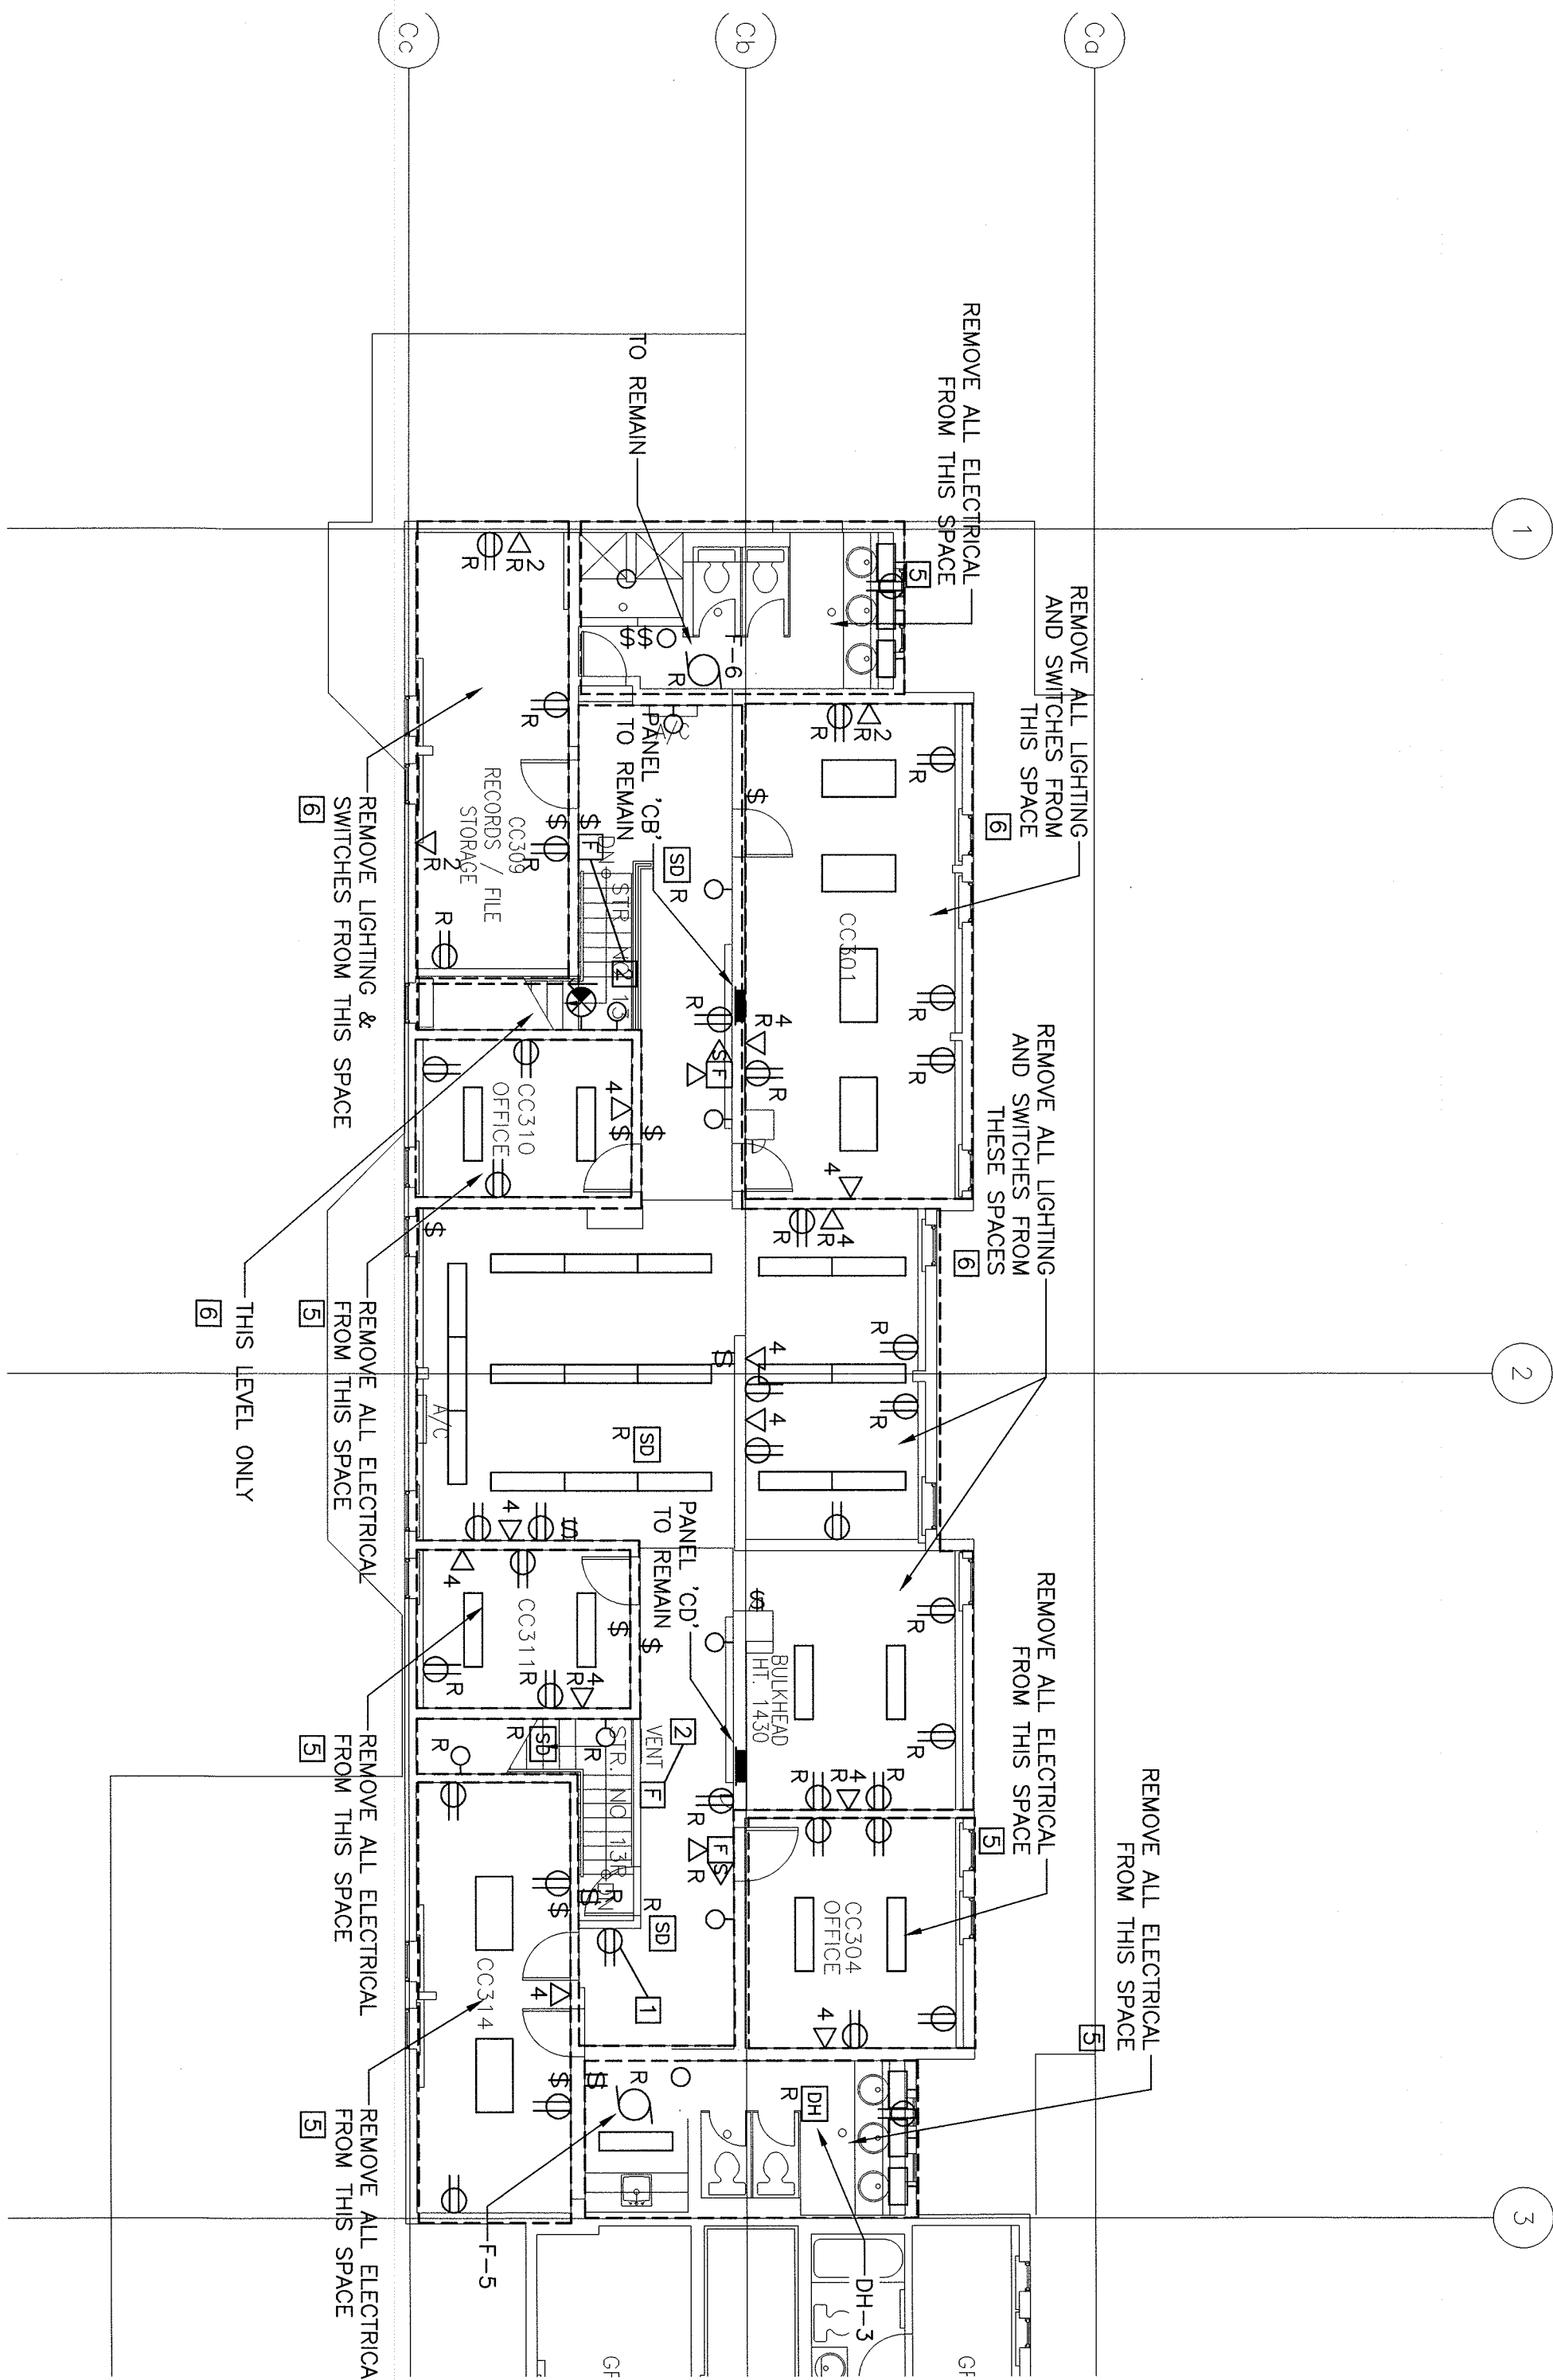

EXISTING FLOOR PLAN – LEVEL 300 – ALL SYSTEMS.

SCALE : 1:100


0m 1m 2m 3m 4m 5m 6m 7m 8m 9m 10m

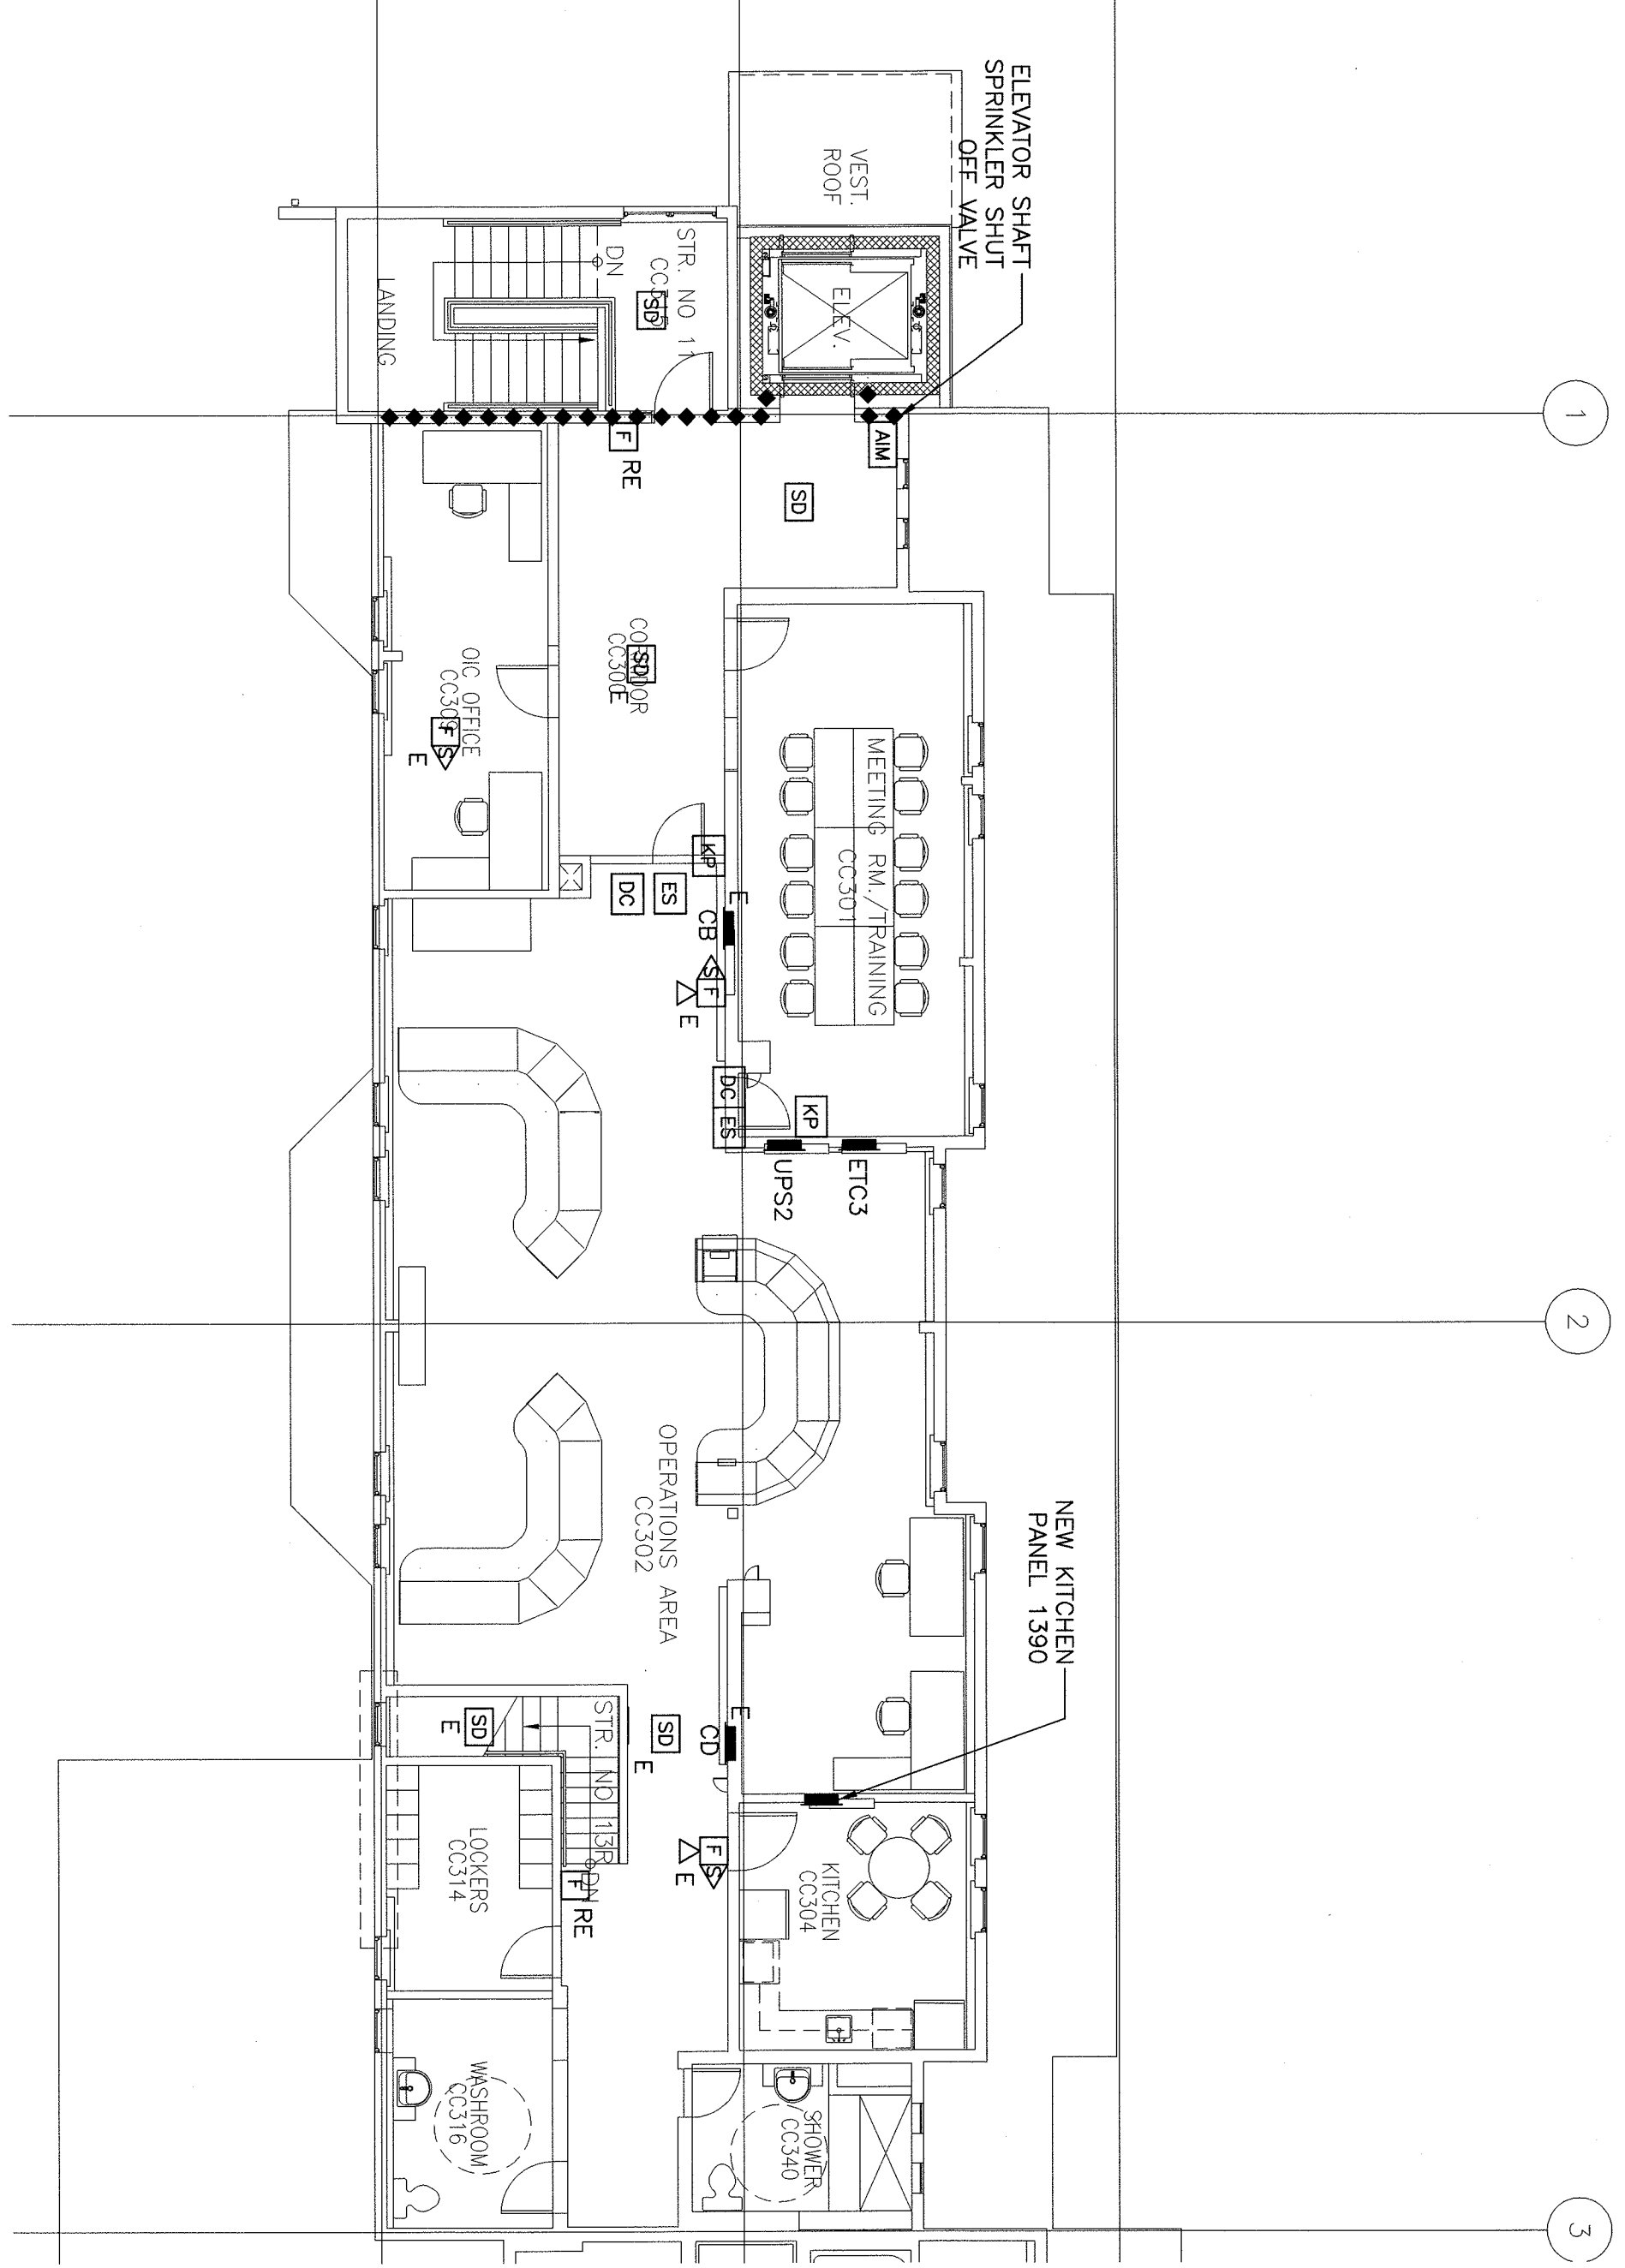

NEW FLOOR PLAN – LEVEL 300 – SYSTEMS.

SCALE : 1:100

0m 1m 2m 3m 4m 5m 6m 7m 8m 9m 10m

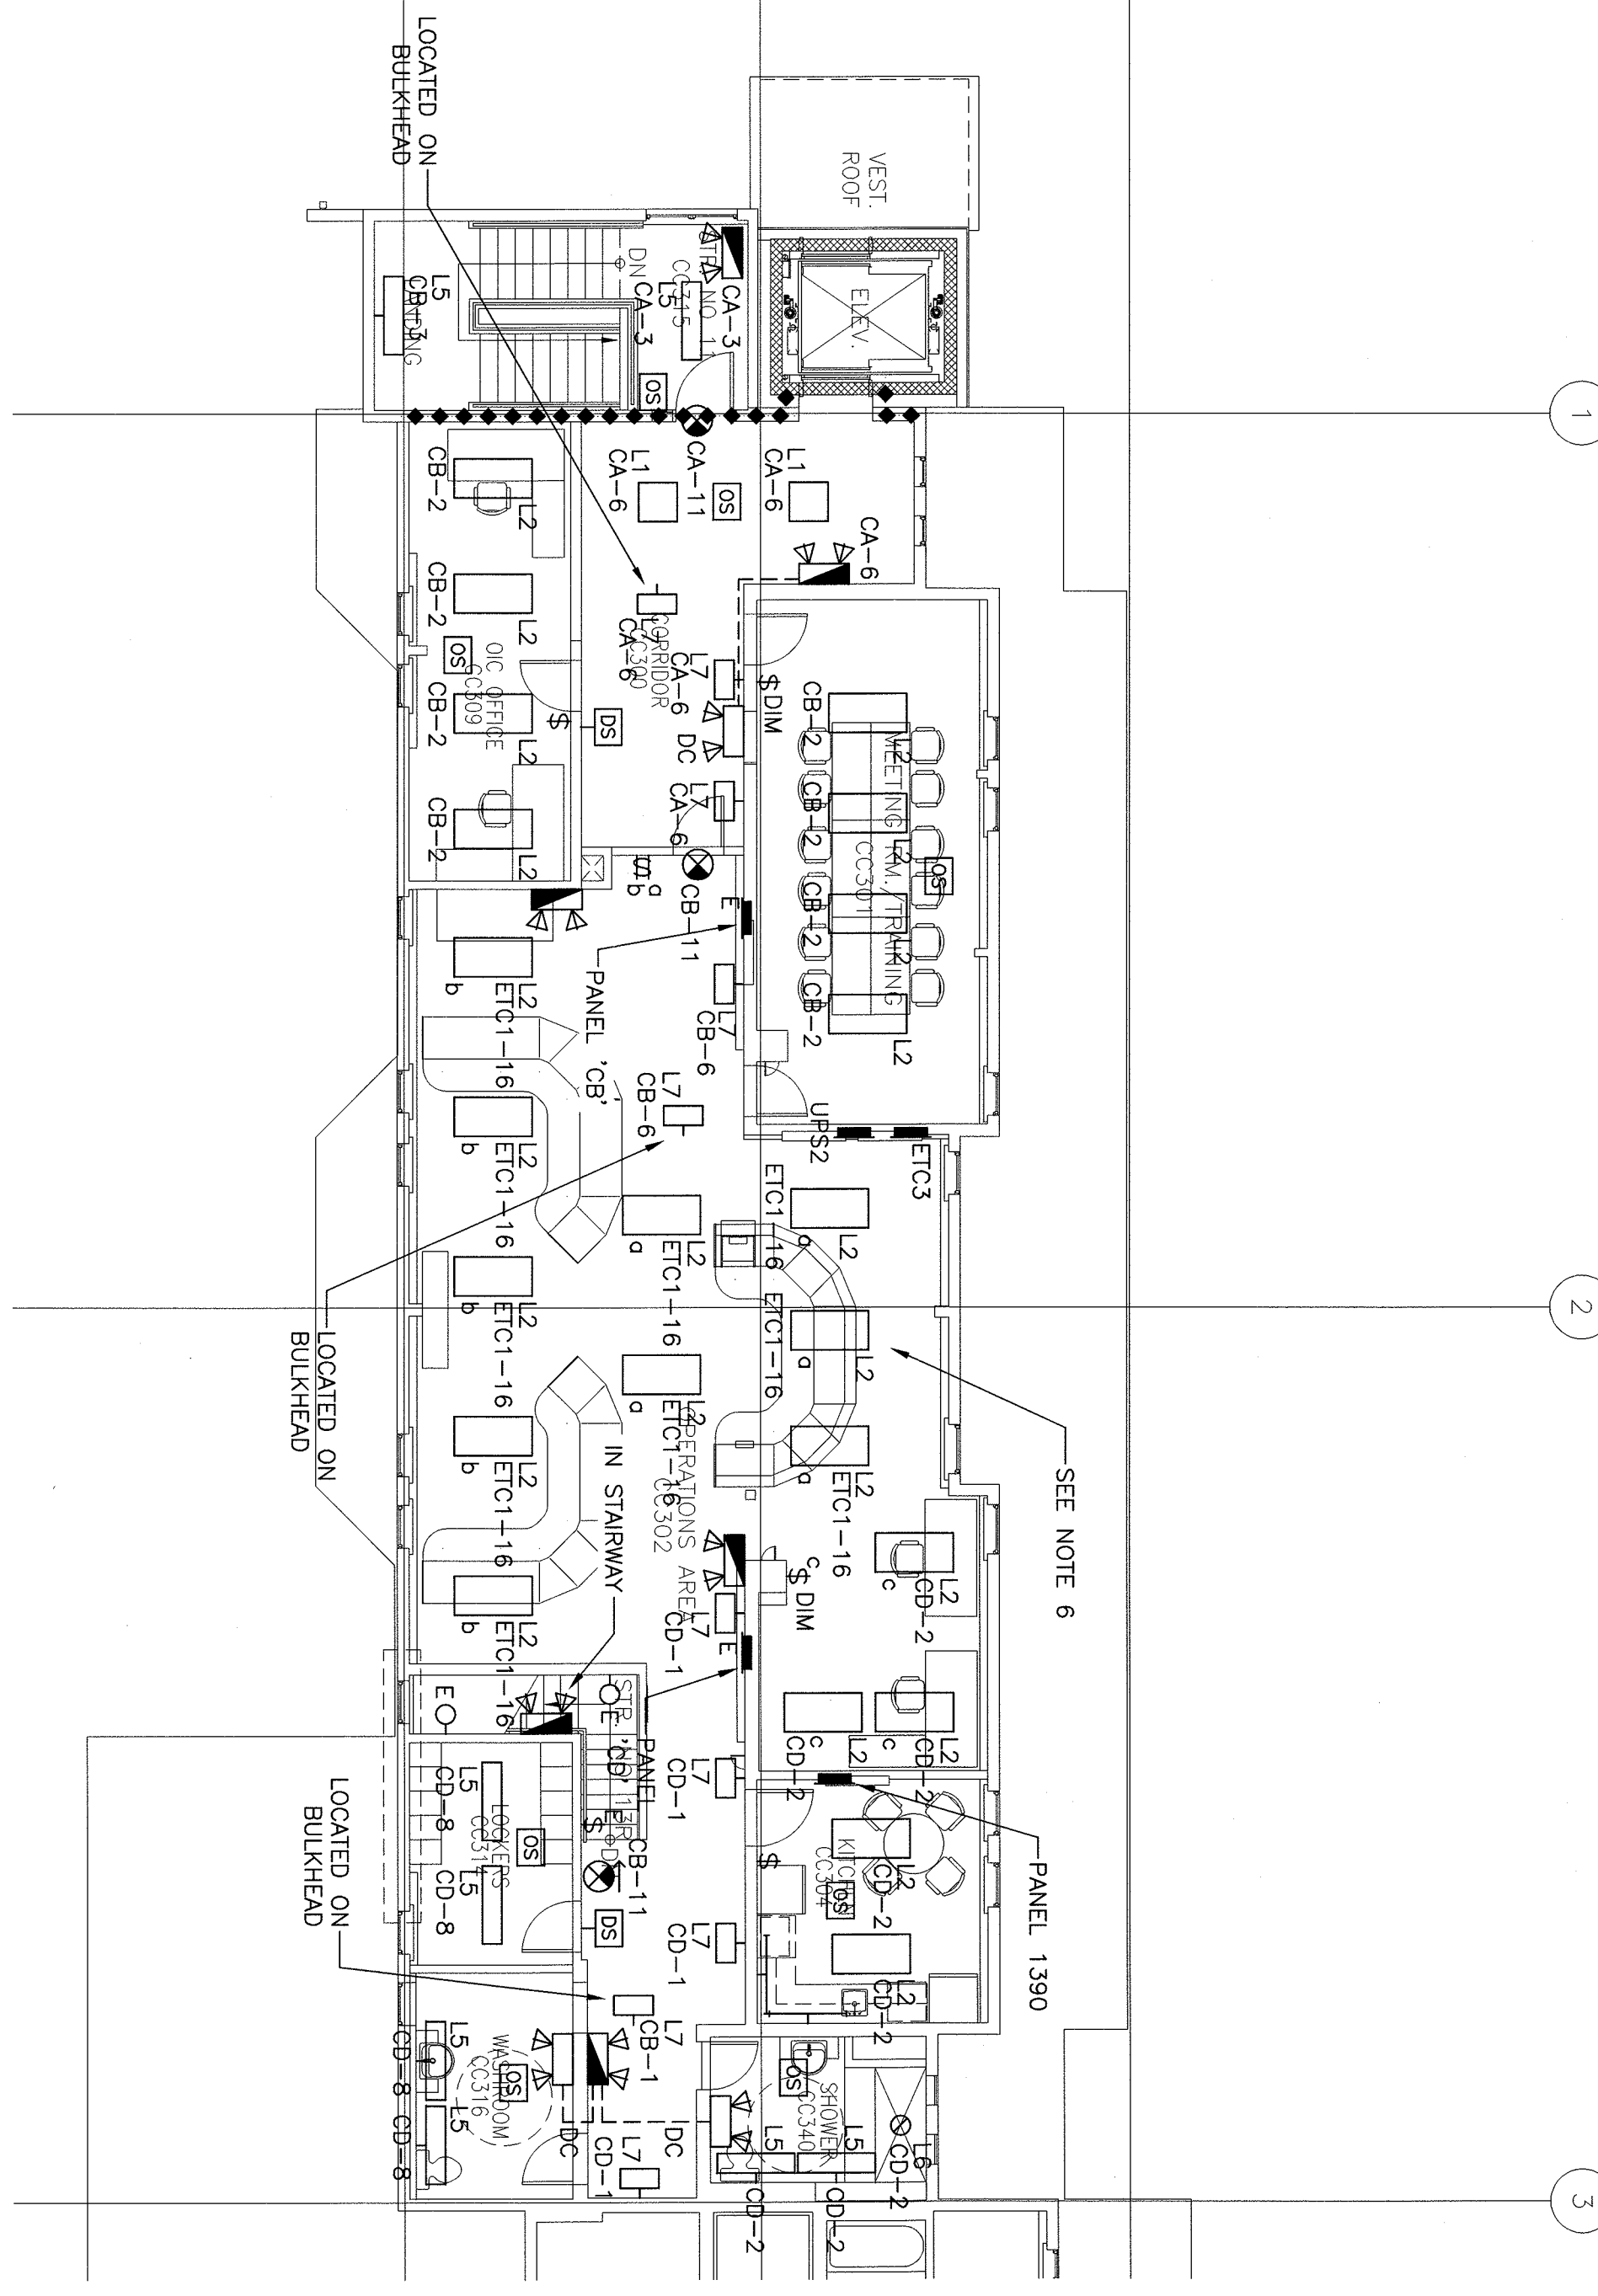

NEW FLOOR PLAN – LEVEL 300 – LIGHTING.

SCALE : 1:100

0m 1m 2m 3m 4m 5m 6m 7m 8m 9m 10m