
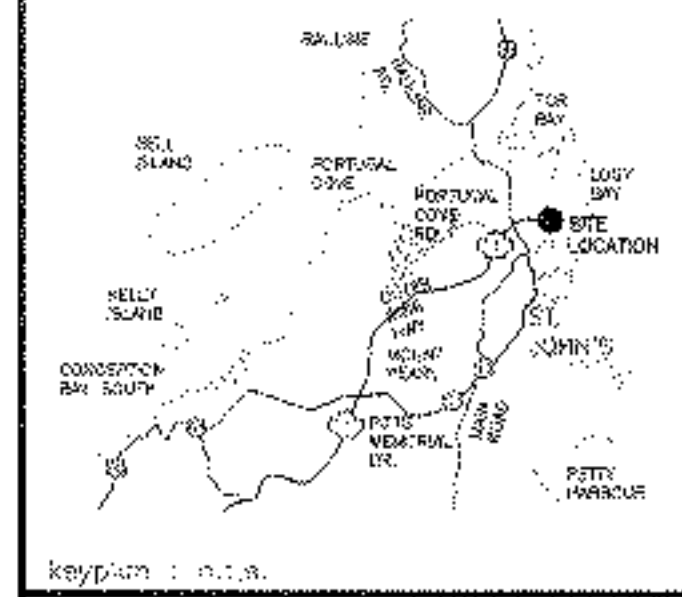


- LEGEND
- EXISTING WATER LINE
 - NEW WATER LINE
 - EXISTING CULVERT
 - EXISTING DITCH
 - BOTTOM OF BANK
 - TOP OF BANK
 - EXISTING POWER LINES
 - EXISTING ELECTRICAL CONDUIT
 - EXISTING POWER POLE (AND ANCHOR)
 - CONCRETE MARKER POST (AND ANCHOR)
 - CONCRETE BULKHEAD
 - GRAVEL ROAD
 - WETLAND

SCALE: 1:500

0m 10m 20m 30m 40m 50m

- NOTES:
1. CONTOUR INTERVALS ARE 0.5m.
 2. WHEN WORKING IN THE VICINITY OF BURIED INFRASTRUCTURE, THE CONTRACTOR SHALL CARRY OUT CAREFUL TEST DIGS AS REQUIRED.
 3. FOR SURVEY INFORMATION, REFER TO DRAWING PREPARED BY PWGSC, DATED JULY 11, 2013.
 4. THE CONTRACTOR SHALL BE AWARE OF ALL EXISTING INFRASTRUCTURE. THE CONTRACTOR SHALL TAKE ALL APPROPRIATE CARE WHEN WORKING IN THIS AREA AND PROTECT IT FROM DAMAGE.
 5. THE LOCATION OF EXISTING UNDERGROUND INFRASTRUCTURE SHOULD BE CONSIDERED AS APPROXIMATE ONLY AND NOT GUARANTEED TO BE ACCURATE OR CORRECT.
 6. MOVED/DISTURBED CONCRETE MARKER POST MUST BE RETURNED/REPLACED TO THEIR ORIGINAL LOCATION.

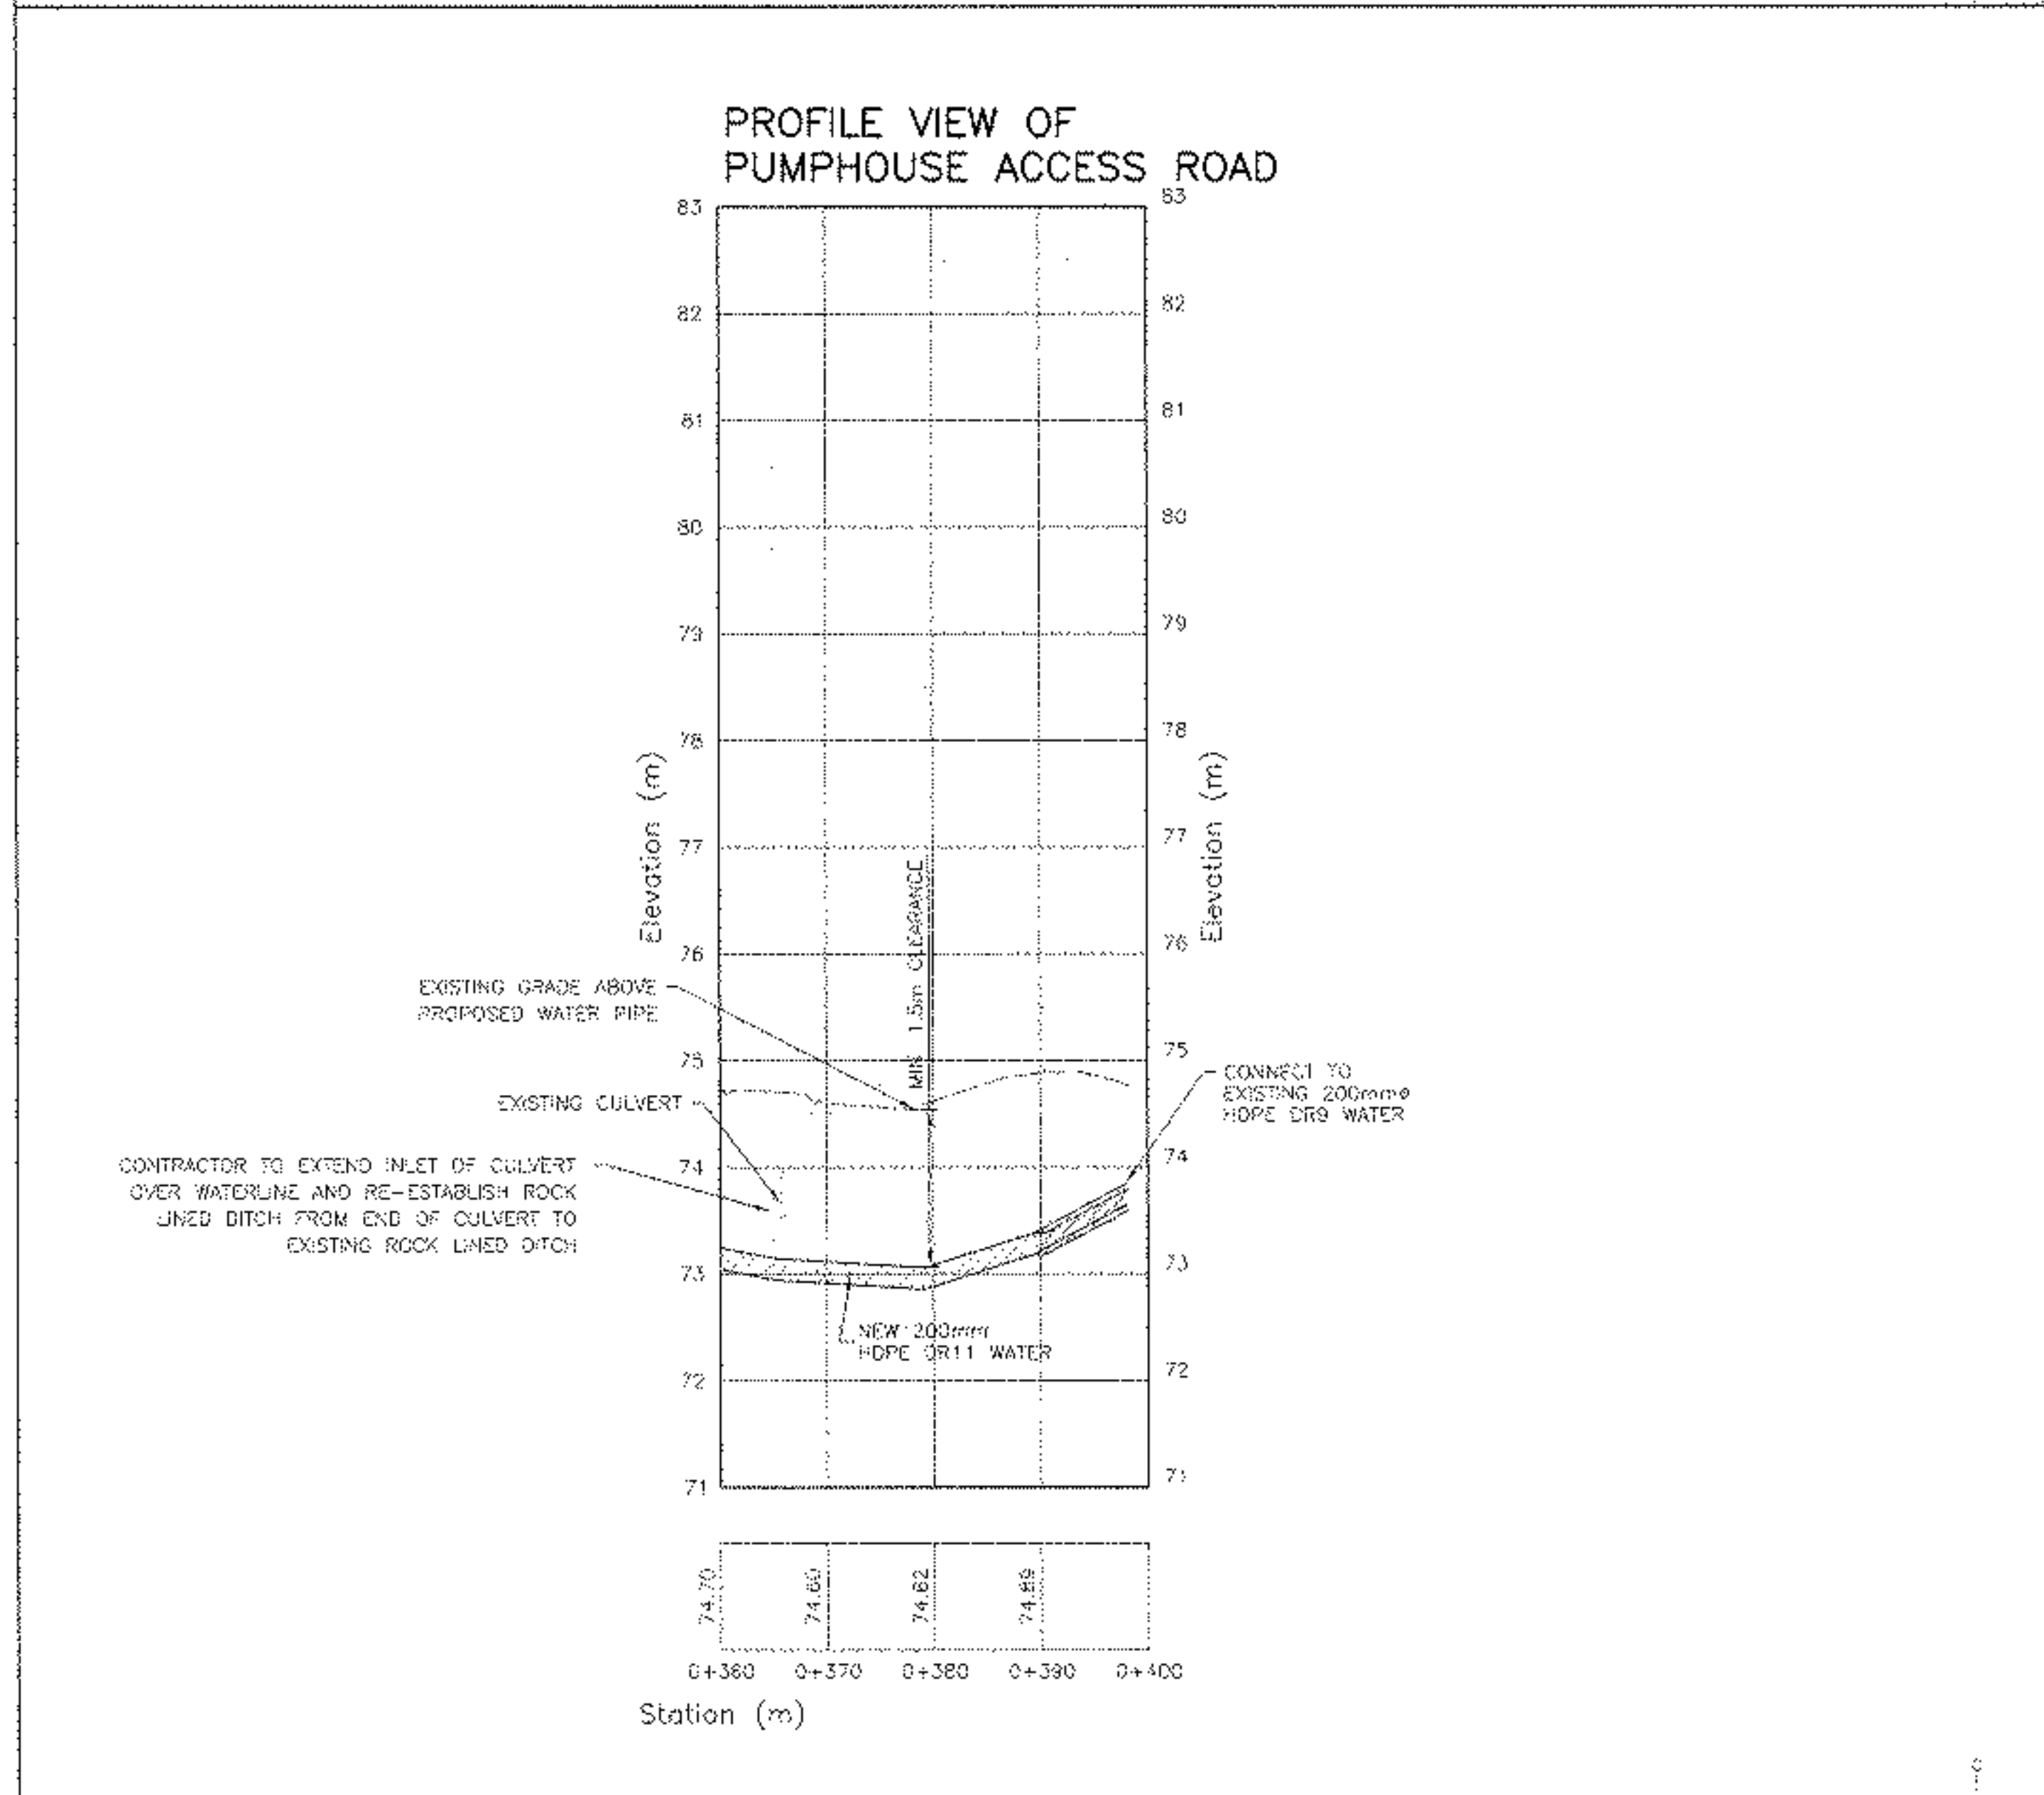

CDC	ISSUED FOR TENDER	001.0
Revisions		date

SALTWATER SUPPLY SYSTEM REPAIRS
NORTH ATLANTIC FISHERIES CENTRE
ST. JOHN'S, NL

WATER
PLAN AND PROFILE
(STA. 0+360 TO 0+400)

Drawn by J.J.	Scale 2013-08-09	Sheet MZH	Drawn by
Checked N.L.	Scale 2013-08-09	Checked N.L.	Checked by
Drawn by	Scale	Sheet	Drawn by
C.M.	Scale	Sheet	C.M.
Project number	Project number	Project number	Project number
R.058758.001	R.058758.001	R.058758.001	R.058758.001
Sheeting no.	Sheeting no.	Sheeting no.	Sheeting no.
C2	C2	C2	C2