

revision	0	ISSUED FOR TENDER	10/28/2013
project	RAISING DECK ELEVATION		
client	BLACK RIVER ST. JOHN CO. NB.		



**ELECTRICAL PLAN
AND DETAILS**

designed	RMB	checked	
drawn	SEP7 2013	drawn	SEP7 2013
date	SEP7 2013	date	SEP7 2013
approved	BET	approved	
date	SEP7 2013	date	SEP7 2013
project number	R.064463.001		
drawing no.	E1 of 2		



NOTES

- SERVICE ENTRANCE TO BE REMOVED INCLUDING LOADCENTER IN FIBREGLASS ENCLOSURE, TWO 15A, 120V DUPLEX RECEPTACLES, ONE 50A, 250V SINGLE RECEPTACLE, SUPPORT POSTS AND PLYWOOD BACKBOARD.
- UTILITY METER AND WEATHERHEAD FOR A 100A, 240V, 1PH SERVICE TO BE REMOVED.
- EXISTING LUMINAIRE AND WOOD POLE TO BE REMOVED INCLUDING AERIAL FEED.
- EXISTING LUMINAIRE TO BE REMOVED C/W AERIAL FEED. POLE TO REMAIN AND BE REUSED FOR NEW UNDERGROUND SERVICE.
- EXISTING SERVICE POLE, AERIAL SERVICE, SUPPORT POSTS AND PLYWOOD BACKBOARD, TO BE REMOVED.

GENERAL NOTES:


EXISTING PLAN IS ISSUED FOR INFORMATION ONLY AND SHOWS MAJOR ITEMS ONLY. CONTRACTOR SHALL EXAMINE ELECTRICAL DRAWINGS, VISIT THE SITE TO LOCATE ALL EXISTING UTILITIES AND DETERMINE THE SCOPE OF WORK INVOLVED IN DEMOLITION PRIOR TO SUBMITTING A TENDER. EXTRAS WILL NOT BE CONSIDERED BECAUSE ACTUAL CONDITIONS DIFFER FROM DRAWINGS. ALL COSTS INCLUDING DEMOLITION, DISPOSAL AND SITE RESTORATION MUST BE INCLUDED IN TOTAL TENDERED PRICE.

EXISTING PLAN
SCALE: 1:200

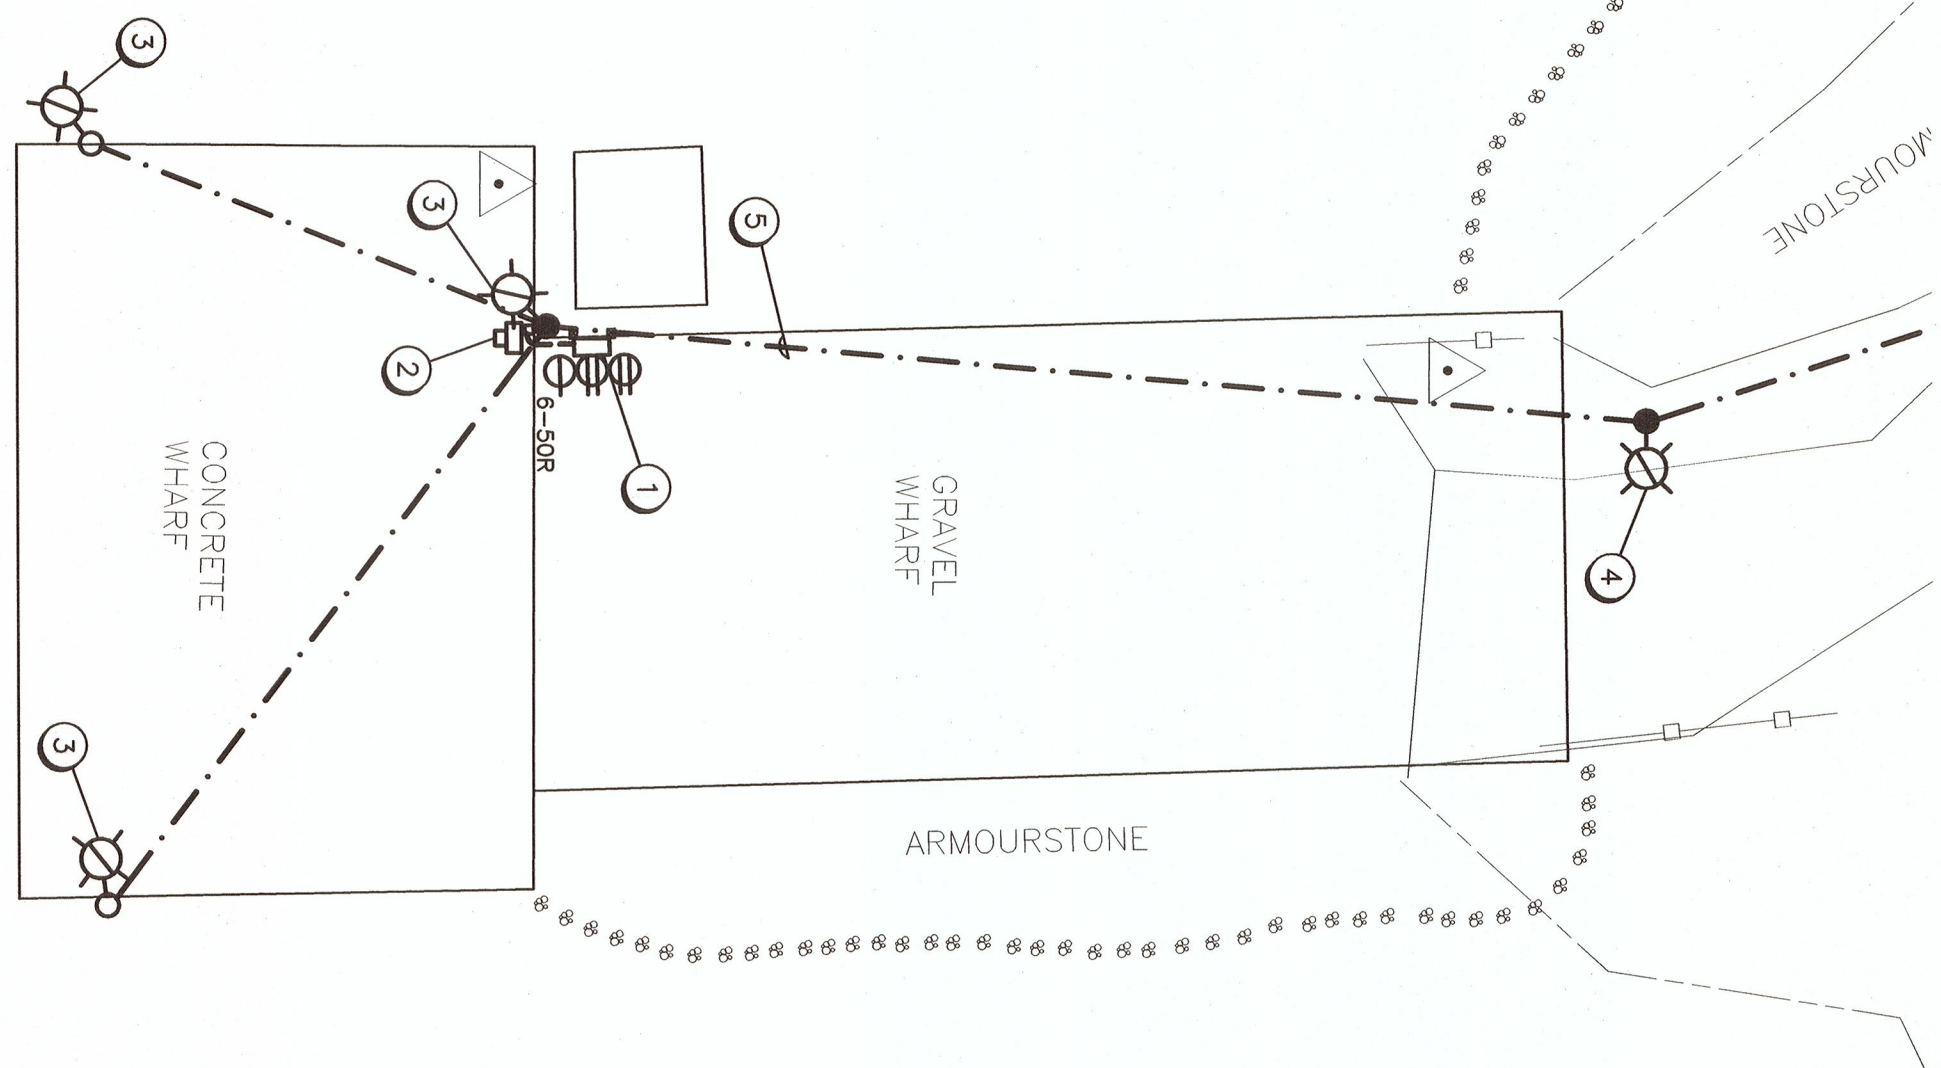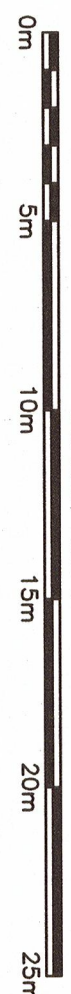


SERVICE POLE DETAIL
SCALE: N.T.S.

4
E1

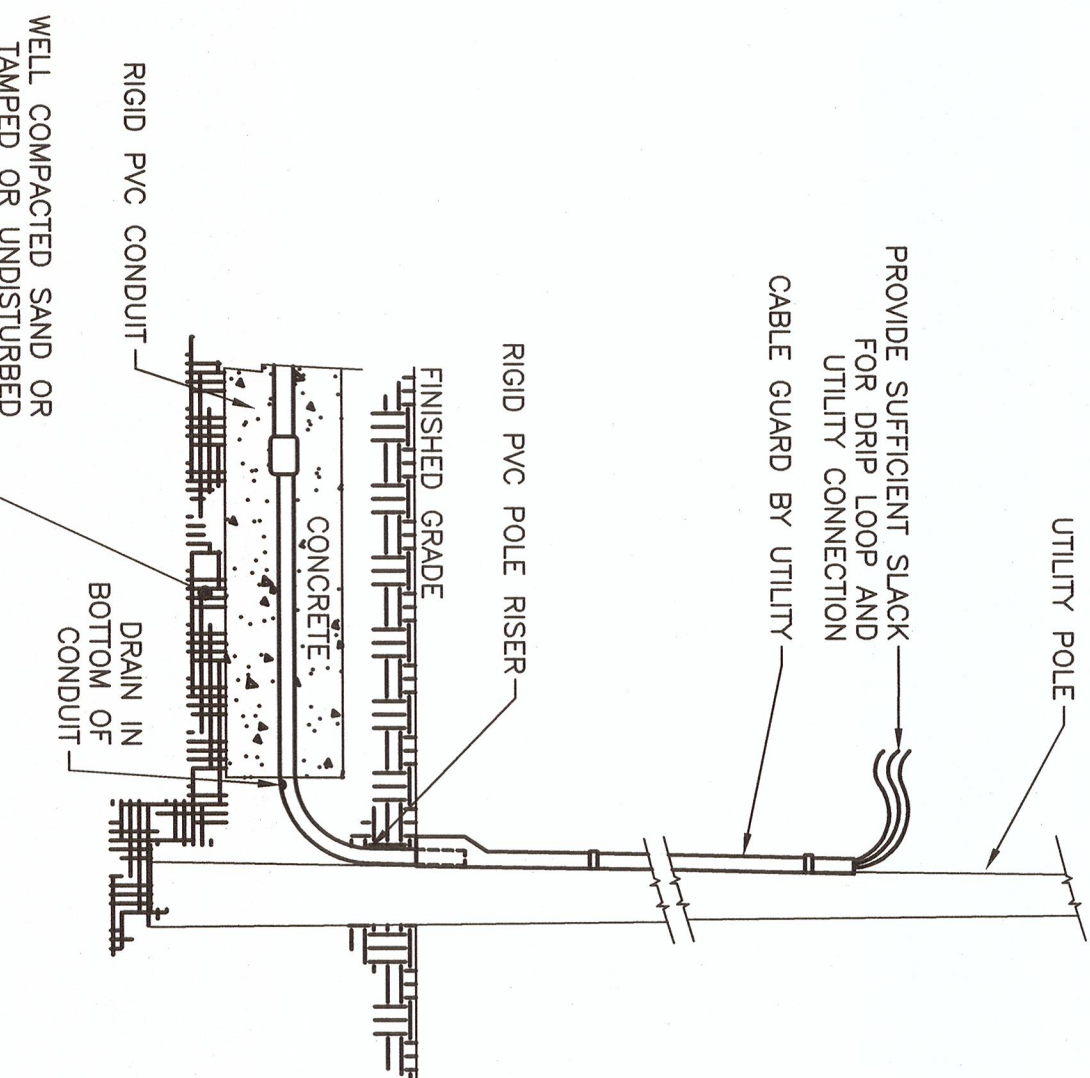


TRENCH DETAIL
SCALE: N.T.S.

A
E1

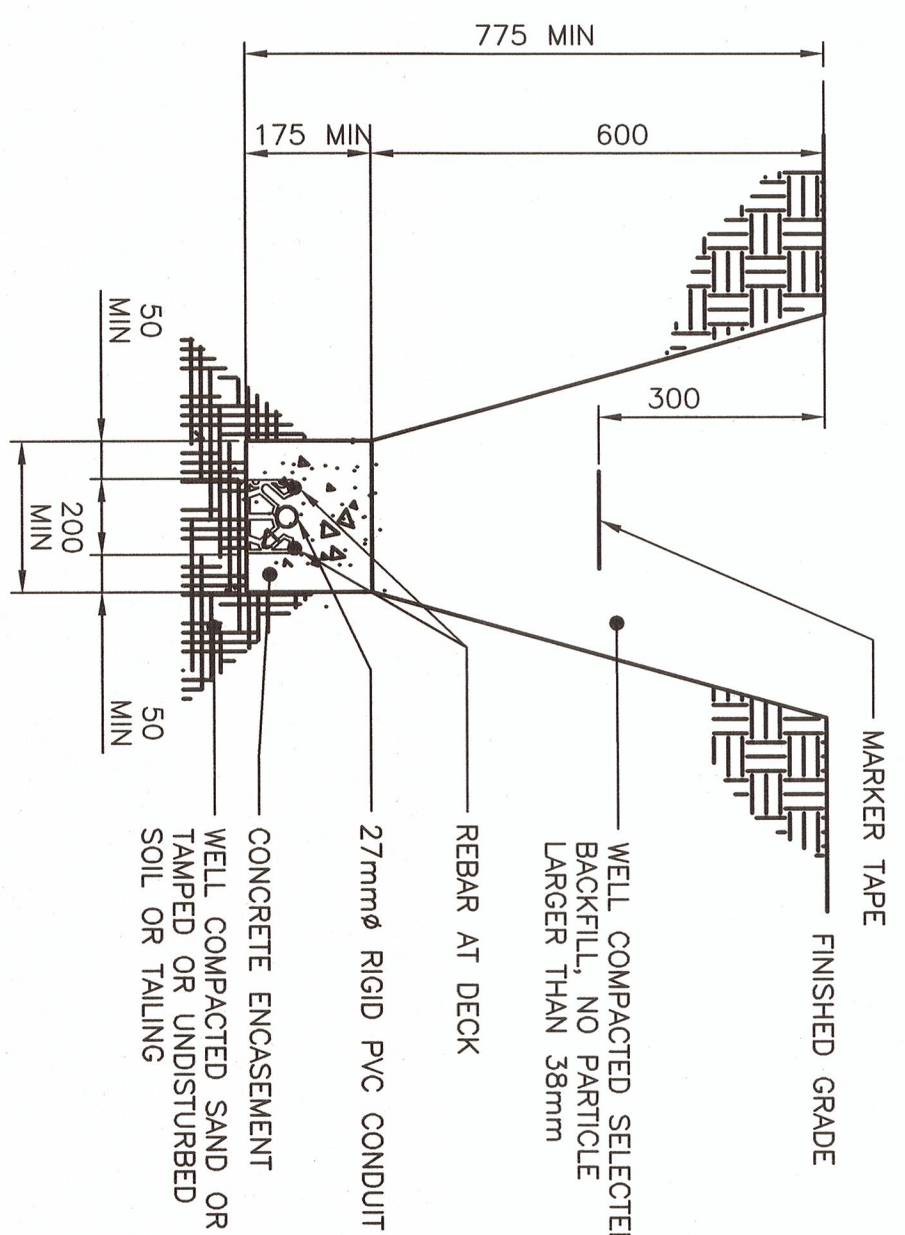

WHARF CONDUIT DETAIL
SCALE: N.T.S.

B
E1

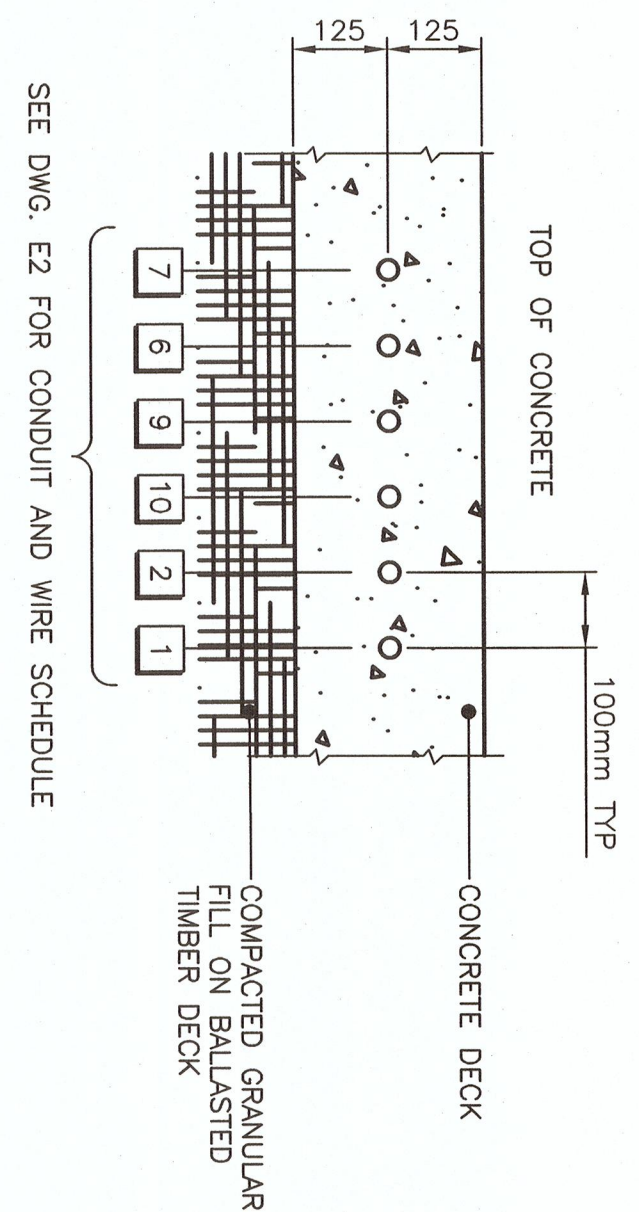

LEGEND

- SERVICE POLE AS NOTED
- SITE LIGHTING LUMINAIRE ON ALUMINUM POLE, CODED BY TYPE AND NUMBERED
- A - INDICATES TYPE IN SPECIFICATION
- ITEM 2 IN CONDUIT AND CABLE SCHEDULE
- CONDUIT AND WIRING CONCRETE ENCASED
- AERIAL WIRING
- 6-50R SINGLE RECEPTACLE, 6-50R INDICATES CSA CONFIGURATION
- G.W COMBINATION DUPLEX RECEPTACLE AND GROUND FAULT INTERRUPTER (SEE DETAIL)
- CRSC CORROSION RESISTANT STEEL CONDUIT
- A-2 INDICATES CIRCUIT #2 IN PANEL 'A'

NOTES

- COORDINATE WITH UTILITIES TO FEED NEW SERVICE. INDICATED POLE TO BE FITTED UP TO NB POWER STANDARD CONSTRUCTION PRACTICES, ED7U-25.
- CONCRETE FOR DICT ENCASEMENT TO BE SLOPED DOWN FROM DECK TO THIS AREA. REPAIR TO BE EMBEDDED IN CONCRETE. REPAIR TO BE SLOPED DOWN INTO DICT BANK FOR A MINIMUM OF 1200mm TO PREVENT SHEAR.
- CORRODED GROUND WIRE TO TOP OF EXISTING STEEL PILE.

ELECTRICAL UPGRADE PLAN
SCALE: 1:100

