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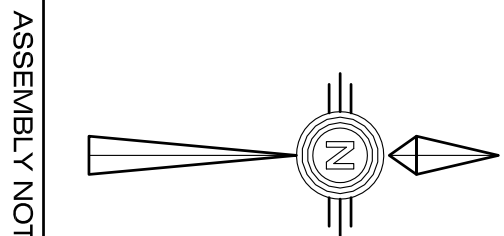
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2	98% REVIEW	OCT.21/13
1	66% REVIEW	SEPT.17/13
0	PRELIMINARY REVIEW	NOV.22/13
REVISION	Description/Description	Date/Date
Client/Client		

**CORRECTIONAL
SERVICES
CANADA**

Project title/Titre du projet
GRANDE CACHE INSTITUTION
BAG 400
GRANDE CACHE, ALBERTA
FOOD SERVICES
DISH ROOM REVITALIZATION

Approved by/Approuvé par	JEF
Designed by/Conçue par	JEF
Drawn by/Dessiné par	JEF
Project Manager/Administrateur de projets	TPSC
Project Architect/Architecte	YVON LABRECQUE
Project Engineer/Ingénieur	Responsible Architectural et de Directeur d'ingénierie, TPSC
Client/Client	RON J. PAUL
Drawing title/Titre du dessin	ELECTRICAL - SITE PLAN

Project No./No. du	Sheet/Feuille	Revision/Version
R.061948.001	E1	0
OF 3		



ASSEMBLY NOTES

SITE PLAN – POWER LAYOUT NOTES:


- COORDINATE ALL POWER & AUXILIARY INSTALLATIONS WITH ARCHITECTURAL, MECHANICAL AND STRUCTURAL LAYOUTS. CONFIRM EXACT LOCATIONS AND METHODS FOR OUTLET SUPPORTS ON SITE PRIOR TO INSTALLATIONS. MAKE ANY ADJUSTMENTS IN THE LAYOUTS AS REQUIRED TO ACCOMMODATE ALL THE WORK AT NO ADDITIONAL COSTS TO THE CONTRACT.
- CONNECT NEW TEMPERARY DISHWASHING TRAILER INTO EXISTING SUB-DIST. PANELBOARD (PFB) "E-201" c/w 200A 3-POLE BREAKER & FRAME TO SUIT. CONFIRM EXACT LOCATIONS, CONDITIONS AND REQUIREMENTS ON SITE.
- TEMPERARY TRAILER POWER FEEDER RISER ONTO ROOF. CONFIRM EXACT LOCATION, CONDITIONS AND REQUIREMENTS ON SITE.
- CONFIRM EXACT LOCATIONS, CONDITIONS AND REQUIREMENTS ON SITE AND RUN 4-#250 MCW AL XLP IN 78 EMT AND/OR TECK 90 CABLE c/w GRD. UP ONTO ROOF TO EXISTING TRAILER SERVICE ENTRANCE AND CONNECT. SUPPORT NEW FEEDER ON ROOF (PARALLEL WITH C-FRONT C-SERIES BRASS AT 3m O.C. AND 50mm GALV. STRUT CHANNEL ACROSS TO TRAILER UNIT).
- CONFIRM EXACT LOCATIONS, CONDITIONS AND REQUIREMENTS ON SITE AND CONNECT NEW FEEDER (4-#250 MCW AL XLP IN 78 EMT AND/OR TECK 90 CABLE c/w GRD.) INTO EXISTING TRAILER ELECTRICAL LOAD CENTRE c/w 75mm RIGID CONDUIT MUST AND WEATHERHEAD TO SUIT.
- NOTE: ELECTRICAL FEEDER TO TEMPORARY TRAILER ELECTRICAL LOAD CENTRE SHALL BE THE SAME ELECTRICAL LOCATION ON THE SITE AS THE EXISTING TRAILER ELECTRICAL LOAD CENTRE. CONFIRM ON SITE WITH THE GEN. CONTRACTOR, KITCHEN EQUIPMENT IS OPERATIONAL.
- NOTE: ELECTRICAL FEEDER TO TEMPORARY TRAILER ELECTRICAL LOAD CENTRE SHALL BE THE SAME ELECTRICAL LOCATION ON THE SITE AS THE EXISTING TRAILER ELECTRICAL LOAD CENTRE. CONFIRM ON SITE WITH THE GEN. CONTRACTOR, KITCHEN EQUIPMENT IS OPERATIONAL.

ELECTRICAL SYMBOL SCHEDULE

WIRING AND CONDUIT	
EMT CONDUIT OR TECK 90 RUN IN CEILING SPACE OR WALLS	---
FLEXIBLE CONDUIT OR ARMORED CABLE	~~~~~
LOW VOLTAGE CABLE RUN IN CEILING SPACE	- - - - -
JUNCTION BOXES	○ □
LIGHTING FIXTURES	☼
SURFACED CEILING MOUNTED REMOTE EMERGENCY LIGHT FIXTURE	☼
RECESSED CEILING MOUNTED LED LIGHT FIXTURE	☼
LIGHT FIXTURE TYPE (REFER TO SCHEDULE)	(10)
WIRING DEVICES	
SINGLE POLE LIGHTING SWITCH	⌵
SINGLE POLE MOTOR PROTECTION SWITCH (SIZED TO SUIT)	M ⌵
DISCONNECT SWITCH (SIZED TO SUIT)	⌵
DUPLEX RECEPTACLE	⌵
WEATHERPROOF DUPLEX RECEPTACLE	WP ⌵
DUPLEX RECEPTACLE WITH GROUND FAULT CIRCUIT PROTECTION	GFCI ⌵
208V/3-PHASE EQUIPMENT SINGLE POINT POWER CONNECTION	⌵
PANELBOARD OR CABINET – SURFACE MOUNT	⌵
OUTLETS AND EQUIPMENT	
ELECTRIC MOTOR	⌵
MISCELLANEOUS OUTLET	⌵
CEILING MOUNTED SPEAKER OUTLET	⌵
FIRE ALARM SYSTEM HORN/STROBE ALARM DEVICE	HS PD
SECURITY SYSTEM CEILING MOUNTED CCTV OUTLET	⌵
SYMBOLS	
DRAWING NOTES REFERENCE	2
NO. OF CONDUCTORS WITHIN CONDUIT	###
NO. OF CONDUCTORS WITHIN CONDUIT	8

GENERAL ELECTRICAL NOTES

- VISIT THE SITE DURING TENDERING TO CONFIRM ALL ON SITE CONDITIONS, LAYOUTS AND MEASUREMENTS.
- PRIOR TO COMMENCING INSTALLATION OF ALL WORK, THE CONTRACTOR SHALL OBTAIN ALL NECESSARY PERMITS AND APPROVALS FROM THE LOCAL AUTHORITY. THE CONTRACTOR SHALL BE RESPONSIBLE FOR LAYING OUT THE WORK AND COMMENCING WORK WITHIN THE SPECIFIED TIME FRAME. THE CONTRACTOR SHALL BE RESPONSIBLE FOR COMMENCING INSTALLATION OF THE WORK AND MAKE ANY ADJUSTMENTS TO THE LAYOUTS AS REQUIRED TO ACCOMMODATE ALL THE WORK AT NO ADDITIONAL COSTS TO THE CONTRACT.
- PRIOR TO INSTALLATIONS OF OUTLET BOXES, JUNCTION BOXES, CONDUIT BOXES, MAKE ANY ADJUSTMENTS IN LAYOUTS AS REQUIRED.
- PROVIDE AND INSTALL ALL REQUIRED OUTLETS, JUNCTION BOXES, CONDUIT DEVICES AND WIRING AS NECESSARY TO CONNECT EQUIPMENT. WIRING DEVICES AND LIGHTING FIXTURES TO SUIT LAYOUTS.
- WHERE CONDUIT, RACEWAY, CABLE TRAY, ETC. PASSES THROUGH FIRE RATED FLOORS, WALLS AND CEILINGS, SEAL ALL AROUND THE ASSEMBLY WITH UL-C FIRE RATED MATERIALS (GULF, 5M) IN AN APPROVED MANNER.
- PROVIDE AND INSTALL COMPLETE, FULLY TESTED AND OPERATIONAL ELECTRICAL SYSTEMS IN COMPLETE COMPLIANCE WITH CEC PART 1, C22.1-09.

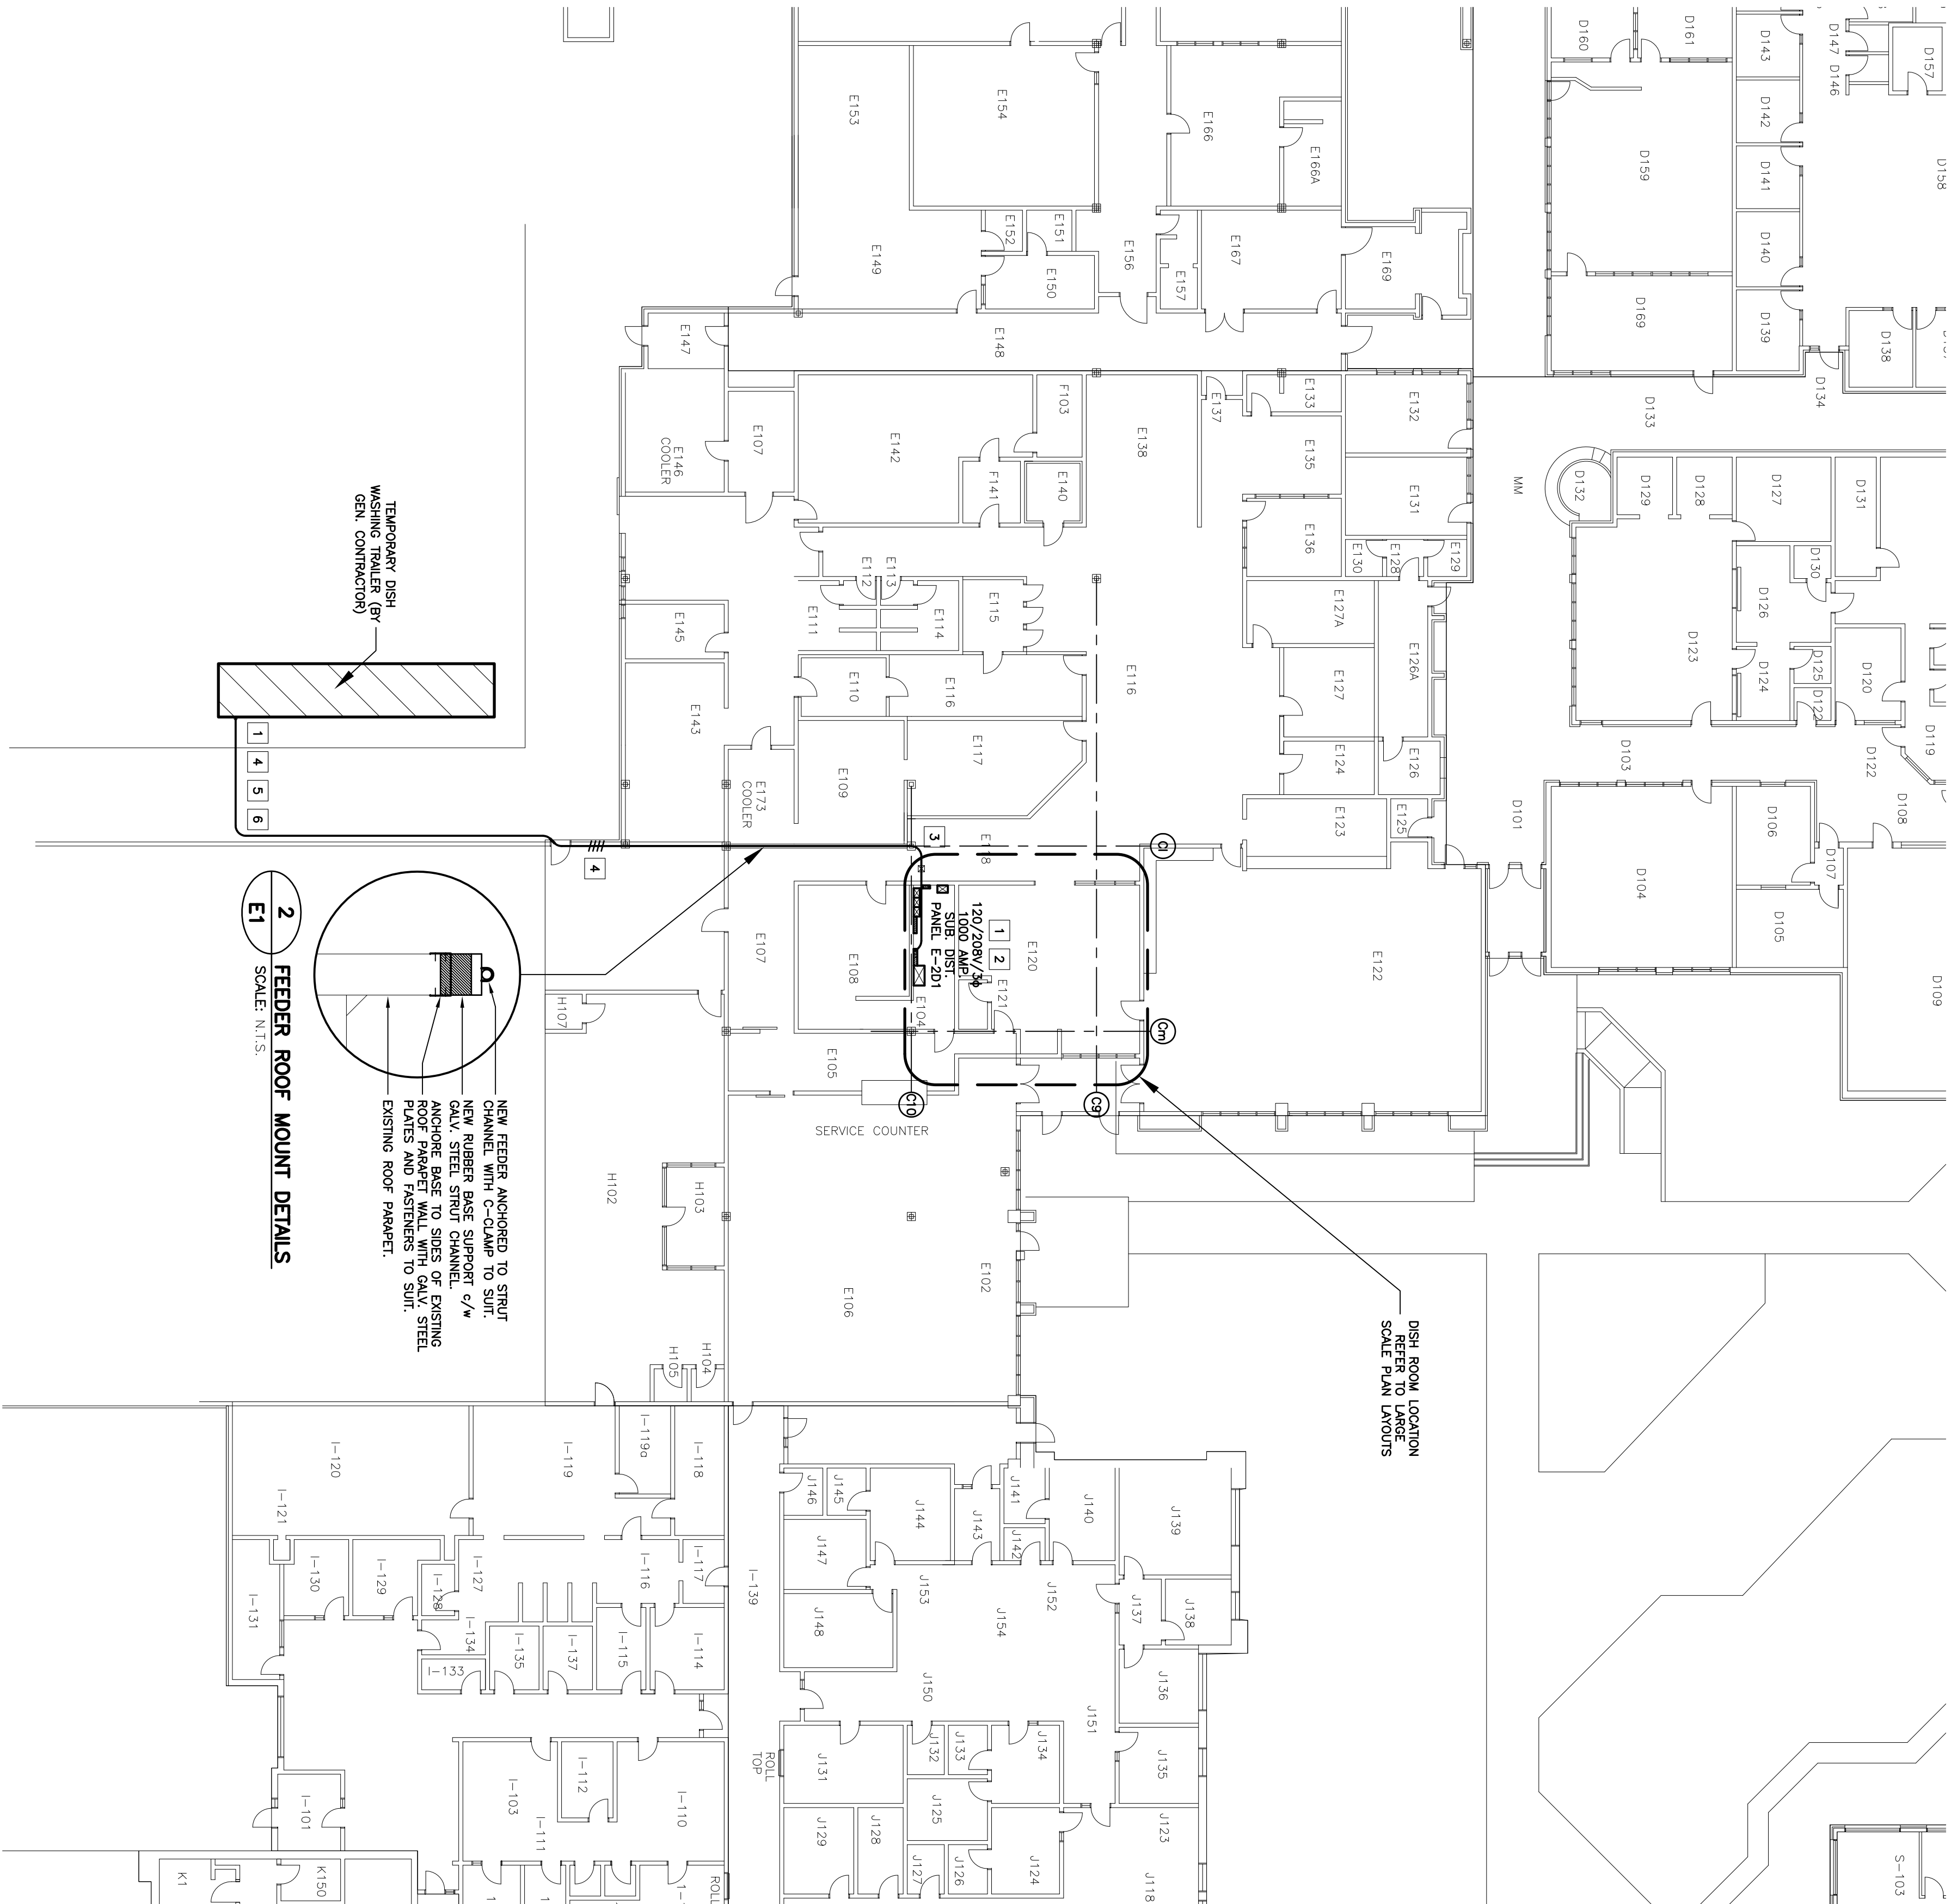

2 FEEDER ROOF MOUNT DETAILS
SCALE: N.T.S.

1 4 5 6

1 SITE PLAN – ELECTRICAL LAYOUT
SCALE: 1:200