


APPROX. NORTH

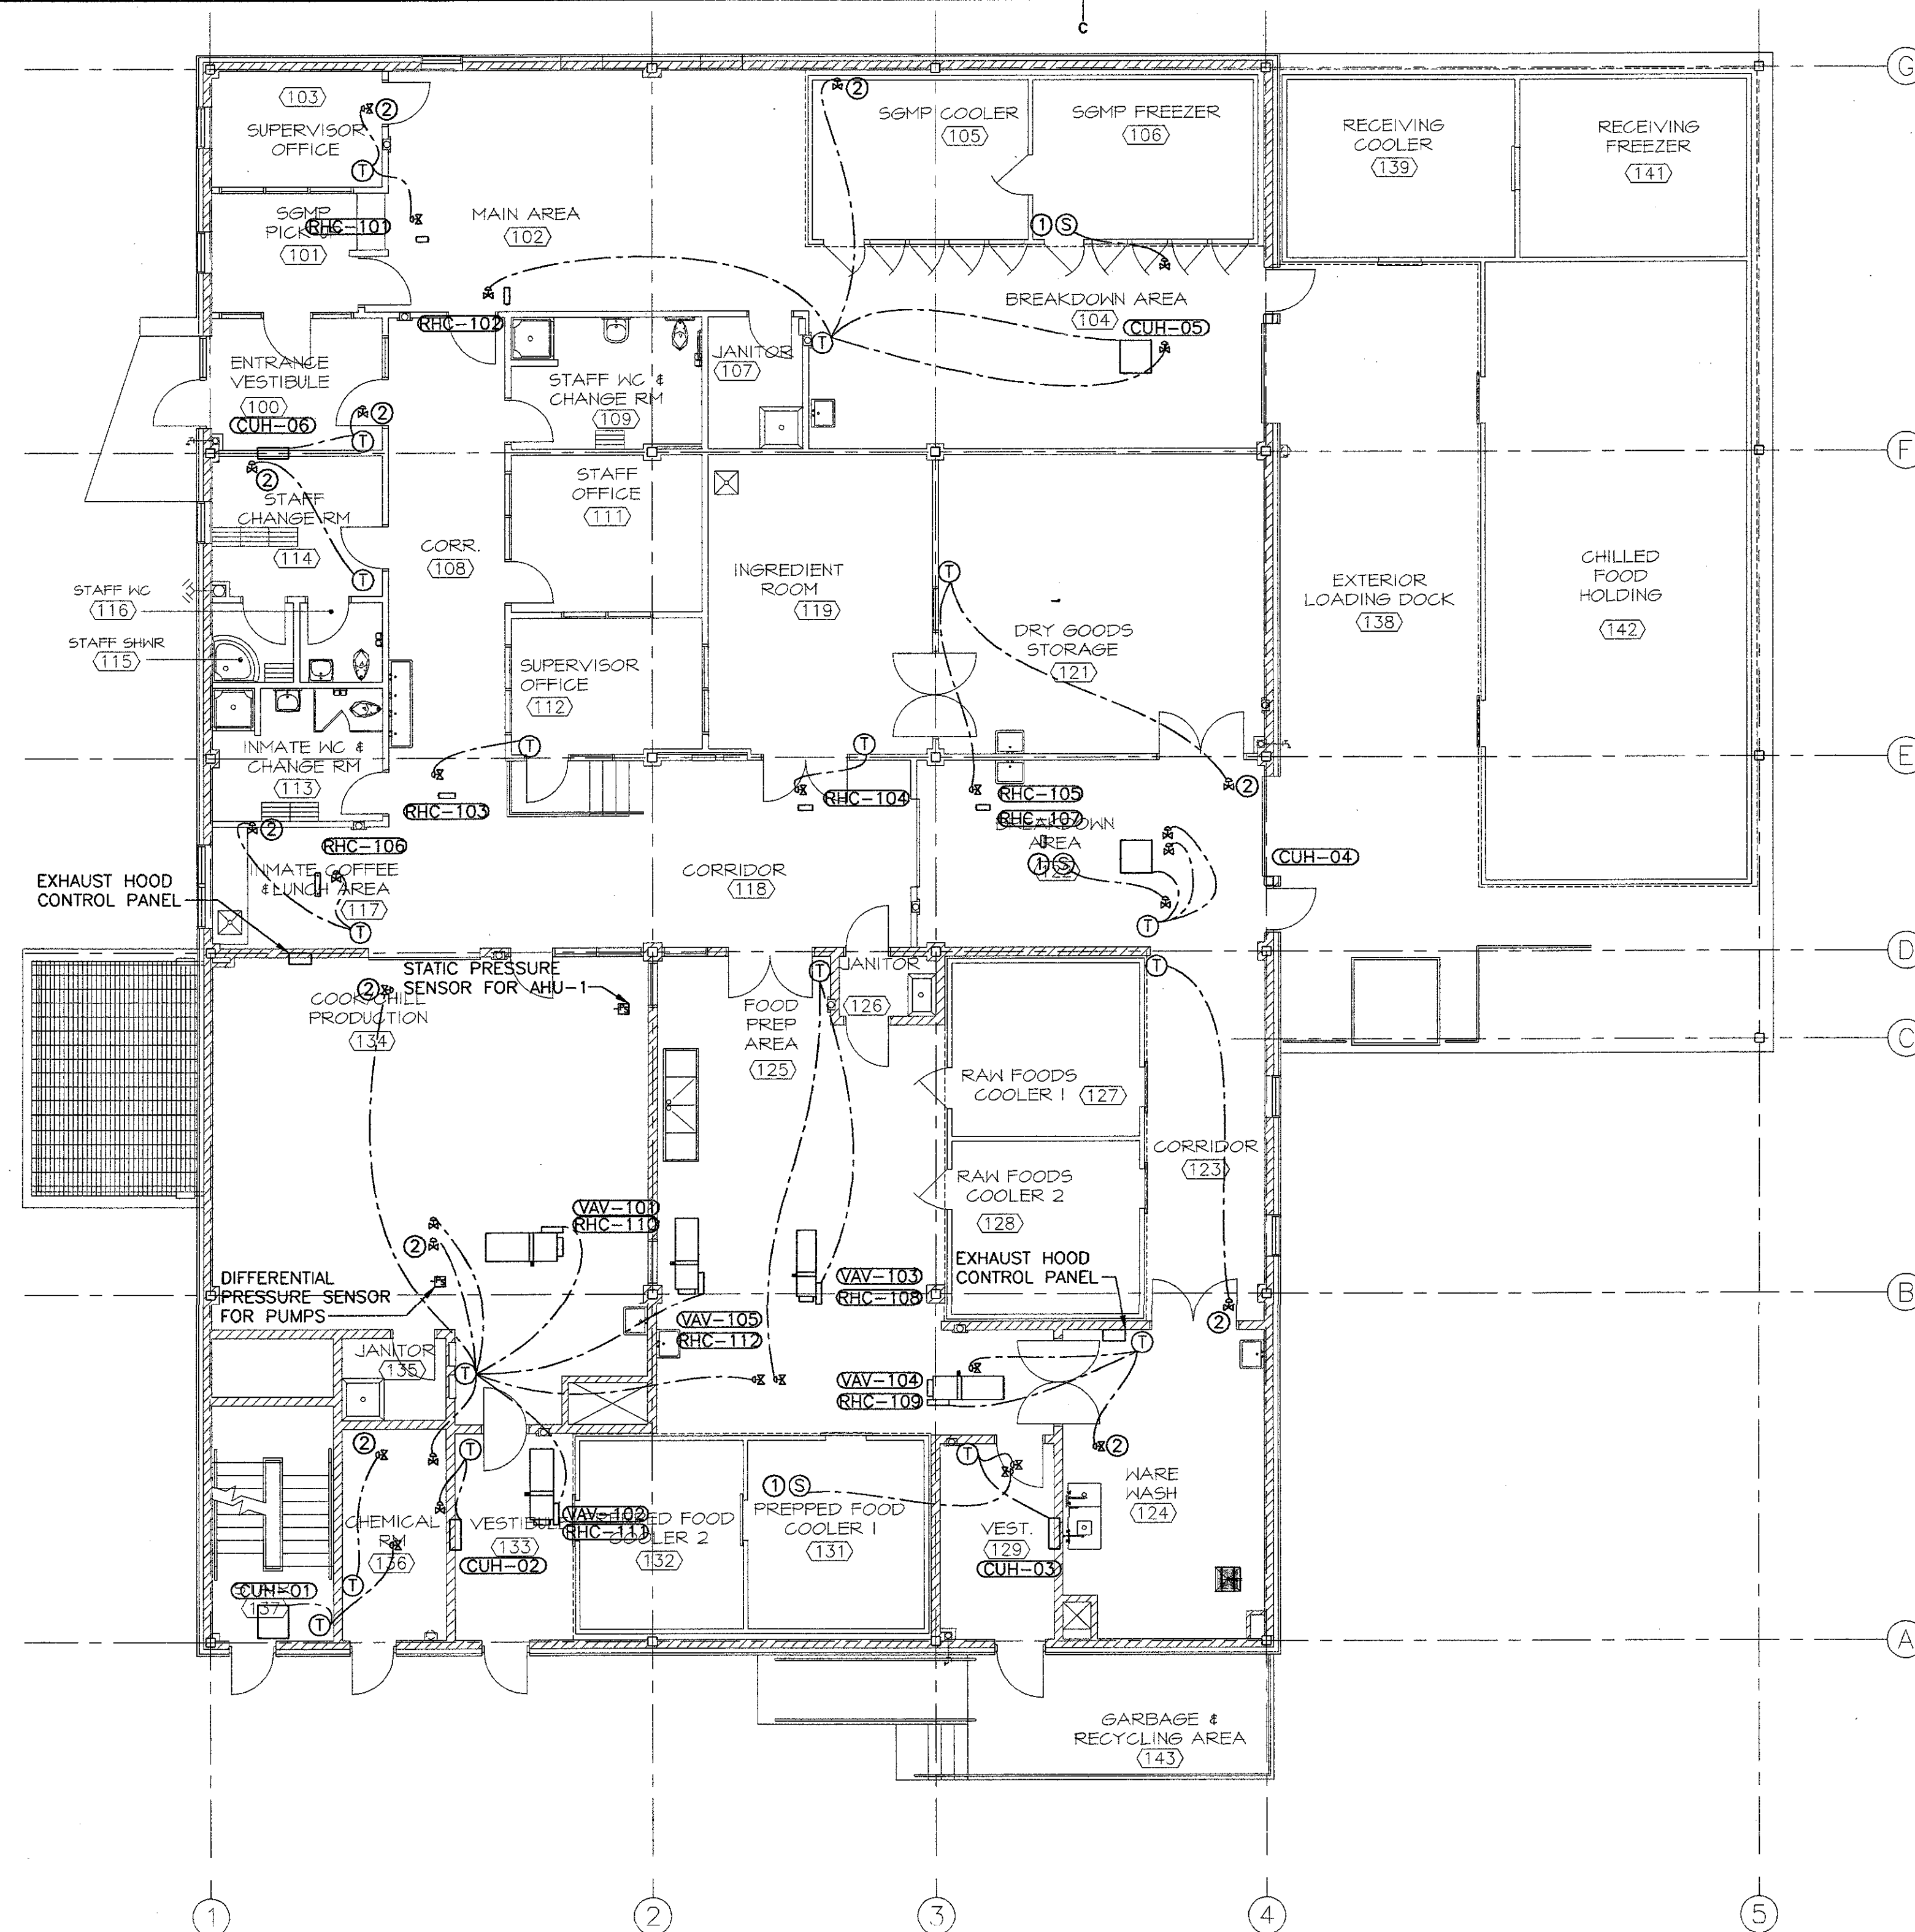


GROUND FLOOR PLAN

SCALE : 1:100

0m 1m 2m 3m 4m 5m 6m 7m 8m 9m 10m

1
M4.1

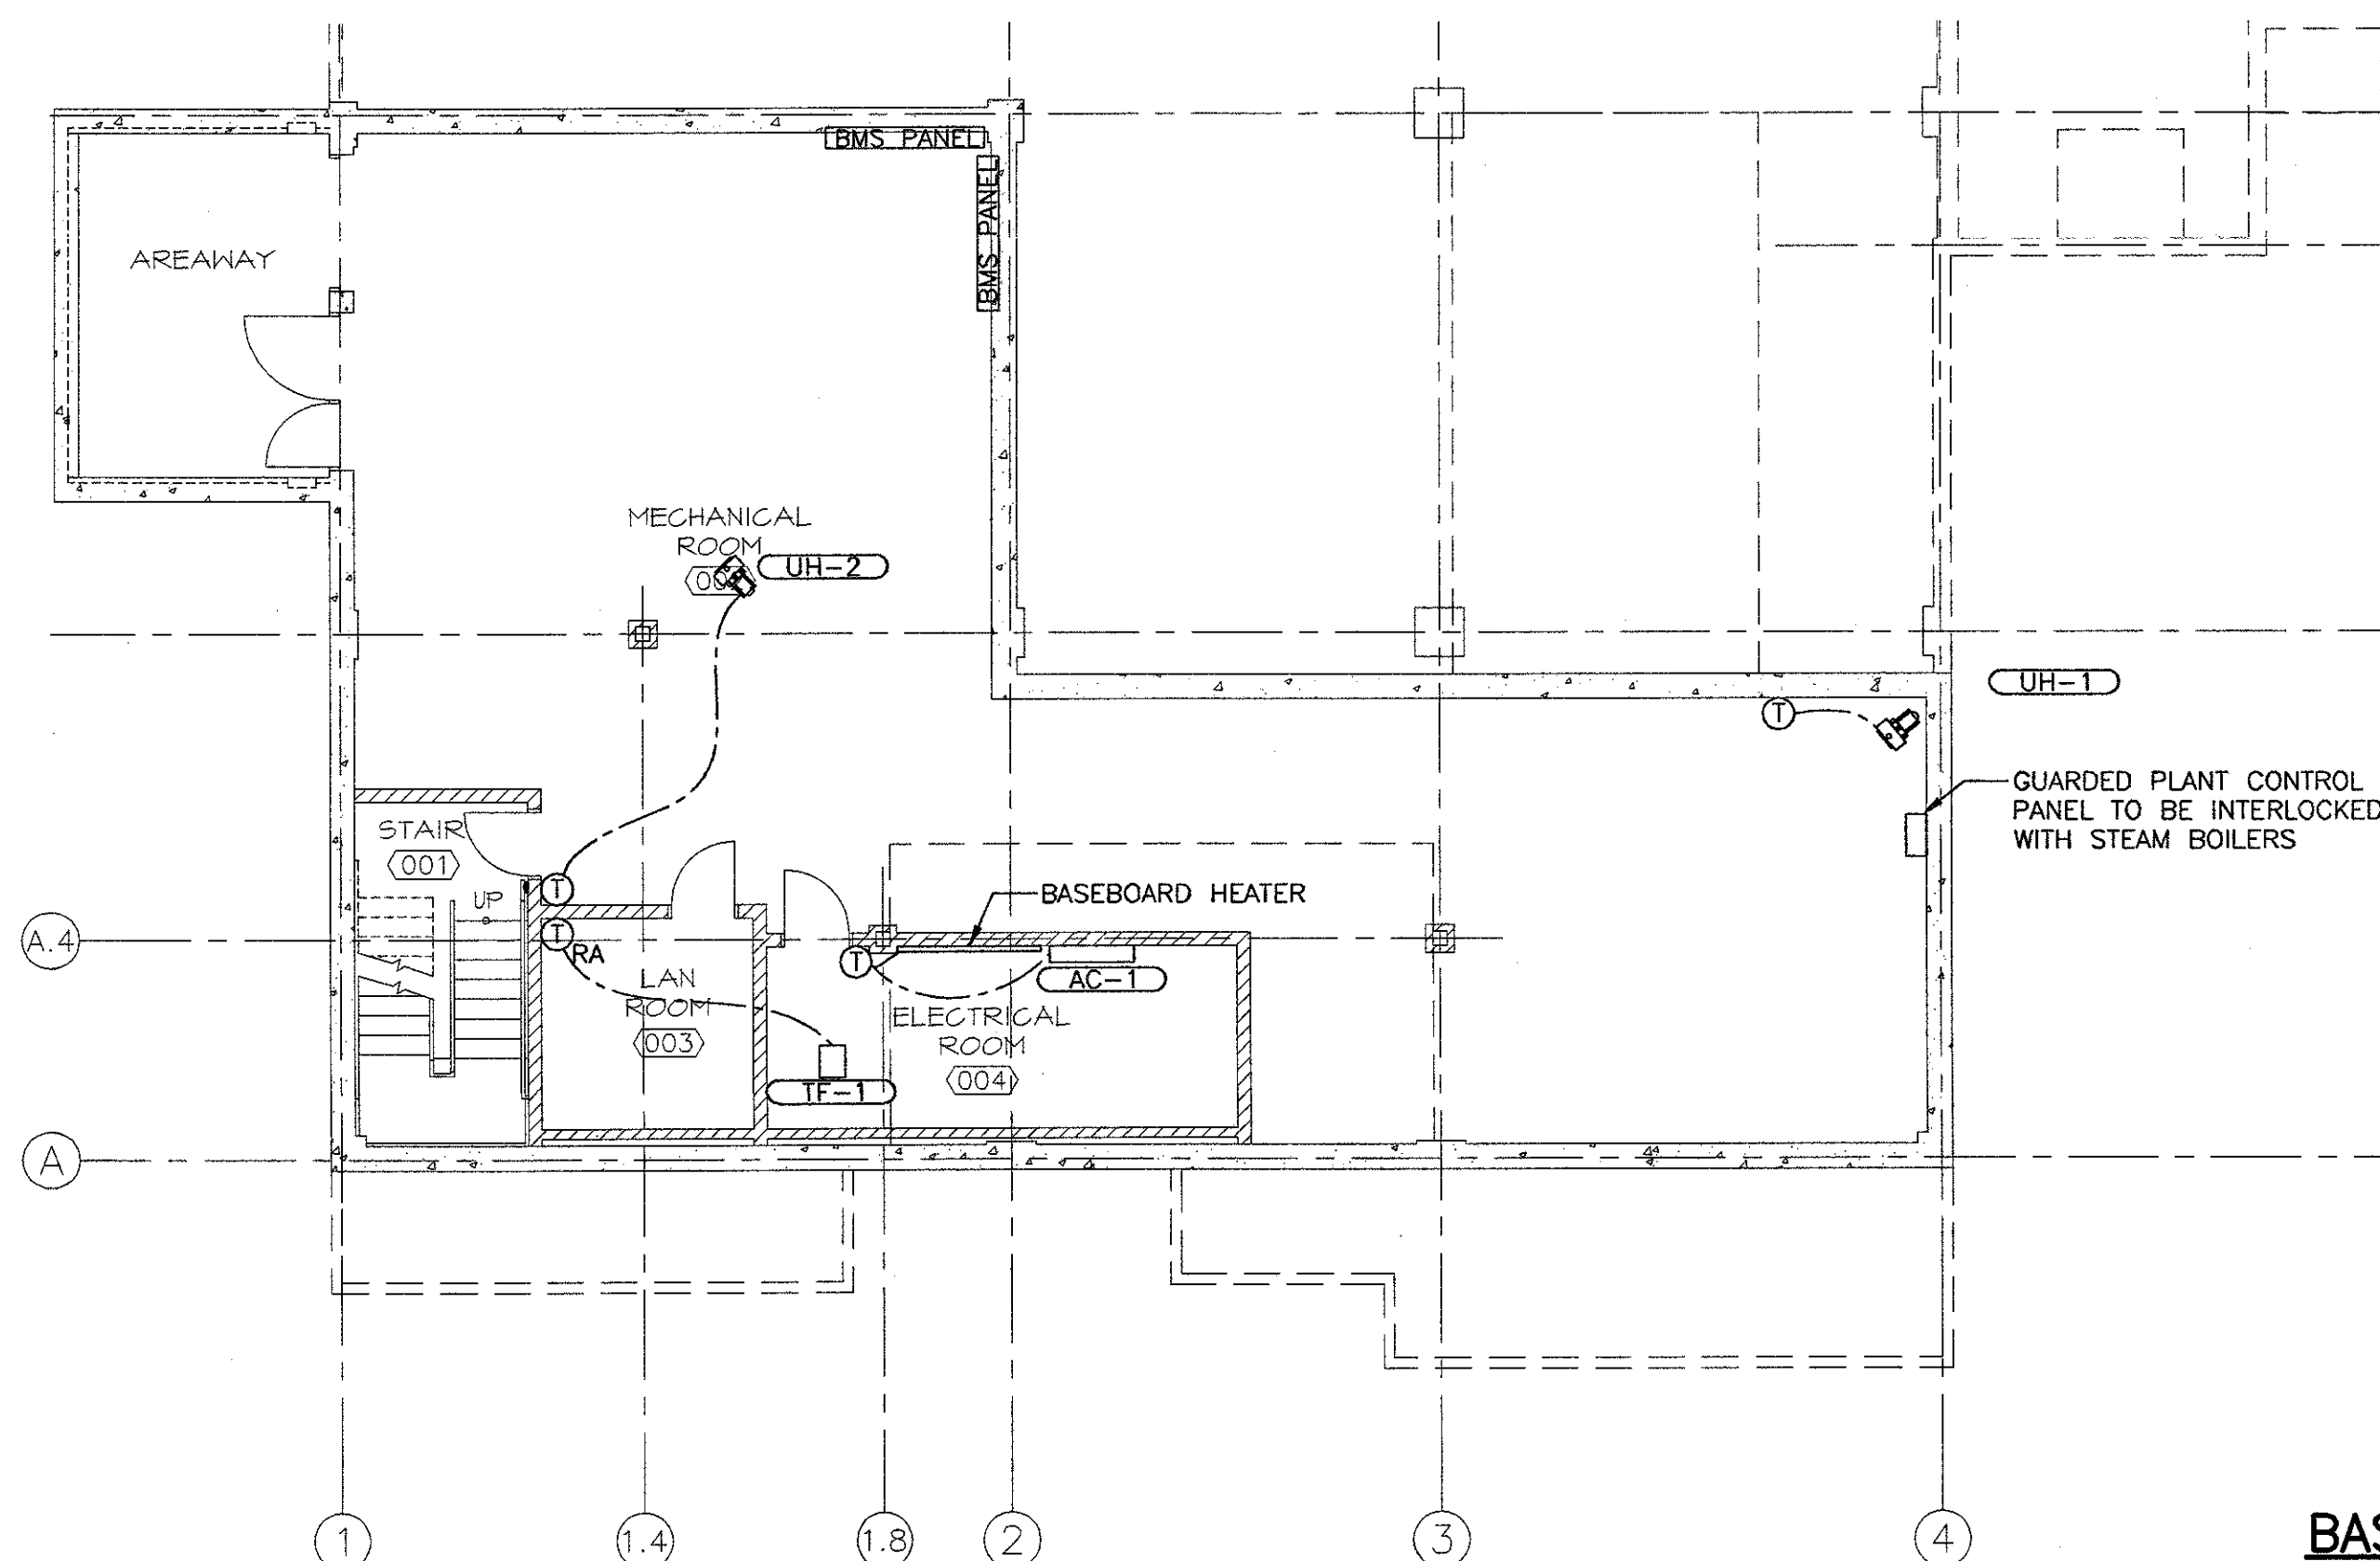

BASEMENT FLOOR PLAN

SCALE : 1:100

0m 1m 2m 3m 4m 5m 6m 7m 8m 9m 10m

1
M4.1

NOTES:

1. PERIMETER RADIANT PANELS TO RUN FROM WALL-TO-WALL AND CUT AT COLUMNS. INDICATED LENGTHS ARE ACTIVE LENGTHS.
2. GROUP BALANCING DAMPERS, VALVES AND OTHER ITEMS REQUIRING SERVICE NEAR ACCESS DOORS TO ALLOW ACCESS. KEEP DEVICES WITHIN 1000mm FROM TOP OF CEILING FOR ACCESS. TYPICAL.
3. REFER TO ELECTRICAL DRAWINGS FOR FIBRE TO F58.

KEYNOTES:

- ① TEMPERATURE SENSOR FOR BARE FIN RADIATION TO BE LOCATED IN CEILING.
- ② CONTROL VALVE FOR RADIANT PANEL.
- ③ EMERGENCY BOILER DISABLE PUSH BUTTON COMPLETE WITH LAMACOID LABEL. EMERGENCY BOILER SHUTDOWN.

0	ISSUED FOR TENDER	NOV. 29, 2013
revisions		date

project **NEW FOOD SERVICES BUILDING**
WESTMORLAND INSTITUTION

DORCHESTER, NB

drawing **MECHANICAL CONTROLS GROUND & BASEMENT FLOOR PLANS**

designed MCP	conqu
date Nov. 1, 2013	
drawn GGH	dessiné
date Nov. 1, 2013	
approved MCP	approuvé
date Nov. 29, 2013	

Tender **R.061828.001**
Project Manager **Matthew Peckham**
Signature **Matthew Peckham**
Date **November 29th, 2013**
Project number **R.061828.001**
no. du projet

drawing no. **M4.1**
no. du dessin

