

consultant



1867 YONGE ST, STE 1100, TORONTO ON CANADA M4S 1Y5
T 416 480 2020 F 416 480 1881

DRAWING NOTES:
1. ALL BUILDINGS, DIMENSIONS, ROADS, CURBS AND PROPERTY LINES ARE TAKEN WITH PERMISSION FROM THIS OWNER (ENVIRONMENT CANADA – BUILDING & TECHNICAL SERVICES – CANADA CENTRE FOR INLAND WATERS) FROM A SITE PLAN DRAWING PREPARED BY REID CROWTHER AND PARTNERS LTD. – DATED OCTOBER 1969.
2. ALL ACTUAL CHANGES TO THIS SITE FROM THE AFOREMENTIONED DRAWING ISSUE IN 1969 HAVE NOT BEEN INCORPORATED.
3. ALL EXISTING BUILDINGS AND NEW ADDITIONS TO PERMANENT AND TEMPORARY BUILDING STRUCTURES ARE TO BE VERIFIED ON SITE.

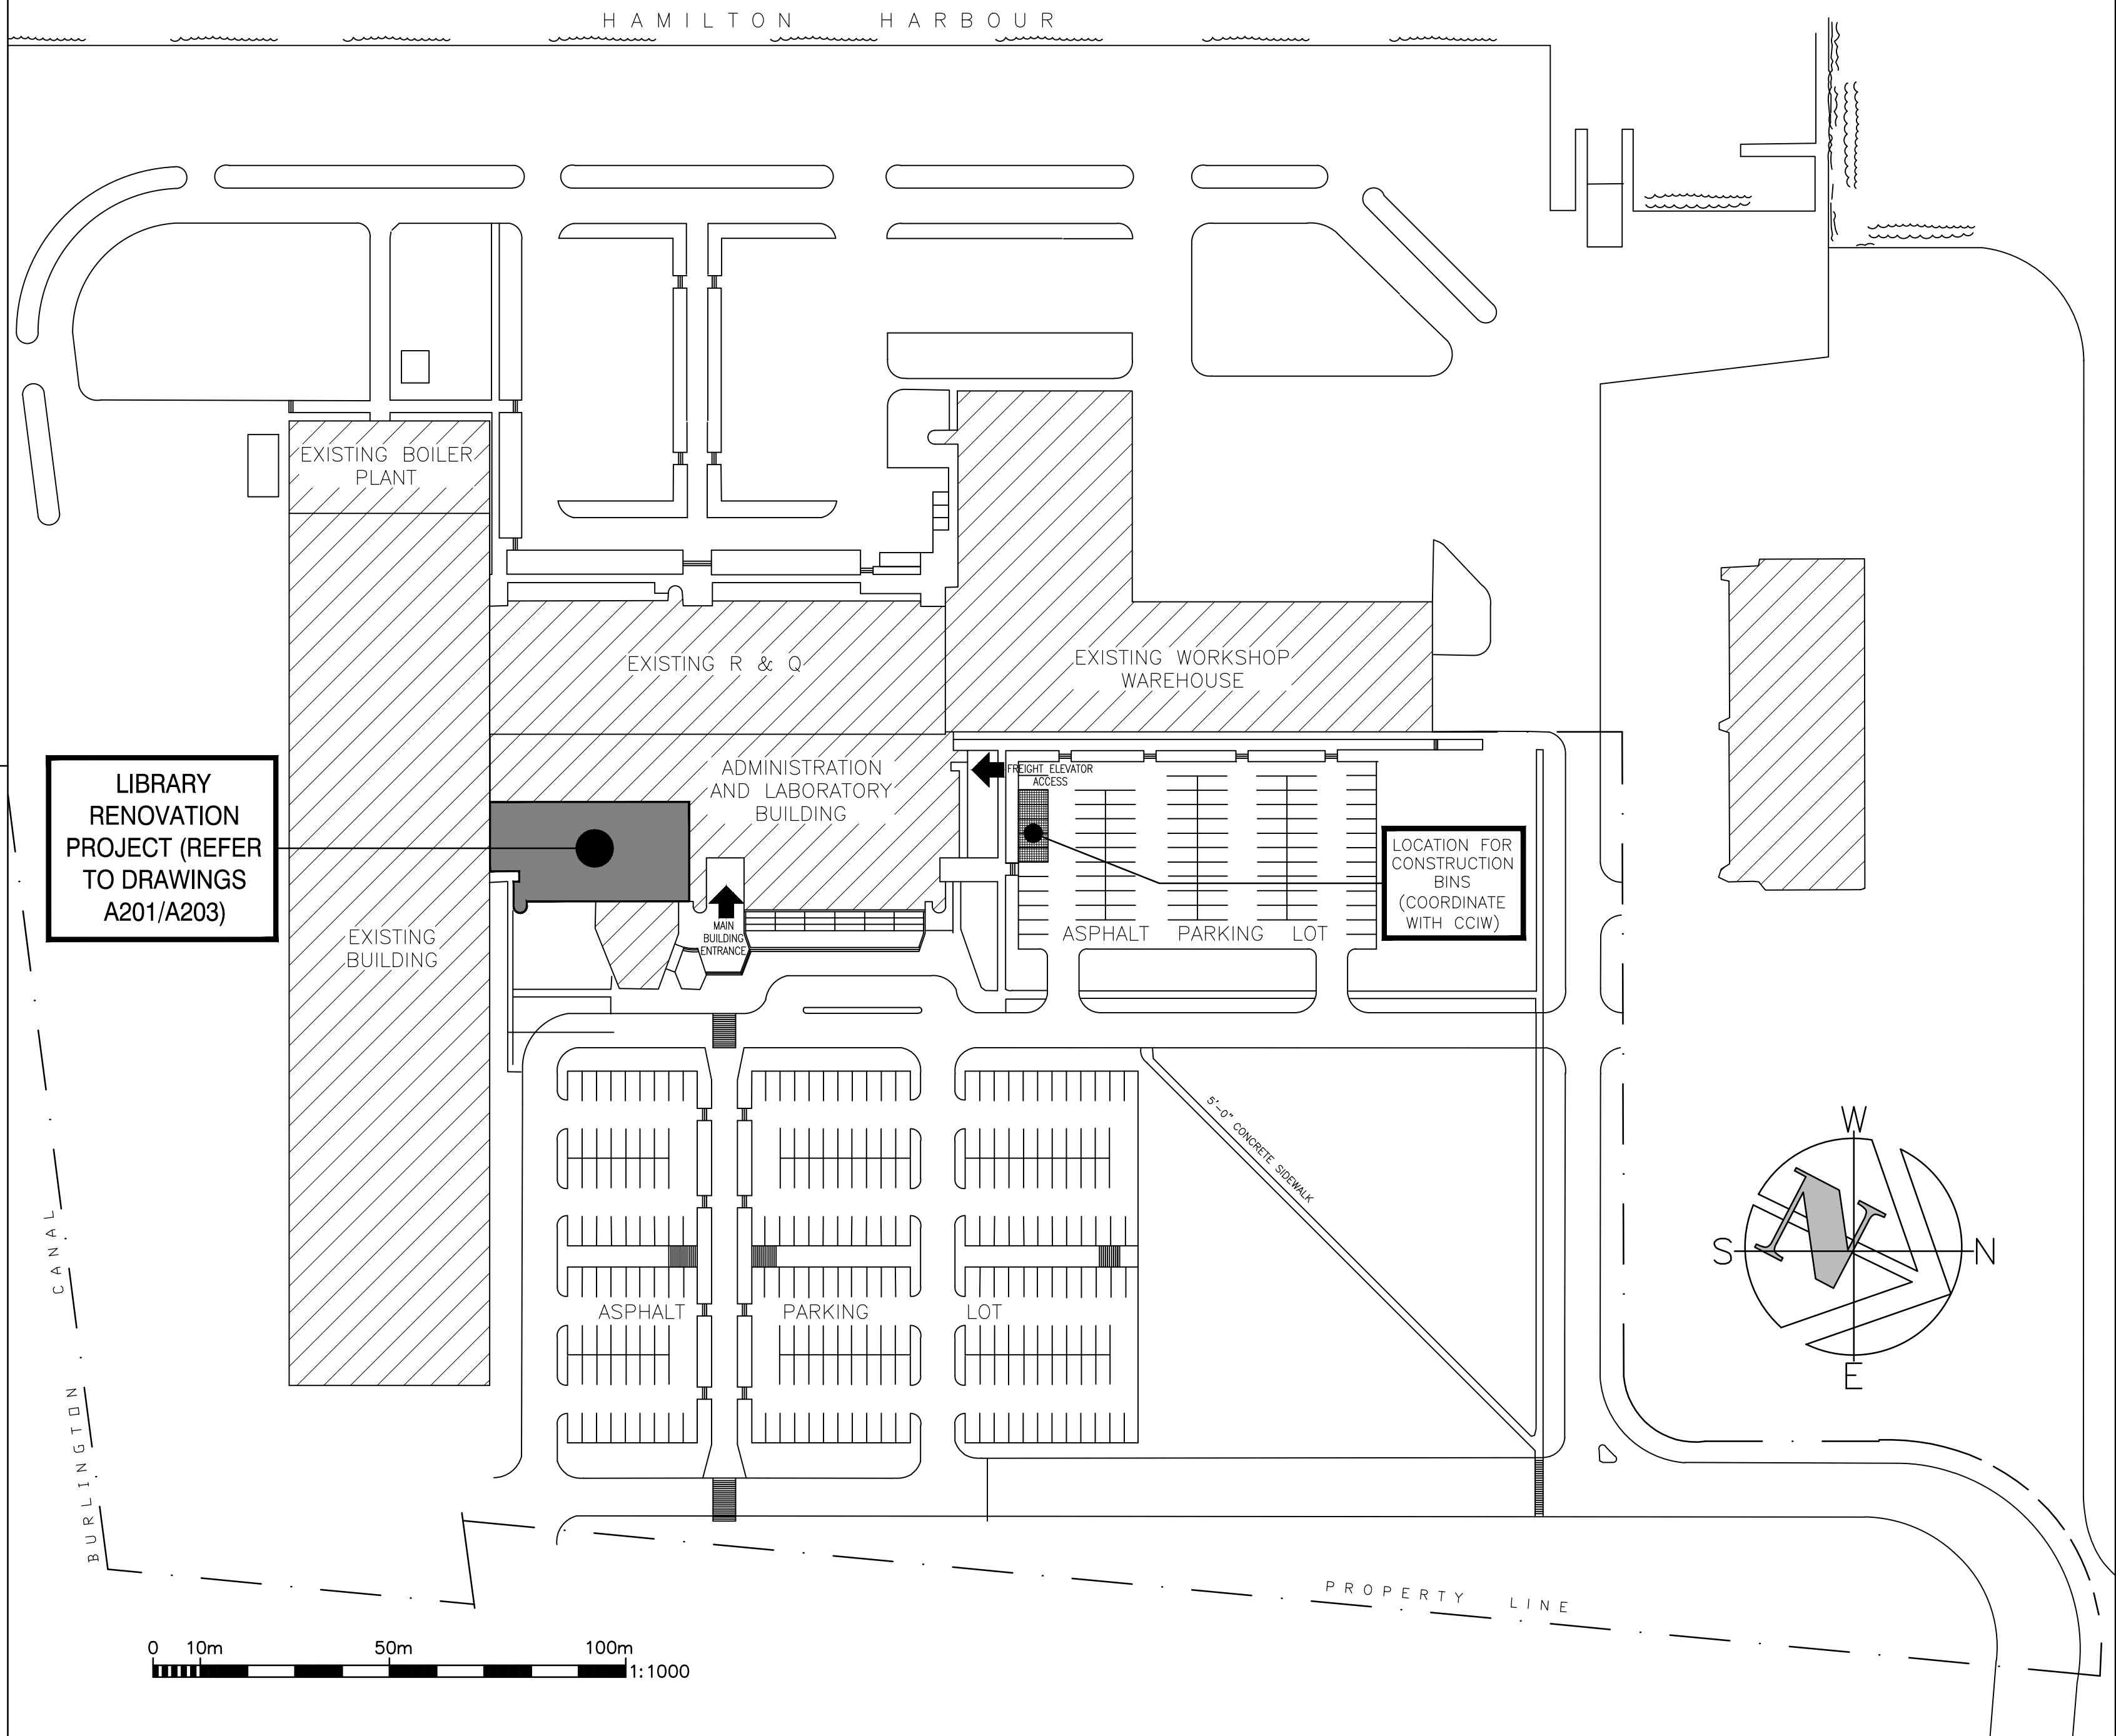

NAME OF PRACTICE:
REICH + PETCH ARCHITECTS INC.
1867 YONGE ST, SUITE 1100
TORONTO ONTARIO M4S 1Y5
T 416.480.2020 F 416.480.1881

NAME OF PROJECT:
CANADA CENTRE FOR INLAND WATERS (CCIW) – LIBRARY RENOVATION


LOCATION:
867 LAKESHORE ROAD, BURLINGTON ON, L7R 4A6

ITEM	NBC 2010 AND ONTARIO BUILDING CODE 2012 DATA MATRIX							OBC REFERENCE			
								REFERENCES ARE TO DIVISION 'B' UNLESS NOTED [A] FOR DIVISION 'A' OR [C] FOR DIVISION 'C'			
1	PROJECT DESCRIPTION	INTERIOR RENOVATIONS TO EXISTING LIBRARY OFFICE SPACES – MINOR LAYOUT CHANGES <input type="checkbox"/> CHANGE OF USE			<input type="checkbox"/> NEW <input type="checkbox"/> ADDITION <input checked="" type="checkbox"/> ALTERATION			<input checked="" type="checkbox"/> NBC PART 3	<input checked="" type="checkbox"/> OBC PART 3		
	YEAR OF EXISTING CONSTRUCTION: 1969								1.1.2. [A]	1.1.2. [A]	
2	MAJOR OCCUPANCY(S)	LIBRARY OFFICE SPACES – UNCHANGED						3.1.2.1.(1)		3.1.2.1.(1)	
3	BUILDING AREA (sq.m.)	EXISTING: UNCHANGED TOTAL AREA OF WORK COVER UNDER THIS PERMIT APPLICATION: 675 sq.m. (Ground Floor) + 1243 sq.m. (Second Floor) 1918 sq.m. TOTAL						1.4.1.2 [A]		1.4.1.2 [A]	
5	NUMBER OF STOREYS	ABOVE GRADE	INTERIOR RENO	BELOW GRADE	INTERIOR RENO		3.2.1.1.		1.4.1.2 [A] & 3.2.1.1.		
6	NUMBER OF STREETS/FIRE FIGHTER ACCESS	UNCHANGED						3.2.2.10. & 3.2.5.		3.2.2.10. & 3.2.5.	
7	BUILDING CLASSIFICATION	EXISTING – UNCHANGED (ONLY MINOR INTERIOR RENOVATIONS) REFER TO FLOOR PLANS						3.2.2.68		3.2.2.69	
8	SPRINKLER SYSTEM PROPOSED	<input type="checkbox"/> ENTIRE BUILDING <input checked="" type="checkbox"/> SELECTED COMPARTMENTS (REFER TO FLOOR PLANS) <input type="checkbox"/> SELECTED FLOOR AREAS <input type="checkbox"/> BASEMENT ONLY <input type="checkbox"/> IN LIEU OF ROOF RATING <input type="checkbox"/> NOT REQUIRED <input type="checkbox"/> NFPA 13 <input type="checkbox"/> NFPA 13R <input type="checkbox"/> NFPA 13D						3.2.2.68		3.2.2.69	
9	STANDPIPE REQUIRED	<input checked="" type="checkbox"/> YES <input type="checkbox"/> NO						3.2.5.8		3.2.9.	
10	FIRE ALARM REQUIRED	<input checked="" type="checkbox"/> YES <input type="checkbox"/> NO						3.2.4.		3.2.4.	
11	WATER SERVICE/SUPPLY IS ADEQUATE	<input checked="" type="checkbox"/> YES <input type="checkbox"/> NO								3.2.5.7.	
12	HIGH BUILDING	<input checked="" type="checkbox"/> YES <input type="checkbox"/> NO						3.2.6.		3.2.6.	
13	CONSTRUCTION RESTRICTIONS	<input checked="" type="checkbox"/> COMBUSTIBLE permitted <input type="checkbox"/> NON-COMBUSTIBLE required <input type="checkbox"/> BOTH						3.2.2.68		3.2.2.69	
	ACTUAL CONSTRUCTION	<input type="checkbox"/> COMBUSTIBLE <input type="checkbox"/> NON-COMBUSTIBLE <input checked="" type="checkbox"/> BOTH									
14	MEZZANINE(S) AREA (sq.m.)	N/A						3.2.1.1.(3)–(8)		3.2.1.1.(3)–(8)	
15	TOTAL OCCUPANCY LOAD	BASED ON PERSONS <input type="checkbox"/> sq.m./PERSON <input checked="" type="checkbox"/> DESIGN OF BUILDING BASEMENT: OCCUPANCY: LOAD: 1st FLOOR: OCCUPANCY: LOAD: 2nd FLOOR: OCCUPANCY: LOAD:						3.1.17.		3.1.17.	
16	BARRIER-FREE DESIGN	<input checked="" type="checkbox"/> YES <input type="checkbox"/> NO (EXPLAIN)						3.8.		3.8.	
17	HAZARDOUS SUBSTANCES	<input type="checkbox"/> YES <input checked="" type="checkbox"/> NO						3.3.1.2. & 3.3.1.19.		3.3.1.2. & 3.3.1.19.	
18	REQUIRED FIRE RESISTANCE RATING (FRR)	HORIZONTAL ASSEMBLIES FRR (HOURS)			LISTED DESIGN NO. OR DESCRIPTION (SG-2)			3.2.2.68	3.2.2.17 & 3.2.2.69		
FLOORS – MINUTES			OR NON-COMBUSTIBLE								
ROOF – HOURS											
MEZZANINE – MINUTES			OR NON-COMBUSTIBLE								
FRR OF SUPPORTING MEMBERS			LISTED DESIGN NO. OR DESCRIPTION (SG-2)								
19	SPATIAL SEPARATION – CONSTRUCTION OF EXTERIOR WALLS								3.2.3.		
	WALL	AREA OF EBF (sq.m.)	L.D. (m)	L.H. OR H/L	PERMITTED MAX. % OF OPENINGS	PROPOSED % OF OPENINGS	FRR (HOURS)	LISTED DESIGN OR DESCRIPTION	COMB. CONST.	COMB. CONSTR. NONC. CLADDING	NON COMB. CONSTR.
	NORTH										<input type="checkbox"/>
	SOUTH										<input type="checkbox"/>
	EAST										<input type="checkbox"/>
	WEST										<input type="checkbox"/>
21	OTHER (describe)										

3	ISSUED FOR BID	09 DEC 2013
2	ISSUED FOR 95% SUBMISSION	12 NOV 2013
1	ISSUED FOR 75% SUBMISSION	30 APR 2013

revision

Do not scale drawings.
Verify all dimensions and conditions on site and immediately notify the Departmental Representative of all discrepancies.

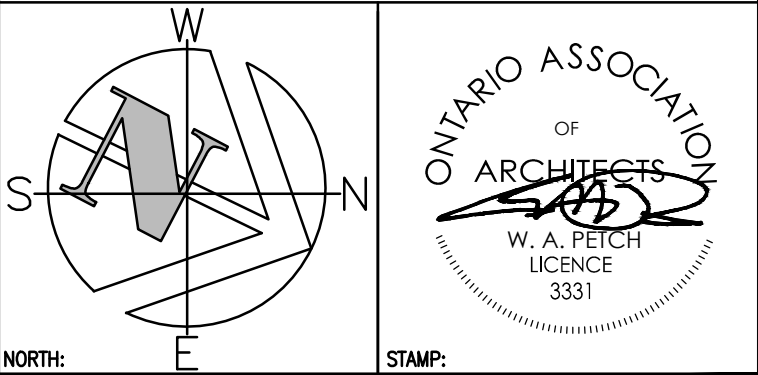

A	Detail No.
B	No. du détail
C	drawing no. – where detail required dessin no. – où détail exigé
	drawing no. – where detailed dessin no. – où détaillé

project title
titre du projet
BURLINGTON **ONTARIO**
CANADA CENTRE FOR INLAND WATERS
867 LAKESHORE ROAD

LIBRARY RENOVATION

drawing title
titre du dessin
KEY PLAN AND BUILDING CODE MATRIX

drawn by
dessiné par **R+P A**

designed by
conc par **R+P A**

approved by
approuvé par **CCIW/EC/PWGSC**

bid
offre


project manager
administrateur de projets

project date
date du projet **2013–02–20**

project no.
no. du projet **R.061475.001**

drawing no.
dessiné no. **A002**

SCREEN SCHEDULE / ELEVATIONS

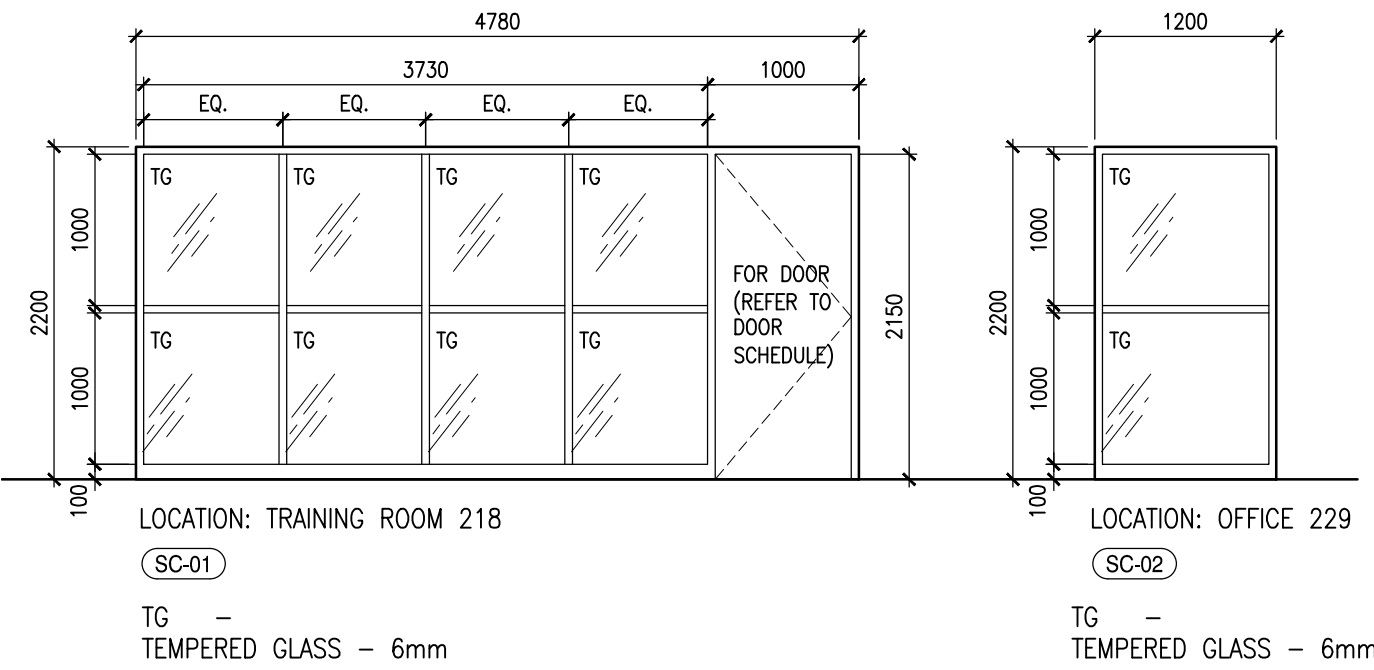

- NOTES:
1. DOOR FRAME AND GLAZING FRAME SYSTEM BY DEMOUNTABLE PARTITION SUPPLIER
 2. PROVIDED CONTINUOUS WALL ASSEMBLY (SEE FLOOR PLANS) ABOVE SCREEN TO U/S OF STRUCTURE (CONCRETE SLAB)
 3. SEE ALSO SPECIFICATIONS FOR ADDITIONAL FRAMING INFORMATION

ROOM FINISH SCHEDULE / ABBREVIATION LEGEND

ROOM FINISH SCHEDULE

NUMBER	ROOMNAME	FLOOR	BASE	NORTH WALL MATERIAL	FINISH	EAST WALL MATERIAL	FINISH	SOUTH WALL MATERIAL	FINISH	WEST WALL MATERIAL	FINISH	CEILING MATERIAL	FINISH	HEIGHT	REMARKS	FIRE RATING	STC RATING	NC RATING
210	ENTRANCE		RSF-1	RB-1	GL	-	EXIST	PT-1	-	-	EXIST	PT-1	ACT	-	SEE RCP	-	-	-
211	DISPLAY ROOM		CPTT-1	RB-2	EXIST	PT-1	-	-	-	GBD	PT-2	ACT	-	SEE RCP	-	-	-	
212	RECEPTION		CPTT-1	RB-2	-	-	-	EXIST	PT-1	GBD	PT-2	ACT	-	SEE RCP	-	-	-	
213	ARCHIVE/RECORD STORAGE		EXIST	RB-2	EXIST	EXIST	GBD	PT-1	GBD	PT-1	EXIST	EXIST	ACT	-	SEE RCP	ROOM TO HAVE 2HR FIRE SEPARATION	2 HRS	-
214A	CABINET STORAGE # 1		RSF-1	RB-1	-	-	-	-	EXIST	PT-1	GL	FILM	EXIST/ACT	BLACK PT	SEE RCP	EXISTING GLAZED SCREEN TO RECEIVE FROSTED FILM	-	-
214B	CABINET STORAGE # 1		RSF-1	RB-1	-	-	-	-	-	-	GL	FILM	EXIST/ACT	BLACK PT	SEE RCP	EXISTING GLAZED SCREEN TO RECEIVE FROSTED FILM	-	-
214C	CABINET STORAGE # 1		RSF-1	RB-1	-	-	-	-	-	-	GL	FILM	EXIST/ACT	BLACK PT	SEE RCP	EXISTING GLAZED SCREEN TO RECEIVE FROSTED FILM	-	-
214D	CABINET STORAGE # 1		RSF-1	RB-1	EXIST/GBD	PT-1	-	-	-	-	GL	FILM	EXIST/ACT	BLACK PT	SEE RCP	EXISTING GLAZED SCREEN TO RECEIVE FROSTED FILM	-	-
215	CORRIDOR/AISLE		RSF-1	RB-1	-	-	-	-	-	-	-	-	ACT	-	SEE RCP	-	-	-
216A	CABINET STORAGE # 2		RSF-1	RB-1	-	-	-	-	EXIST	PT-1	-	-	EXIST/ACT	BLACK PT	SEE RCP	-	-	-
216B	CABINET STORAGE # 2		RSF-1	RB-1	-	-	-	-	-	-	-	-	EXIST/ACT	BLACK PT	SEE RCP	-	-	-
217A	MEETING AREA # 1		RSF-1	RB-1	-	-	EXIST	PT-2	EXIST	PT-1	-	-	EXIST/ACT	-	SEE RCP	NEW ACT TILE WHERE LIGHT FIXTURES WERE REMOVED	-	-
217B	COMPUTER STATIONS		RSF-1	RB-1	-	-	EXIST	PT-2	-	-	-	-	EXIST/ACT	-	SEE RCP	NEW ACT TILE WHERE LIGHT FIXTURES WERE REMOVED	-	-
217C	MEETING AREA # 2		RSF-1	RB-1	EXIST	PT-1	-	-	-	-	-	-	EXIST/ACT	-	SEE RCP	NEW ACT TILE WHERE LIGHT FIXTURES WERE REMOVED	-	-
218	TRAINING ROOM		CPTT-1	RB-2	EXIST/VFGB	PT-1	EXIST	PT-2	VFGB	PT-1	GL/VFGB	PT-1	ACT	-	SEE RCP	P2 ABOVE GLAZING SCREEN TYP.	-	45 (MIN.)
219	PROJECTION ROOM		EXIST	EXIST	EXIST	-	EXIST	-	EXIST	-	EXIST	-	EXIST	-	SEE RCP	-	-	-
219A	IT ROOM		RSF-1	RB-1	EXIST	-	EXIST	-	EXIST	-	EXIST	-	EXIST	-	SEE RCP	-	-	-
220	STORAGE ROOM		EXIST	EXIST	EXIST	-	EXIST	-	EXIST	-	EXIST	-	EXIST	-	SEE RCP	-	-	-
221	OFFICE		CPTT-1	RB-2	EXIST	PT-1	EXIST	PT-2	EXIST	PT-1	EXIST	PT-1	ACT	-	SEE RCP	-	-	-
222	OFFICE		CPTT-1	RB-2	EXIST	PT-1	EXIST	PT-2	EXIST	PT-1	EXIST	PT-1	ACT	-	SEE RCP	-	-	-
223	OFFICE		CPTT-1	RB-2	EXIST	PT-1	EXIST	PT-2	EXIST	PT-1	EXIST/VFGB	PT-1	ACT	-	SEE RCP	-	-	-
224	WORKSTATION 1		RSF-1	RB-1	-	-	-	-	-	-	-	-	ACT	-	SEE RCP	-	-	-
225	WORKSTATION 1		RSF-1	RB-1	-	-	-	-	-	-	-	-	ACT	-	SEE RCP	-	-	-
226	WORK AREA		RSF-1	RB-1	EXIST/VFGB	PT-1	EXIST	PT-1	EXIST	PT-1	EXIST	PT-1	ACT	-	SEE RCP	-	-	-
227	KITCHEN		RSF-1	RB-1	EXIST	PT-1	EXIST/VFGB	PT-1	VFGB	PT-1	EXIST	PT-1	ACT	-	SEE RCP	-	-	-
228	OFFICE		CPTT-1	RB-2	EXIST	PT-1	EXIST	PT-1	EXIST	PT-1	EXIST	PT-2	ACT	-	SEE RCP	-	-	-
229	OFFICE		CPTT-1	RB-2	EXIST	PT-2	EXIST	PT-1	EXIST	PT-1	EXIST/GBD	PT-1	ACT	-	SEE RCP	-	-	-
230	MEETING ROOM		EXIST	EXIST	EXIST	EXIST	EXIST	EXIST	EXIST	EXIST	EXIST	ACT/SKYLIGHT	-	SEE RCP	NEW ACT CEILING - FLUSH WITH EXIST. CONC. BEAM	-	-	-
231	VESTIBULE		EXIST	EXIST	EXIST	EXIST	EXIST	EXIST	EXIST	EXIST/VFGB	UNFINISH	ACT	-	SEE RCP	-	-	-	
232	MEETING ROOM		EXIST	EXIST	EXIST	EXIST	EXIST	EXIST	EXIST	EXIST	EXIST	ACT/SKYLIGHT	-	SEE RCP	-	-	-	

ROOM FINISH SCHEDULE - ABBREVIATION LEGEND

ACT	ACOUSTIC CEILING TILE	GBD	GYPSUM BOARD	RSF	RESILIENT SHEET FLOORING
CONC	CONCRETE	GL	GLAZING	VFGB	CONV. FACED GYPSUM BOARD
CPTT	CONCRETE TILE	PT	PAIN	WD	WOOD
EXIST	EXISTING	RB	RUBBER/RESILIENT BASE		

NOTE:
ROOM FINISH SCHEDULE TO BE READ IN CONJUNCTION TO ARCHITECTURAL SPECIFICATION BOOK.

SYMBOLS LEGEND:

ROOM NAME	ROOM NAME & NUMBER
300	
A 2000A300	DETAIL REFERENCE TAG
A 2000A300	WALL SECTION/ SECTION DETAILS REFERENCE TAG
A 2000A400	ELEVATION REFERENCE TAG
CPTT 1	FINISHES REFERENCE TAG
A	GRID TAG
136	DOOR TAG (REFER TO DOOR SCHEDULE)
SC-01	SCREEN TAG (REFER TO SCREEN SCHEDULE)
1 1	NOTE TAGS
P1	INTERIOR PARTITION ASSEMBLY (REFER TO THIS DRAWING)
C1	CEILING ASSEMBLY (REFER TO THIS DRAWING)
C1 2450	CEILING TAG (R.C.P.) - REFER TO ASSEMBLY - CEILING HEIGHT A.F.F. (REFER TO REFLECTED CEILING PLANS)
EXISTING 2450 TO REMAIN	CEILING TAG 2 (R.C.P.) - EXISTING ASSEMBLY - CEILING HEIGHT A.F.F. ASSEMBLY TO REMAIN (REFER TO REFLECTED CEILING PLANS)
+ -350	SPOT ELEVATION REFERENCE TAG

DOOR SCHEDULE

DOOR NO.	DOOR ROOM NAME	SIZE	TYPE	MATERIAL	FINISH	GLASS TYPE	FIRE RATING MINUTES	FRAME TYPE	MATERIAL	FINISH	JAMB DETAIL	HARDWARE	COMMENTS
210	ENTRANCE	DOUBLE DOORS	EXIST	EXIST	PT-3	EXIST	-	EXIST	EXIST	PT-4	EXIST	EXISTING	SUPPLY AND INSTALL DOOR OPERATOR
213	ARCHIVE/RECORD STORAGE	910x2150x45	A	HM	PT-3	FRG	90 MINUTES	1	HM	PT-4	2	EXISTING	90 MINUTES FIRE RATED HOLLOW METAL DOOR
213A	ARCHIVE/RECORD STORAGE	910x2150x45	A	HM	PT-3	FRG	90 MINUTES	EXIST HM	EXIST HM	PT-4	EXIST HM	EXISTING	NEW 90 MINUTES FIRE RATED HOLLOW METAL DOOR ON EXISTING HOLLOW METAL FRAME
217A	MEETING AREA #1	SINGLE DOOR	EXIST	EXIST	PT-3	EXIST	-	EXIST	EXIST	PT-4	EXIST	EXISTING	EXISTING EXIST DOOR - ALL HARDWARE TO REMAIN AS IS
218	TRAINING ROOM	910x2150x45	A	WD	PT-3	TG	-	1	AL	PT-4	1	A,D,U,W	LOCK-SET COMPATIBLE WITH EXISTING BUILDING STANDARD - DOOR FRAME BY DEMOUNTABLE PARTITION SUPPLIER
219A	IT ROOM	910x2150x45	SOLID	WD	PT-3	-	-	1	AL	PT-4	1	A,D,S,U,W	NO GLAZING ON DOOR
219	PROJECTION ROOM	SINGLE DOOR	EXIST	EXIST	PT-3	EXIST	-	EXIST	EXIST	PT-4	EXIST	EXISTING	-
221	OFFICE	SINGLE DOOR	EXIST	EXIST	PT-3	EXIST	-	EXIST	EXIST	PT-4	EXIST	EXISTING	-
222	OFFICE	SINGLE DOOR	EXIST	EXIST	PT-3	EXIST	-	EXIST	EXIST	PT-4	EXIST	EXISTING	-
223	OFFICE	910x2150x45	A	WD	PT-3	TG	-	1	AL	PT-4	1	A,D,U,W	LOCK-SET COMPATIBLE WITH EXISTING BUILDING STANDARD - DOOR FRAME BY DEMOUNTABLE PARTITION SUPPLIER
227	KITCHEN	SINGLE DOOR	EXIST	EXIST	PT-3	EXIST	-	EXIST	EXIST	PT-4	EXIST	EXISTING	-
228	OFFICE	SINGLE DOOR	EXIST	EXIST	PT-3	EXIST	-	EXIST	EXIST	PT-4	EXIST	EXISTING	-
229	OFFICE	SINGLE DOOR	EXIST	EXIST	PT-3	EXIST	-	EXIST	EXIST	PT-4	EXIST	EXISTING	-
230	MEETING ROOM	SINGLE DOOR	EXIST	EXIST	PT-3	EXIST	-	EXIST	EXIST	PT-4	EXIST	EXISTING	-
231	VESTIBULE	SINGLE DOOR	EXIST	EXIST	PT-3	EXIST	-	EXIST	EXIST	PT-4	EXIST	EXISTING	-
231A	VESTIBULE	SINGLE DOOR	EXIST	EXIST	PT-3	EXIST	-	EXIST	EXIST	PT-4	EXIST	EXISTING	-
231B	VESTIBULE	SINGLE DOOR	EXIST	EXIST	PT-3	EXIST	-	EXIST	EXIST	PT-4	EXIST	EXISTING	-
231C	SPRINKLER ZONE VALVES	910x2150x45	SOLID	WD	PT-3	-	-	1	AL	PT-4	1	A,D,S,U,W	NO GLAZING ON DOOR
232	MEETING ROOM	910x2150x45	A	WD	PT-3	TG	-	2	AL	PT-4	1	A,D,E,U,W	LOCK-SET COMPATIBLE WITH EXISTING BUILDING STANDARD - DOOR FRAME BY DEMOUNTABLE PARTITION SUPPLIER
232A	MEETING ROOM	910x2150x45	A	WD	PT-3	TG	-	2	AL	PT-4	1	A,D,E,U,W	LOCK-SET COMPATIBLE WITH EXISTING BUILDING STANDARD - DOOR FRAME BY DEMOUNTABLE PARTITION SUPPLIER

NOTE: PAINT FINISH FOR ALL DOORS TO BE (PT-3) AND DOOR/GLASS FRAMES TO BE (PT-4) TYPICAL.

100	SPRINKLER ZONE VALVES	2-910x2150x45	SOLID	HM	PT-3	-	-	2	HM	PT-4	2 (SIM)	A,D,N,S,U	LOCK-SET COMPATIBLE WITH EXISTING BUILDING STANDARD
-----	-----------------------	---------------	-------	----	------	---	---	---	----	------	---------	-----------	---

NEW HOLLOW DOORS - GROUND FLOOR (ACCESS FOR SPRINKLER ZONE VALVES)

DOOR SCHEDULE ABBREVIATION, HARDWARE DESIGNATION AND ELEVATIONS/DETAILS




HARDWARE DESIGNATION

A	THREE (3) HINGES PER LEAF	P	DOOR CONTROL UNITS
B	FOUR (4) HINGES PER LEAF	Q	SWEEP
C	PIVOTS	R	PUSH AND PULL PLATES
D	LOCK SET	S	KICK PLATE
E	PANIC SET	T	THRESHOLD
F	MORTISED PRIVACY SET	U	CLOSER
G	PASSAGE SET	V	CARD READER
H	MORTISED LOCK SET	W	DOOR STOP
J	SLIDING DOOR SET	X	HOLD OPEN
K	SLIDING POCKET DOOR SET	Y	KEY SWITCH
L	DEAD BOLT LOCK	Z	POWER DOOR OPERATOR
M	ELECTRIC STRIKE	DC	DOOR CONTACT
N	FLUSH BOLTS	MD	MOTION DETECTOR
O	WEATHERSTRIPPING		


ABBREVIATIONS

WD	WOOD
HM	HOLLOW METAL
AL	ALUMINUM
PT	PAINT
FRD	FIRE RATED GLASS
ME	MATCH EXISTING
TG	TEMPERED GLASS
EXIST.	EXISTING

ELEVATIONS/DETAILS

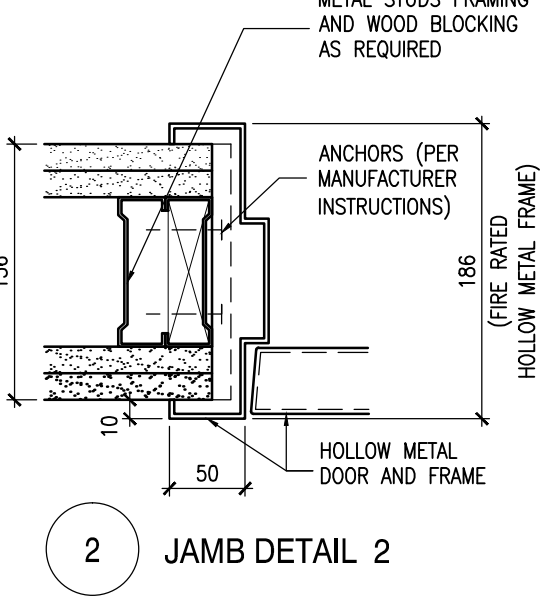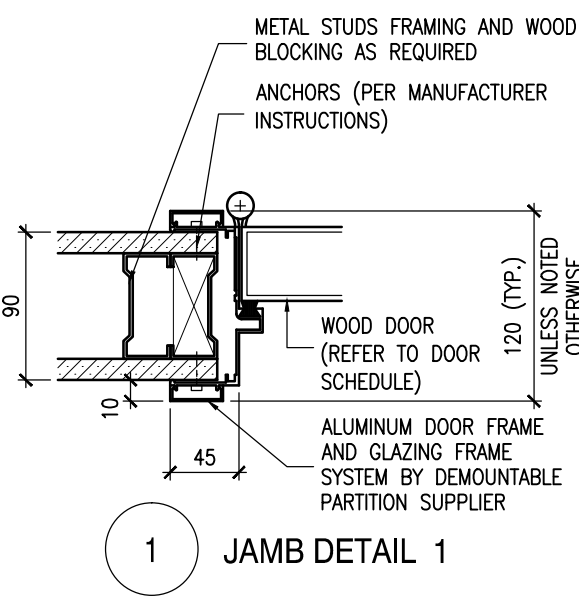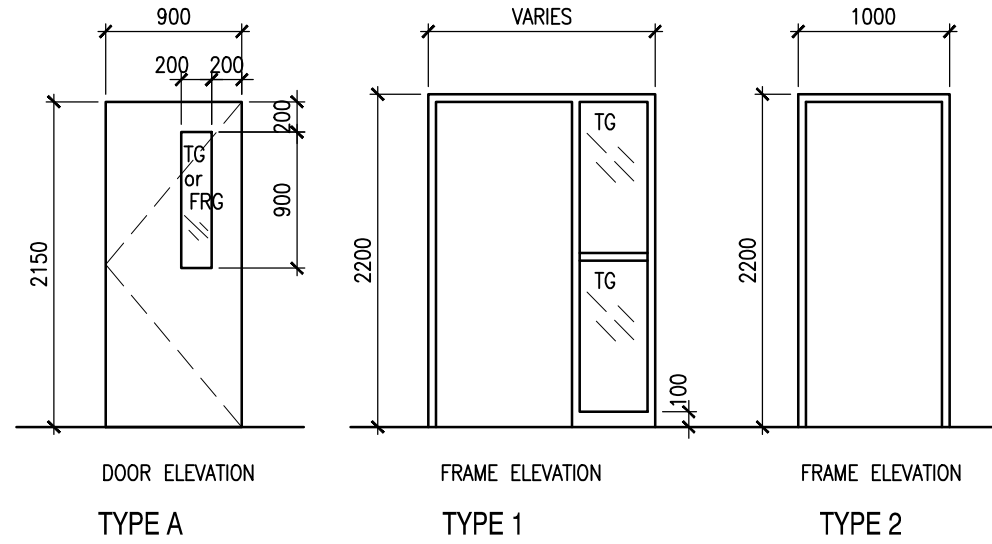

consultant

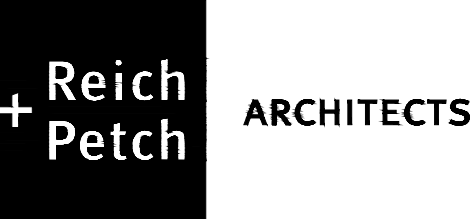

1867 YONGE ST, STE 1100, TORONTO ON CANADA M4S 1Y5
T 416 480 2020 F 416 480 1881

3	ISSUED FOR BID	09 DEC 2013
2	ISSUED FOR 95% SUBMISSION	12 NOV 2013
1	ISSUED FOR 75% SUBMISSION	30 APR 2013

revision		date
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Do not scale drawings.
Verify all dimensions and conditions on site and immediately notify the Departmental Representative of all discrepancies.



NORTH: STAMP:

A	Detail No.
B	drawing no. - where detail required
C	drawing no. - where detailed

project title
titre du projet
BURLINGTON ONTARIO
CANADA CENTRE FOR INLAND WATERS
867 LAKESHORE ROAD

LIBRARY RENOVATION

drawing title
titre du dessin
**SYMBOLS LEGEND,
ROOM FINISH SCHEDULE, DOOR
SCHEDULE AND DOOR/
SCREEN ELEVATIONS/DETAILS**

drawn by
dessine par **R+P A**

designed by
conc par **R+P A**

approved by
approuve par **CCW/EC/PWGSC**

bid
offre

project date
date du projet **2013-02-20**


project no.
no. du projet **R.061475.001**


drawing no.
dessine no. **A003**

3	ISSUED FOR BID	09 DEC 201
2	ISSUED FOR 95% SUBMISSION	12 NOV 201
1	ISSUED FOR 75% SUBMISSION	30 APR 201

revision	date
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Do not scale drawings.
Verify all dimensions and conditions on site and immediately
notify the Departmental Representative of all discrepancies.



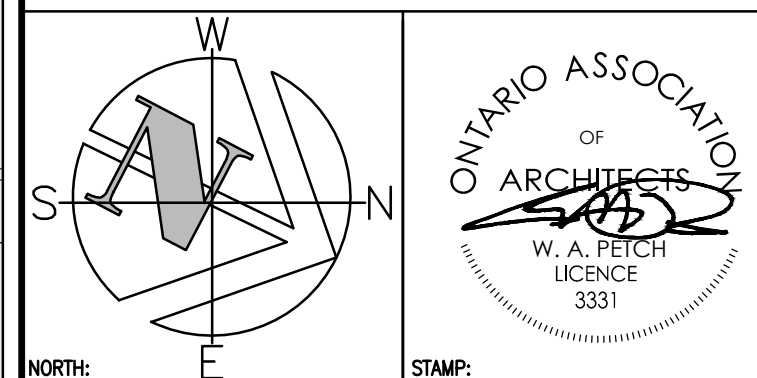

A Detail No.
 No. du détail

B drawing no. — where detail required
 dessin no. — où détail exigé

C drawing no. — where detailed
 dessin no. — où détaillé

project title
titre du projet

BURLINGTON **ONTARIO**

CANADA CENTRE FOR INLAND WATERS
867 LAKESHORE ROAD

LIBRARY RENOVATION

drawing	titre
titre du	dessin

PART SECOND FLOOR –
LIBRARY DEMOLITION PLAN

drawn by
dessine par R+P A

designed by	
conc par	R+P A

approved by
approuvé par CCIW/EC/PWGSC


bid	project manager
offre	administrateur de projets

project date date du projet	2013-02-20
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project no. no. du projet	R.061475.001
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drawing no.
dessine no.

A100




DEMOLITION NOTES AND LEGEND:

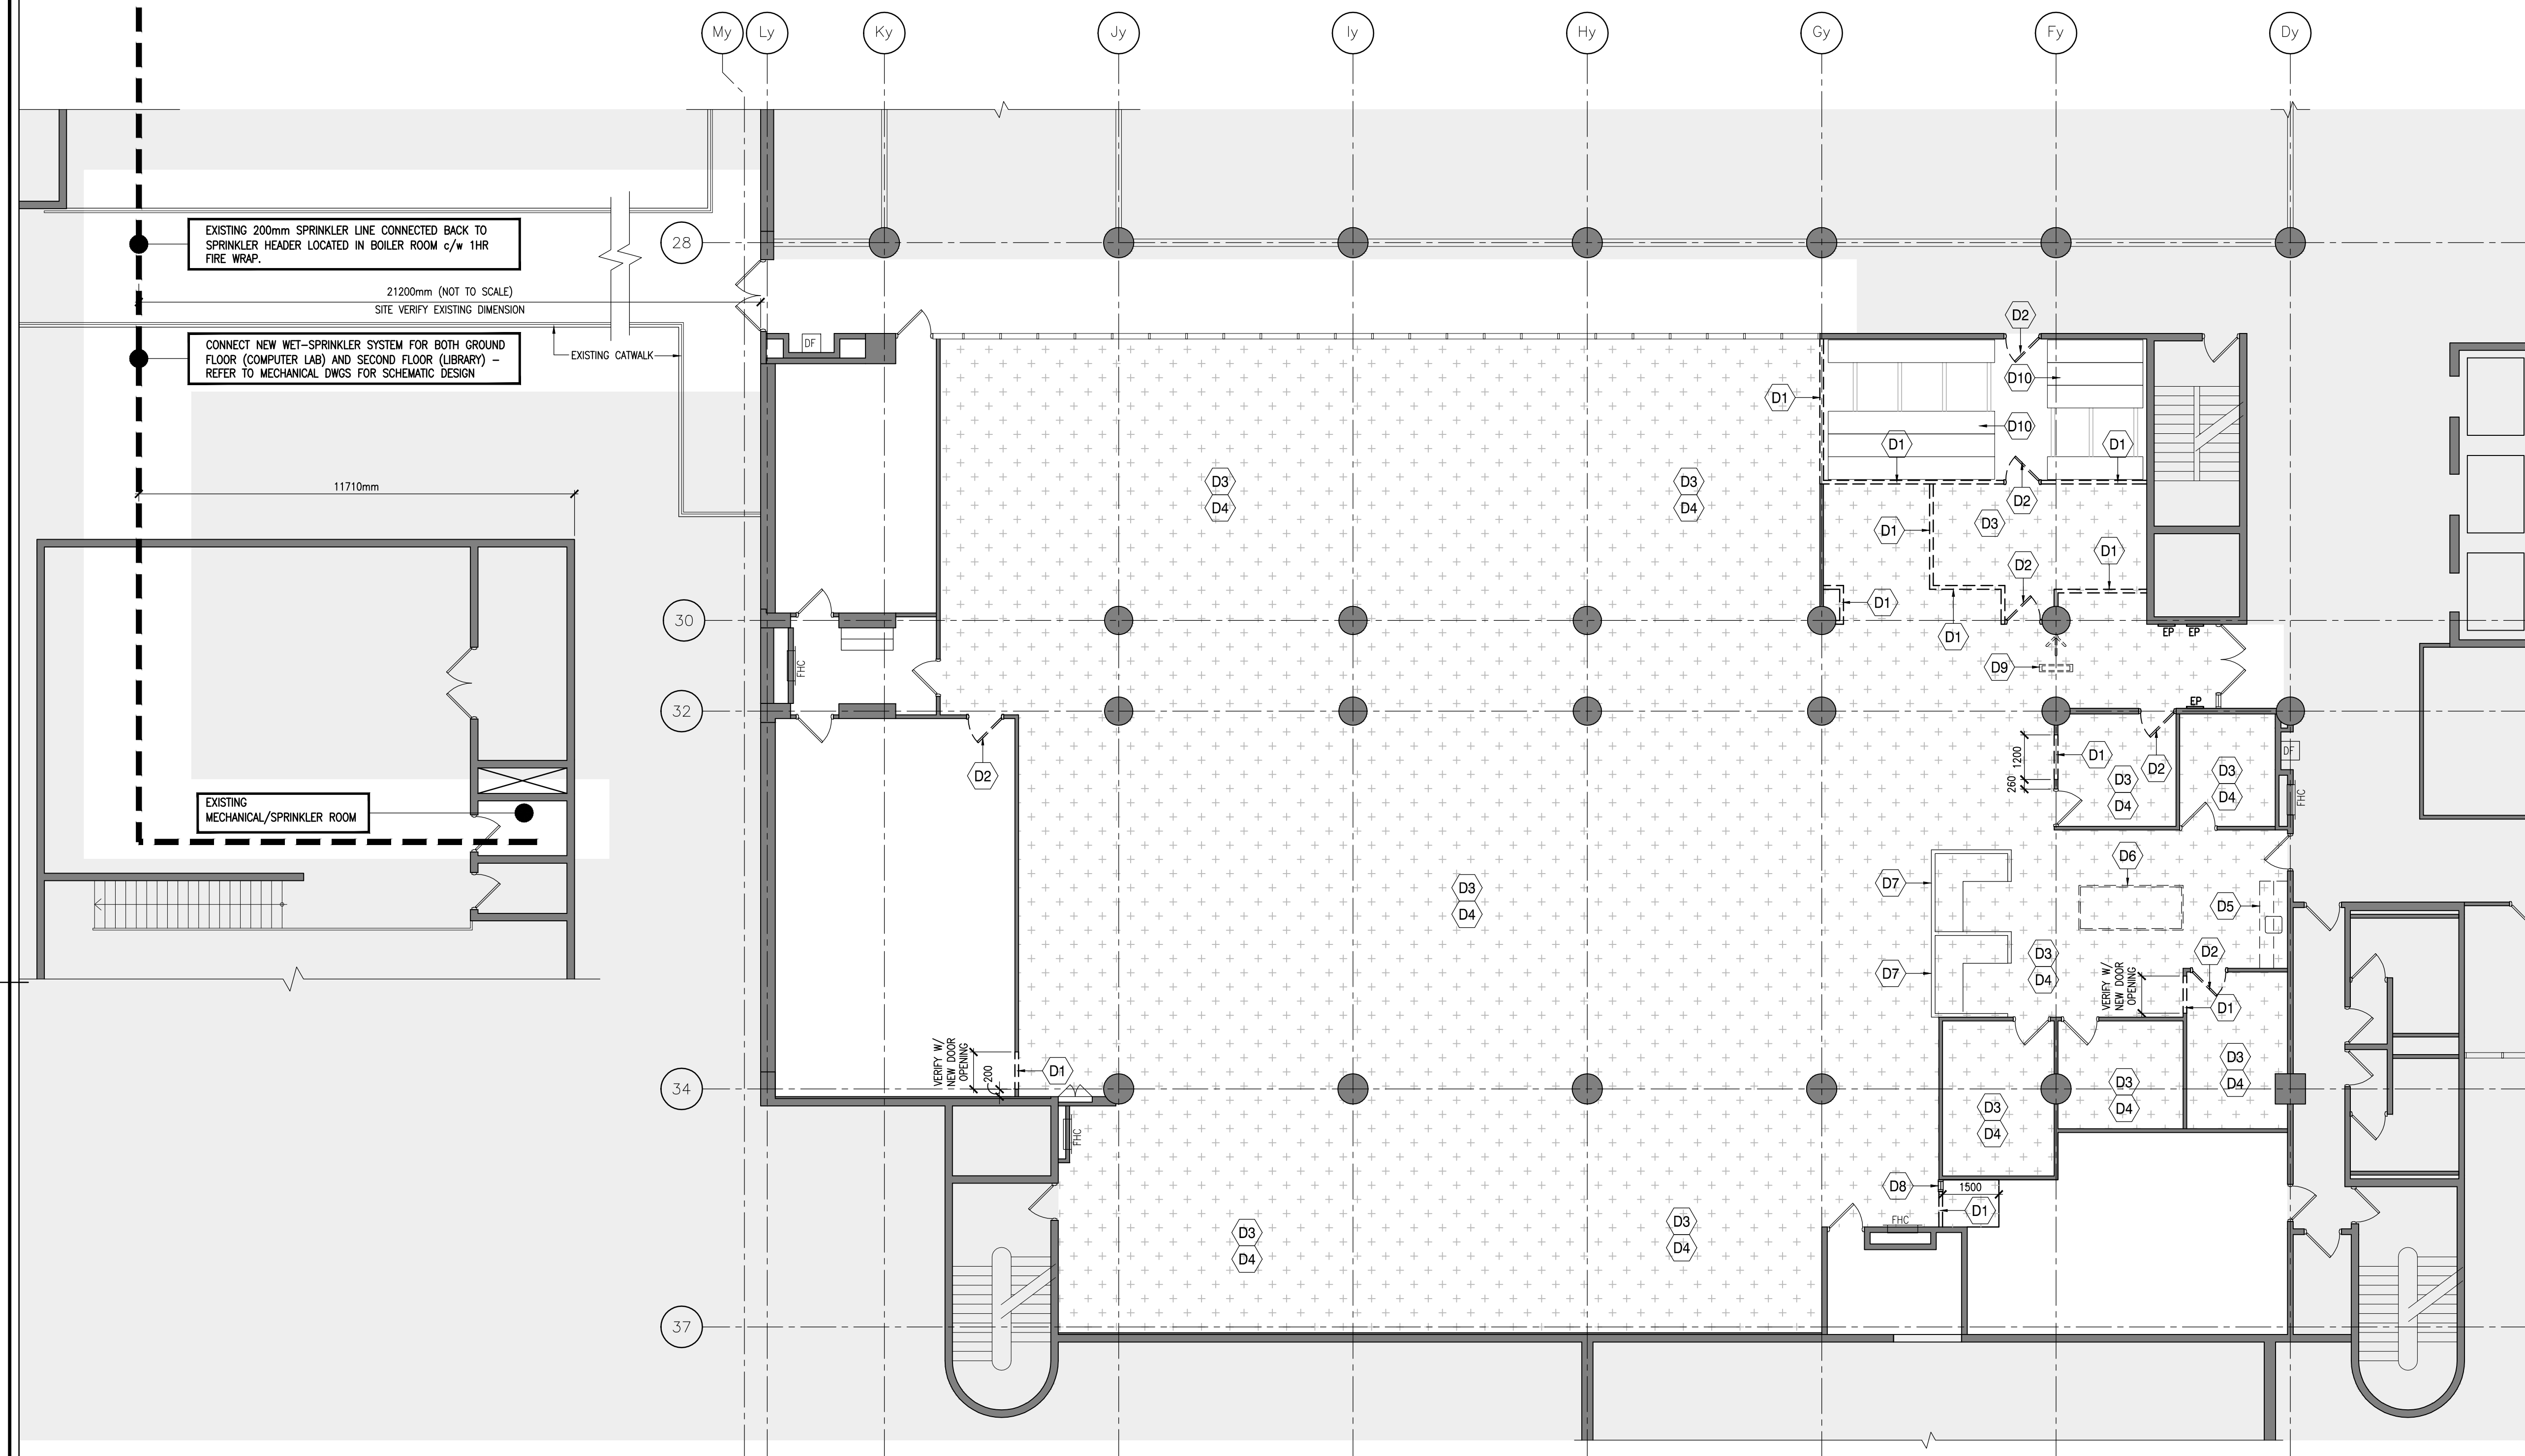DEMOLITION NOTES:

1. DEMOLITION DRAWINGS ARE PROVIDED TO INDICATE THE GENERAL EXTENT OF DEMOLITION WORK AND AS SUCH DO NOT NECESSARILY INDICATE THE ENTIRE SCOPE OF THE DEMOLITION WORK. THE EXTENT OF THE DEMOLITION WORK WILL BE THAT WHICH IS NECESSARY TO COMPLETE THE WORK AS DESCRIBED BY THE CONTRACT DOCUMENTS (SEE ALSO SPECIFICATIONS)
2. REFER TO SPECIFICATIONS FOR "OSHSMS" DESIGNATED SUBSTANCES AND HAZARDOUS MATERIALS SURVEY REPORT – FOR REQUIRED REMEDIATION AND ABATEMENT PROCEDURES AT ALL LOCATIONS WHERE DESIGNATED SUBSTANCES AND HAZARDOUS MATERIALS ARE DISTURBED BY NEW CONSTRUCTION/ DEMOLITION OR ARE TO BE REMOVED
3. PROTECT ADJACENT PROPERTY AGAINST DAMAGES WHICH MIGHT OCCUR FROM FALLING DEBRIS OR OTHER CAUSES. MAKE GOOD ALL DAMAGE AND FINISHES CAUSED BY DOING THIS WORK.
4. CONTRACTOR TO COORDINATE DEMOLITION WITH ALL DISCIPLINES, AND ALL ASSOCIATED TRADES, ALSO COMPLETE DEMOLITION IN ACCORDANCE WITH BUILDING CODES, CONSTRUCTION SAFETY ACT AND AUTHORITIES HAVING JURISDICTION AND ABIDE BY ALL REQUESTS BY SUCH AUTHORITIES WITHOUT ADDITIONAL COST TO THE CLIENT.
5. CLIENT (COW) SHALL BE RESPONSIBLE FOR REMOVING ALL EXISTING FURNITURE, EQUIPMENT AND EXISTING LIBRARY SHELVES FROM THE WORK AREAS UNDER CONTRACT
6. DEMOLISH EXISTING PARTITIONS AS INDICATED ON DEMOLITION FLOOR PLAN. MAKE GOOD ALL BASE BUILDING COMPONENTS THAT ARE TO REMAIN.
7. CONTRACTOR SHALL REPAIR AND MAKE GOOD ANY AND ALL EXISTING FIREPROOFING DAMAGED BY DEMOLITION.
8. ALL DEBRIS AND MATERIALS REMOVED FROM AREAS OF THE WORK SHALL BE DONE SO IN COVERED CONTAINERS. CONTRACTOR SHALL COORDINATE REMOVAL ROUTE WITH CLIENT (COW)
9. DISCONNECT, REMOVE AND/OR RELOCATE ALL EXISTING ELECTRICAL, MECHANICAL, AND COMMUNICATION SERVICES EXPOSED DUE TO DEMOLITION. ALL ABANDONED PENETRATIONS TO BE FILLED SOLID WITH NON-SHRINK GROUT OR FIRE RETARDANT STOP IF LOCATED ON AN EXISTING FIRE SEPARATION (SEE ALSO ELEC. AND MECH. DEMOLITION DWGS.)
10. CONTRACTOR TO ERECT HOARDING WALLS (ONLY AS REQUIRED) TO MAINTAIN SECURITY AND EXITING ROUTES. DESIGN, DETAILING, CONSTRUCTION OF HOARDING, MUST CONFORM TO THE BUILDING CODES, OCCUPATIONAL HEALTH AND SAFETY ACT AND REGULATIONS
11. CONTRACTOR TO THOROUGHLY CLEAN ALL SURFACES WITHIN THE WORK AND ADJACENT AREAS AND REMOVE ALL CONSTRUCTION DEBRIS PRIOR TO COMPLETION.
12. CONTRACTOR TO FOLLOW CLIENT (COW) POLICIES AND PROCEDURES, AS WELL AS, CSA STANDARDS DURING DEMOLITION/RENOVATION/CONSTRUCTION PHASES.
13. ALL FIRE RATED ASSEMBLIES SHALL BE MAINTAINED. NEW CONSTRUCTION, REQUIRED AFTER DEMOLITION SHALL MEET OR EXCEED THE EXISTING FIRE RATINGS.
14. CONTRACTOR IS RESPONSIBLE FOR VERIFYING ALL DIMENSIONS AND EXISTING CONSTRUCTION. SHOULD A DISCREPANCY ON EITHER BE FOUND, REFER FINDINGS TO DEPARTMENTAL REPRESENTATIVE.

HATCH TONE AREA DENOTES
- NOT IN CONTRACT (N.I.C.)

HATCHED AREA DENOTES -
AREAS WHERE EXISTING
FLOOR FINISH IS TO BE
REMOVED

 EXISTING PARTITION/
STRUCTURES TO REMAIN


EXISTING DOOR AND FRAME
TO BE REMOVED

EXISTING WALL TO BE
DEMOLISH (REFER TO
FLOOR PLANS)

EXISTING DOOR AND FRAME
TO REMAIN

- | | | | |
|----|--|-----|---|
| D1 | DEMOLISH ENTIRE PARTITION AND ALL RELATED COMPONENTS TO ACCOMMODATE NEW WORK, PATCH AND MAKE GOOD AS REQUIRED | D10 | PROVIDE THE NECESSARY PROTECTION TO EXISTING MOBILE FILE STORAGE SYSTEM. CONTRACTOR SHALL BE RESPONSIBLE FOR ANY DAMAGES CAUSED DURING CONSTRUCTION |
| D2 | REMOVE AND SALVAGE EXISTING DOOR, FRAME AND HARDWARE | | |
| D3 | REMOVED EXISTING FLOOR FINISHES (CARPET AND VCT FLOORING) TO TOP OF EXISTING CONCRETE SLAB. REMOVE ALL DEBRIS FROM BELOW FINISHES TO PROVIDE TRUE AND FLUSH SURFACE FOR NEW FLOORING | | |
| D4 | REMOVE ALL EXISTING WALL BASE, PATCH AND MAKE GOOD TO RECEIVE NEW RUBBER WALL BASE (INCLUDING WALL BASE AT STRUCTURAL COLUMNS) | | |
| D5 | DEMOLISH EXISTING MILLWORK AND ALL RELATED COMPONENTS (CAP ALL PLUMBING SERVICES) – MAKE GOOD TO RECEIVE NEW KITCHEN MILLWORK | | |
| D6 | REMOVE AND RELOCATED EXISTING WORK AREA TABLE – DISCONNECT EXISTING ELECTRIC/COMMUNICATION CONNECTIONS (SEE ALSO ELEC. DWGS.) REFER TO DRAWINGS A201 FOR NEW LOCATION | | |
| D7 | TEMPORARY REMOVE EXISTING WORKSTATIONS IN ORDER TO REMOVE AND INSTALL NEW FLOOR FINISH UNDER EACH WORKSTATION. RE-INSTATE WORKSTATION AFTER NEW FLOOR INSTALLATION | | |
| D8 | DEMOLISH EXISTING SCREEN AND ALL RELATED COMPONENTS, PATCH AND MAKE GOOD AS REQUIRED | | |
| D9 | REMOVE AND SALVAGE EXISTING TURNSTILE AND ALL RELATED COMPONENTS – RETURN TO CCW | | |

A horizontal graphic scale bar. It is divided into segments. The first segment from the left is further subdivided into five smaller parts. Above the bar, the labels '0', '1m', '5m', and '10m' are positioned at the corresponding tick marks. To the right of the bar, the text '1:100' indicates the scale.

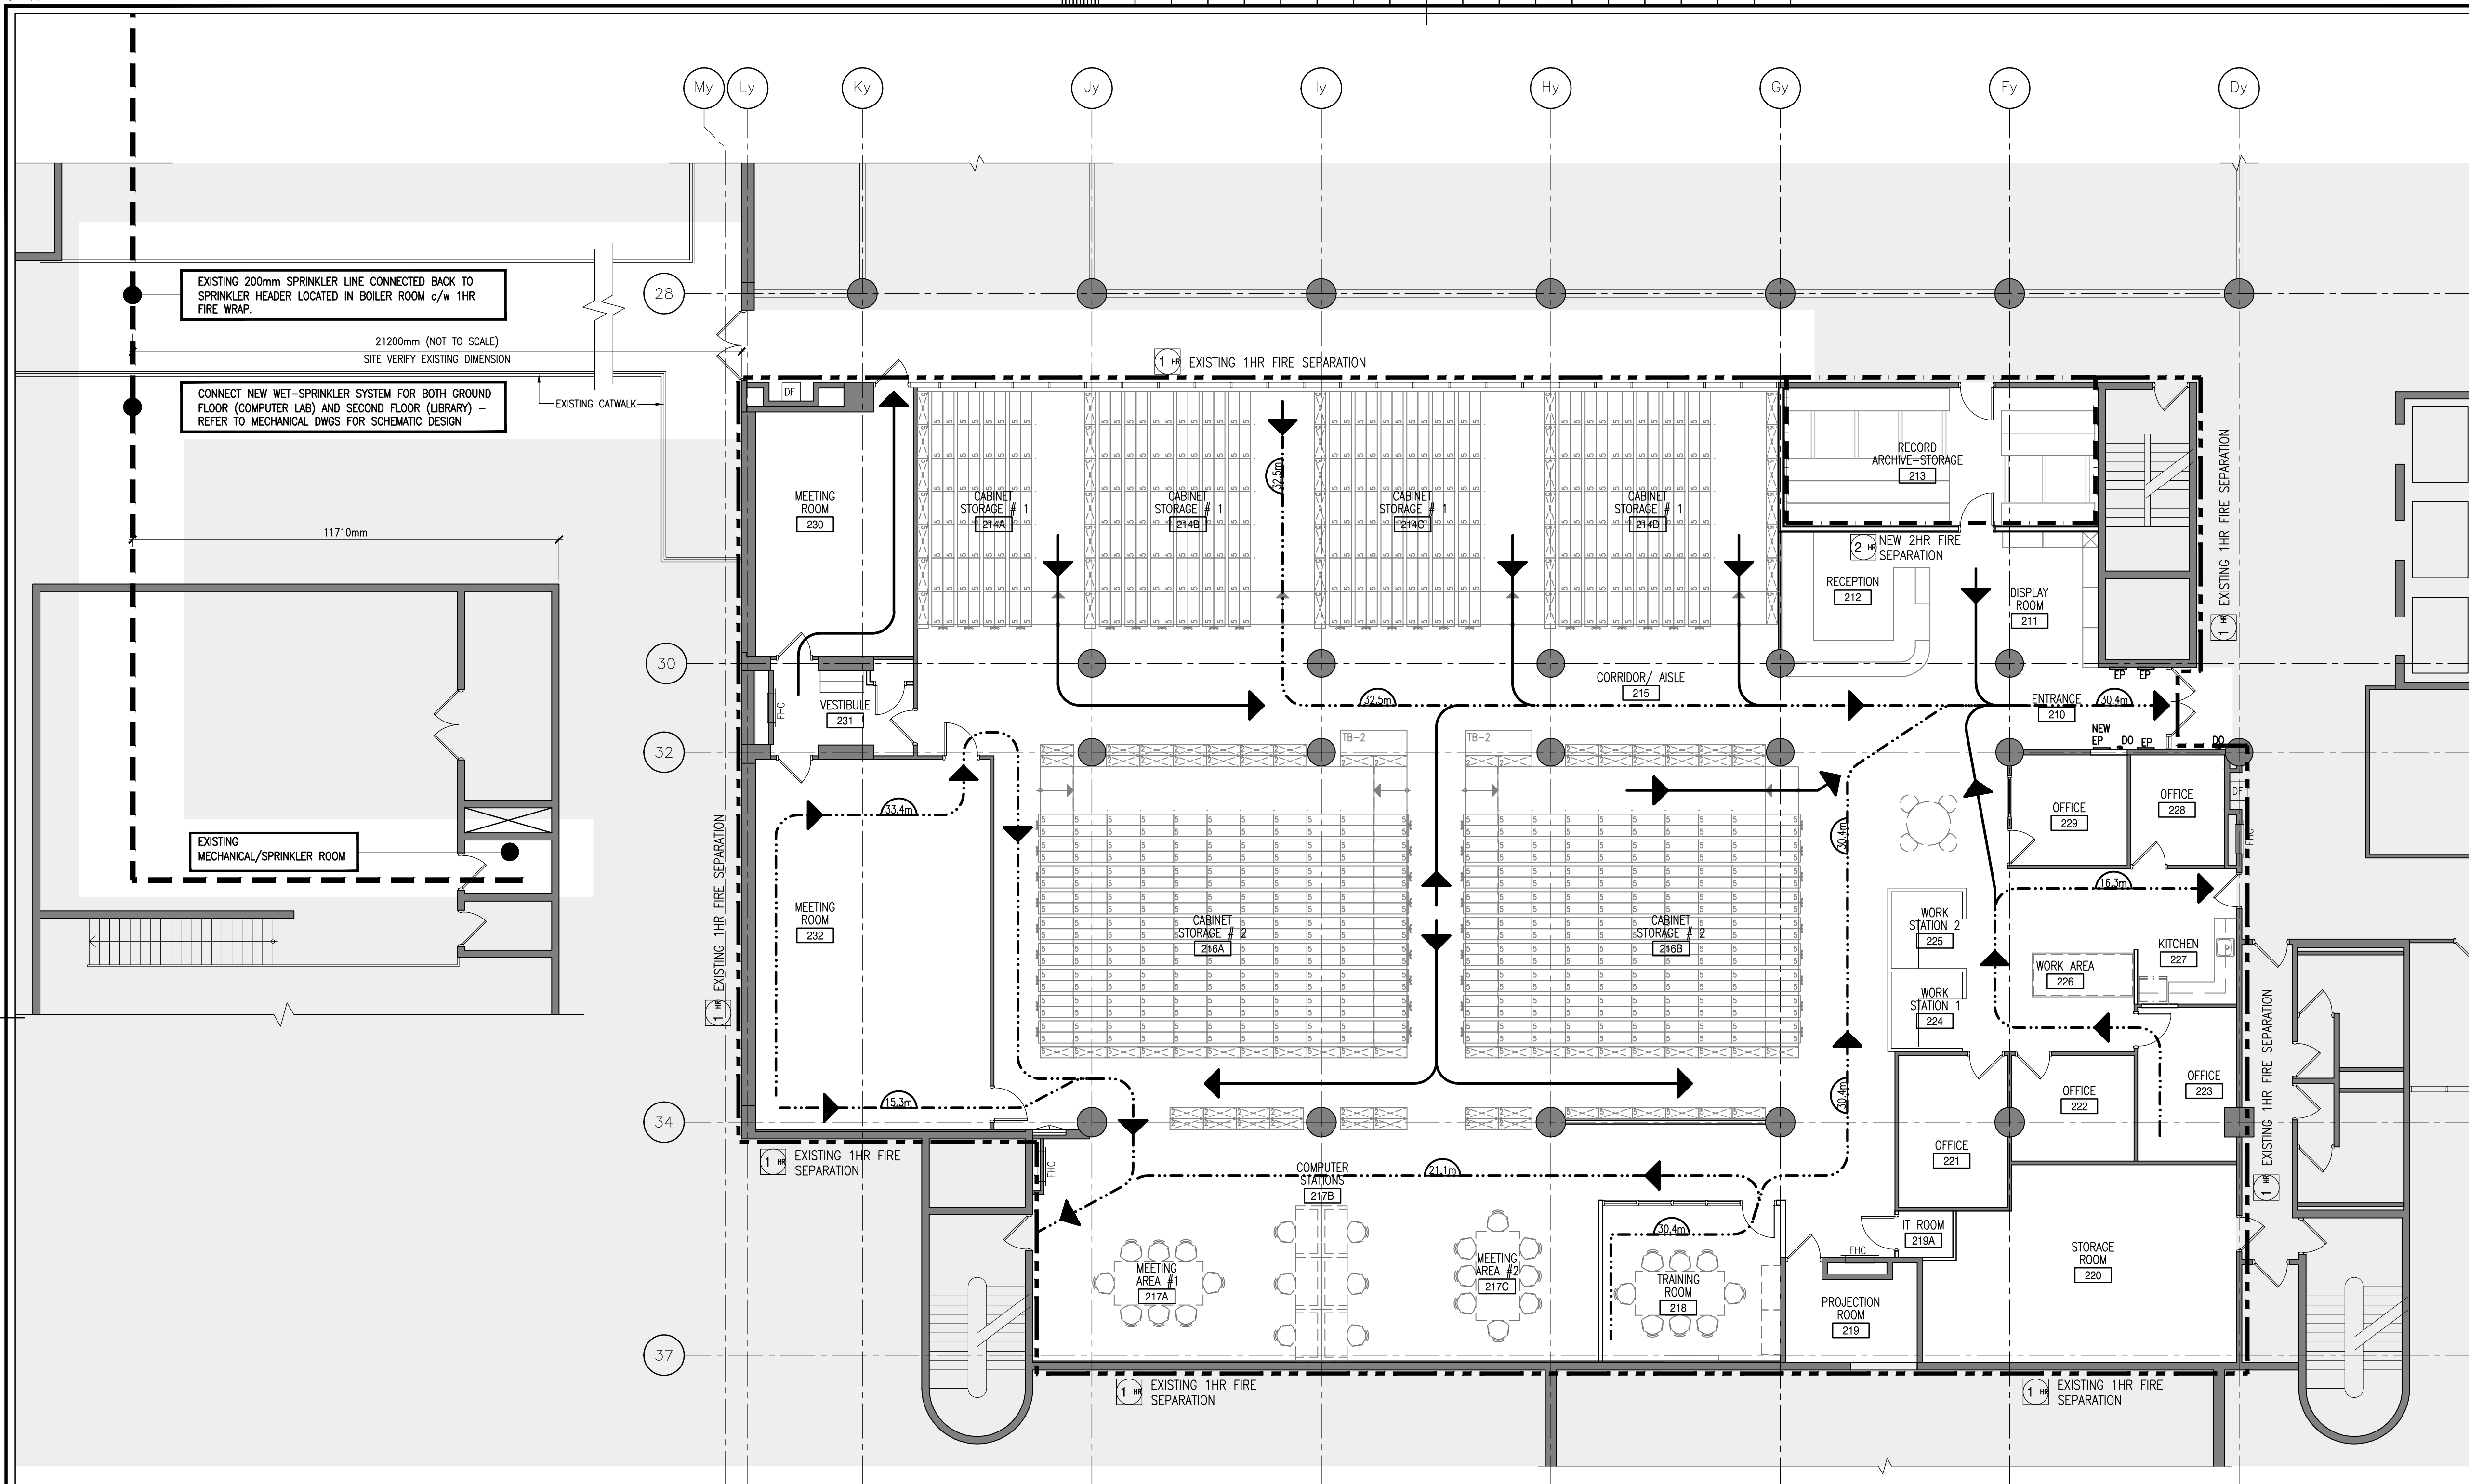

LEGEND

- HATCH TONE AREA DENOTES - NOT IN CONTRACT (N.I.C.)
- FURNITURE (N.I.C.) SUPPLIED BY CLIENT (CCW)
- EXISTING PARTITION/STRUCTURES TO REMAIN
- NEW WALL CONSTRUCTION (REFER TO FLOOR PLANS)
- HIGH DENSITY MOBILE SHELVING "HOMES" (5 SHELVES HIGH) MANUAL OPERATION
- FIXED CABINET BANKS (5 SHELVES HIGH)
- FIXED CABINET BANKS (2 SHELVES HIGH)
- DO - DOOR OPERATOR (REFER TO ELECTRICAL DWGS.)
- EP - ELECTRICAL PANEL (REFER TO ELECTRICAL DWGS.)
- FHC - EXISTING FIRE HOUSE CABINET
- NEW/RELOCATED DOOR AND FRAME
- EXISTING DOOR AND FRAME TO REMAIN

FIRE SEPARATION LEGEND

- INDICATES PATH OF TRAVEL
- INDICATES TRAVEL DISTANCE TO EXIT
- 1 HR FIRE RATING
- 2 HR FIRE RATING

0 1m 5m 10m 1:100

consultant




1867 YONGE ST, STE 1100, TORONTO ON CANADA M4S 1Y5
T 416 480 2020 F 416 480 1881

3	ISSUED FOR BID	09 DEC 2013
2	ISSUED FOR 95% SUBMISSION	12 NOV 2013
1	ISSUED FOR 75% SUBMISSION	30 APR 2013

revision date

Do not scale drawings. Verify all dimensions and conditions on site and immediately notify the Departmental Representative of all discrepancies.

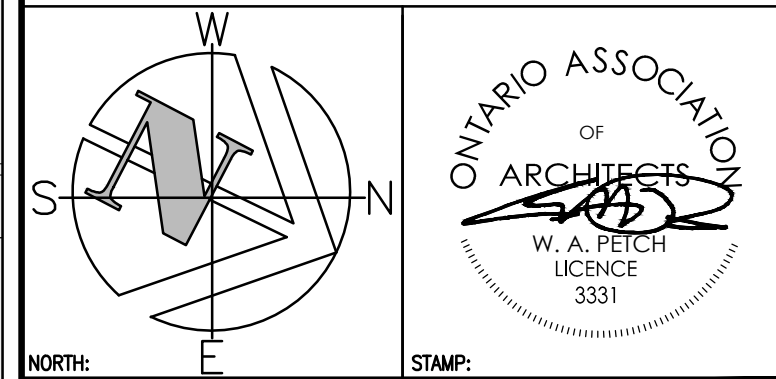

- A Detail No. No. du détail
- B drawing no. - where detail required dessin no. - où détail exigé
- C drawing no. - where detailed dessin no. - où détaillé

project title
titre du projet
BURLINGTON ONTARIO
CANADA CENTRE FOR INLAND WATERS
867 LAKESHORE ROAD

LIBRARY RENOVATION

drawing title
titre du dessin
PART SECOND FLOOR - LIBRARY FIRE SEPARATION PLAN

drawn by
dessiné par
R+P A

designed by
conçue par
R+P A


approved by
approuvé par
CCW/EC/PWGSC

bid
offre
project manager
administrateur de projets

project date
date du projet
2013-02-20

project no.
no. du projet
R.061475.001

drawing no.
dessiné no.
A200

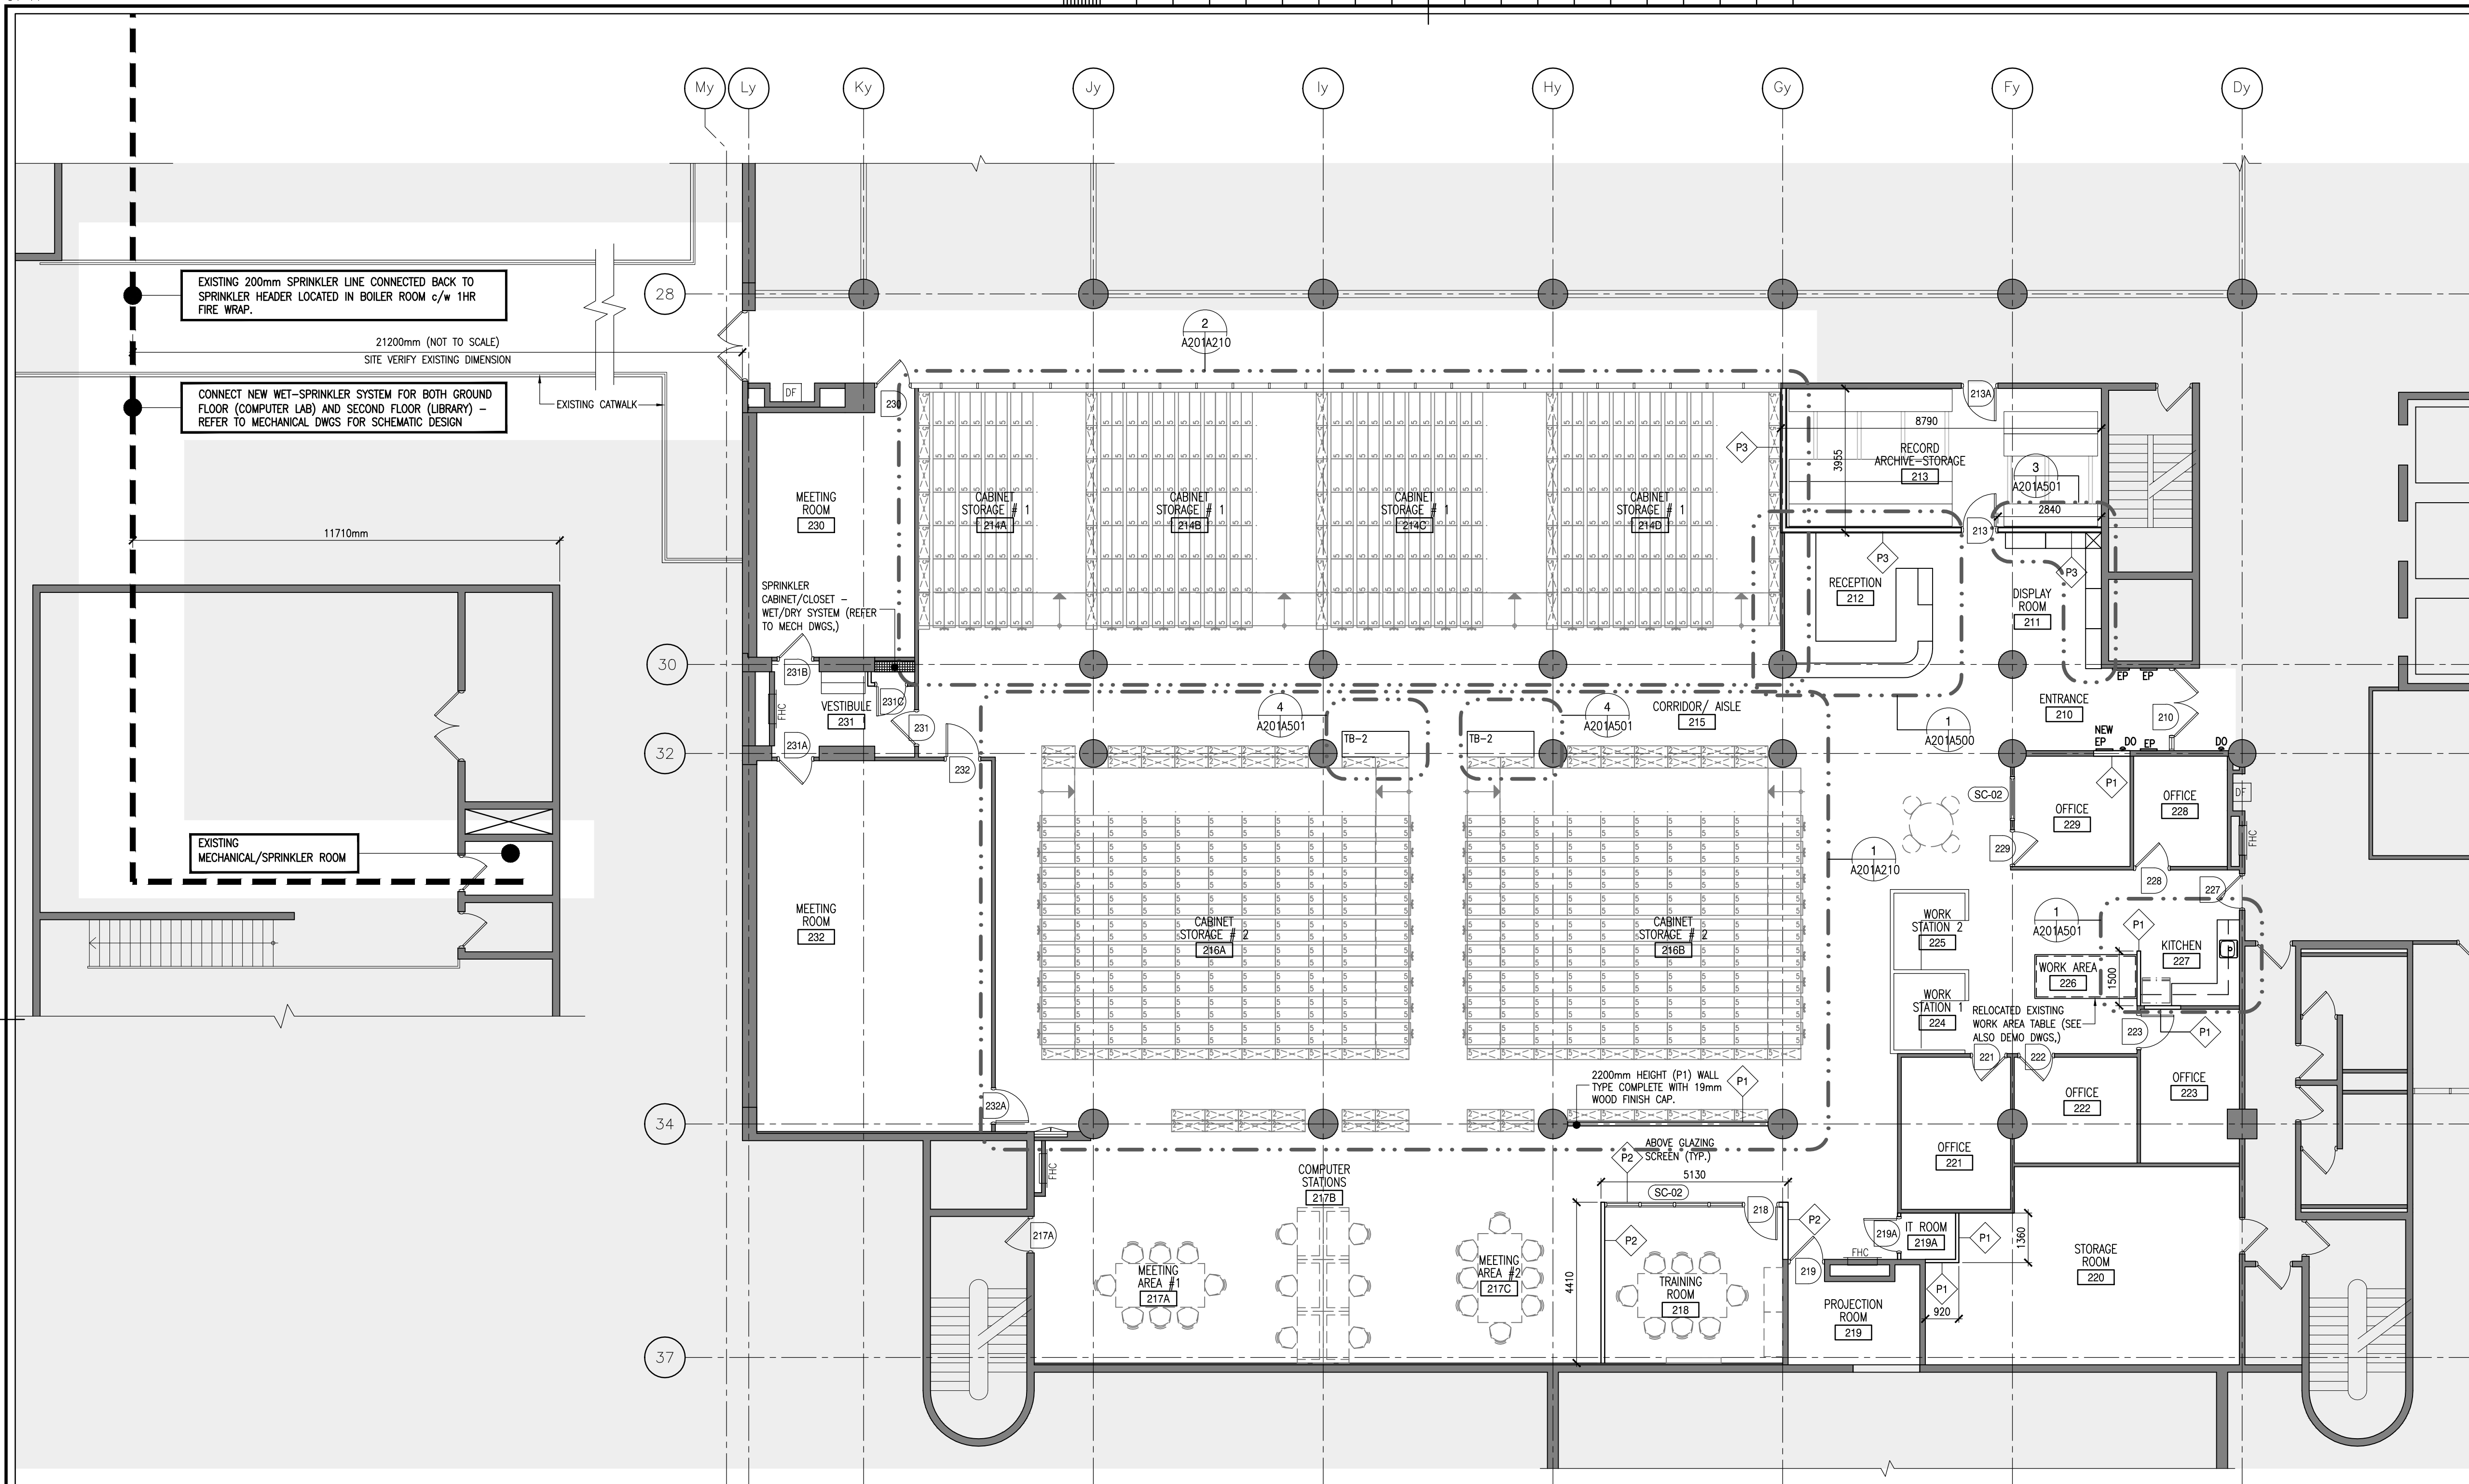

NEW CONSTRUCTION NOTES AND LEGEND:

P1 DEMOUNTABLE GYPSUM PARTITION SYSTEM:
FROM FLOOR TO U/S OF STRUCTURE
(CONCRETE SLAB) UNLESS NOTED OTHERWISE

- 1 LAYER 12.7mm GYPSUM BOARD PANEL
- 64mm METAL STUD FRAMING @ 400mm o/c
- 1 LAYER 12.7mm GYPSUM BOARD PANEL

DEMOUNTABLE PARTITION SYSTEM TO MATCH EXISTING
BUILDING STANDARD - INCLUDING DOOR
FRAMES/GLAZING FRAME SYSTEM

P2 DEMOUNTABLE GYPSUM PARTITION SYSTEM:
FROM FLOOR TO U/S OF STRUCTURE
(CONCRETE SLAB) UNLESS NOTED OTHERWISE

- 1 LAYER 12.7mm GYPSUM BOARD PANEL
- 92mm METAL STUD FRAMING @ 400mm o/c
- 75mm ACOUSTICAL INSULATION (45 STC RATING MIN.)
- 1 LAYER 12.7mm GYPSUM BOARD PANEL

DEMOUNTABLE PARTITION SYSTEM TO MATCH EXISTING
BUILDING STANDARD - INCLUDING DOOR FRAMES/GLAZING
FRAME SYSTEM

P3 2HR FIRE RATED GYPSUM BOARD PARTITION:
FROM FLOOR TO U/S OF STRUCTURE
(CONCRETE SLAB) UNLESS NOTED OTHERWISE

- 2 LAYERS 15.9mm TYPE X GYPSUM BOARD
- 92mm METAL STUD FRAMING @ 400mm o/c
- 2 LAYERS 15.9mm TYPE X GYPSUM BOARD

HATCH TONE AREA DENOTES
- NOT IN CONTRACT (N.I.C.)

EXISTING PARTITION/
STRUCTURES TO REMAIN

NEW WALL CONSTRUCTION
(REFER TO FLOOR PLANS)

HIGH DENSITY MOBILE
SHELVING "HIMES"
(5 SHELVES HIGH)
MANUAL OPERATION

FURNITURE (N.I.C.)
SUPPLIED BY CLIENT (CCW)

NEW/RELOCATED DOOR
AND FRAME

EXISTING DOOR AND FRAME
TO REMAIN

FIXED CABINET BANKS
(5 SHELVES HIGH)

FIXED CABINET BANKS
(2 SHELVES HIGH)

DO - DOOR OPERATOR (REFER
TO ELECTRICAL DWGS.)

EP - ELECTRICAL PANEL (REFER
TO ELECTRICAL DWGS.)

FHC - EXISTING FIRE HOUSE CABINET

NEW PARTITION NOTES:

- PROTECT ADJACENT SURFACES AGAINST DAMAGES. MAKE GOOD ANY DAMAGE CAUSED BY DOING THIS WORK INCLUDING FINISHES
- PROVIDE ACOUSTICAL CAULKING WHERE PARTITIONS MEET COLUMNS, CORE WALLS, FINISHED CEILINGS AND CONCRETE SLABS
- ALL ABANDONED PENETRATIONS TO BE FILLED WITH SOLID NON-SHRINK GROUT OR FIRE RETARDANT SYSTEM AT FIRE SEPARATIONS
- MINIMUM 100mm RETURN AT ALL DOOR FRAME LOCATIONS UNLESS NOTED OTHERWISE
- ALL DIMENSIONS ARE TAKEN FROM THE FACE OF THE PARTITION.
- CONTRACTOR TO PROVIDE DOUBLE METAL STUDS AT EACH DOOR JAMB AND PLYWOOD ROUGH BUCKS.
- CONTRACTOR TO ENSURE EXISTING WALLS ARE PATCHED OR PANELS ARE REPLACED WHERE VISIBLY DAMAGED OR SURFACE DEFECTS EXIST AND PREPARE TO RECEIVE NEW FINISHES
- ALL EXISTING DOORS AND FRAMES SHALL RECEIVED NEW PAINT FINISH. CONTRACTOR TO ENSURE ALL SURFACES ARE ACCEPTABLE AND FREE OF DEFECTS OR PENETRATIONS PRIOR TO APPLICATION OF NEW FINISH
- CONTRACTOR SHOULD REVIEW THE EXISTING SITE CONDITIONS PRIOR TO SUBMISSION OF TENDER BIDS AND ENSURE THAT ALL NECESSARY MATERIALS AND LABOUR ARE PROVIDED TO COMPLETE ALL THE WORK IN ACCORDANCE WITH THE INTENT OF THESE DRAWINGS AND SPECIFICATIONS. NO EXCEPTIONS SHALL BE MADE FOR FAILING TO DO SO.
- CONTRACTOR TO ERECT HOARDING WALLS ONLY AS REQUIRED TO MAINTAIN SECURITY AND EXITING ROUTES. DESIGN, DETAILING, CONSTRUCTION OF HOARDING, MUST CONFORM TO THE BUILDING CODES, OCCUPATIONAL HEALTH AND SAFETY ACT AND REGULATIONS
- CONTRACTOR TO THOROUGHLY CLEAN ALL SURFACES WITHIN THE WORK AND ADJACENT AREAS AND REMOVE ALL CONSTRUCTION DEBRIS PRIOR TO COMPLETION.
- CONTRACTOR TO FOLLOW CLIENT (CCW) POLICIES AND PROCEDURES, AS WELL AS, CSA STANDARDS DURING DEMOLITION/RENOVATION/CONSTRUCTION PHASES
- ALL FIRE RATED ASSEMBLIES SHALL BE MAINTAINED. NEW CONSTRUCTION, REQUIRED AFTER DEMOLITION SHALL MEET OR EXCEED THE EXISTING FIRE RATINGS.
- CONTRACTOR IS RESPONSIBLE FOR VERIFYING ALL DIMENSIONS AND EXISTING CONSTRUCTION. SHOULD A DISCREPANCY ON EITHER BE FOUND, REPORT FINDINGS TO DEPARTMENTAL REPRESENTATIVE.

0 1m 5m 10m
1:100



Public Works and
Government Services Canada
Travaux publics et
Services gouvernementaux Canada

consultant

Reich
+ Petch



ARCHITECTS

1867 YONGE ST., STE 1100, TORONTO ON CANADA M4S 1Y5
T 416 480 2020 F 416 480 1881

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project title
titre du projet
BURLINGTON ONTARIO
CANADA CENTRE FOR INLAND WATERS
867 LAKESHORE ROAD

LIBRARY RENOVATION

drawing title
titre du dessin

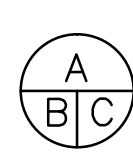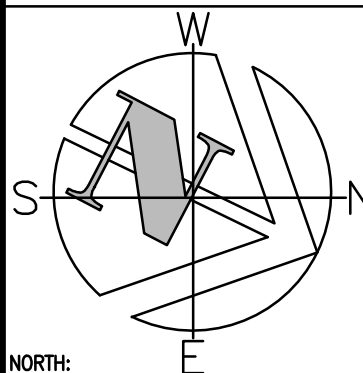PART SECOND FLOOR -
LIBRARY NEW WORK PLAN

drawn by
dessiné par
R+P A

designed by
conc par
R+P A


approved by
approuvé par
CCW/EC/PWGSC

bid
offre
project manager
administrateur
de projets

project date
date du projet
2013-02-20

project no.
no. du projet
R.061475.001

drawing no.
dessiné no.
A201

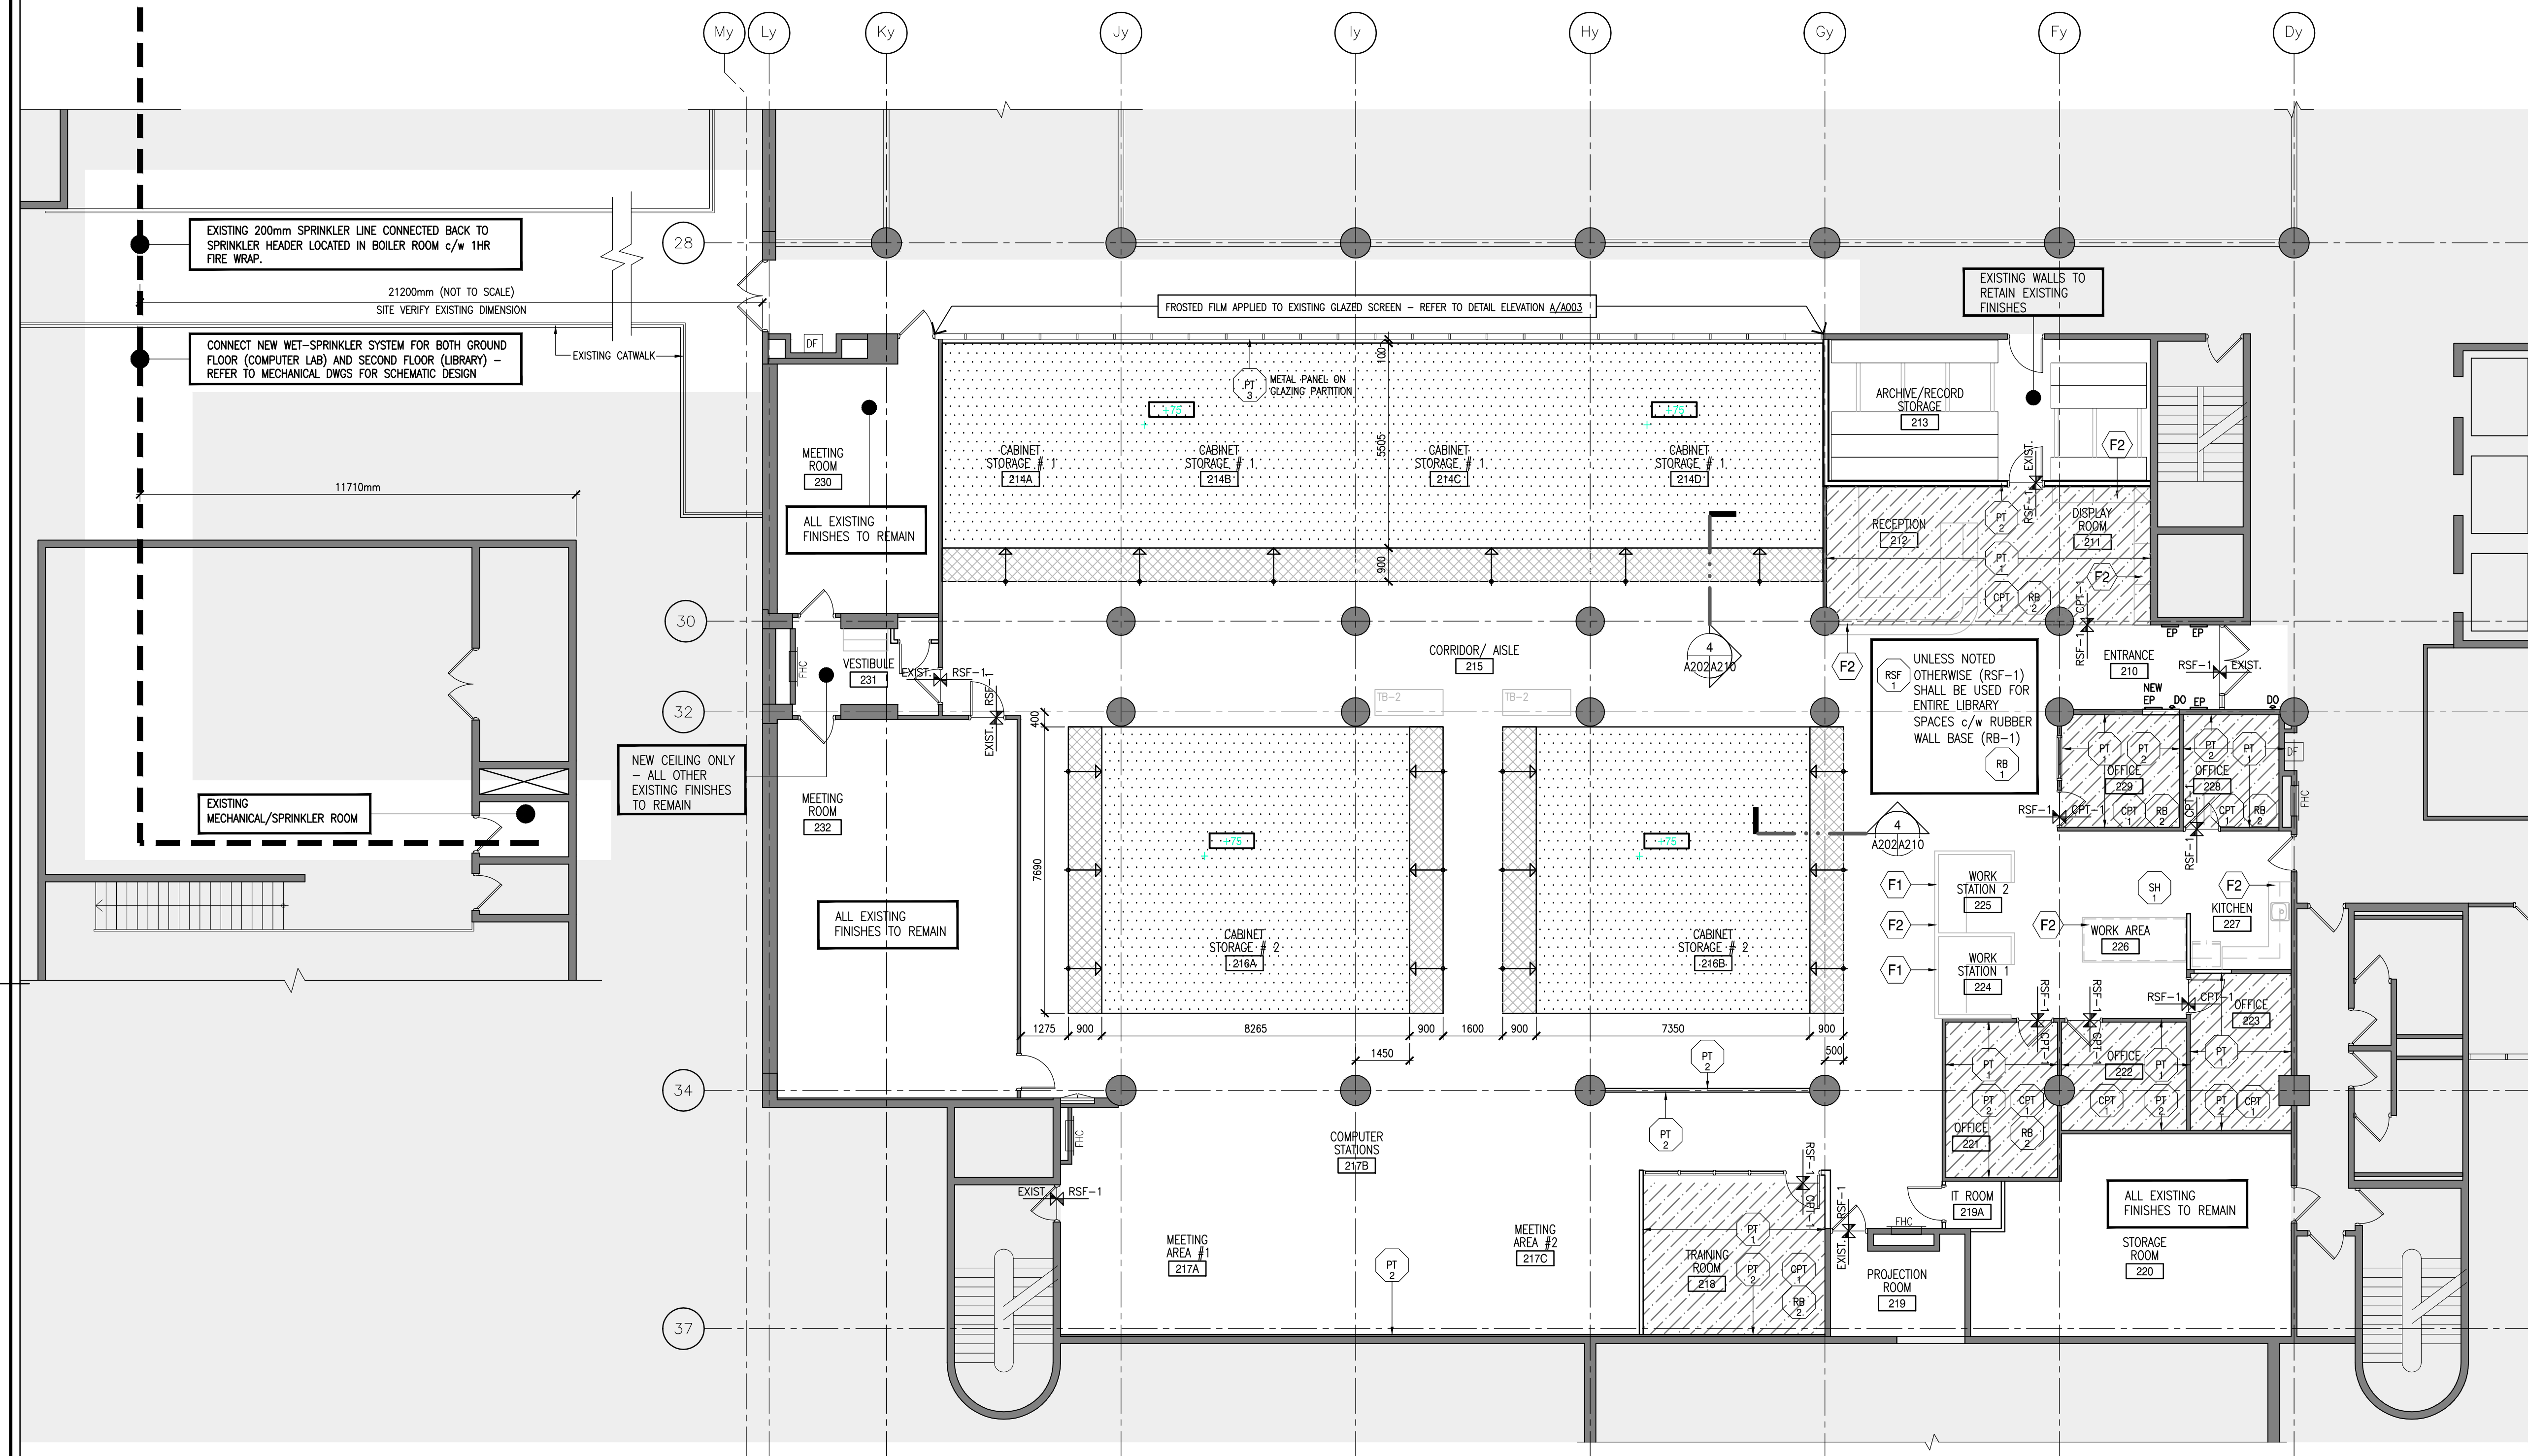

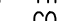



NEW FINISHES NOTES AND LEGEND:



NEW FINISHES NOTES:

1. UNLESS NOTED OTHERWISE PT-1 SHALL BE USED FOR ALL NEW AND EXISTING PARTITIONS, WALLS TO RECEIVE 1 COAT PRIMER AND 2 COATS FINISH PAINT (TYPICAL)
2. ALL EXISTING WALLS BEING PAINTED ARE TO BE PATCHED, PRIMED AND FILLED AS REQUIRED TO PROVIDE A SMOOTH FINISH. EXISTING WALLS TO BE CLEANED PRIOR TO BEING PAINTED. WALLS TO RECEIVE 1 COAT PRIMER AND 2 COATS FINISH PAINT (TYPICAL)
3. UNLESS NOTED OTHERWISE, (R0-1) RUBBER WALL BASE SHALL BE PROVIDED FOR ALL NEW AND EXISTING PARTITIONS/COLUMNS (TYPICAL)
4. FINISHES PLAN AND LEGEND TO BE READ IN CONJUNCTION WITH ROOM FINISHES SCHEDULE AND SPECIFICATIONS. ANY DISCREPANCIES SHALL BE BROUGHT FORTH TO THE DEPARTMENTAL REPRESENTATIVE
5. ALL NEW CARPET TILE TO BE INSTALLED IN A QUARTER TURNED PATTERN AS PER MANUFACTURES SPECIFICATIONS
6. SCRIBE ALL MILLWORK TO WALLS AND PROVIDE BEAD OF SILICONE SEALANT WHERE COUNTERS / MILLWORK DESK MEET WALLS (TYPICAL)
7. ALL NEW/EXISTING HOLLOW METAL DOORS AND FRAMES TO BE PRIMED WITH 1 COAT OF PRIMER AND 2 COATS OF INTERIOR LATEX ENAMEL PAINT. (SEE ALSO DOOR SCHEDULE)
8. CONTRACTOR TO PROTECT FLOOR AND CEILING FINISHES FROM NEW PAINT IN ALL CASES.
9. ALL EXISTING (FHC) FIRE HOSE CABINETS TO BE PAINTED RED.

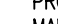
PAINT FINISHES:


- | | | | |
|---|---|---|---|
|  | <p>PRODUCT TYPE: PAINT
 MANUFACTURER: —
 TYPE: ACRYLIC SEMI-GLOSS
 COLOUR: OC-22 CAL
 AT MINIMUM: 1 COAT PRIMER AND
 2 COATS FINISH PAINT</p> |  | <p>PRODUCT TYPE: PAINT
 MANUFACTURER: —
 TYPE: LATEX/ ACRYLIC SEMI-GLOSS
 COLOUR: 2144-30-ROSEMARY SPRIG
 AT MINIMUM: 1 COAT PRIMER AND
 2 COATS FINISH PAINT</p> |
|  | <p>PRODUCT TYPE: PAINT
 MANUFACTURER: —
 TYPE: SEMI-GLOSS
 COLOUR: 2144-20 EUCALYPTUS LEAF
 AT MINIMUM: 1 COAT PRIMER AND
 2 COATS FINISH PAINT</p> |  | <p>PRODUCT TYPE: PAINT
 MANUFACTURER: —
 TYPE: SEMI-GLOSS
 COLOUR: 2121-10 GRAY
 AT MINIMUM: 1 COAT PRIMER AND
 2 COATS FINISH PAINT</p> |

RUBBER WALL BASE:

- | | | | |
|---|---|---|--|
|  | PRODUCT TYPE: RUBBER/RESILIENT WALL BASE
MANUFACTURER: -
CODE: STANDARD TOE 100mm HIGH W/ TOE
COLOUR: 469 MISTIFY CG |  | PRODUCT TYPE: RUBBER/RESILIENT WALL BASE
MANUFACTURER: -
CODE: STANDARD TOE 100mm HIGH W/ TOE
COLOUR: 48 GREY |
|---|---|---|--|

FLOORING FINISHES:

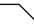-  **PRODUCT TYPE:** CARPET TILE
MANUFACTURER: —
STYLE: ENERGY, PATTERN: RUNWAY
CODE AND SIZE: TILE 24" X 24"
COLOUR: COULTURE T301-30107/ 7841-48107

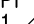 **PRODUCT TYPE:** RESILIENT SHEET FLOORING
MANUFACTURER: —
STYLE: WEATHERED CONCRETE PLANKS
CODE AND SIZE: PLANKS 6" X 48" X 1/8"
COLOUR: NATURAL GREY WC21816

TRANSITION STRIPS:

- MANUFACTURER: -
PRODUCT: STAINLESS STEEL EXTRUSION

NOTE:
CONTRACTOR TO FOLLOW MANUFACTURE INSTALLATION GUIDES FOR
FLOOR FINISHES.




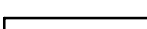


CARPET TILE (CPTT). REFER TO FLOOR FINISH PLAN AND ROOM FINISH SCHEDULE

RESILIENT SHEET FLOORING (RSF). REFER TO FLOOR FINISH PLAN AND ROOM FINISH SCHEDULE


STAINLESS STEEL
EXTRUSION FOR THE
TRANSITION BETWEEN
CARPET TILE (CPTT) AND
RESILIENT SHEET
FLOORING (RSF)

CONTRACTOR TO SLOPE
EXISTING FLOOR SLAB OR
ADJUST BED AS REQUIRED
TO ALLOW FOR FLUSH
TRANSITION

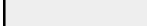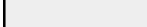TYPICAL TRANSITION DETAIL:

- | | | | |
|---|--|---|--|
|  | HATCH TONE AREA DENOTES
— NOT IN CONTRACT (N.I.C.) |  | HATCHED AREA DENOTES
EXTENT OF NEW CARPET
FINISH |
|  | HATCHED AREA DENOTES
— EXTENT OF HDMS UNITS
RAISED FLOOR |  | HATCHED AREA DENOTES
EXTENT OF HDMS UNITS
RAMPS |
|  | NEW WALL CONSTRUCTION
(REFR TO FLOOR-PLANS) |  | EXISTING PARTITION/
STRUCTURES, TO REMAIN |

FLOOR/ FINISHES MATERIAL ABBREVIATIONS:

- | TRANSITION SYMBOL | |
|---|---|
| FIN-1  FIN-2 | EXIST. EXISTING FLOORING TO REMAIN
CPTI CARPET TILE
RSF RESILIENT SHEET FLOORING
PT PAINT
RB RUBBER/RESILIENT WALL BASE
T-STR TRANSITION STRIP |
| F1 | TEMPERATELY REMOVE EXISTING WORKSTATIONS IN ORDER TO REMOVE AND INSTALL NEW FLOOR FINISH UNDER EACH WORKSTATION |
| F2 | PROVIDE FLOOR FINISHES BENEATH ALL MILLWORK (INCLUDING KITCHEN AND WORKSTATIONS) TYPICAL |



revision	date
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Do not scale drawings.
Verify all dimensions and conditions on site and immediately notify the Departmental Representative of all discrepancies.



project title
titre du projet

BURLINGTON **ONTARIO**

CANADA CENTRE FOR INLAND WATERS
867 LAKESHORE ROAD

drawing title titre du dessin

drawn by
dessine par R+P A

designed by conc par	R+P A
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approved by
approuvé par CCIW/EC/PWGSC

bid	project manager
offre	administrateur de projet

project date date du projet	2013-02-20
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project no. no. du projet

R.061475.001

drawing no.
dessine no.

A203

NOTES:

1. PROTECT ADJACENT SURFACES AGAINST DAMAGES. MAKE GOOD ANY DAMAGE CAUSED BY DOING THIS WORK INCLUDING FINISHES
2. ALL ABANDONED PENETRATIONS TO BE FILLED WITH SOLID NON-SHRINK GROUT OR FIRE RETARDANT SYSTEM AT FIRE SEPARATIONS
3. ALL DIMENSIONS ARE TAKEN FROM THE FACE OF THE PARTITION.
4. CONTRACTOR TO ENSURE EXISTING WALLS ARE PATCHED OR PANELS ARE REPLACED WHERE VISIBLY DAMAGED OR SURFACE DEFECTS EXIST AND PREPARE TO RECEIVE NEW FINISHES
5. CONTRACTOR SHOULD REVIEW THE EXISTING SITE CONDITIONS PRIOR TO SUBMISSION OF TENDER BIDS AND ENSURE THAT ALL NECESSARY MATERIALS AND LABOUR ARE PROVIDED TO COMPLETE ALL THE WORK IN ACCORDANCE WITH THE INTENT OF THESE DRAWINGS AND SPECIFICATIONS. NO EXCEPTIONS SHALL BE MADE FOR FAILING TO DO SO.
6. CONTRACTOR TO ERECT HOARDINGS WALLS ONLY AS REQUIRED TO MAINTAIN SECURITY AND EXISTING ROUTES. DESIGN, DETAILING, CONSTRUCTION OF HOARDING, MUST CONFORM TO THE BUILDING CODES, OCCUPATIONAL HEALTH AND SAFETY ACT AND REGULATION.
7. CONTRACTOR TO THOROUGHLY CLEAN ALL SURFACES WITHIN THE WORK AND ADJACENT AREAS AND REMOVE ALL CONSTRUCTION DEBRIS PRIOR TO COMPLETION.
8. CONTRACTOR TO FOLLOW CLIENT (COW) POLICIES AND PROCEDURES, AS WELL AS, CSA STANDARDS DURING DEMOLITION/RENOVATION/CONSTRUCTION PHASES.
9. ALL FIRE RATED ASSEMBLIES SHALL BE MAINTAINED. NEW CONSTRUCTION, REQUIRED AFTER DEMOLITION SHALL MEET OR EXCEED THE EXISTING FIRE RATINGS.
10. CONTRACTOR IS RESPONSIBLE FOR VERIFYING ALL DIMENSIONS AND EXISTING CONSTRUCTION. SHOULD A DISCREPANCY ON EITHER BE FOUND, REPORT FINDINGS TO DEPARTMENTAL REPRESENTATIVE.

P2 DEMOUNTABLE GYPSUM PARTITION SYSTEM:
FROM FLOOR TO U/S OF STRUCTURE
(CONCRETE SLAB) UNLESS NOTED OTHERWISE

- 1 LAYER 12.7mm GYPSUM BOARD PANEL
- 92mm METAL STUD FRAMING @ 400mm o/c
- 75mm ACOUSTICAL INSULATION (45 STC RATING MIN.)
- 1 LAYER 12.7mm GYPSUM BOARD PANEL

 HATCH TONE AREA DENOTES
- NOT IN CONTRACT (N.I.C.)


 EXISTING PARTITION/
STRUCTURES TO REMAIN

EXISTING DOOR AND FRAME
TO REMAIN


NEW/RELOCATED DOOR AND FRAME

A horizontal graphic scale bar. It is divided into segments. The first segment from the left is further subdivided into five smaller parts. Above the bar, the labels '0', '1m', '5m', and '10m' are positioned at the corresponding tick marks. To the right of the bar, the text '1:100' indicates the scale.



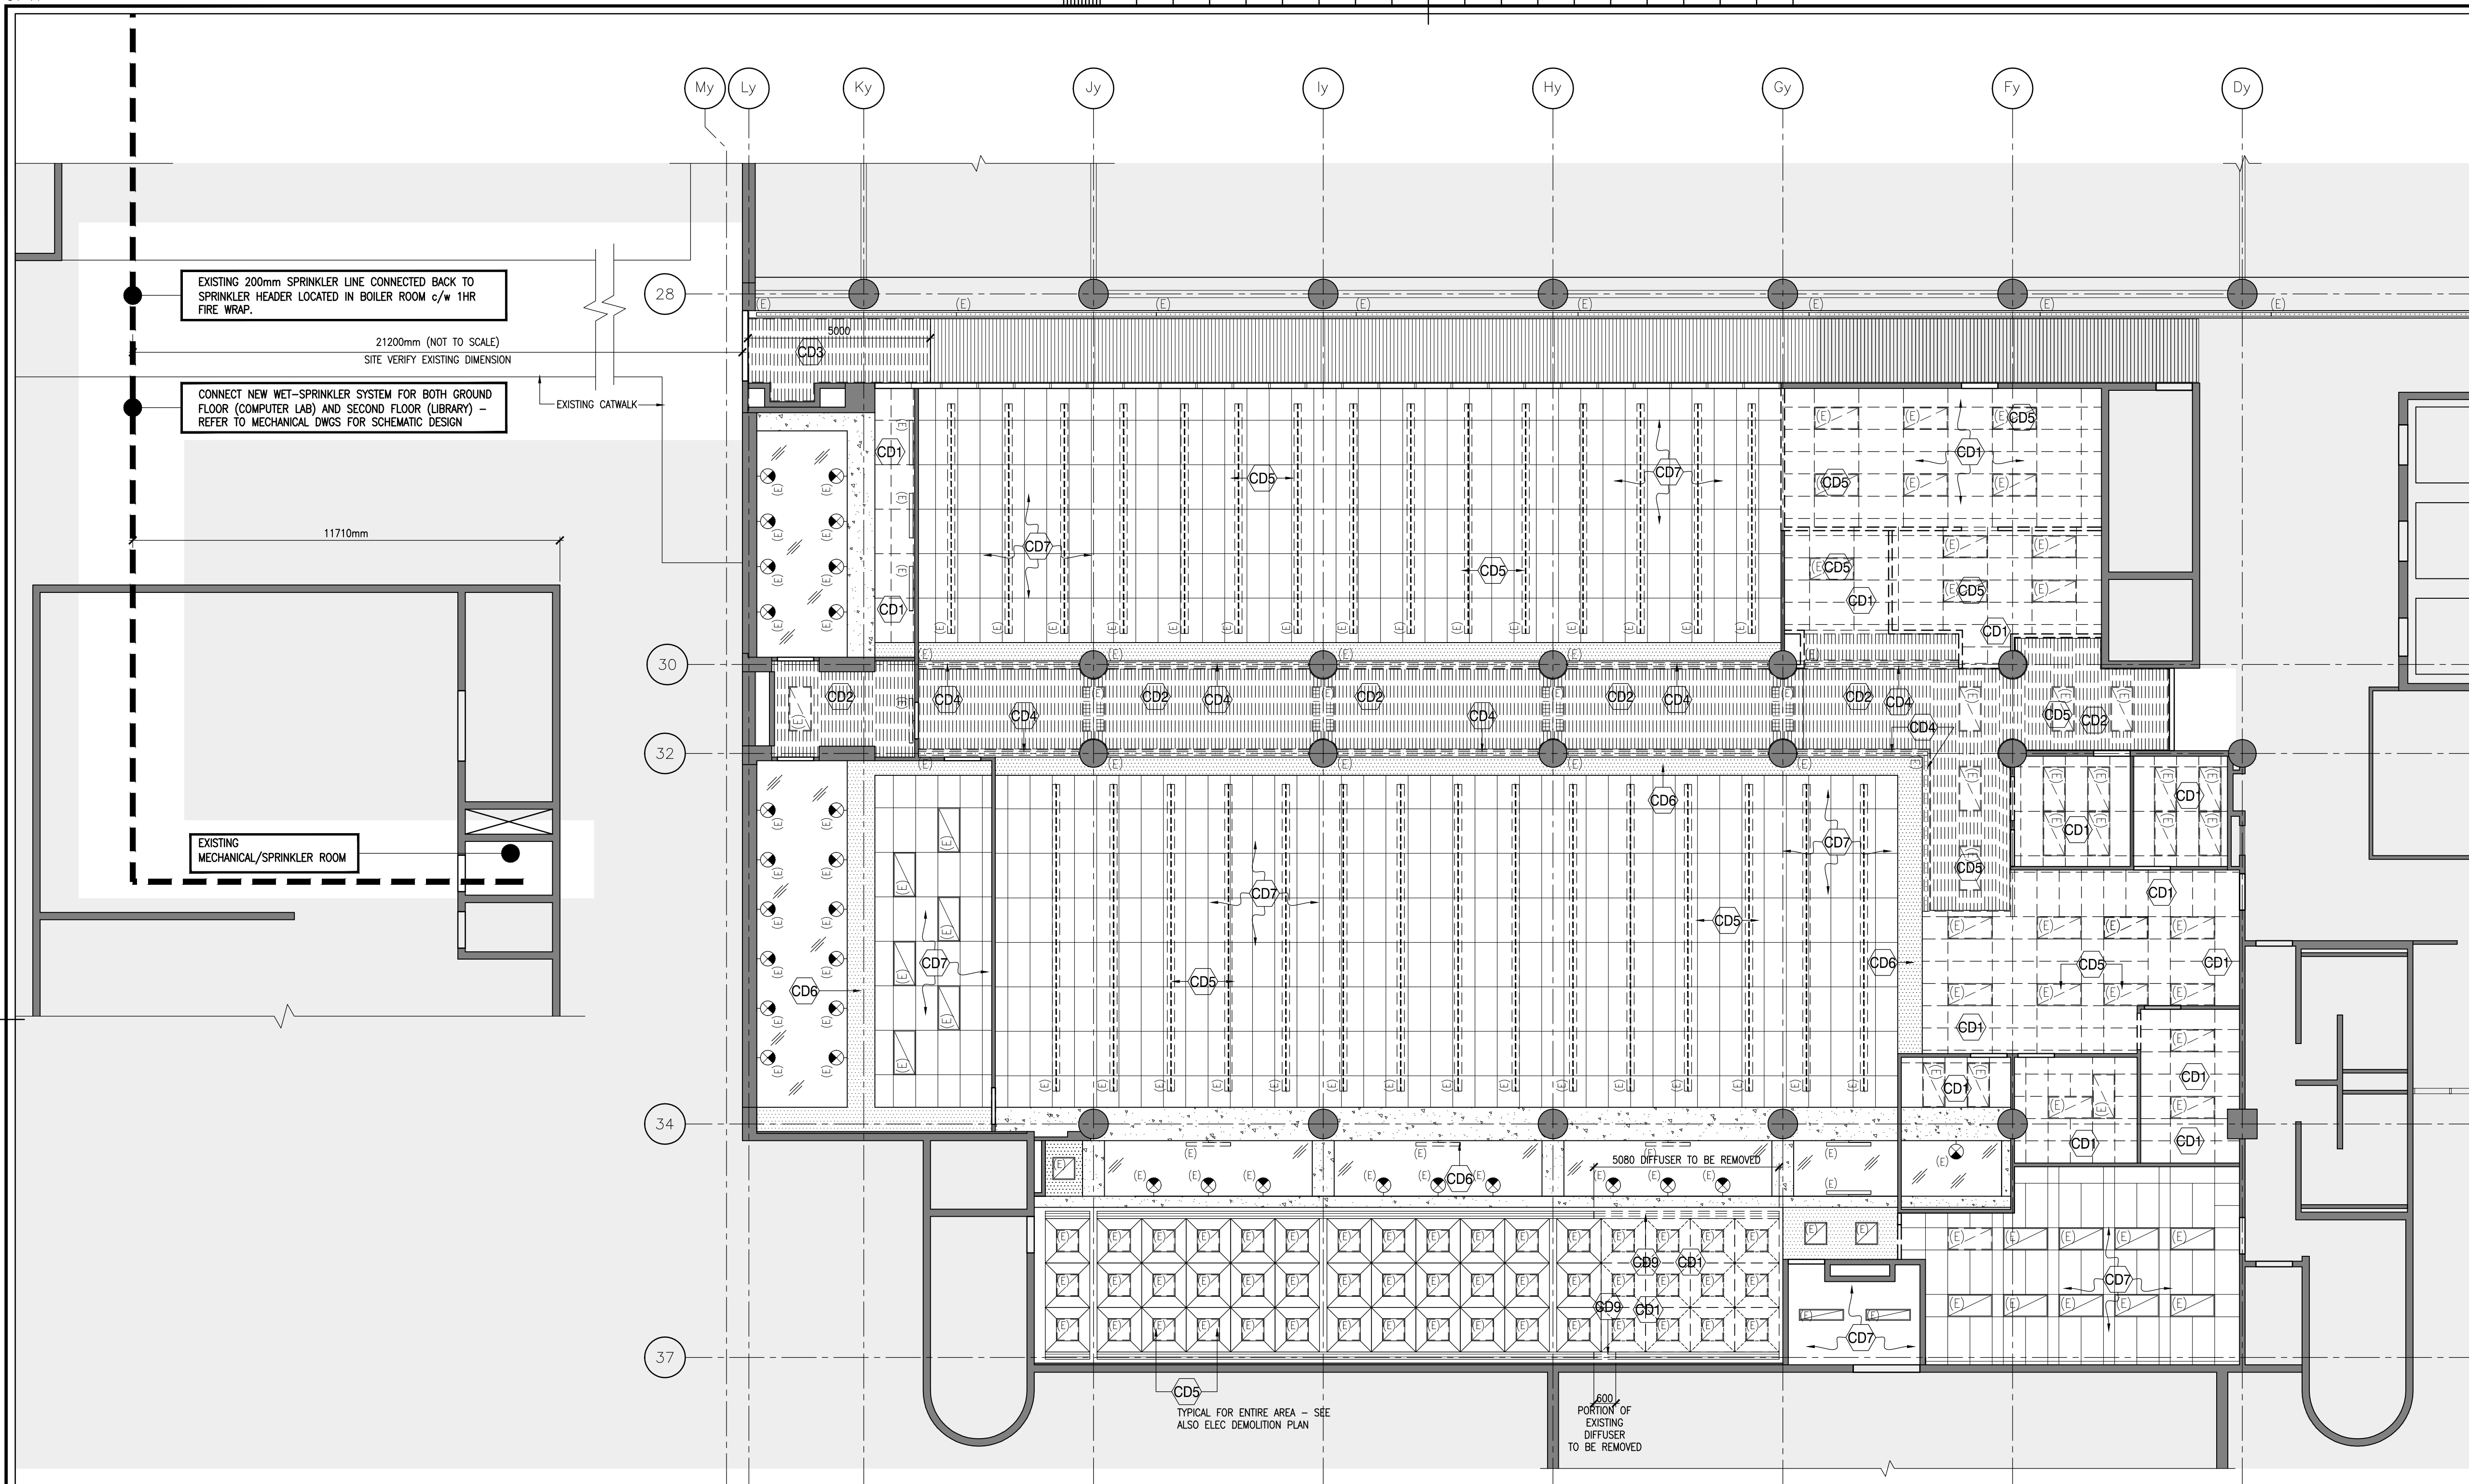

- CD1 DEMOLISH EXISTING ACT CEILING ASSEMBLY; TILE, T-BAR, INCLUDING LIGHTS AND DIFFUSERS TO ACCOMMODATE NEW WORK - REUSE EXISTING HANGERS FOR NEW ASSEMBLY WHERE POSSIBLE
- CD2 DEMOLISH EXISTING WOOD SLAT CEILING ASSEMBLY INCLUDING LIGHTS AND DIFFUSERS TO ACCOMMODATE NEW WORK
- CD3 REMOVE SECTION OF EXISTING WOOD SLAT CEILING ASSEMBLY TO ACCOMMODATE INSTALLATION OF NEW SPRINKLER SERVICES - SAFELY STORE AND PROTECT WOOD SLATS. UPON COMPLETION OF SPRINKLER WORK REINSTALL IN ORIGINAL POSITION. CONTRACTOR WILL BE RESPONSIBLE FOR REPLACING DAMAGED WOOD SLATS DURING THE PROCESS.
- CD4 DEMOLISH EXISTING DRYWALL COVE AND LIGHT FIXTURES TO ACCOMMODATE NEW WORK
- CD5 DEMOLISH EXISTING ELECTRICAL/MECHANICAL DEVICES AND ALL RELATED COMPONENTS (SEE ALSO MECH. AND ELEC. DEMOLITION DWGS.)
- CD6 EXISTING BULKHEAD TO REMAIN
- CD7 CONTRACTOR TO TAKE DOWN EXISTING ACOUSTIC CEILING ASSEMBLY WHERE CEILING ACCESS IS REQUIRED TO COMPLETE WORK - REMOVE CEILING TILES, T-BAR AND ANY ASSOCIATED COMPONENTS, INCLUDING LIGHT FIXTURES, MECH. DIFFUSERS TO ACCOMMODATE INSTALLATION OF NEW SERVICES IN THE CEILING SPACE (SEE ALSO TO MECH. AND ELEC. DWGS.). SAFELY STORE AND PROTECT CEILING TILES/CEILING T-BAR/LIGHT FIXTURES/MECH. DIFFUSER. UPON COMPLETION OF WORK REINSTALL IN ORIGINAL POSITIONS. CONTRACTOR WILL BE RESPONSIBLE FOR REPLACING DAMAGED CEILING TILES/CEILING T-BAR/LIGHT FIXTURES/MECH. DIFFUSER DURING THE PROCESS.
- CD8 PROVIDE THE NECESSARY PROTECTION TO EXISTING MOBILE FILE STORAGE SYSTEM. CONTRACTOR SHALL BE RESPONSIBLE FOR ANY DAMAGES CAUSED DURING CONSTRUCTION
- CD9 DEMOLISH SECTION OF EXISTING LINEAR DIFFUSER AS SHOWN (SEE ALSO MECH. DWGS.)

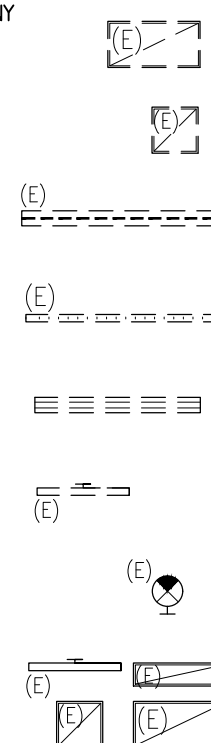

- EXISTING FLUORESCENT LIGHT FIXTURE TO BE REMOVED (REFER TO ELEC. DWGS.)
- EXISTING FLUORESCENT LIGHT FIXTURE TO BE REMOVED (REFER TO ELEC. DWGS.)
- EXISTING SUSPENDED LIGHT FIXTURES TO BE REMOVED (REFER TO ELEC. DWGS.)
- EXISTING COVE LIGHT FIXTURES TO BE REMOVED (REFER TO ELEC. DWGS.)
- PORTION OF EXISTING LINEAR DIFFUSER TO BE REMOVED (REFER TO MECH. DWGS.)
- EXISTING WALL MOUNTED LIGHT FIXTURES TO BE REMOVED (REFER TO ELEC. DWGS.)
- EXISTING LIGHT FIXTURES TO REMAIN - RE-LAMP PER INSTRUCTION OF ELEC. DWGS.
- EXISTING FLUORESCENT LIGHT FIXTURES TO REMAIN (REFER TO ELEC. DWGS.)

- HATCH TONE AREA DENOTES - NOT IN CONTRACT (N.I.C.)
- EXISTING WOOD SLAT CEILINGS TO REMAIN
- EXISTING BULKHEAD TO REMAIN
- EXISTING WALL TO BE DEMOLISH (REFER TO FLOOR PLANS)

- EXPOSED CONCRETE EXISTING STRUCTURE
- EXISTING DROP CEILING TO BE DEMOLISH INCLUDING METAL GRID T's
- EXISTING WOOD SLAT CEILINGS TO BE DEMOLISH
- EXISTING PARTITION/STRUCTURES TO REMAIN

DEMOLITION RCP NOTES AND LEGEND:

REFLECTED CEILING DEMOLITION NOTES:

- DEMOLITION DRAWINGS ARE PROVIDED TO INDICATE THE GENERAL EXTENT OF DEMOLITION WORK AND AS SUCH DO NOT NECESSARILY INDICATE THE ENTIRE SCOPE OF THE DEMOLITION WORK. THE EXTENT OF THE DEMOLITION WORK WILL BE THAT WHICH IS NECESSARY TO COMPLETE THE WORK AS DESCRIBED BY THE CONTRACT DOCUMENTS (SEE ALSO DEMOLITION SPECIFICATIONS)
- REFER TO SPECIFICATIONS FOR "DSHMSR" DESIGNATED SUBSTANCES AND HAZARDOUS MATERIALS SURVEY REPORT - FOR REQUIRED REMOVAL AND ABATEMENT PROCEDURES AT ALL LOCATIONS WHERE DESIGNATED SUBSTANCES AND HAZARDOUS MATERIALS ARE DISTURBED BY NEW CONSTRUCTION/ DEMOLITION OR ARE TO BE REMOVED
- PROTECT ADJACENT PROPERTY AGAINST DAMAGES WHICH MIGHT OCCUR FROM FALLING DEBRIS OR OTHER CAUSES. MAKE GOOD ALL DAMAGE AND FINISHES CAUSED BY DOING THIS WORK.
- CONTRACTOR TO COORDINATE DEMOLITION WITH ALL DISCIPLINES, AND ALL ASSOCIATED TRADES. ALSO COMPLETE DEMOLITION IN ACCORDANCE WITH BUILDING CODES, CONSTRUCTION SAFETY ACT AND AUTHORITIES HAVING JURISDICTION AND ABIDE BY ALL REQUESTS BY SUCH AUTHORITIES WITHOUT ADDITIONAL COST TO THE CLIENT.
- CONTRACTOR TO REFER TO ELECTRICAL AND MECHANICAL DRAWINGS FOR THE RECONFIGURATION OF HVAC, THERMOSTATS, ELECTRICAL CIRCUITS, LIFE SAFETY DEVICES AND EXIT SIGNS.
- MAKE GOOD ALL BASE BUILDING COMPONENTS THAT ARE TO REMAIN.
- CONTRACTOR SHALL REPAIR AND MAKE GOOD ANY AND ALL EXISTING FIREPROOFING DAMAGED BY DEMOLITION.
- ALL DEBRIS AND MATERIALS REMOVED FROM AREAS OF THE WORK SHALL BE DONE SO IN COVERED CONTAINERS. CONTRACTOR SHALL COORDINATE REMOVAL ROUTE WITH CLIENT (CCIW)
- DISCONNECT, REMOVE AND/OR RELOCATE ALL EXISTING ELECTRICAL, MECHANICAL AND COMMUNICATION SERVICES EXPOSED DUE TO DEMOLITION. ALL ABANDONED PENETRATIONS TO BE FILLED SOLID WITH NON-SHRINK GROUT OR FIRE RETARDANT STOP IF LOCATED ON AN EXISTING FIRE SEPARATION (SEE ALSO ELEC. AND MECH. DEMOLITION DWGS.)
- SUPPLY AND INSTALL NEW ELECTRICAL AND MECHANICAL EQUIPMENT AS INDICATED AND AS PER ELECTRICAL AND MECHANICAL DRAWINGS, RELOCATED ANY AS INDICATED. REFER TO ELECTRICAL AND MECHANICAL DRAWINGS FOR EXACT EQUIPMENT REQUIREMENTS

0 1m 5m 10m
1:100



Public Works and
Government Services Canada
Travaux publics et
Services gouvernementaux Canada

consultant


**Reich
+ Petch** ARCHITECTS

1867 YONGE ST, STE 1100, TORONTO ON CANADA M4S 1Y5
T 416 480 2020 F 416 480 1881

3	ISSUED FOR BID	09 DEC 2013
2	ISSUED FOR 95% SUBMISSION	12 NOV 2013
1	ISSUED FOR 75% SUBMISSION	30 APR 2013

revision	date
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Do not scale drawings.
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- A Detail No.
No. du détail
B drawing no. - where detail required
dessin no. - où détail exigé
C drawing no. - where detailed
dessin no. - où détaillé

project title
titre du projet
BURLINGTON ONTARIO
CANADA CENTRE FOR INLAND WATERS
867 LAKESHORE ROAD

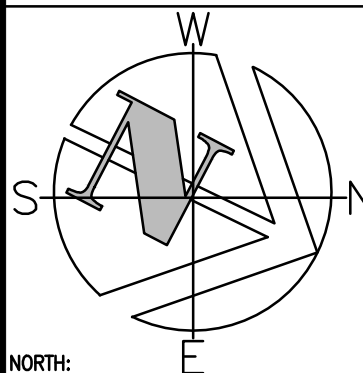LIBRARY RENOVATION

drawing title
titre du dessin

PART SECOND FLOOR - LIBRARY DEMOLITION REFLECTED CEILING PLAN

drawn by
dessiné par

R+P A

designed by
conçue par

R+P A

approved by
approuvé par

CCIW/EC/PWGSC

bid
offre

project manager
administrateur
de projets

project date
date du projet


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project no.
no. du projet

R.061475.001

drawing no.
dessiné no.


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3	ISSUED FOR BID	09 DEC 2013
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revision	date
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	drawing no. - where detailed dessin no. - où détaillé

project title
titre du projet
BURLINGTON ONTARIO
CANADA CENTRE FOR INLAND WATERS
867 LAKESHORE ROAD

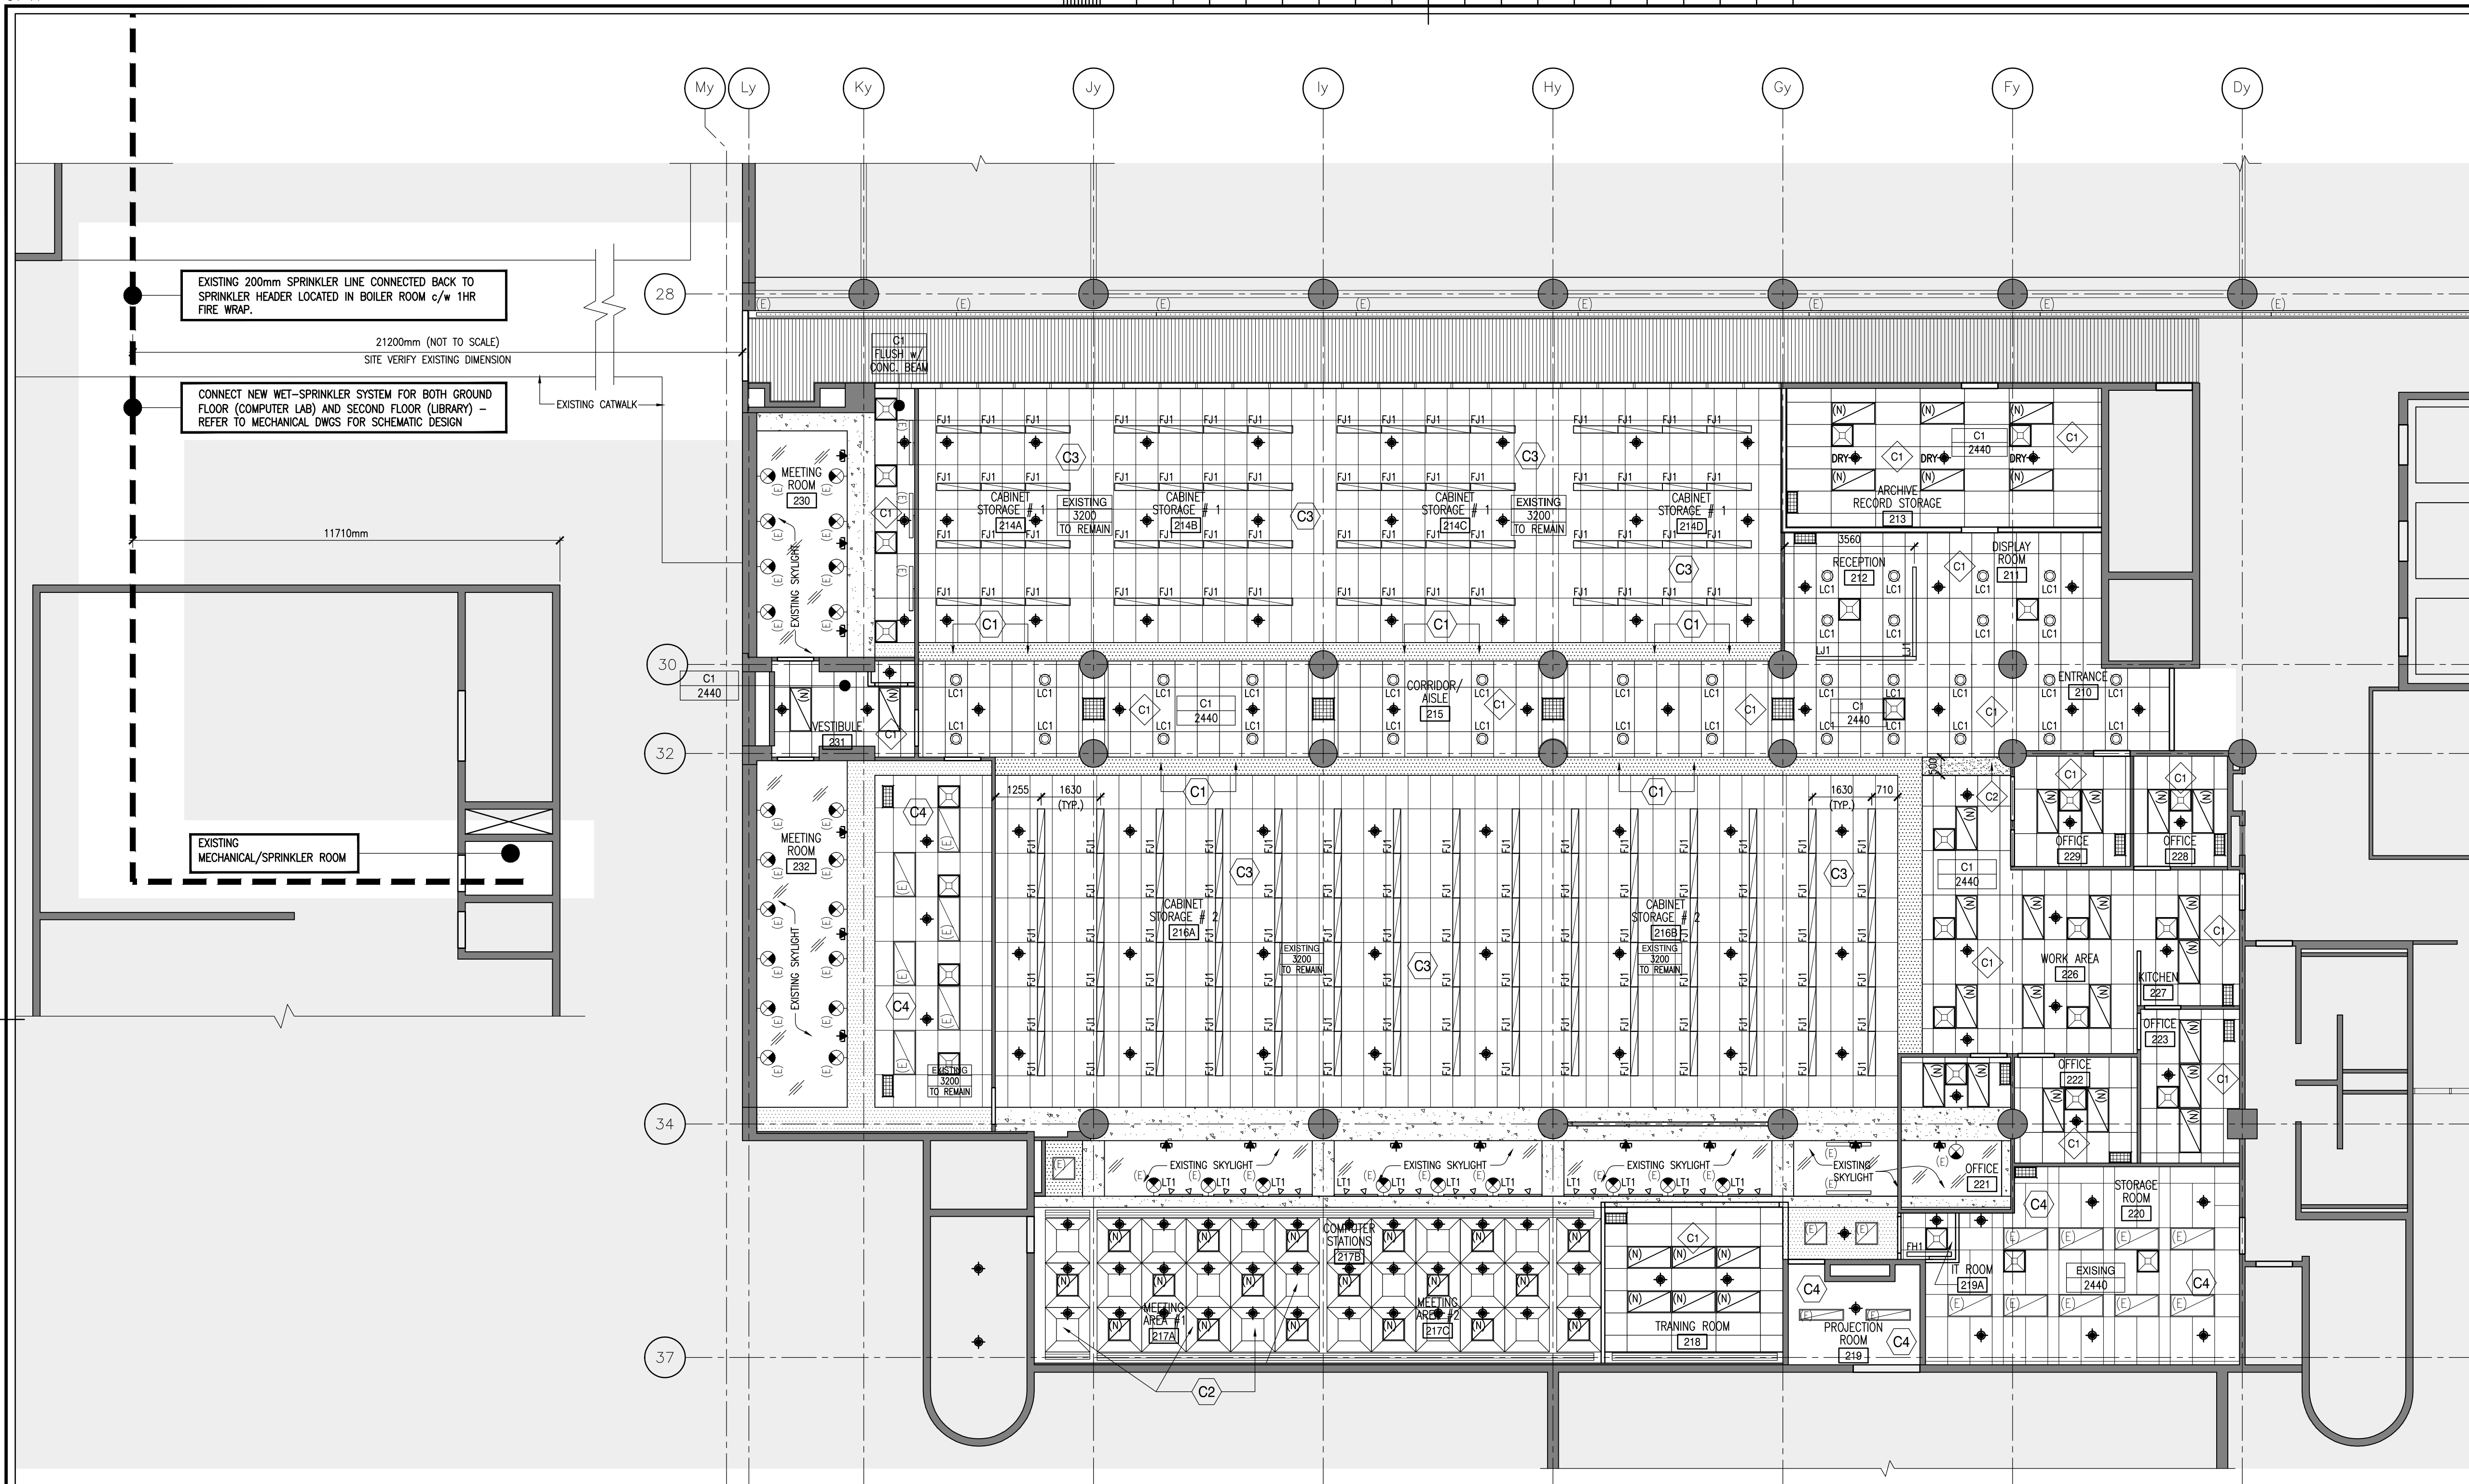LIBRARY RENOVATION

drawing title
titre du dessin
**PART SECOND FLOOR -
LIBRARY NEW WORK
REFLECTED CEILING PLAN**

drawn by
dessiné par
R+P A

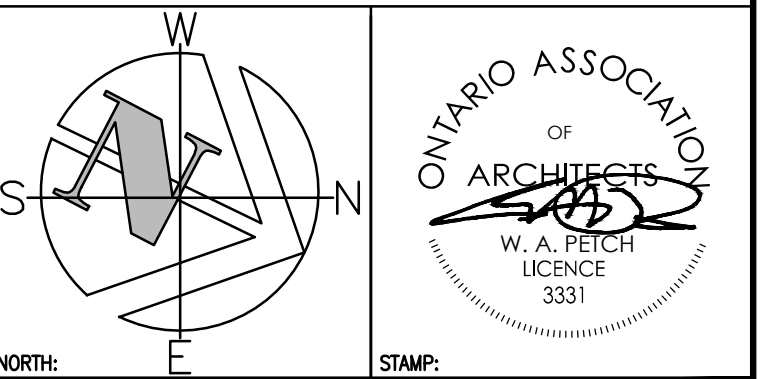designed by
conc par
R+P A

approved by
approve par
CCW/EC/PWGSC

bid
offre
project manager
administrateur de projets

project date
date du projet
2013-02-20

project no.
no. du projet
R.061475.001


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NEW LIBRARY REFLECTED CEILING PLAN NOTES AND LEGEND:


NEW LIBRARY REFLECTED CEILING NOTES:

- THIS DRAWING TO BE READ IN CONJUNCTION WITH MECHANICAL AND ELECTRICAL DRAWINGS.
- FOR LOCATION ON EXISTING/NEW SPRINKLERS, SPEAKERS, SENSORS, AND OTHER M&E CEILING FIXTURES PLEASE REFER TO MECHANICAL AND ELECTRICAL DRAWINGS.
- CONTRACTOR TO MAKE GOOD METAL CEILING GRID WHERE PARTITION RUNS THROUGH FROM FLOOR TO U/S CONCRETE SLAB.
- CONTRACTOR TO ENSURE EXISTING CEILINGS / BULKHEADS ARE PATCHED WHERE VISIBLY DAMAGED OR SURFACE DEFECTS EXIST AND PREPARE TO RECEIVE NEW FINISHES.
- ALL ABANDONED PENETRATIONS TO BE FILLED WITH SOLID NON-SHRINK GROUT OR FIRE RETARDANT SYSTEM AT FIRE SEPARATIONS.
- CONTRACTOR TO COORDINATE WITH ELECTRICAL AND MECHANICAL DWGS. FOR PROPER LIFE SAFETY SYSTEMS COVERAGE IE: EXIT LIGHTS, SPRINKLERS, EMERGENCY LIGHTS, ETC. ANY LIFE SAFETY SYSTEMS RELOCATION TO BE DONE IN ACCORDANCE WITH BUILDING CODE AND JURISDICTION HAVING AUTHORITY.
- CONTRACTOR TO THOROUGHLY CLEAN ALL SURFACES WITHIN THE WORK AREA AND REMOVE ALL CONSTRUCTION DEBRIS PRIOR TO COMPLETION.
- CONTRACTOR TO FOLLOW CLIENT (CCW) POLICIES AND PROCEDURES, AS WELL AS, CSA STANDARDS DURING DEMOLITION/RENOVATION/CONSTRUCTION PHASES.
- ALL FIRE RATED ASSEMBLIES SHALL BE MAINTAINED. NEW CONSTRUCTION, REQUIRED AFTER DEMOLITION SHALL MEET OR EXCEED THE EXISTING FIRE RATINGS.
- CONTRACTOR IS RESPONSIBLE FOR VERIFYING ALL DIMENSIONS AND EXISTING CONSTRUCTION. SHOULD A DISCREPANCY ON EITHER BE FOUND, REPORT FINDINGS TO DEPARTMENTAL REPRESENTATIVE.

0 1m 5m 10m
1:100

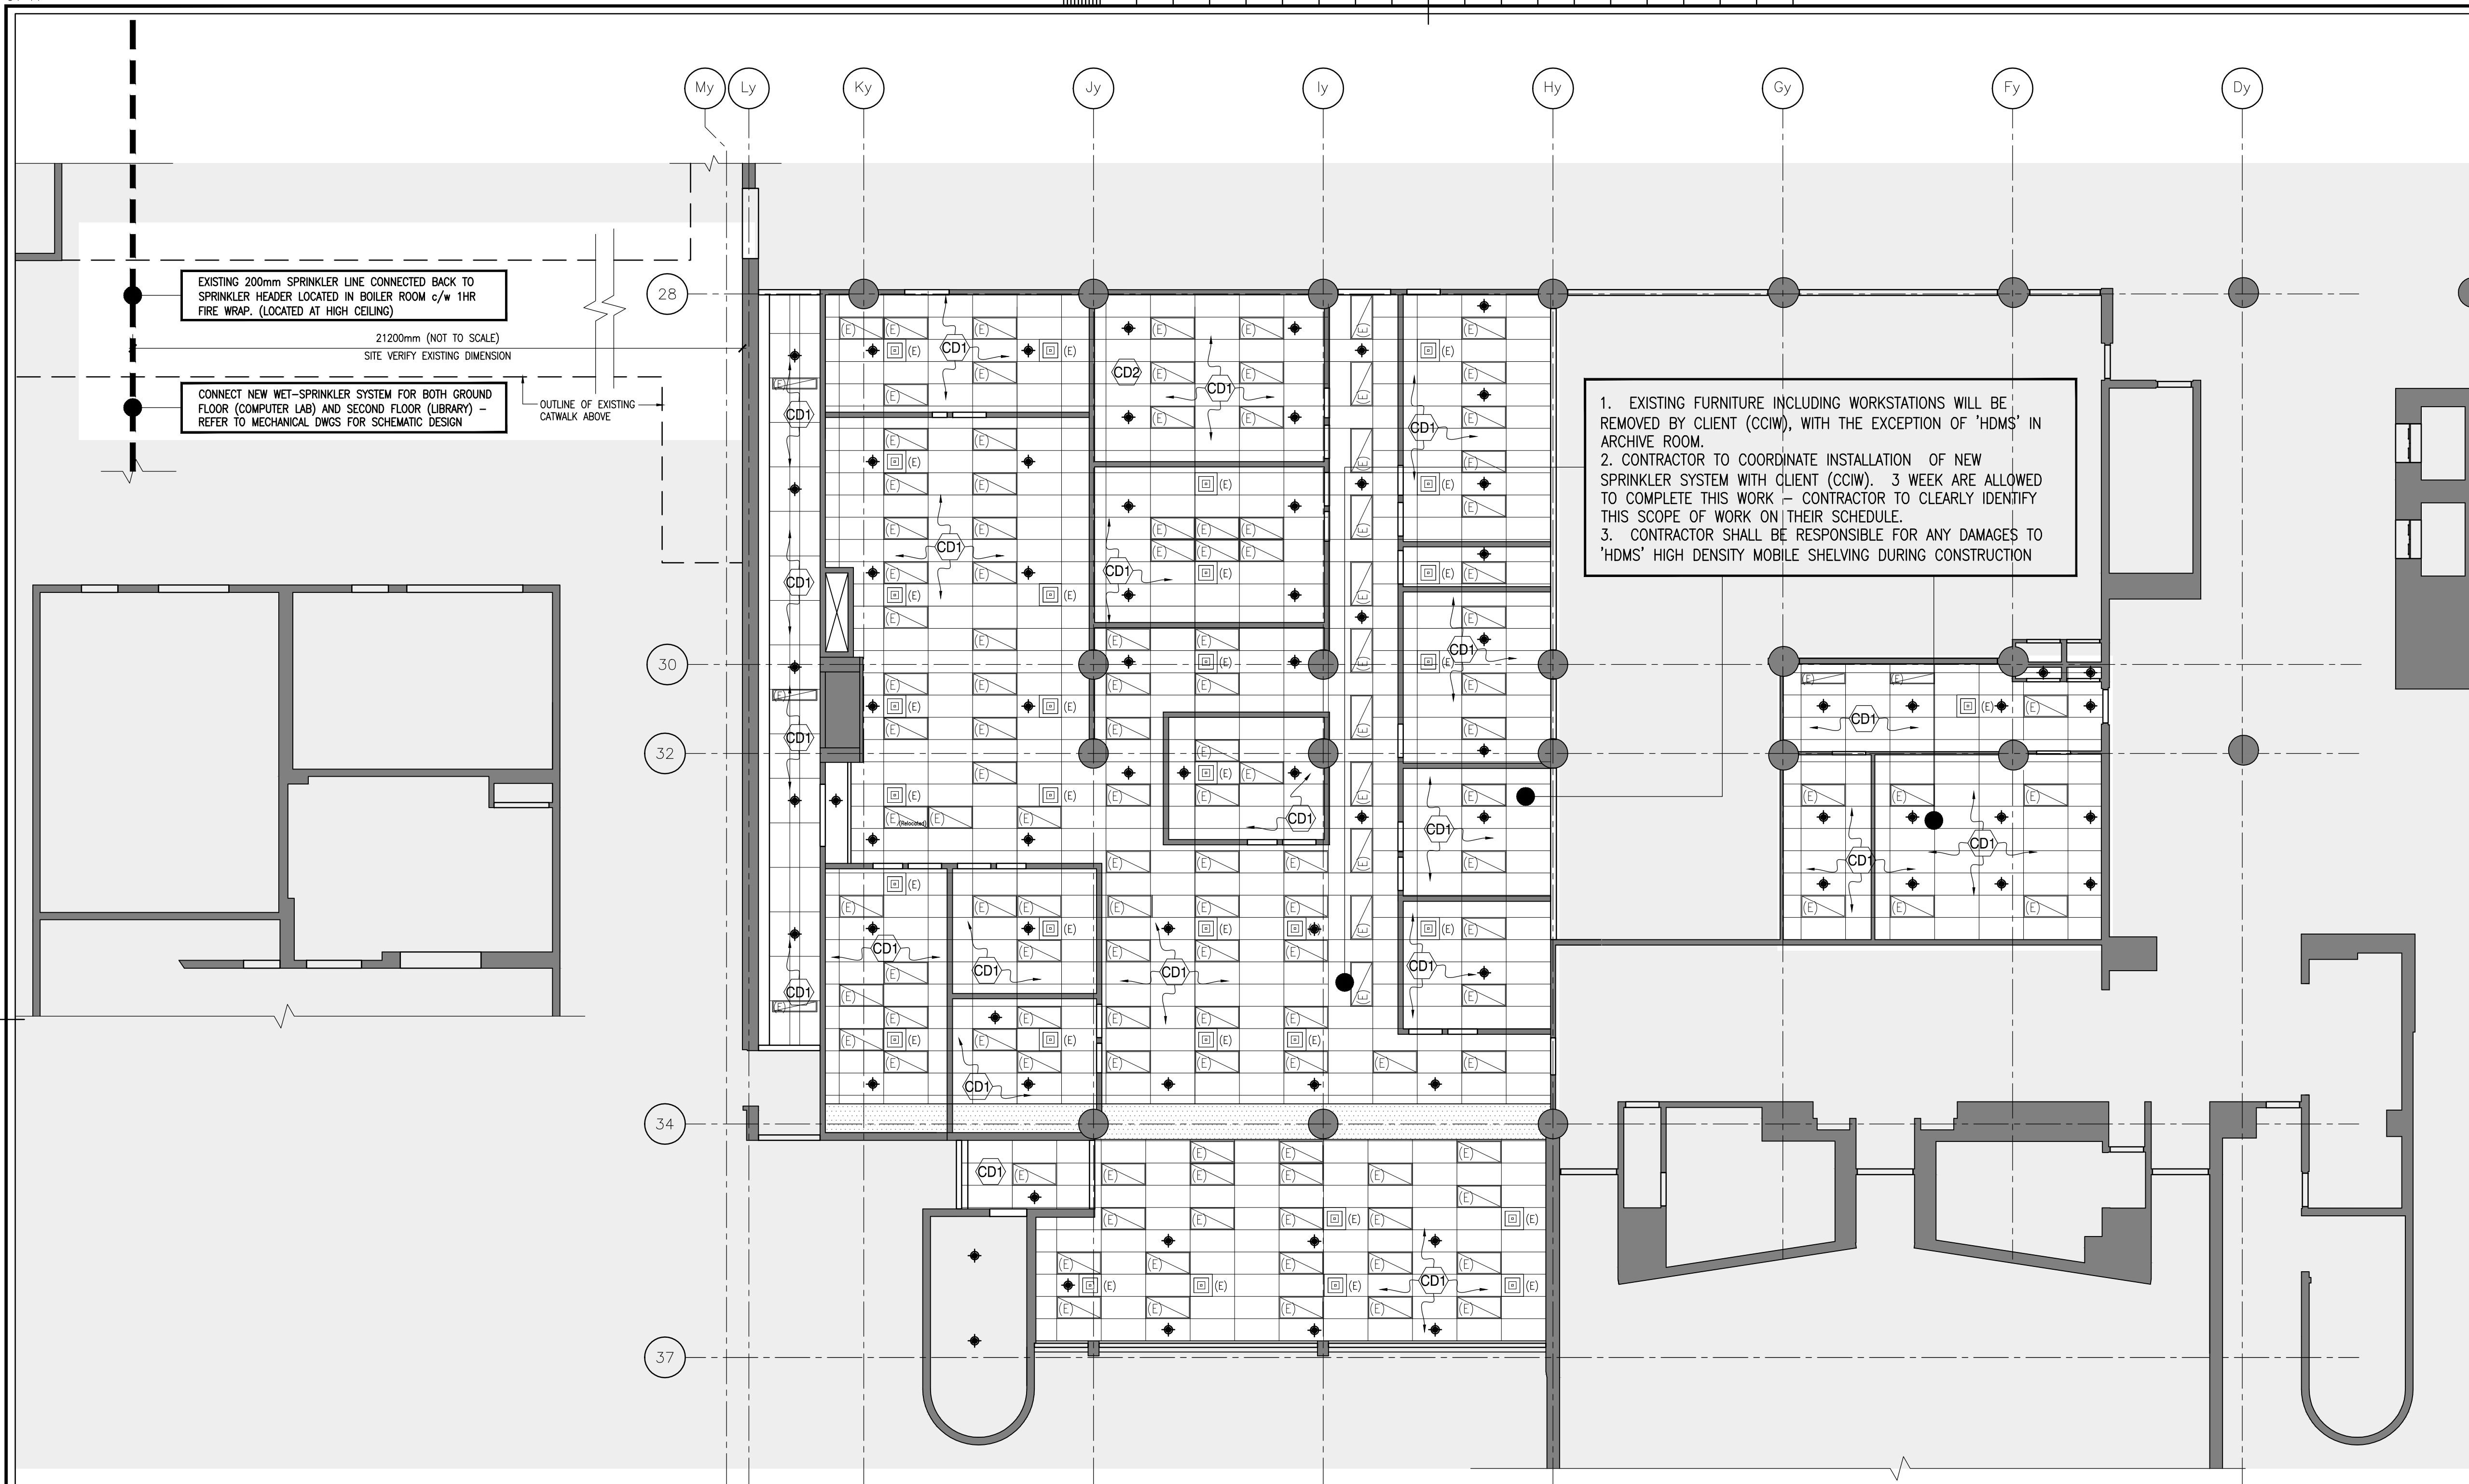

COMPUTER LAB REFLECTED CEILING PLAN NOTES AND LEGEND:

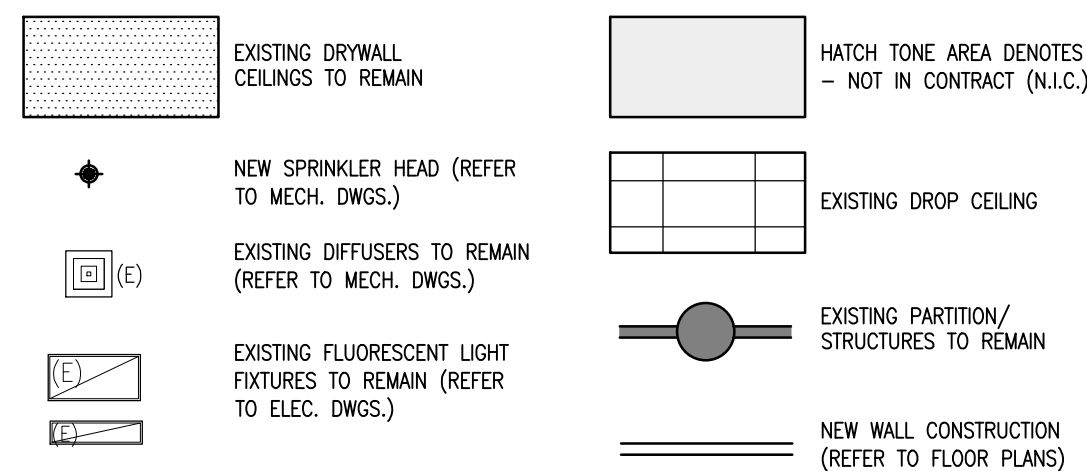

CONTRACTOR TO TAKE DOWN EXISTING ACOUSTIC CEILING ASSEMBLY WHERE CEILING ACCESS IS REQUIRED TO COMPLETE WORK - REMOVE CEILING TILES, T-BAR AND ANY ASSOCIATED COMPONENTS, INCLUDING LIGHT FIXTURES, MECH. DIFFUSERS TO ACCOMMODATE INSTALLATION OF NEW SERVICES IN THE CEILING SPACE (SEE ALSO TO MECH. AND ELEC. DWGS.). SAFELY STORE AND PROTECT CEILING TILES/CEILING T-BAR/LIGHT FIXTURES/MECH DIFFUSER. UPON COMPLETION OF WORK REINSTALL IN ORIGINAL POSITIONS, CONTRACTOR WILL BE RESPONSIBLE FOR REPLACING DAMAGED CEILING TILES/CEILING T-BAR/LIGHT FIXTURES/MECH. DIFFUSER DURING THE PROCESS.

PROVIDE THE NECESSARY PROTECTION TO 'HDS' HIGH DENSITY MOBILE SHELVING TO REMAIN IN PLACE DURING CONSTRUCTION. CONTRACTOR SHALL BE RESPONSIBLE FOR ANY DAMAGES CAUSED DURING CONSTRUCTION

COMPUTER REFLECTED CEILING NOTES:

1. THIS DRAWING TO BE READ IN CONJUNCTION WITH MECHANICAL AND ELECTRICAL DRAWINGS.
2. FOR LOCATION ON EXISTING/NEW SPRINKLERS, SPEAKERS, SENSORS, AND OTHER M&E CEILING FIXTURES PLEASE REFER TO MECHANICAL AND ELECTRICAL DRAWINGS
2. REFER TO SPECIFICATIONS FOR 'DSHMSR' DESIGNATED SUBSTANCES AND HAZARDOUS MATERIALS SURVEY REPORT - FOR REQUIRED REMOVAL AND ABATEMENT PROCEDURES AT ALL LOCATIONS WHERE DESIGNATED SUBSTANCES AND HAZARDOUS MATERIALS ARE DISTURBED BY NEW CONSTRUCTION/ DEMOLITION OR ARE TO BE REMOVED
4. CONTRACTOR TO ENSURE EXISTING CEILINGS/ BULKHEADS ARE PATCHED WHERE VISIBLY DAMAGED OR SURFACE DEFECTS EXIST AND PREPARE TO RECEIVE NEW FINISHES
5. ALL ABANDONED PENETRATIONS TO BE FILLED WITH SOLID NON-SHRINK GROUT OR FIRE RETARDANT SYSTEM AT FIRE SEPARATIONS
6. CONTRACTOR TO COORDINATE WITH ELECTRICAL AND MECHANICAL DWGS. FOR PROPER LIFE SAFETY SYSTEMS COVERAGE IE: EXIT LIGHTS, SPRINKLERS, EMERGENCY LIGHTS, ETC. ANY LIFE SAFETY SYSTEMS RELOCATION TO BE DONE IN ACCORDANCE WITH BUILDING CODE AND JURISDICTION HAVING AUTHORITY
7. CONTRACTOR TO THOROUGHLY CLEAN ALL SURFACES WITHIN THE WORK AND ADJACENT AREAS AND REMOVE ALL CONSTRUCTION DEBRIS PRIOR TO COMPLETION.
8. CONTRACTOR TO FOLLOW CLIENT (CCIW) POLICIES AND PROCEDURES, AS WELL AS, CSA STANDARDS DURING DEMOLITION/RENOVATION/CONSTRUCTION PHASES
9. ALL FIRE RATED ASSEMBLIES SHALL BE MAINTAINED. NEW CONSTRUCTION, REQUIRED AFTER DEMOLITION SHALL MEET OR EXCEED THE EXISTING FIRE RATINGS.
10. CONTRACTOR IS RESPONSIBLE FOR VERIFYING ALL DIMENSIONS AND EXISTING CONSTRUCTION. SHOULD A DISCREPANCY ON EITHER BE FOUND, REPORT FINDINGS TO DEPARTMENTAL REPRESENTATIVE.
11. MAKE GOOD ALL BASE BUILDING COMPONENTS THAT ARE TO REMAIN.

0 1m 5m 10m 1:100

consultant


**Reich
+ Petch** ARCHITECTS

1867 YONGE ST, STE 1100, TORONTO ON CANADA M4S 1Y5
T 416 480 2020 F 416 480 1881

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revision	date
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A	Detail No.
B	No. du détail
C	drawing no. - where detail required dessin no. - où détail exigé
	drawing no. - where detailed dessin no. - où détaillé

project title
titre du projet
BURLINGTON ONTARIO
CANADA CENTRE FOR INLAND WATERS
867 LAKESHORE ROAD

LIBRARY RENOVATION

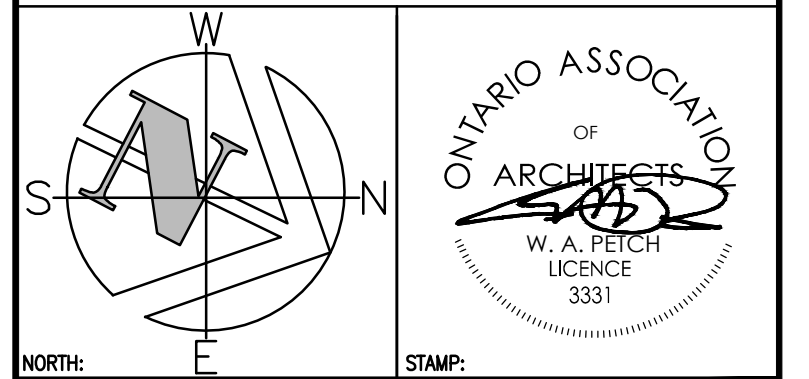drawing title
titre du dessin
**PART GROUND FLOOR -
COMPUTER LAB
REFLECTED CEILING PLAN**

drawn by
dessiné par
R+P A

designed by
conc par
R+P A

approved by
approuvé par
CCIW/EC/PWGSC

bid
offre
project manager
administrateur
de projets

project date
date du projet
2013-02-20

project no.
no. du projet
R.061475.001

drawing no.
dessiné no.
A302

consultant



1867 YONGE ST, STE 1100, TORONTO ON CANADA M4S 1Y5
T 416 480 2020 F 416 480 1881



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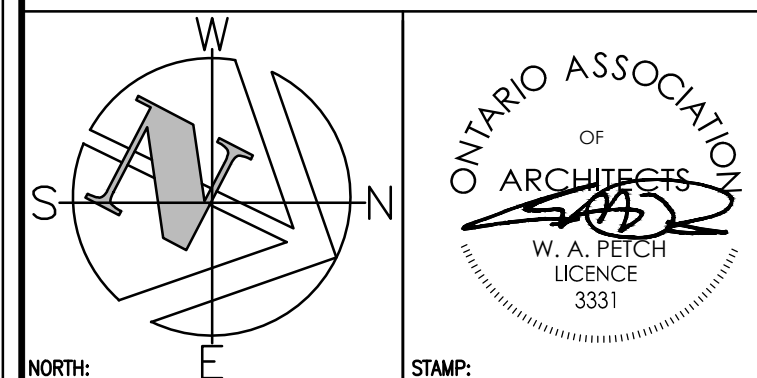


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revision	date
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A	Detail No.
B	drawing no. — where detail required
C	drawing no. — where detailed

project title
titre du projet
BURLINGTON ONTARIO
CANADA CENTRE FOR INLAND WATERS
867 LAKESHORE ROAD

LIBRARY RENOVATION

drawing title
titre du dessin
**MILLWORK —
RECEPTION DESK**

drawn by
dessiné par
R+P A

designed by
conc par
R+P A


approved by
approuvé par
CCIW/EC/PWGSC

bid
offre
project manager
administrateur
de projets


project date
date du projet
2013-02-20

project no.
no. du projet
R.061475.001


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A500

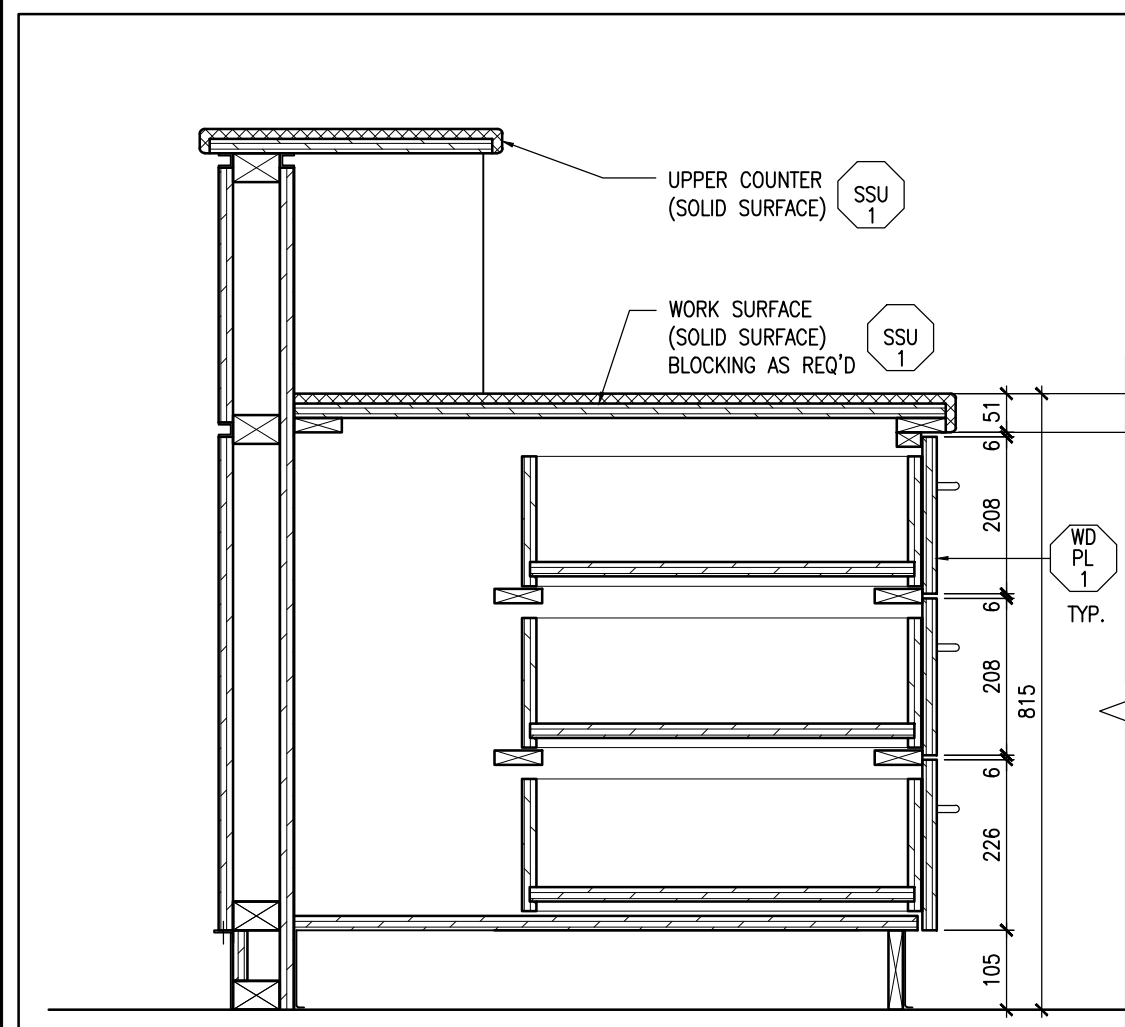

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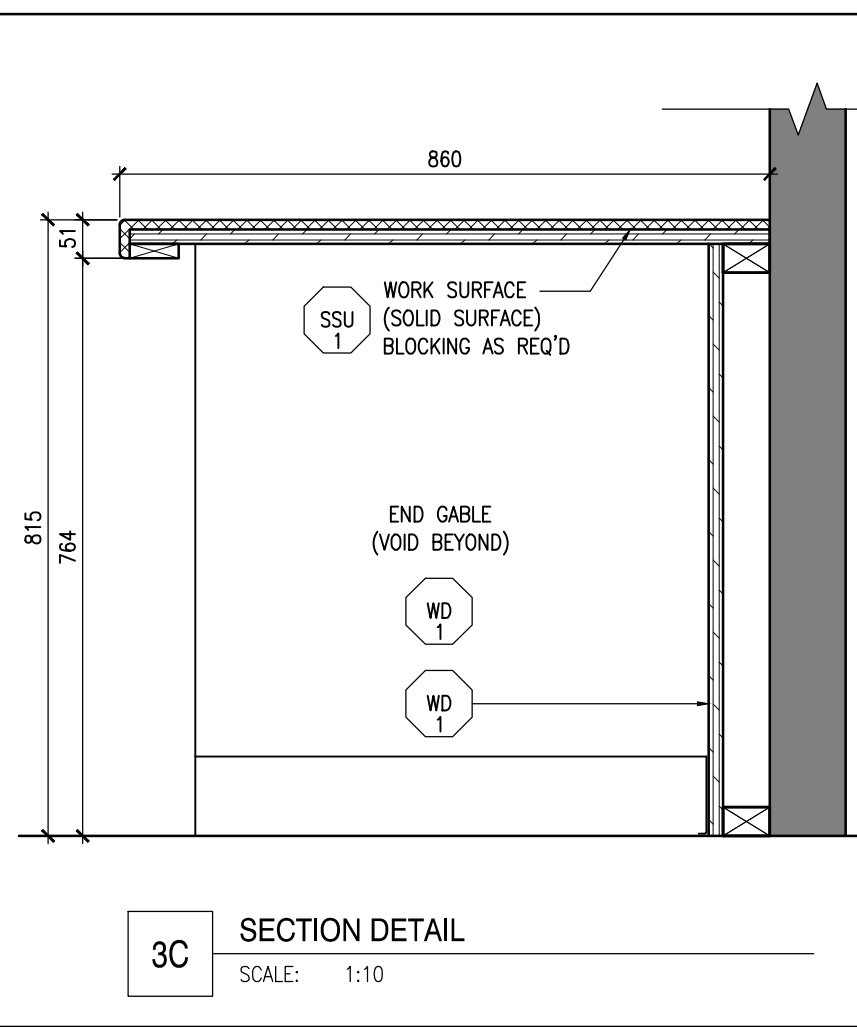

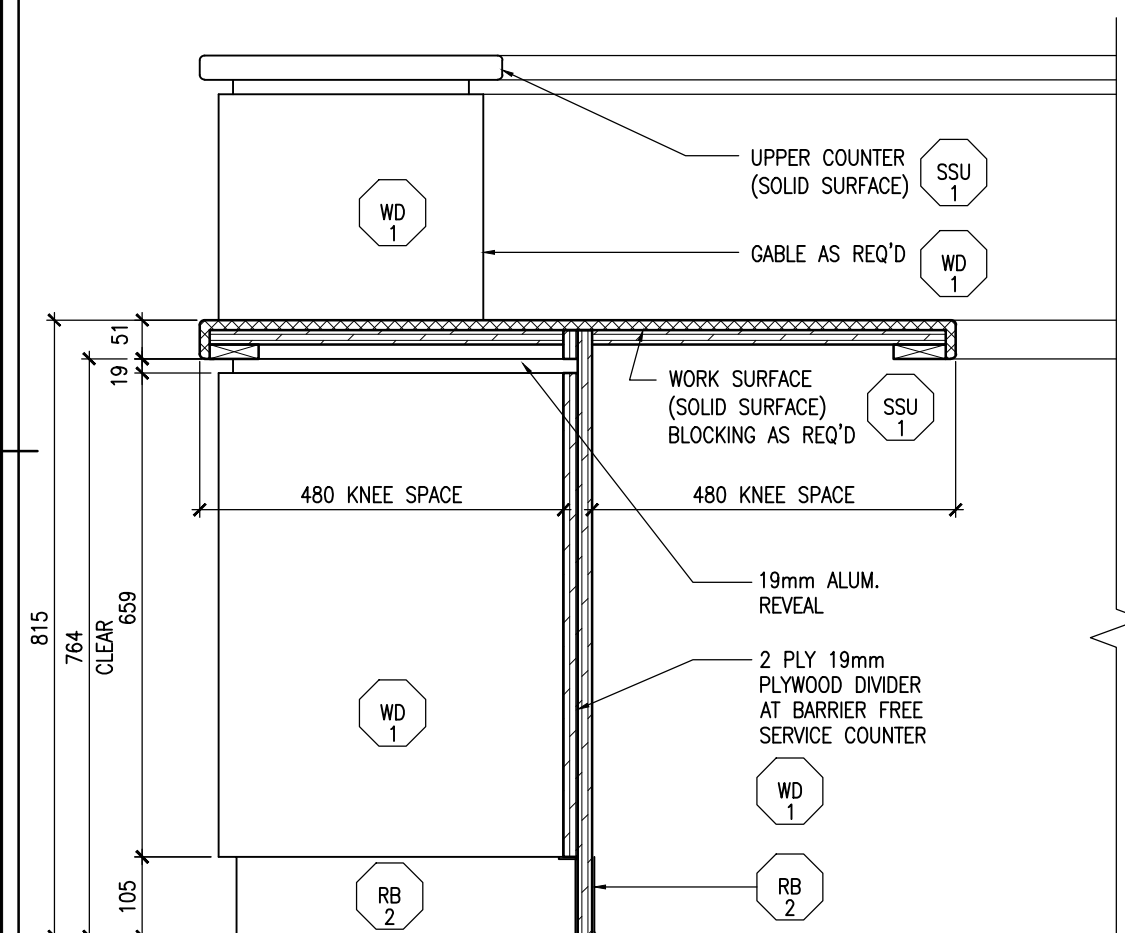
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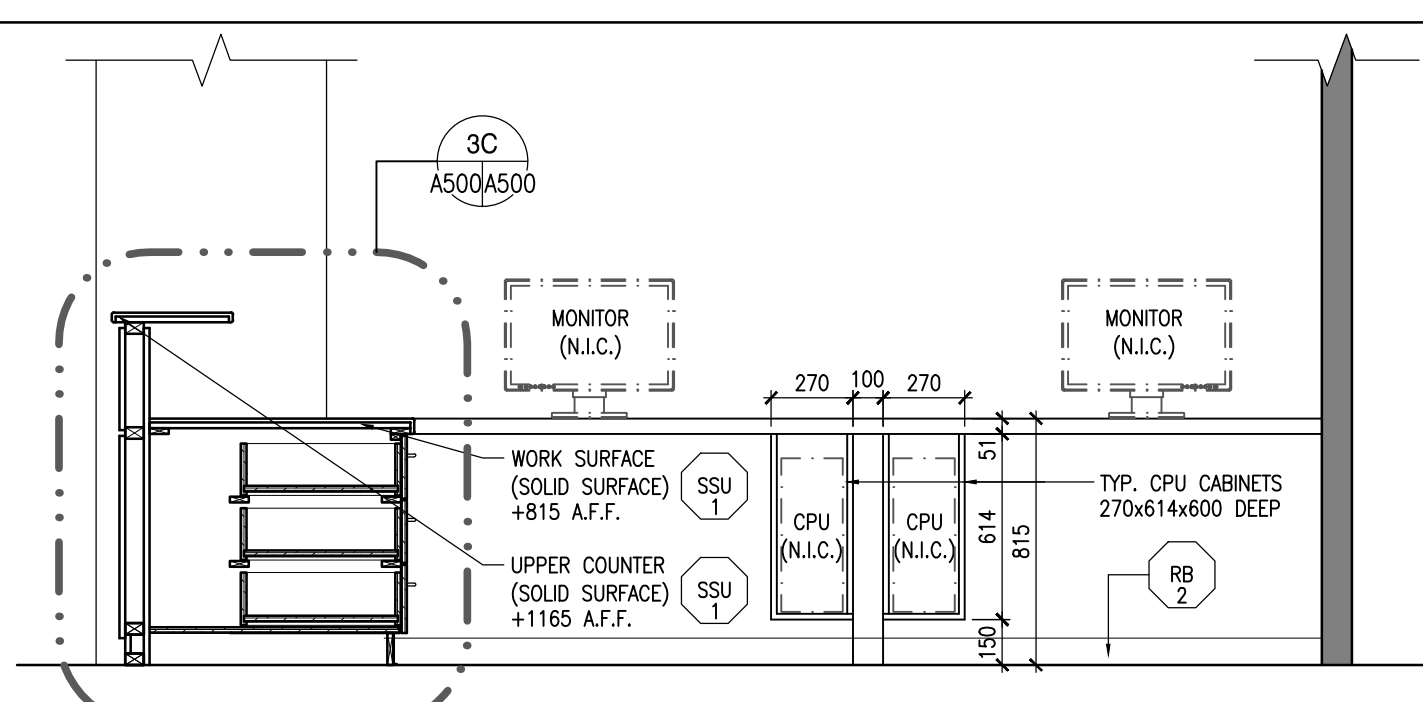


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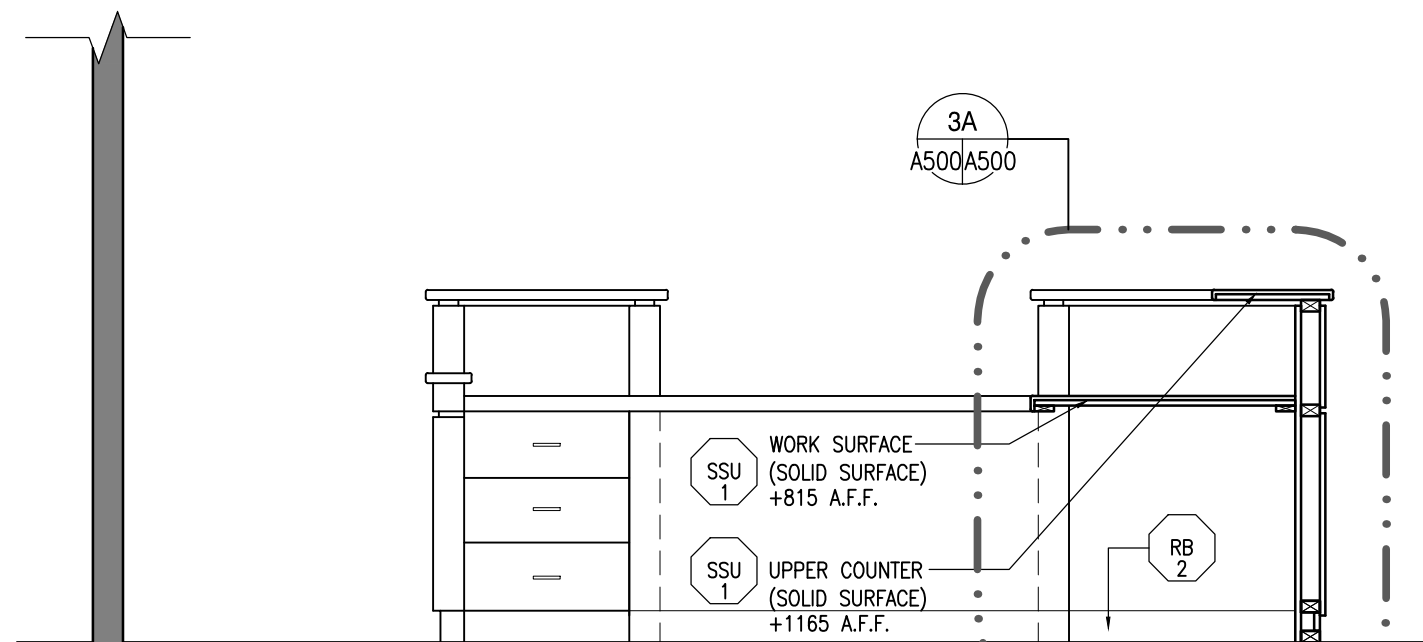
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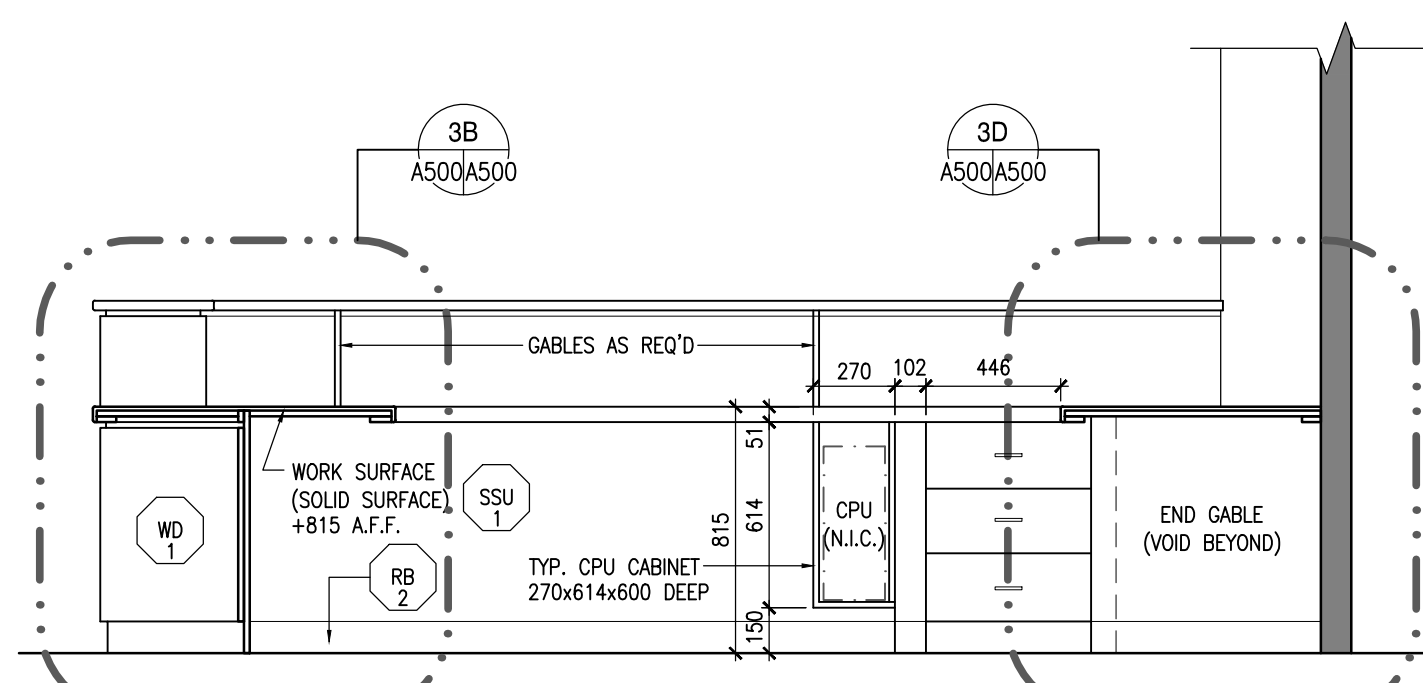
3C SECTION DETAIL
SCALE: 1:10

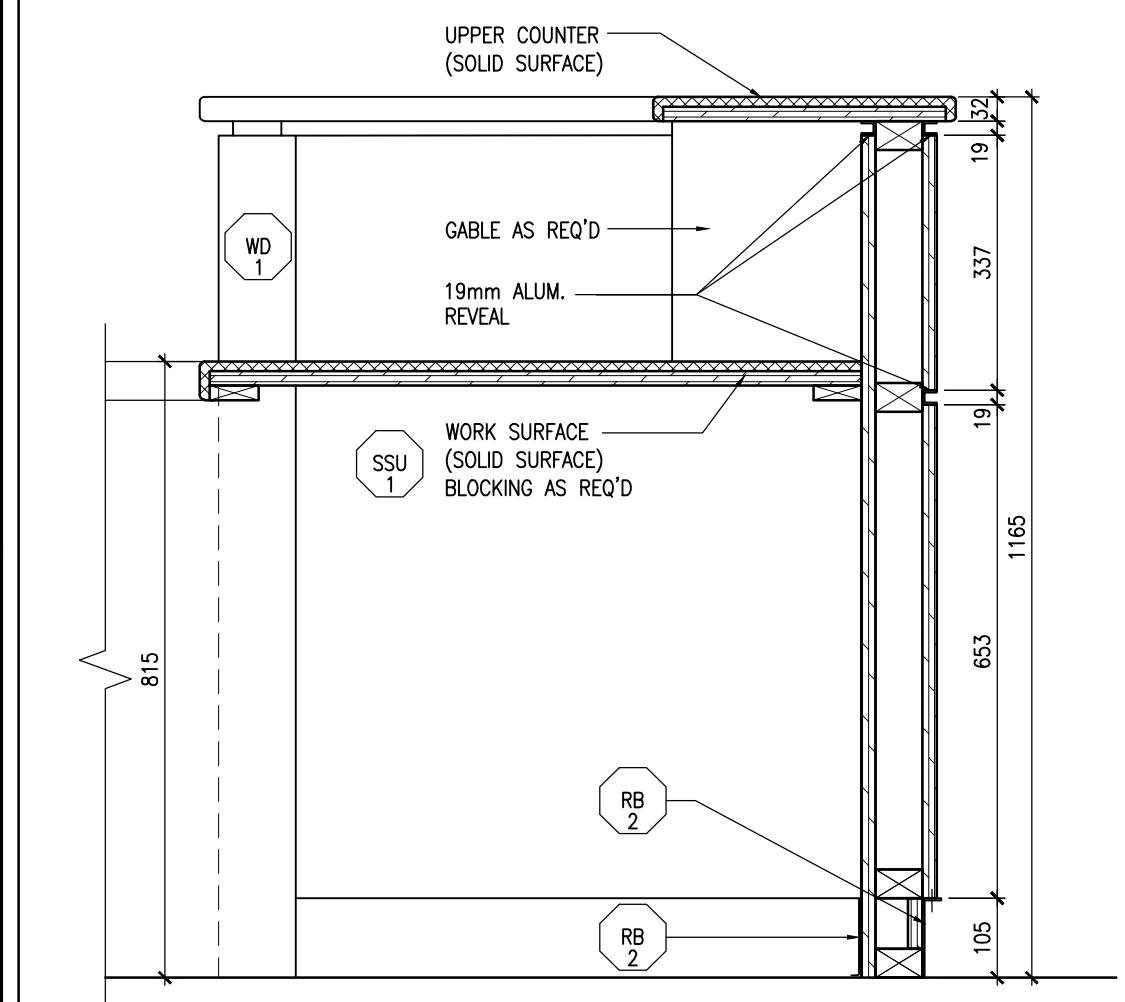

2C RECEPTION DESK SECTIONS
SCALE: 1:25



2B RECEPTION DESK SECTIONS
SCALE: 1:25




2A RECEPTION DESK SECTIONS
SCALE: 1:25

2 RECEPTION DESK SECTIONS
SCALE: AS NOTED


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TYPE: F1-9137
COLOUR: CASABLANCA
- PL 1 PRODUCT TYPE: PLASTIC LAMINATE
MANUFACTURER: WILSONART LAMINATE HD
TYPE: HD
COLOUR: 1860K-55 ROMAN LIMESTONE
- PL 2 PRODUCT TYPE: PLASTIC LAMINATE
MANUFACTURER: WILSONART LAMINATE
COLOUR: 0315-60 PLATINUM
- PL 3 PRODUCT TYPE: PLASTIC LAMINATE
MANUFACTURER: LAMIN-ART
COLOUR: 3073-VT CAPPUCCINO ASH
- RB 2 PRODUCT TYPE: RUBBER/RESILIENT WALL BASE
MANUFACTURER: -
CODE: STANDARD TOE 100mm HIGH W/ TOE
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- WD 1 PRODUCT TYPE: SOLID WOOD
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COLOUR/SPECIES: WALNUT
FINISH: FLAT

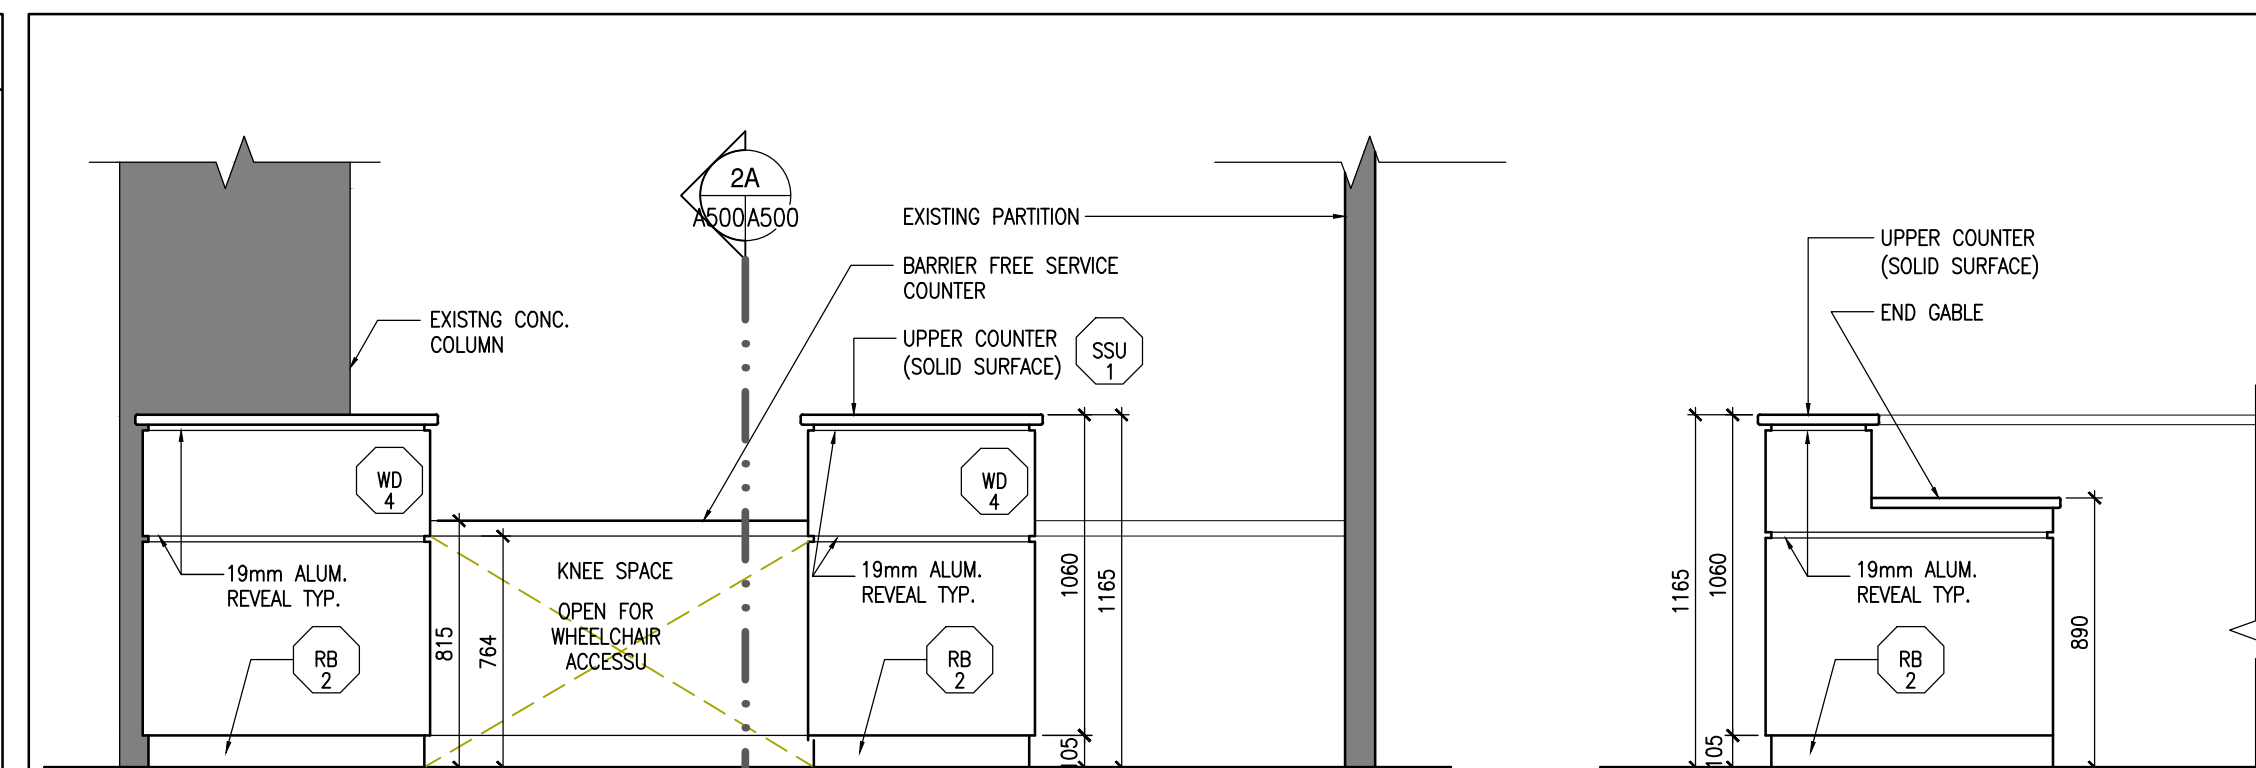


1C SIDE ELEVATION AT RECEPTION DESK
SCALE: 1:25

1D SIDE ELEVATION AT RECEPTION DESK
SCALE: 1:25


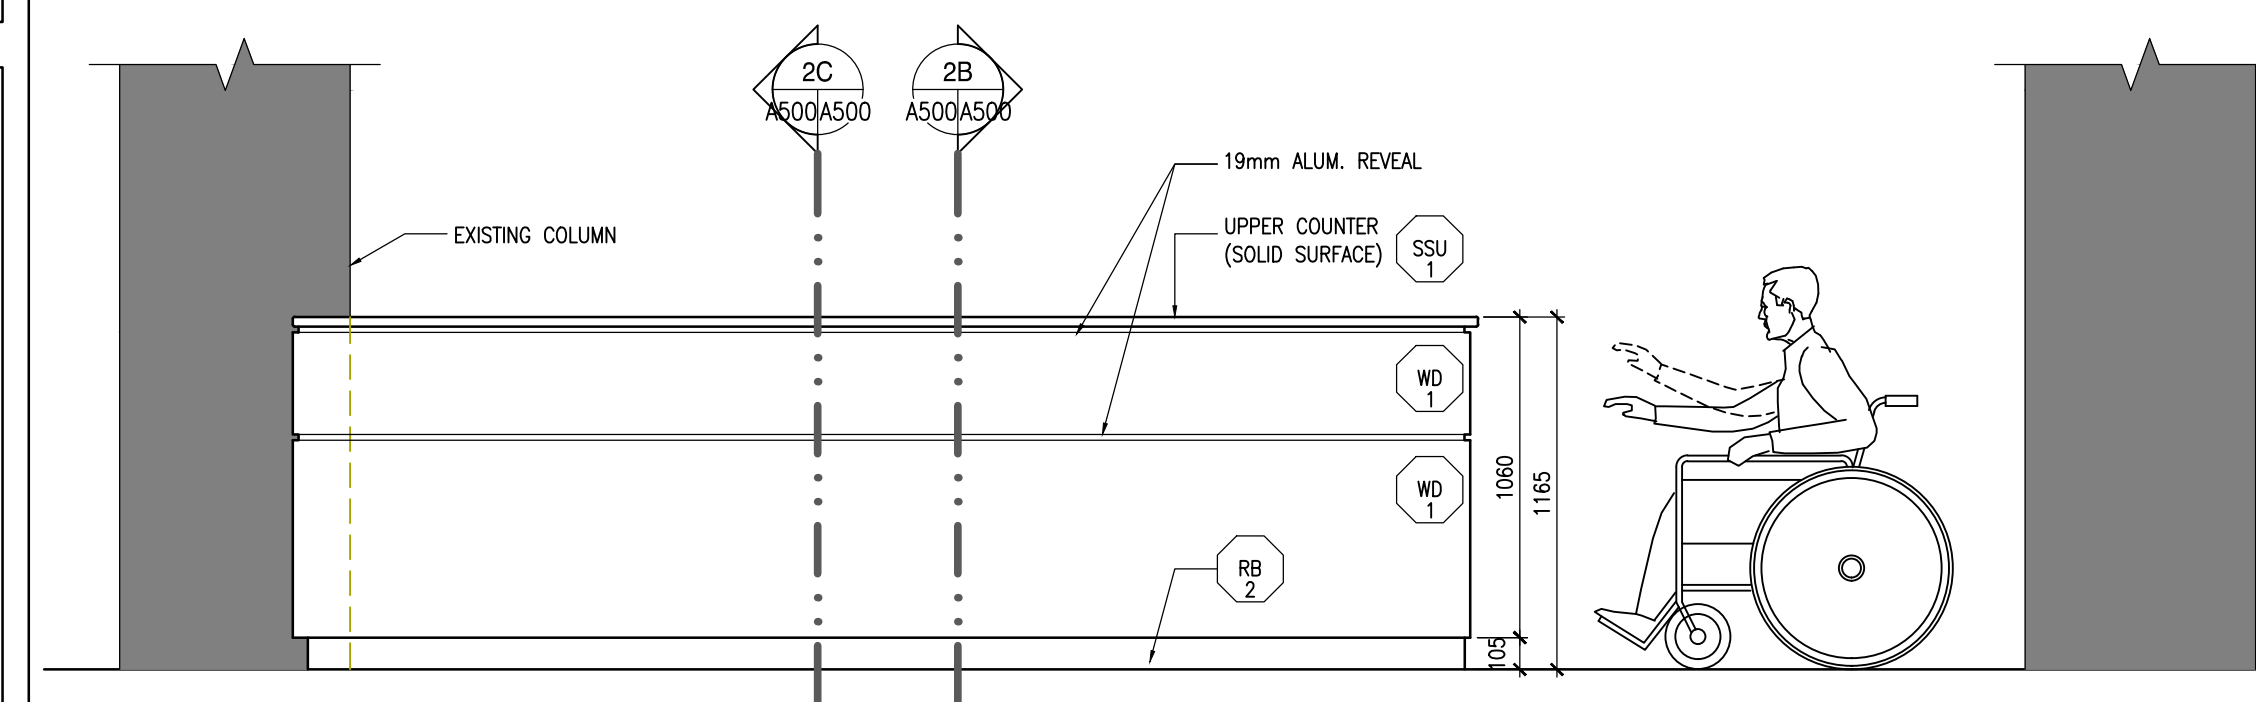


1B FRONT ELEVATION AT RECEPTION DESK
SCALE: 1:25

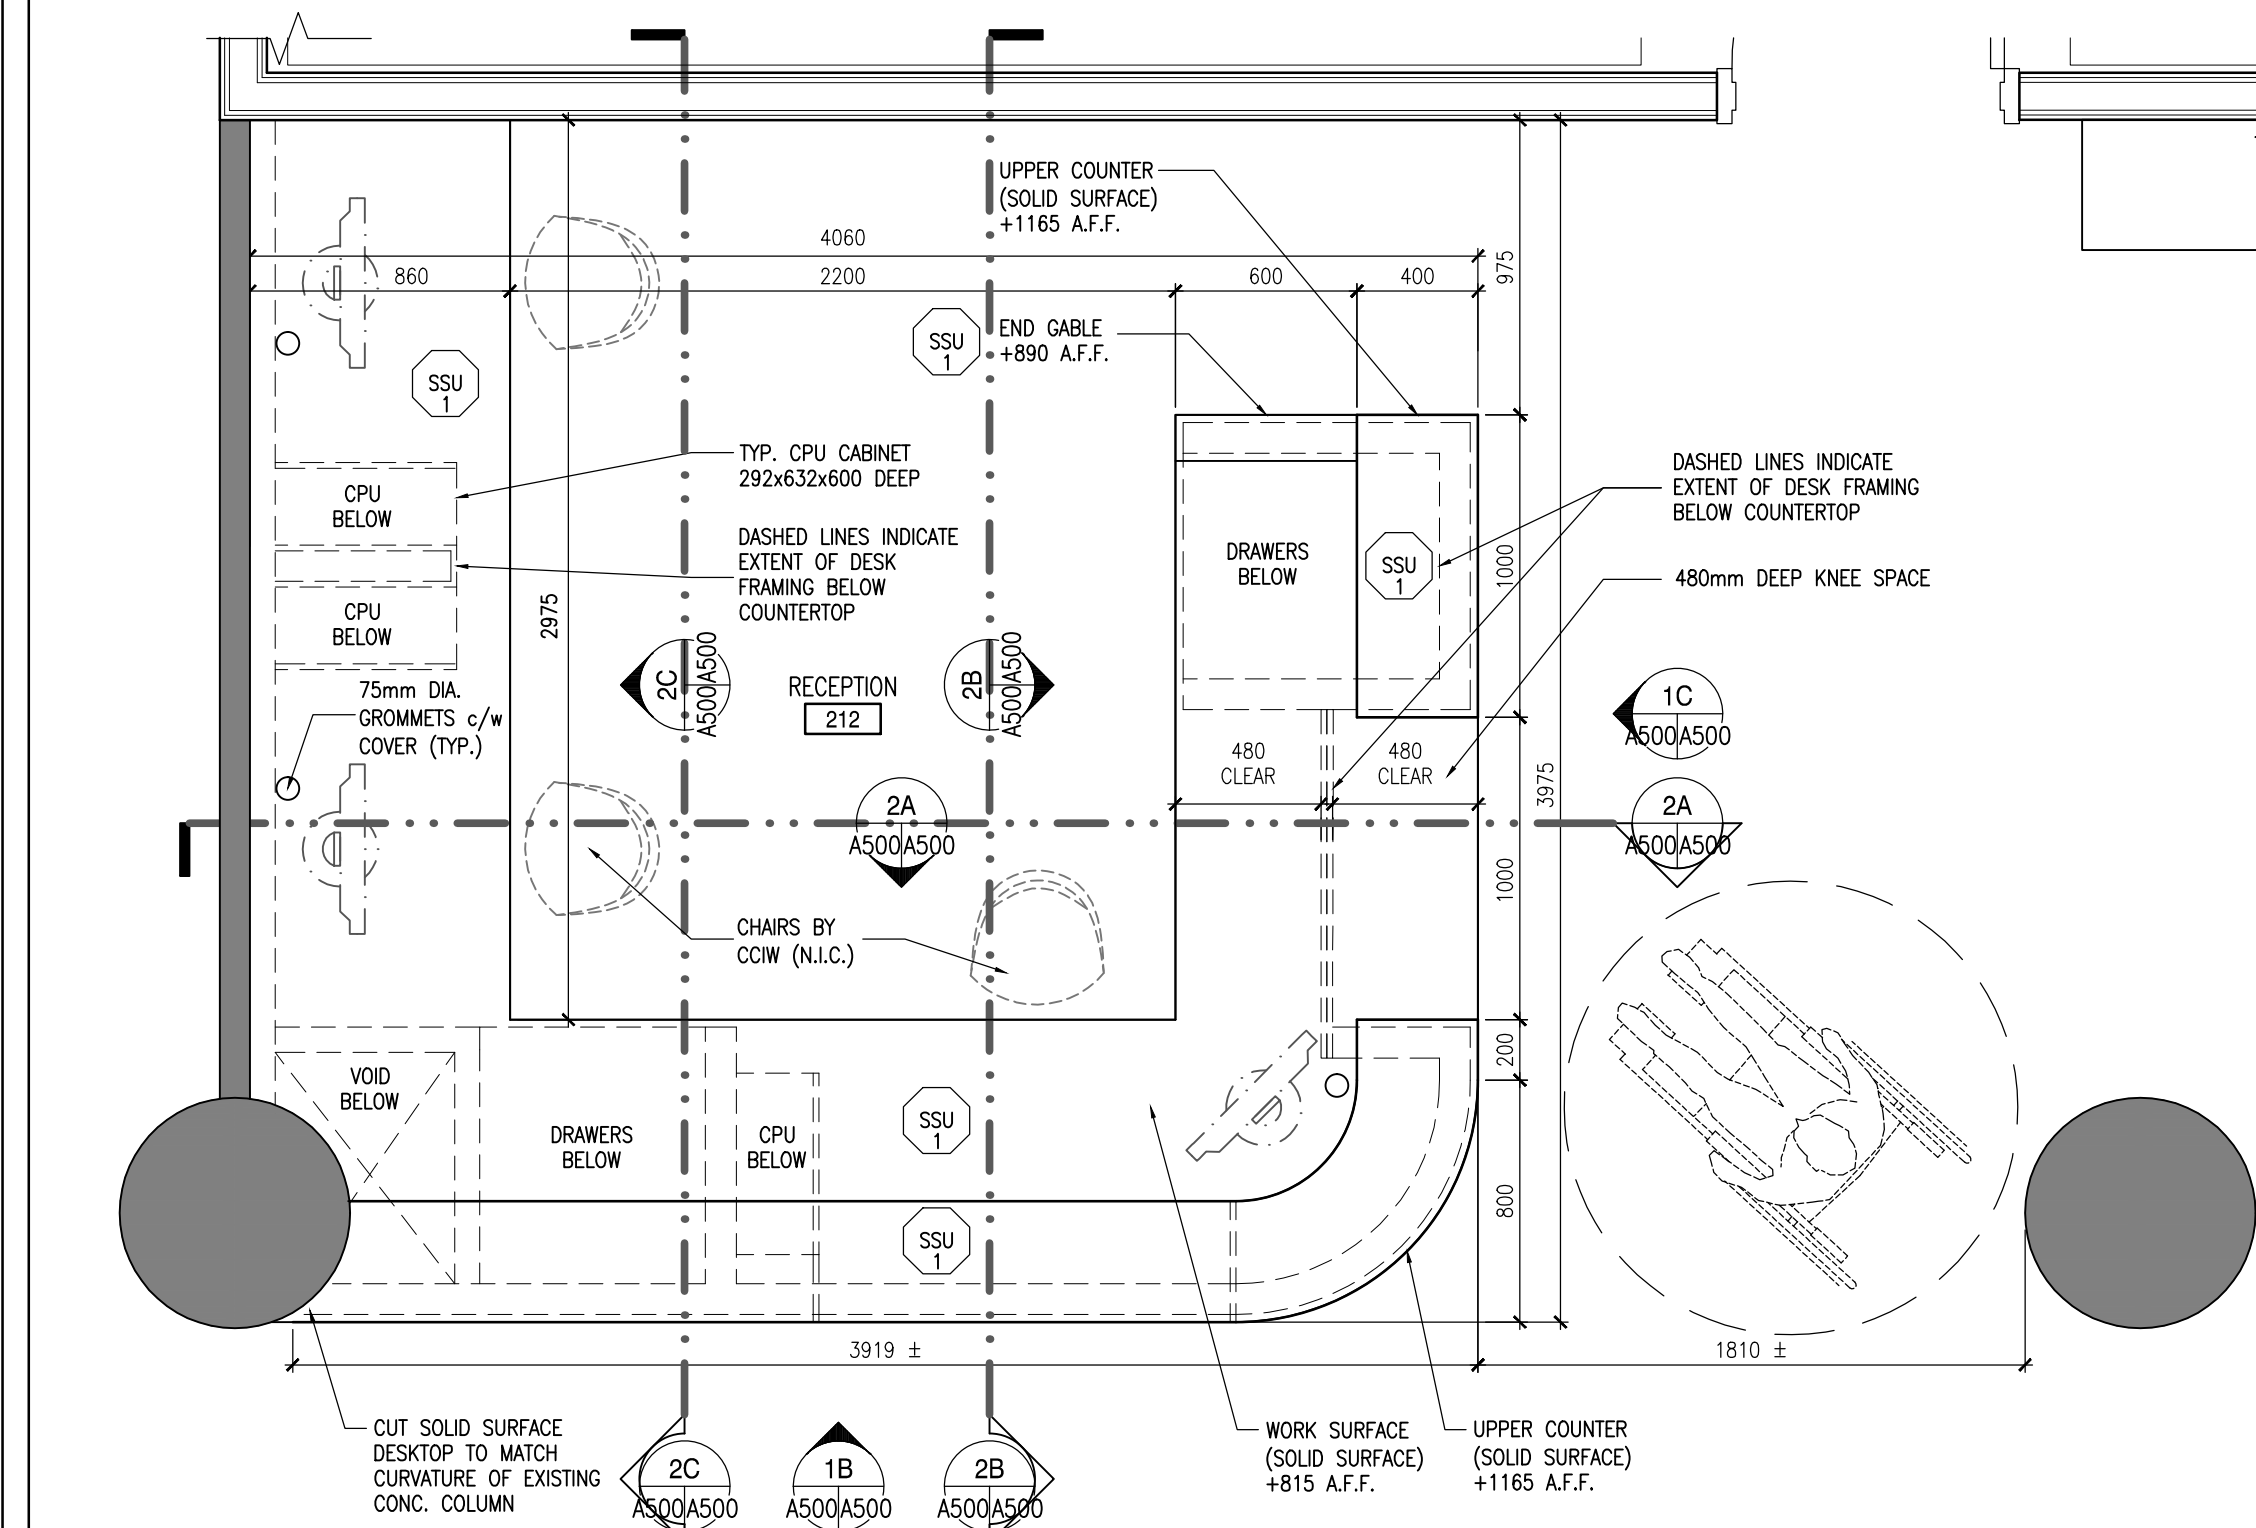

1A RECEPTION DESK PLAN
SCALE: 1:25

1 RECEPTION DESK - PLAN AND ELEVATIONS
SCALE: AS NOTED

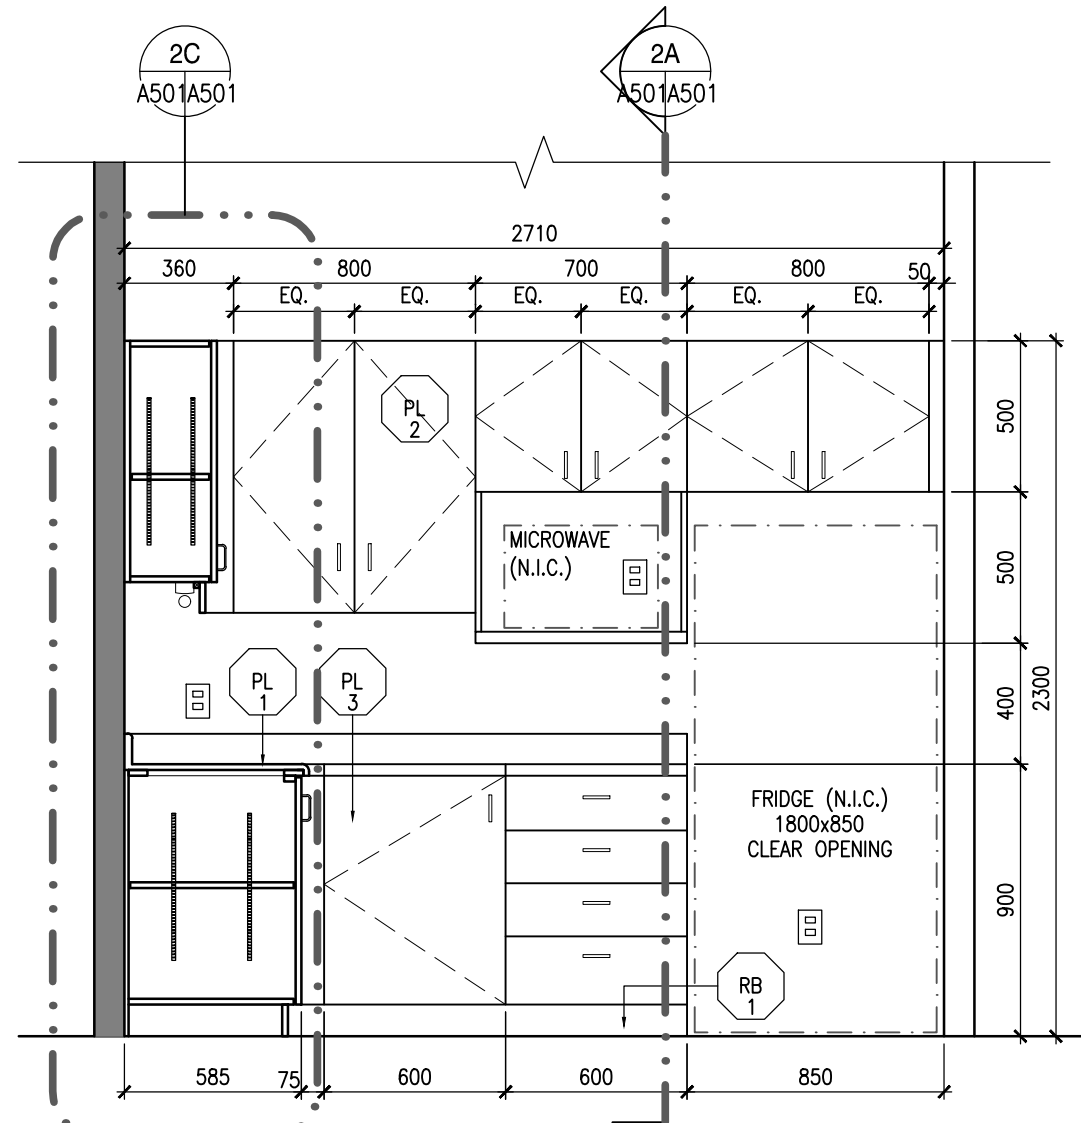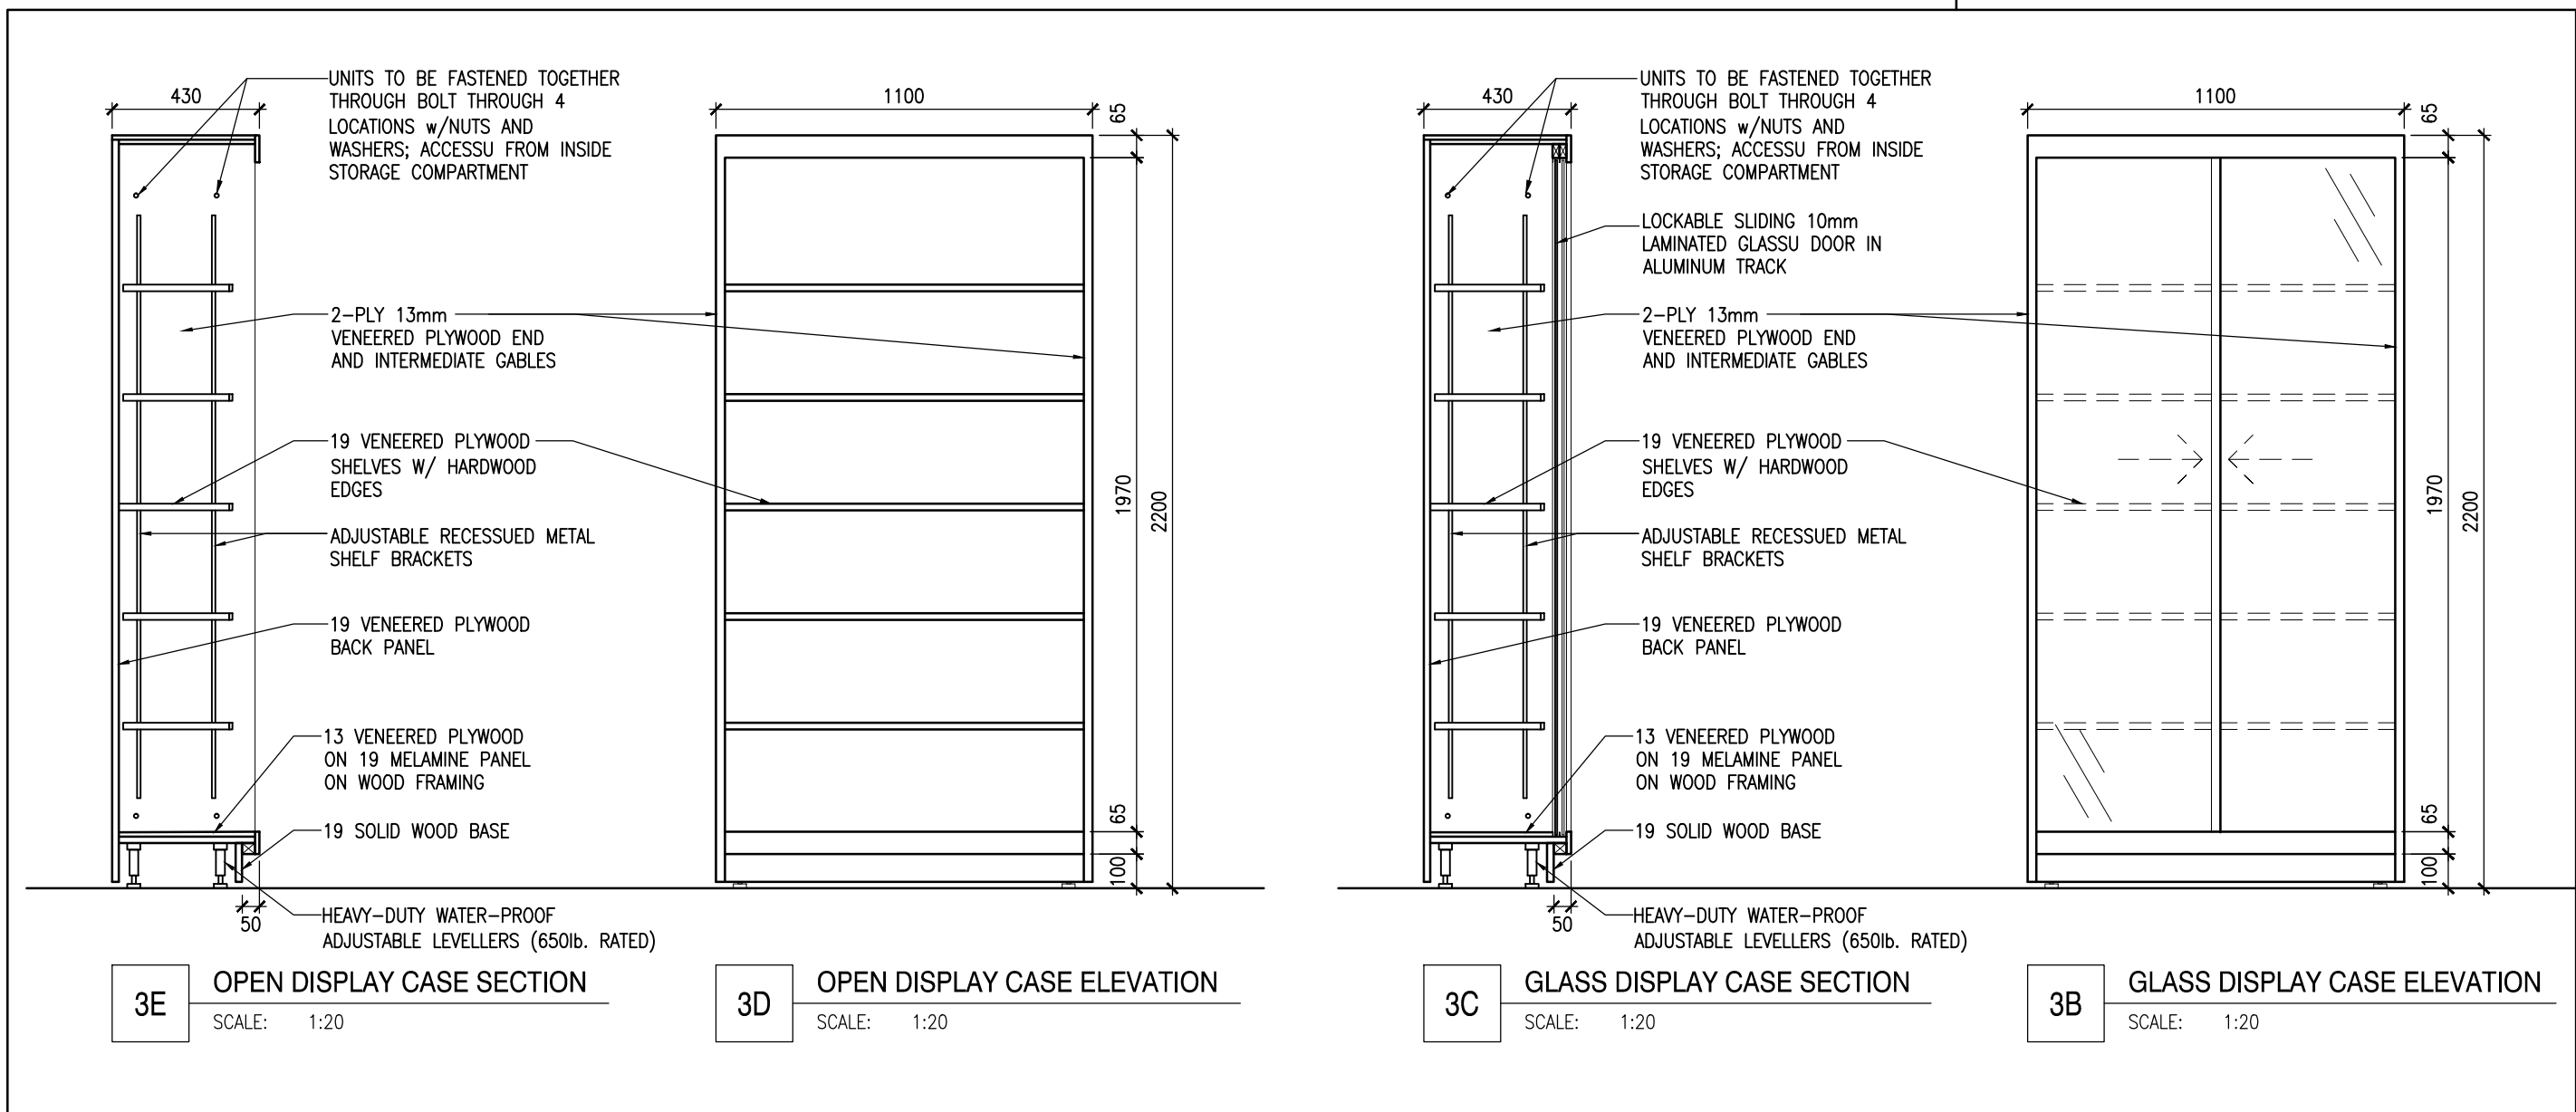


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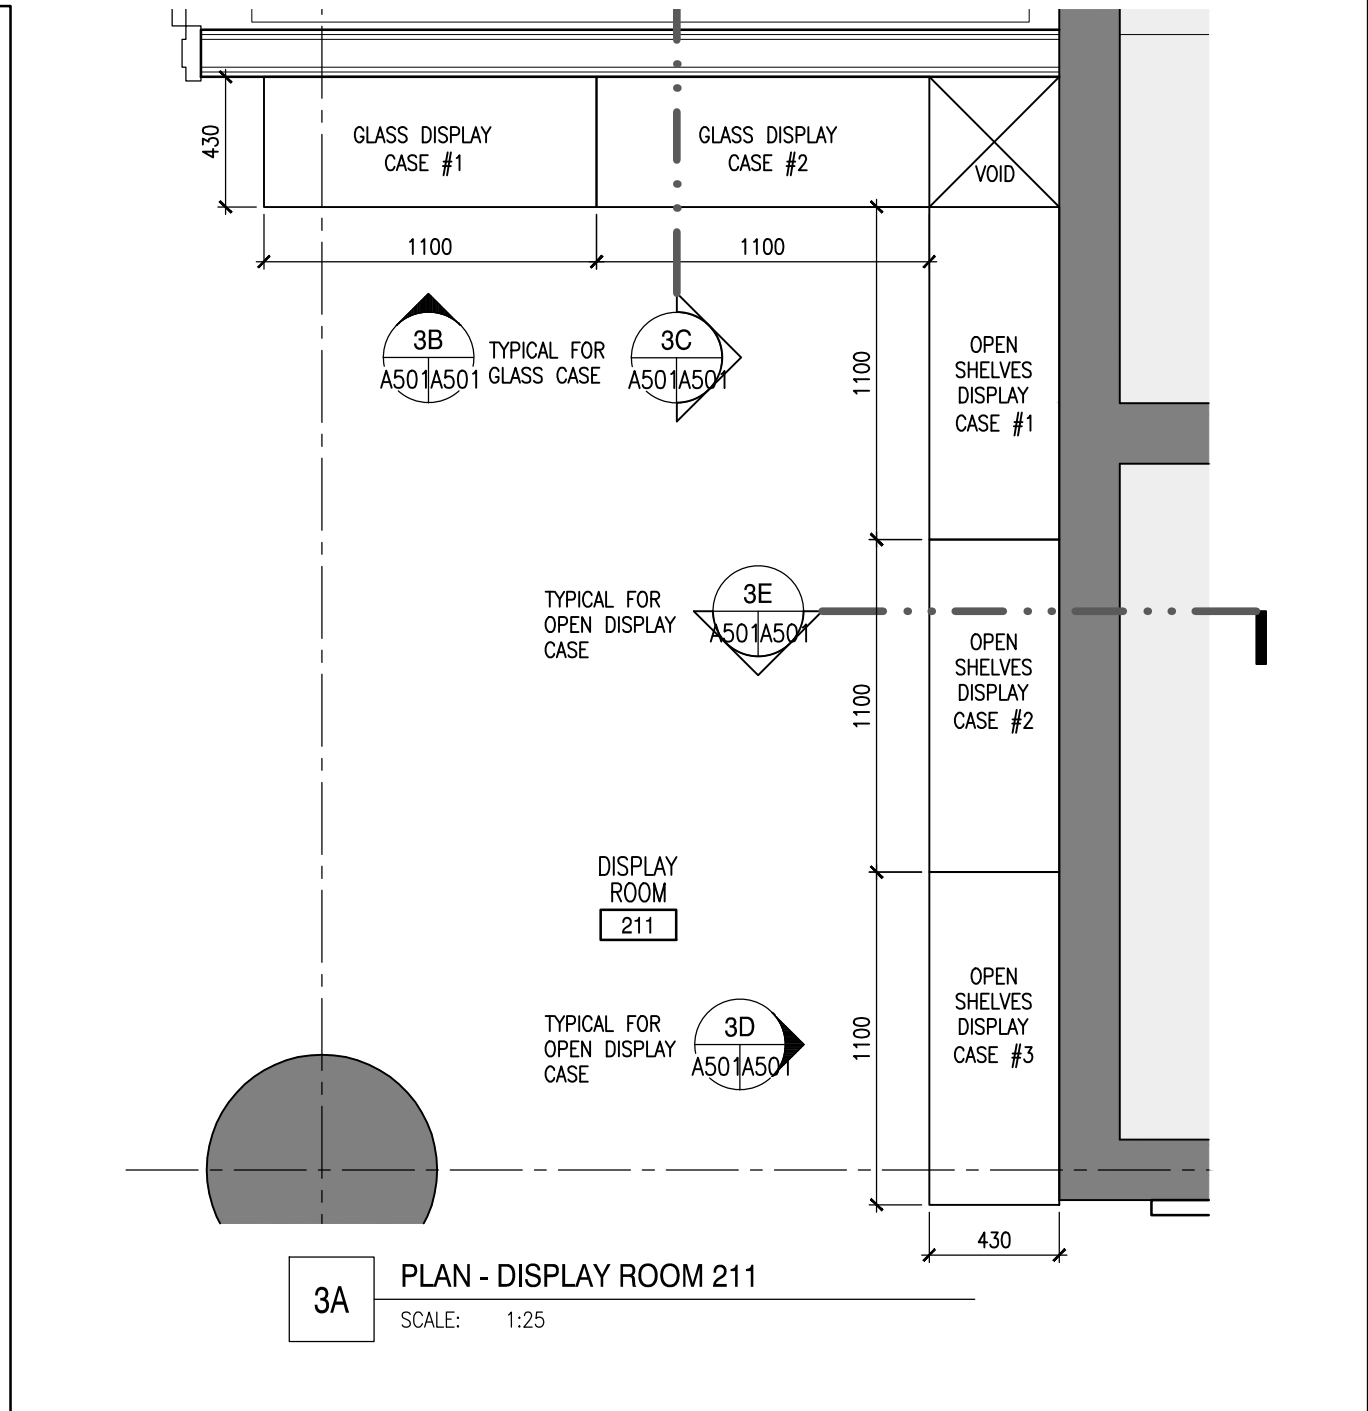
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MANUFACTURER: AVONITE
TYPE: F1-9137
COLOUR: CASABLANCA
- PL 1** PRODUCT TYPE: PLASTIC LAMINATE
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TYPE: HD
COLOUR: 1860K-55 ROMAN LIMESTONE
- PL 2** PRODUCT TYPE: PLASTIC LAMINATE
MANUFACTURER: WILSONART LAMINATE
COLOUR: D315-60 PLATINUM
- PL 3** PRODUCT TYPE: PLASTIC LAMINATE
MANUFACTURER: LAMIN-ART
COLOUR: 3073-VT CAPPUCCINO ASH
- RB 2** PRODUCT TYPE: RUBBER/RESILIENT WALL BASE
MANUFACTURER: -
CODE: STANDARD TOE 100mm HIGH W/ TOE
COLOUR: 48 GREY
- WD 1** PRODUCT TYPE: SOLID WOOD
MANUFACTURER: -
COLOUR/SPECIES: WALNUT
FINISH: FLAT

GENERAL MILLWORK CONSTRUCTION NOTES:


- COUNTERTOP**
POST FORMED COUNTER-TOP (PL-1) PLASTIC LAMINATE ON 19mm MOISTURE RESISTANT MDF CORE SUBSTRATE.
- VISIBLE SHELVES & VISIBLE CABLES**
(PL-2) PLASTIC LAMINATE ON 19mm VANEER CORE PLYWOOD SUBSTRATE.
- DOOR/DRAWER FRONTS**
(PL-2) PLASTIC LAMINATE ON 19mm PARTICLE BOARD CORE SUBSTRATE c/w MATCHING EDGING ON ALL 4 SIDES
- CABINET EXTERIOR**
(PL-2) PLASTIC LAMINATE ON 19mm PARTICLE BOARD CORE SUBSTRATE c/w MATCHING EDGING ON ALL EXPOSED SURFACES
- CABINET INTERIOR**
(ML-1) WHITE MELAMINE ON 19mm PARTICLE BOARD CORE SUBSTRATE c/w MATCHING PVC EDGING ON ALL EXPOSED SURFACES
- ADJUSTABLE SHELVES**
(ML-1) WHITE LAMINATE ON 19mm VANEER CORE PLYWOOD SUBSTRATE c/w MATCHING PVC EDGING ON ALL 4 SIDES
- CABINET BACK PANEL**
(ML-2) WHITE LAMINATE ON 13mm PARTICLE BOARD CORE
- CABINET BASE**
19mm 'D' GRADE VANEER CORE PLYWOOD 100mm HIGH w/RUBBER BASE (RB-1)
- CABINET CONSTRUCTION TO MEET ALL AWAMAC STANDARDS AND RECOMMENDED CORE MATERIALS (TYP.)**

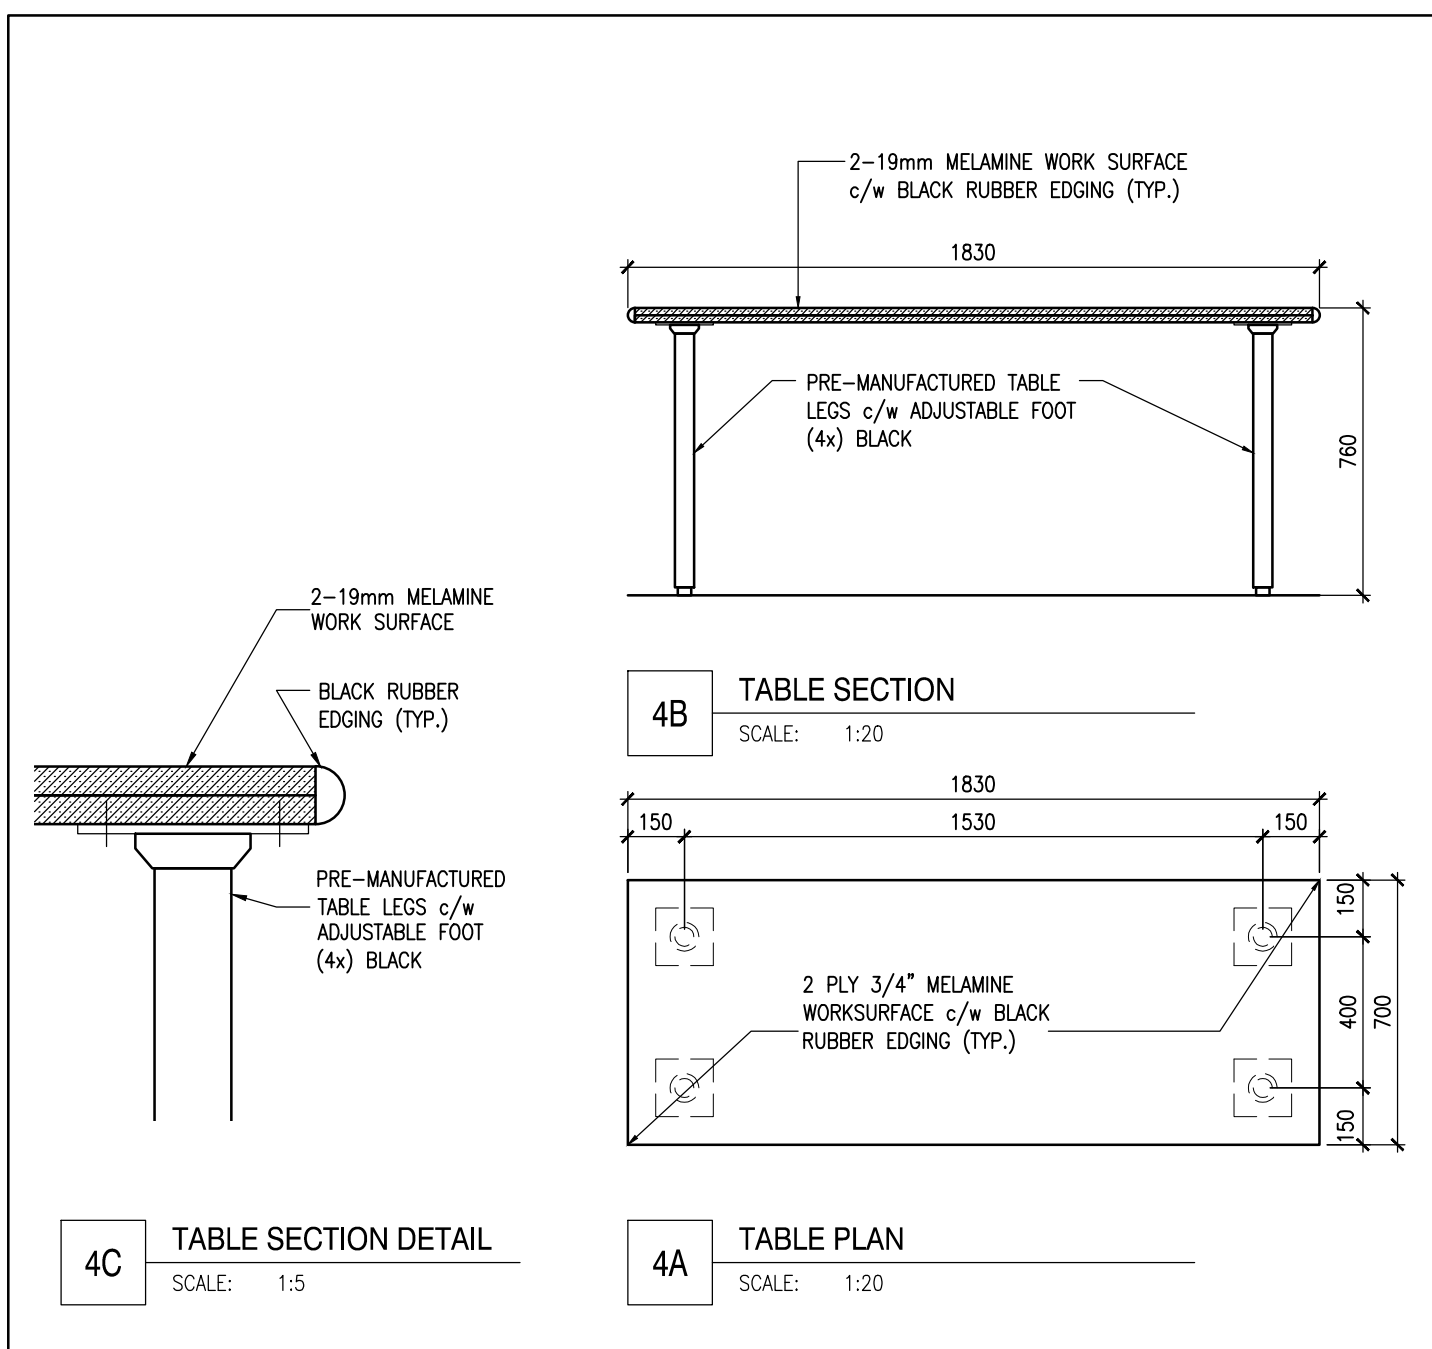


4 READING TABLE - PLAN, SECTION AND SECTION DETAIL
A201A501 SCALE: 1:25




3 DISPLAY CASES - PLAN, ELEVATION AND SECTION DETAIL
A201A501 SCALE: 1:25

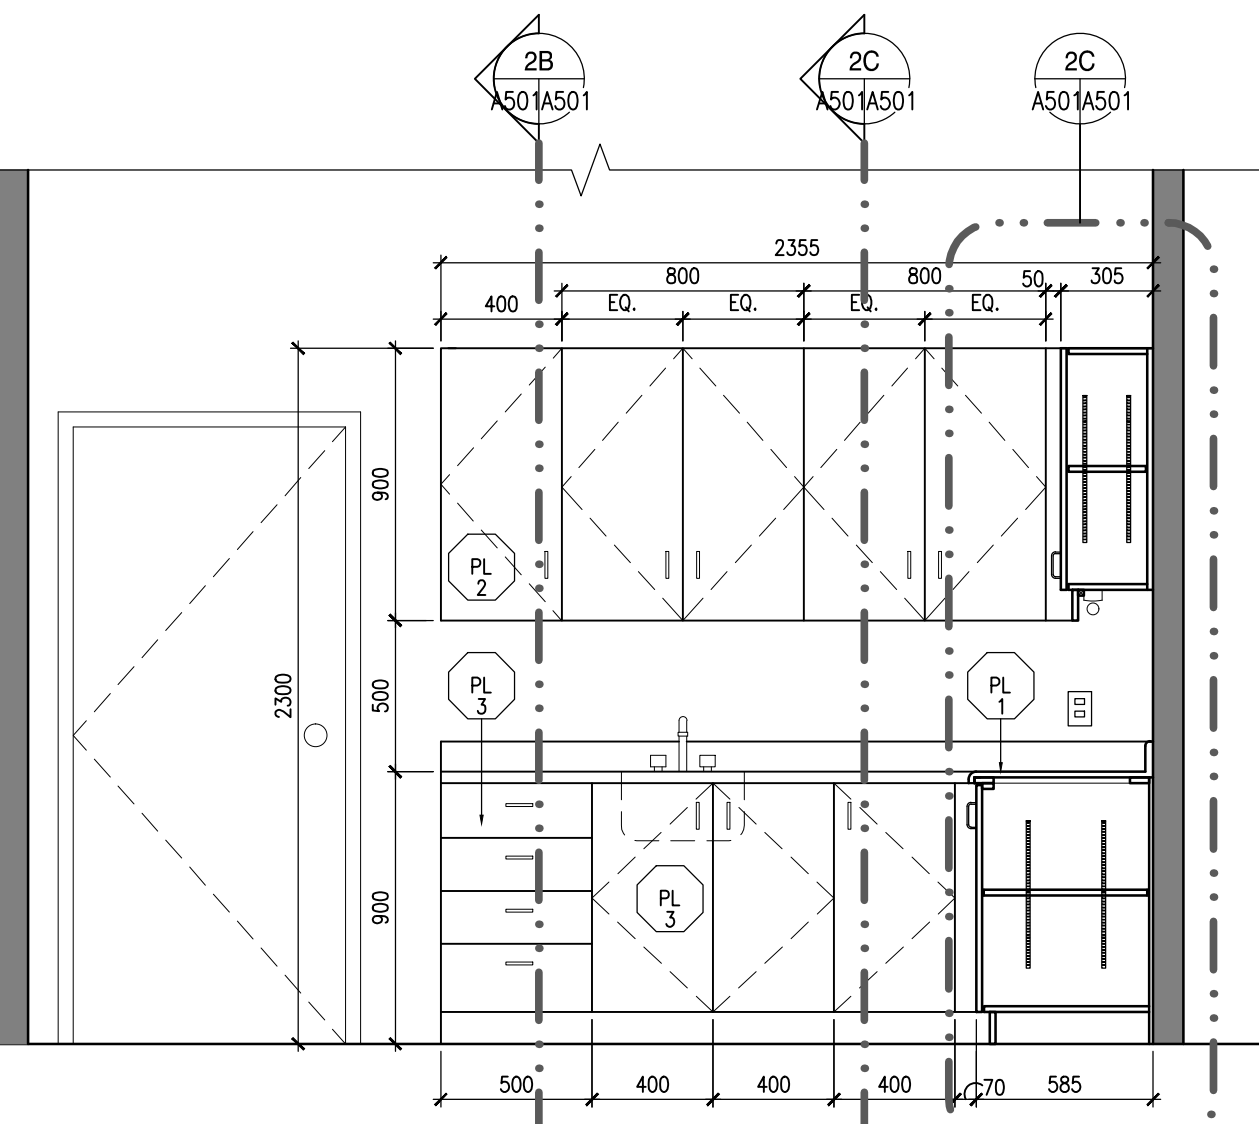

1B KITCHEN ELEVATION
SCALE: 1:25

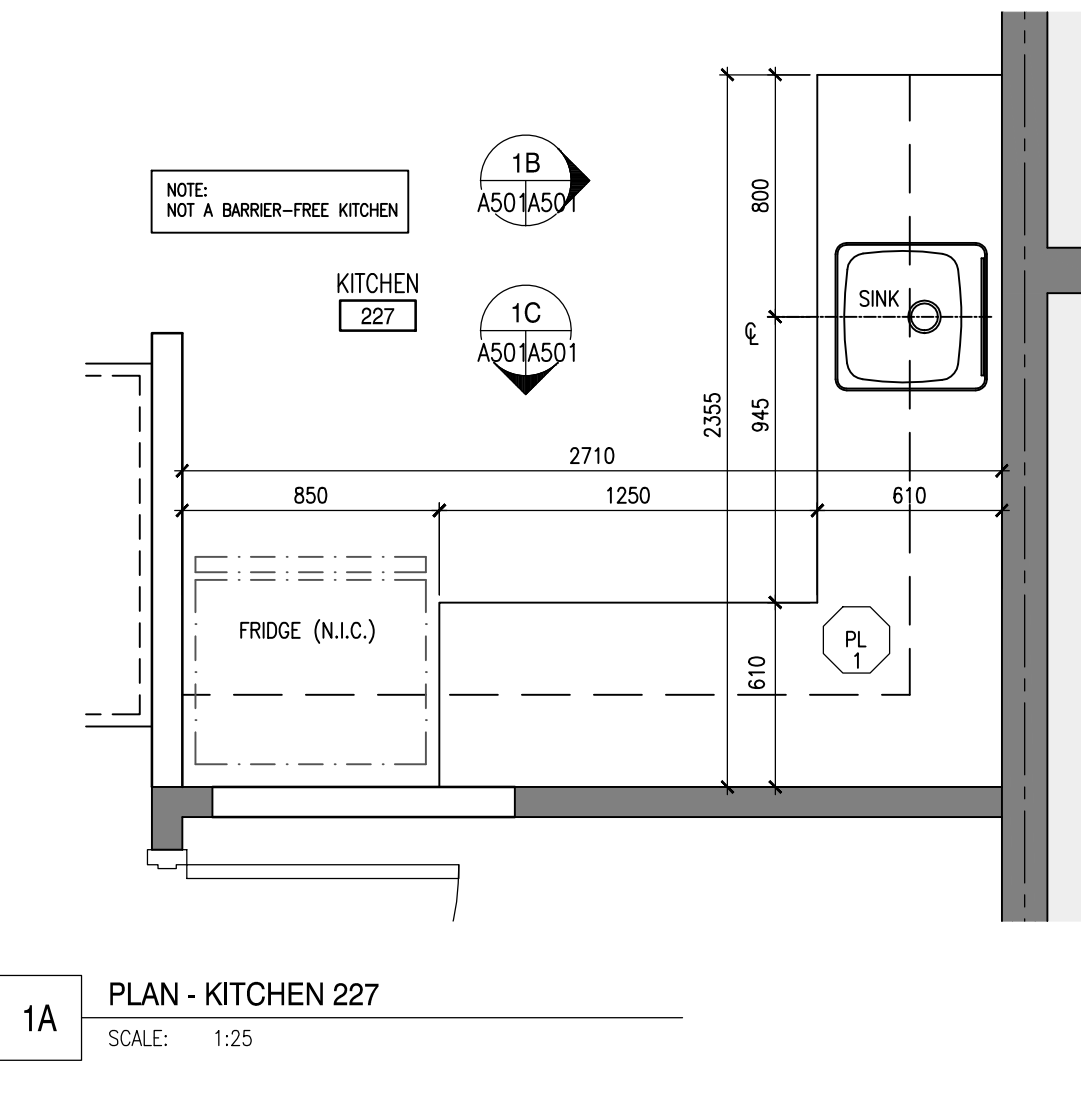


1 KITCHEN - PLAN AND ELEVATIONS
A201A501 SCALE: AS NOTED

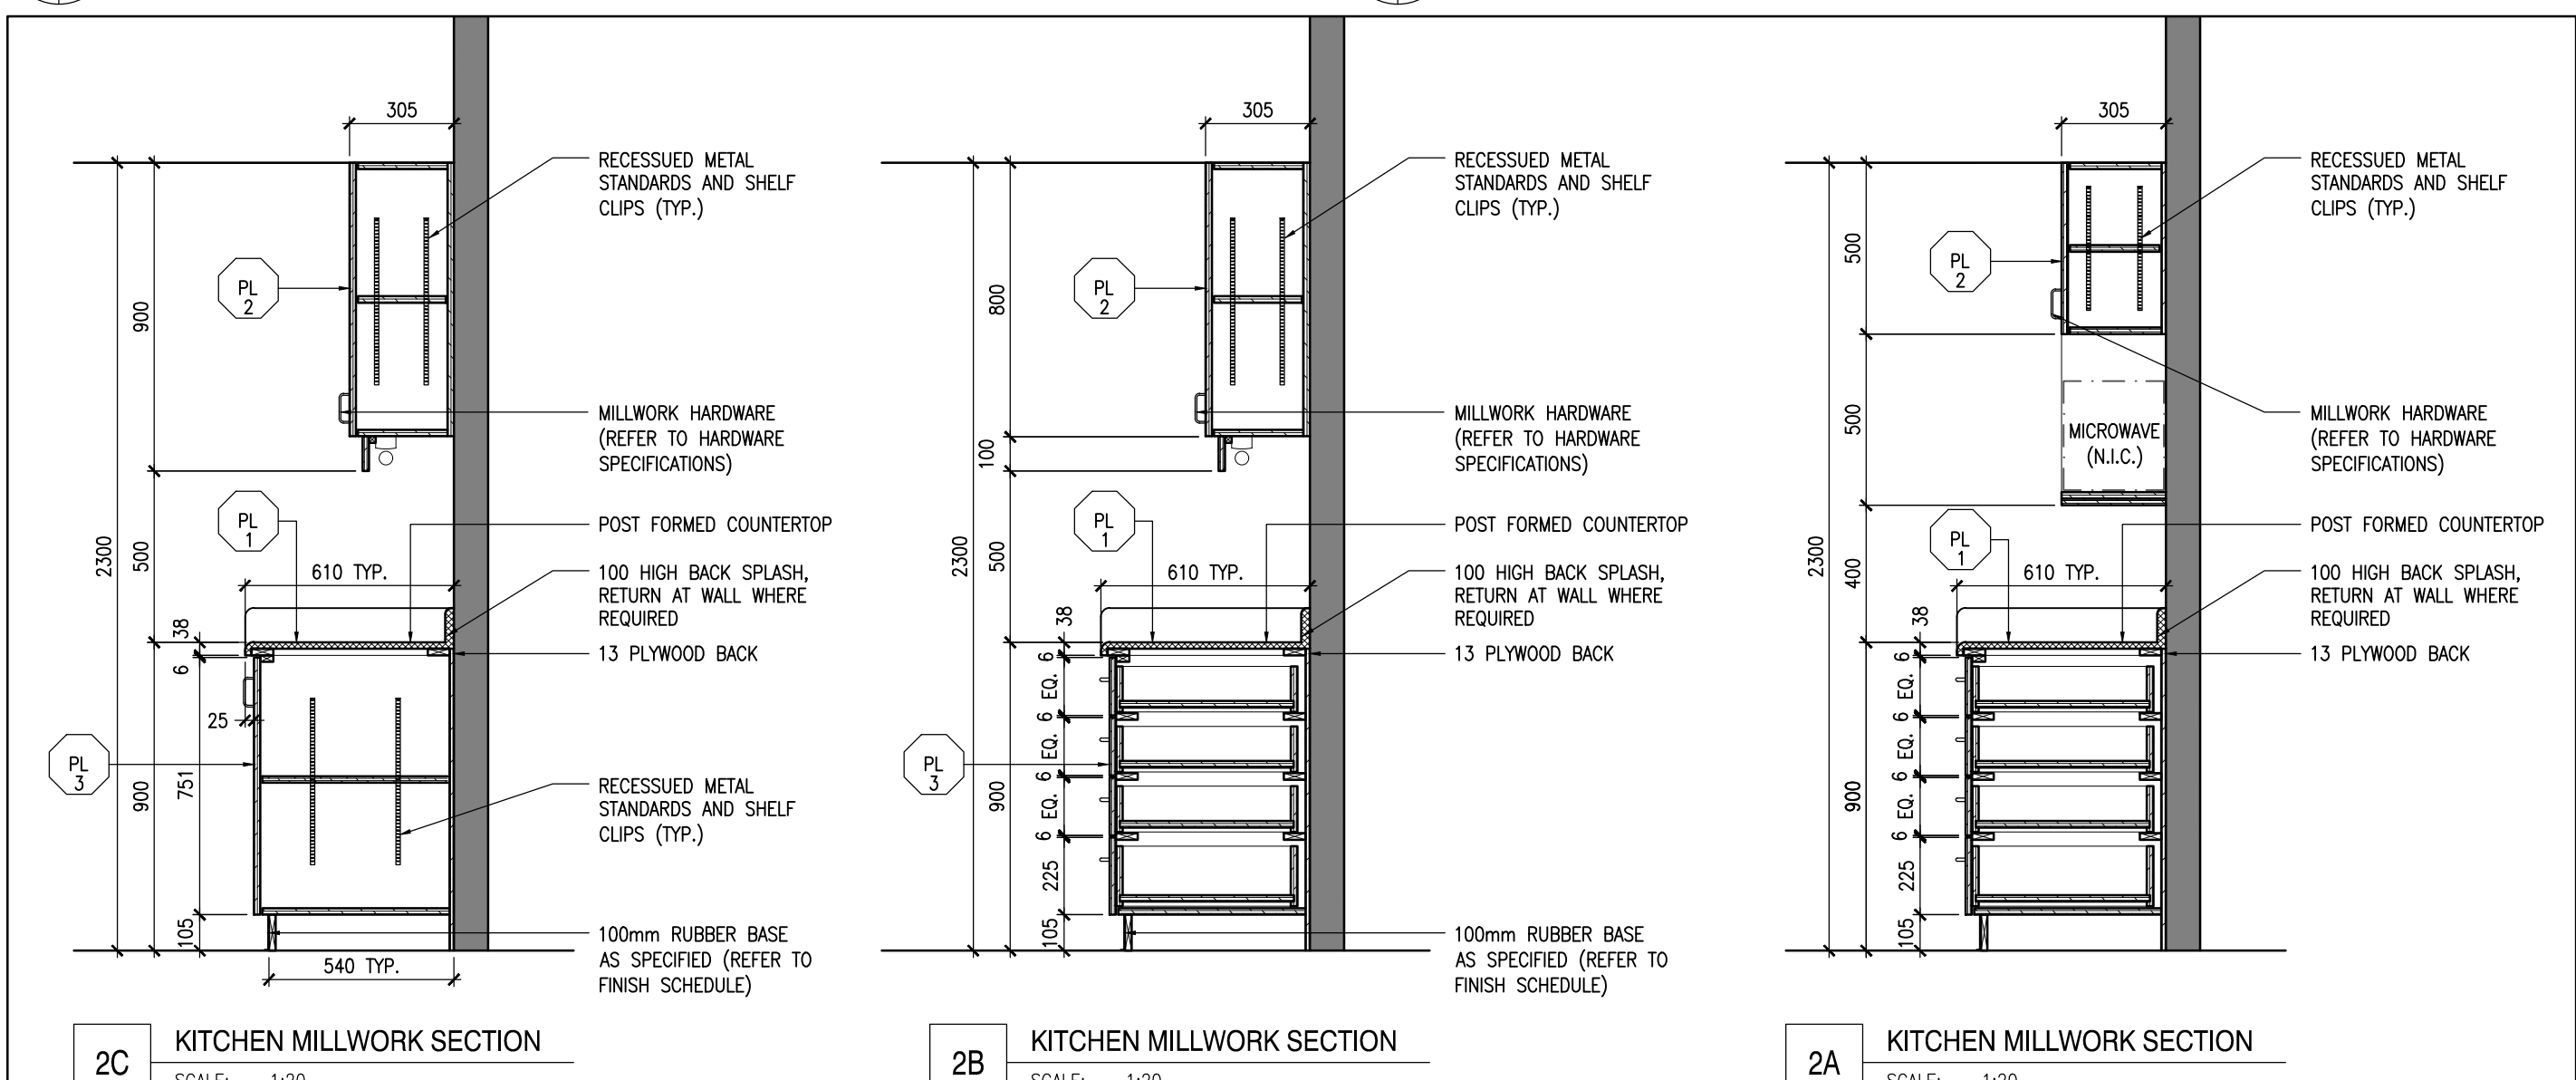


2 KITCHEN MILLWORK SECTIONS
A501A501 SCALE: AS NOTED

consultant

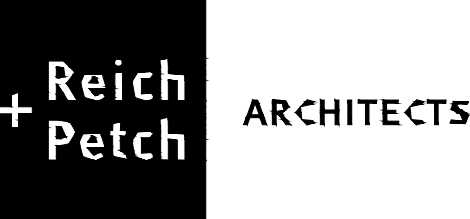


1867 YONGE ST, STE 1100, TORONTO ON CANADA M4S 1Y5
T 416 480 2020 F 416 480 1881

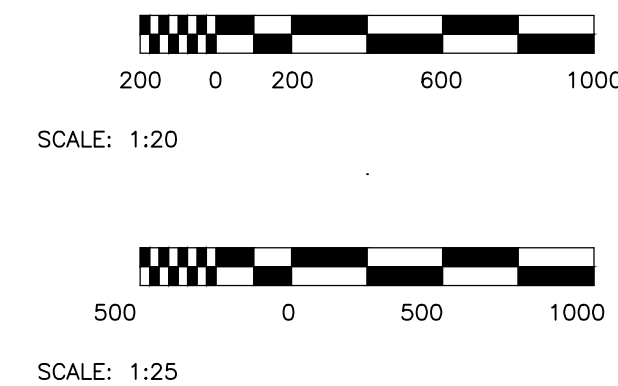

3	ISSUED FOR BID	09 DEC 2013
2	ISSUED FOR 95% SUBMISSION	12 NOV 2013
1	ISSUED FOR 75% SUBMISSION	30 APR 2013

revision date

Do not scale drawings. Verify all dimensions and conditions on site and immediately notify the Departmental Representative of all discrepancies.

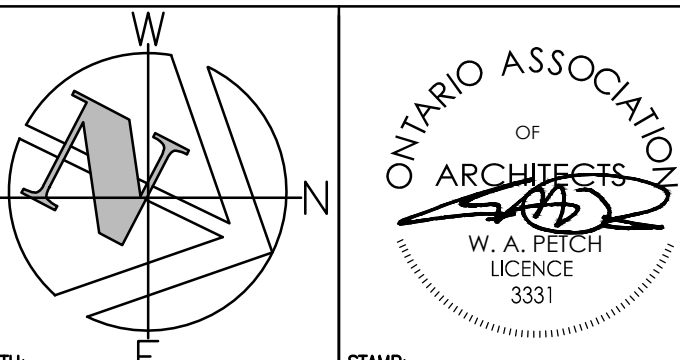

A	Detail No.
B	drawing no. - where detail required
C	drawing no. - where detailed

project title
titre du projet
BURLINGTON ONTARIO
CANADA CENTRE FOR INLAND WATERS
867 LAKESHORE ROAD

LIBRARY RENOVATION

drawing title
titre du dessin
MILLWORK - KITCHEN, READING TABLES AND DISPLAY CASES

drawn by
dessiné par
R+P A

designed by
conçue par
R+P A

approved by
approuvé par
CCW/EC/PWGSC

bid
offre
project manager
administrateur de projets

project date
date du projet
2013-02-20

project no.
no. du projet
R.061475.001

drawing no.
dessiné no.
A501