

MECHANICAL NOTES: (X)

DISCONNECT, REMOVE AND DISPOSE OFF SITE EXISTING AIR HANDLING UNITS (50PAC05, 50PAC06 AND 50PACO7) ALONG WITH ASSOCIATED DUCT CONNECTIONS AND ROOF CURBS.

PROVIDE NEW ROOF TOP AIR HANDLING UNITS (RTU'S), ALL REQUIRED DISCONNECTS AND ROOF CURBS AS INDICATED. REFER TO SPECIFICATIONS AND SCHEDULES FOR ADDITIONAL INFORMATION AND PERFORMANCE. ROOF TOP AIR HANDLING UNITS SHALL HAVE "THROUGH BASE CONNECTIONS" FOR POWER AND CONTROL CONNECTIONS.

TEST, ADJUST AND BALANCE NEW RTU'S TO QUANTITIES INDICATED. PROVIDE NRC REPRESENTATIVE WITH BALANCING REPORT FOR REVIEW BEFORE INSERTION INTO O&M MANUALS.

ELECTRICAL NOTES: <X>

- 1. DISCONNECT ELECTRICAL FEED AND REMOVE WIRE BACK TO DISCONNECT IN HIGH BAY AREA ON
- GROUND FLOOR. REFER TO DRAWING GO2. 2. PROVIDE NEW WEATHERPROOF DISCONNECT FOR NEW ROOFTOP UNIT. REFER TO SINGLELINE DETAIL 3/G03 FOR DETAILS.
- 3. 5-20R RECEPTACLE FOR THE PURPOSE OF MEETING CEC RULE 26-704. PROVIDE 20A GFCI BREAKER AND CIRCUIT AS SHOWN USING # 12 WIRE IN PVC CONDUIT. PROVIDE EXPANSION COUPLING. MOUNT ON EXISTING UNISTRUT SUPPORT AT A MINIMUM OF 750mm ABOVE THE FINISHED ROOF SURFACE IN WEATHERPROOF BOX.
- 4. 5-20R RECEPTACLE FOR THE PURPOSE OF MEETING CEC RULE 26-704. CIRCUIT FROM SAME BREAKER PROVIDED IN NOTE 3 USING # 12 WIRE IN PVC CONDUIT. PROVIDE EXPANSION COUPLING. MOUNT ON THE SIDE OF THE ROOFTOP UNIT AT A MINIMUM OF 750MM ABOVE THE FINISHED ROOF SURFACE IN WEATHERPROOF BOX.

National Research Council Canada

Conseil national de recherches Canada Division des services administratifs et gestion de l'immobilier

NAC · CNAC

GENERAL NOTES

- CONTRACTORS TO CHECK AND VERIFY ALL DIMENSIONS ON SITE PRIOR TO DEMOLITION OR CONSTRUCTION AND REPORT ANY ERRORS OR OMISSIONS TO DEPARTMENTAL REPRESENTATIVE.
- CONTRACTORS MUST VISIT THE SITE & FULLY FAMILIARIZE THEMSELVES WITH THE SCOPE OF THE WORK.
- PREVENT THE SPREAD OF DUST & DEBRIS BEYOND THE WORK AREA AND CLEAN ALL SURFACES AT COMPLETION.
- MAKE GOOD ALL SURFACES AFFECTED BY THIS WORK.
- COORDINATE ALL SHUTDOWNS WITH THE DEPARTMENTAL REPRESENTATIVE.
- PROVIDE ALL LABOUR AND MATERIAL REQUIRED TO FORM A COMPLETE, FUNCTIONAL SYSTEM AS DESCRIBED ON DRAWINGS.

JAN. 2014	ISSUED FOR TENDER	JWG
Date	Revision	By: Par:

Date Printed DD MM YYYY Date imprimée

Vérifier toutes les dimensions et l'état des liéux et en assumer la responsabilité

A Detail no. No. du détail B Location drawing no. sur dessin no. C Drawing no. dessin no.

BUILDING M-50- ELECTRICAL HIGH BAY ROOF TOP

MONTREAL ROAD CAMPUS


UNITS REPLACEMENTS

PARTIAL ROOF PLAN- MECHANICAL AND ELECTRICAL NEW WORK AND DEMOLITION

designed	conçu	date	date
JWG/DIF		JAN 2014	
drawn	dessiné	scale	échelle
JWG/DIF		AS INDICATED	
checked	vérifié	sheet	feuille
		1 of/de 3	
approved	approuvé	W.O.no.	D.T.no.
BV		A1-000506-42	2
dwg.no.		dess	in no.

3873-G01

ASPM A1 (841x594)

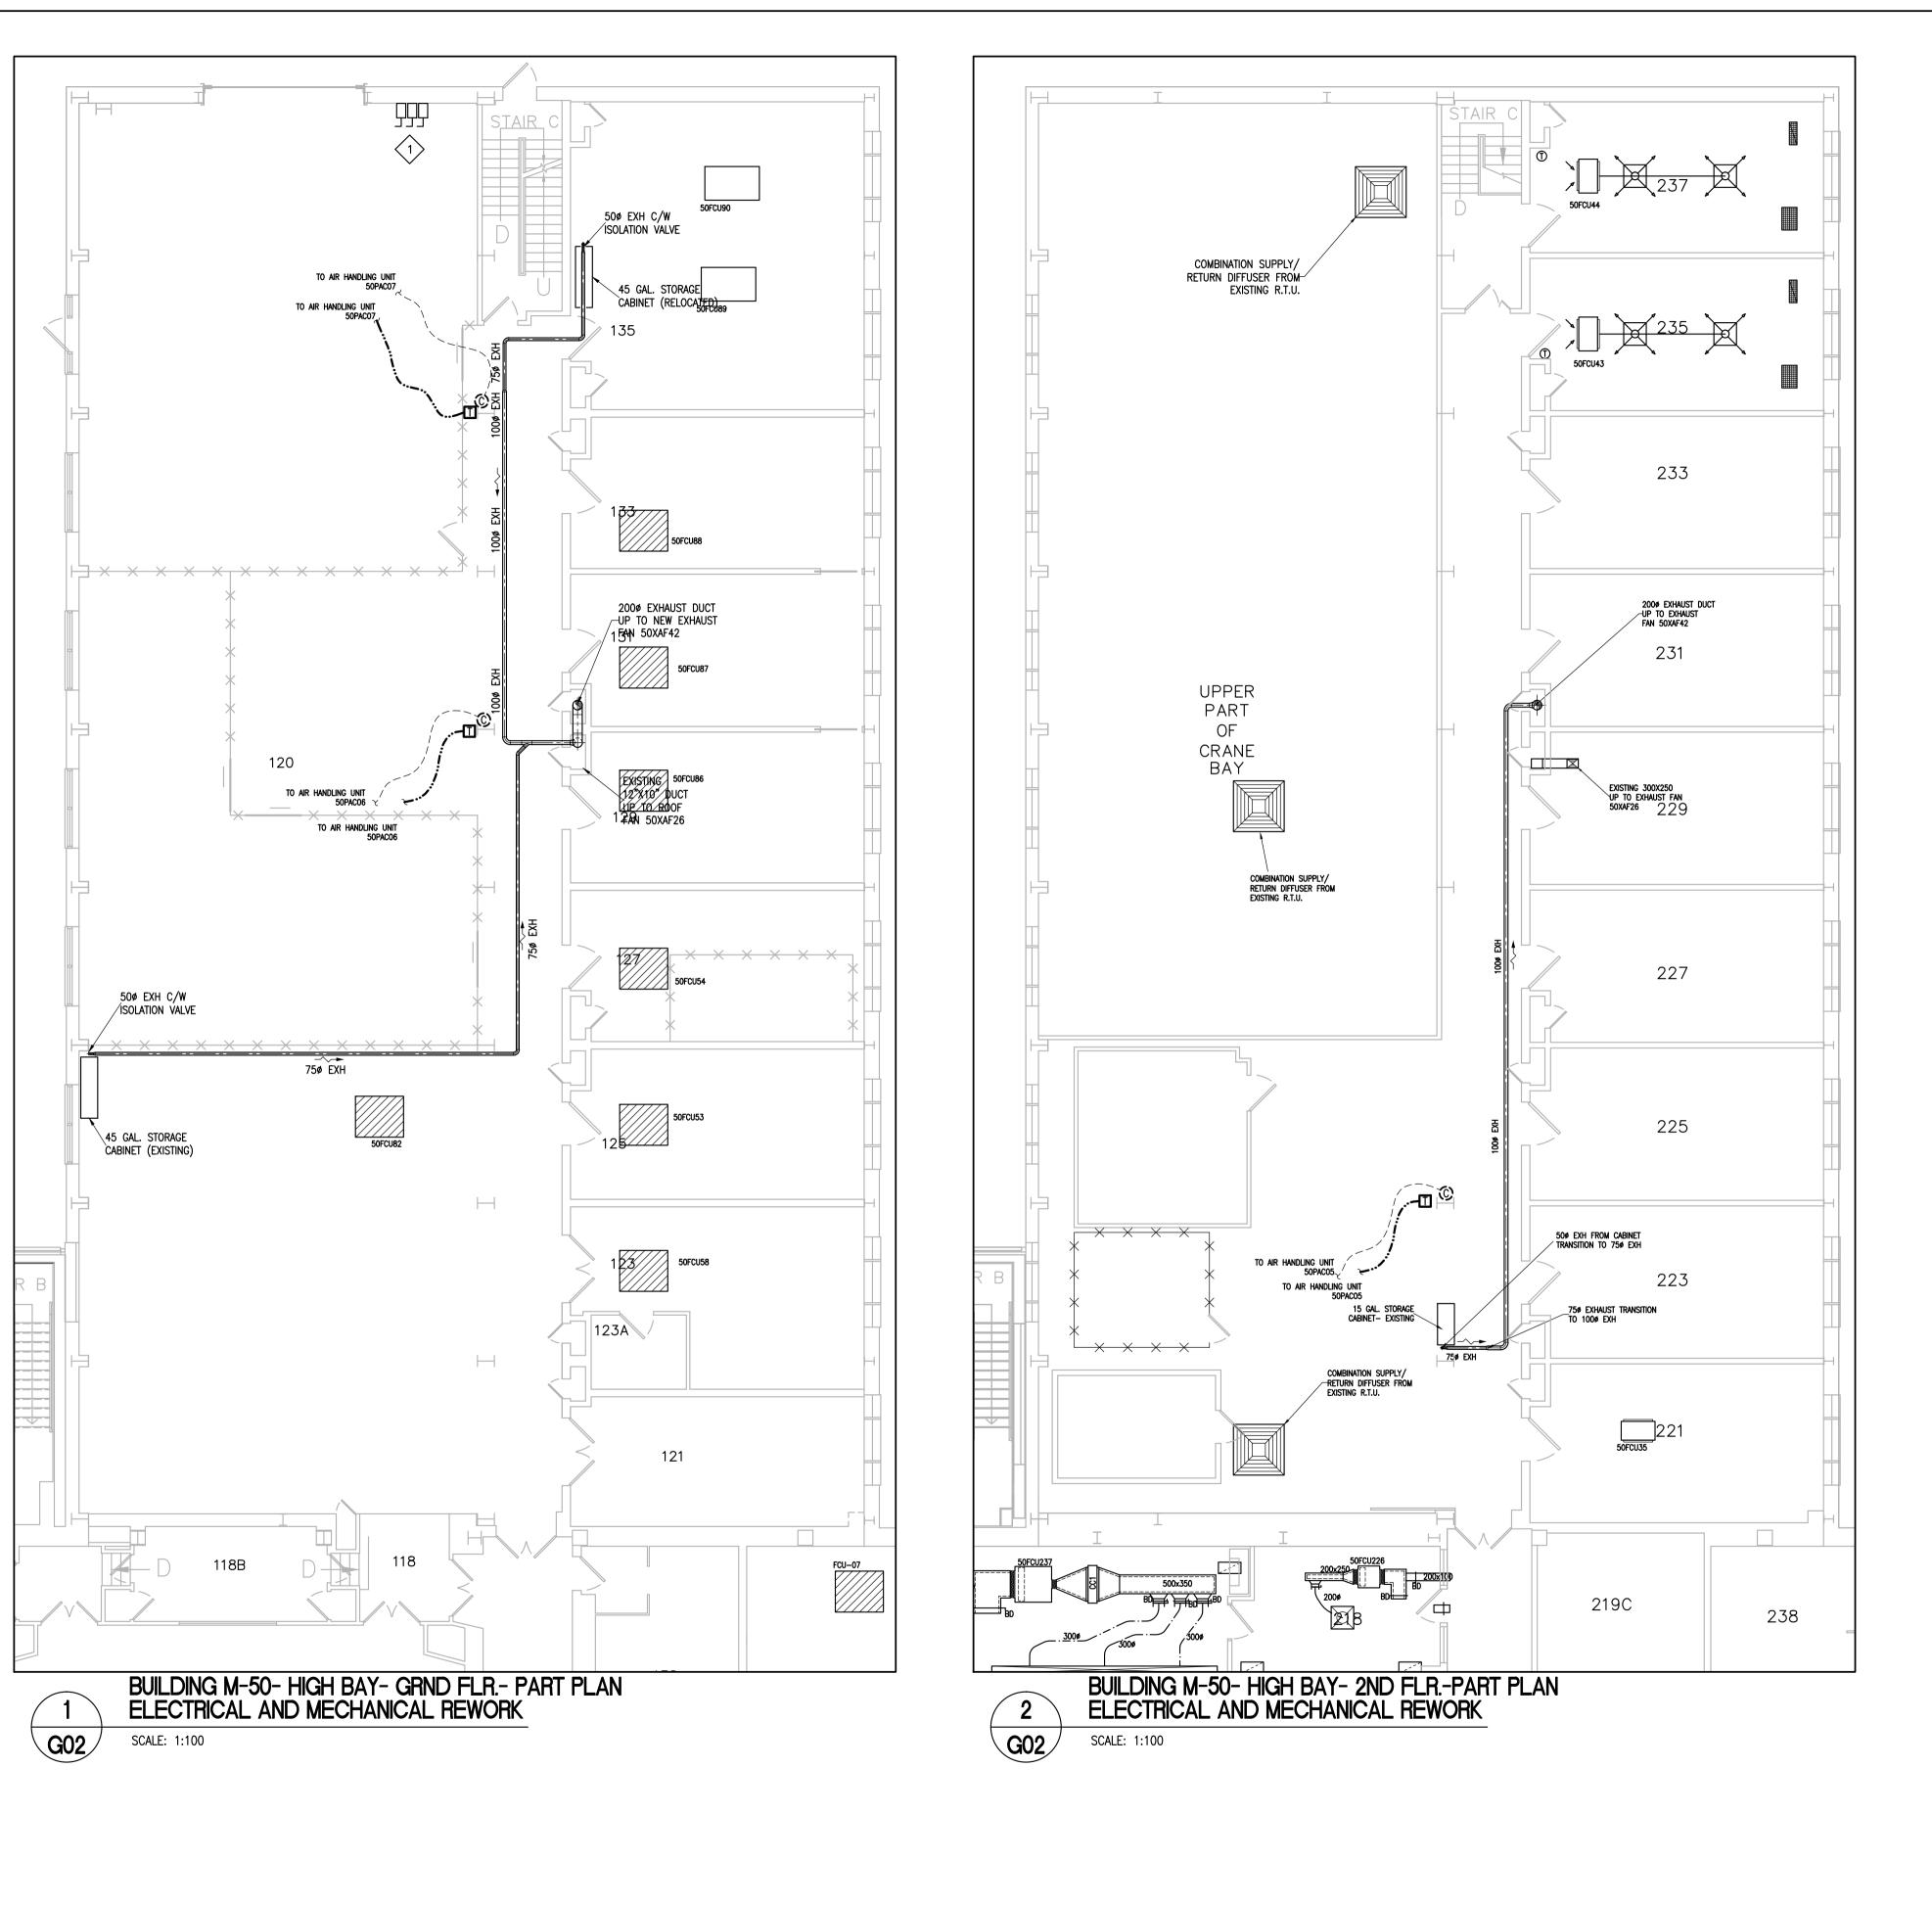

ASPM A1 (841x594)

MECHANICAL NOTES: (X)

- DISCONNECT, REMOVE AND DISPOSE OFF SITE EXISTING ROOF TOP UNIT CONTROLLERS AND
- ASSOCIATED CONTROL WIRING.

 2. PROVIDE NEW LOCAL TEMPERATURE SENSOR AND WIRING AS INDICATED. REFER TO SPECIFICATIONS FOR ADDITIONAL INFORMATION. DIRECT ENERGY TO PROVIDE ALL TEMPERATURE SENSORS AND

ELECTRICAL NOTES: X

REMOVE WIRE & CONDUIT FROM EXISTING ROOFTOP UNITS BACK TO DISCONNECTS IN THIS LOCATION. MARK DISCONNECTS AS SPARE.

National Research Council Canada

Conseil national de recherches Canada Division des services administratifs et gestion de l'immobilier

NAC · CNAC

GENERAL NOTES

- CONTRACTORS TO CHECK AND VERIFY ALL DIMENSIONS ON SITE PRIOR TO DEMOLITION OR CONSTRUCTION AND REPORT ANY ERRORS OR OMISSIONS TO DEPARTMENTAL REPRESENTATIVE.
- CONTRACTORS MUST VISIT THE SITE & FULLY FAMILIARIZE THEMSELVES WITH THE SCOPE OF THE WORK.
- PREVENT THE SPREAD OF DUST & DEBRIS BEYOND THE
- WORK AREA AND CLEAN ALL SURFACES AT COMPLETION. MAKE GOOD ALL SURFACES AFFECTED BY THIS WORK.
- COORDINATE ALL SHUTDOWNS WITH THE DEPARTMENTAL REPRESENTATIVE.
- PROVIDE ALL LABOUR AND MATERIAL REQUIRED TO FORM A COMPLETE, FUNCTIONAL SYSTEM AS DESCRIBED ON DRAWINGS.

	·		
	·		
	·		
0	JAN. 2014	ISSUED FOR TENDER	JWG
No.	Date	Revision	By: Par:
Data	Data Brinted DD MM WW		

Date imprimée Date Printed DD MM YYYY

 Verify all dimensions and site conditions and be responsible for same Vérifier toutes les dimensions et l'état des liéux et en assumer la responsabilité

A Detail no. No. du détail B Location drawing no. sur dessin no.

C Drawing no. dessin no. BUILDING M-50- ELECTRICAL HIGH BAY ROOF TOP UNITS REPLACEMENTS


MONTREAL ROAD CAMPUS

PARTIAL FLOOR PLANS- MECHANICAL AND ELECTRICAL NEW WORK AND DEMOLITION

designed	conçu	date date
JWG/DIF		JAN 2014
drawn	dessiné	scale échelle
JWG/DIF		AS INDICATED
checked	vérifié	sheet feuille
		2 of/de 3
approved	approuvé	W.O.no. D.T.no.
BV		A1-000506-42


dessin no.

3873-G02

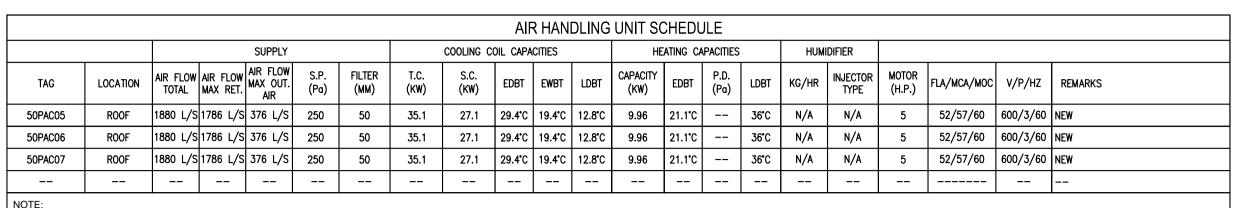

NOTE:


NEW AIR HANDLING UNITS ARE BASED ON CARRIER MODEL 50HCDB11 C/W DX COOLING COIL, ELECTRIC HEATING, NO HUMIDIFICATION AND TEMPERATURE SENSOR/ CONTROLLERS LOCATED AS INDICATED. PROVIDE CO2 SENSOR IN RETURN AIR FOR OUTDOOR NEW AIR HANDLING UNIT CONTROLS ARE TO BE COMPATIBLE WITH BAS. REFER TO SPECIFICATIONS, SEQUENCE OF OPERATION AND DRAWINGS FOR ADDITIONAL INFORMATION.

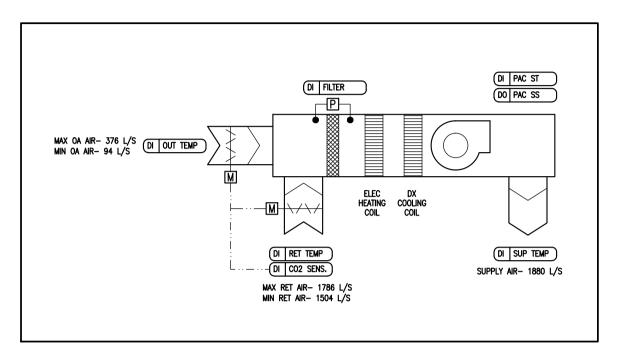

ROOF TOP UNITS CONTROLS SCHEMATIC

G03 SCALE: N.T.S. ELECTRICAL NOTES: <X>

- 1. EXISTING BUS DUCT #5. INSTALL NEW PLUG-IN UNIT IN THIS AREA.
- 2. INSTALL SPLITTER AND DISCONNECTS FOR ROOFTOP UNIT IN THIS LOCATION.

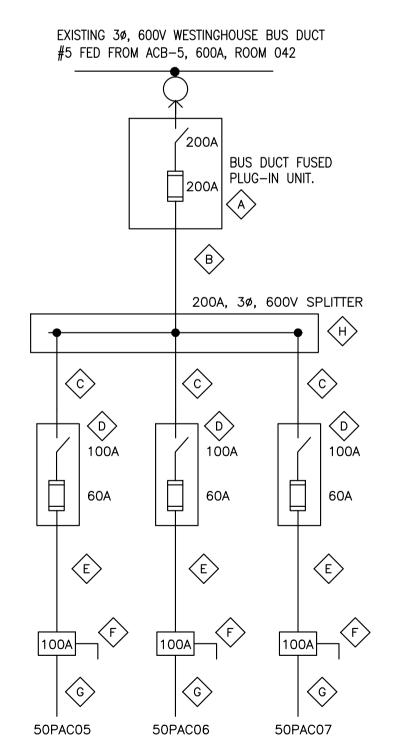

SINGLELINE NOTES: (X)

PROVIDE THE FOLLOWING: A. 200A, 600V, 3Ø BUS DUCT PLUG-IN UNIT FUSED AT 200A.

- B. 3x 3/0 + GROUND IN 53mm EMT. C. 3x #6 + GROUND IN 27mm EMT.
- D. 100Å, 600V, 3Ø FUSED DISCONNECT, FUSED AT 60A.
- E. 3x #6 + GROUND IN 27mm EMT. CONDUIT IS TO BE ROUTED SUCH THAT IT DOES NOT INTERFERE WITH THE EXISTING CRANE.

 F. 100A, 600V, 3¢ DISCONNECT IN CSA TYPE 3R ENCLOSURE ATTACHED TO
- ROOFTOP UNIT.
- G. 3X #6 + GROUND IN 27MM LIQUID TIGHT FLEXIBLE CONDUIT.
- H. 200A, 600V, 3Ø SPLITTER.

 WIRE, DISCONNECT AND FUSE SIZES ARE BASED ON THE SPECIFIED CARRIER


 UNIT. CONFIRM WIRE, DISCONNECT AND FUSE SIZES WITH NAMEPLATES OF

 ACTUAL ROFFTOP UNIT SUPPLIED PRIOR TO INSTALLATION



PARTIAL SINGLELINE

SCALE: N.T.S.

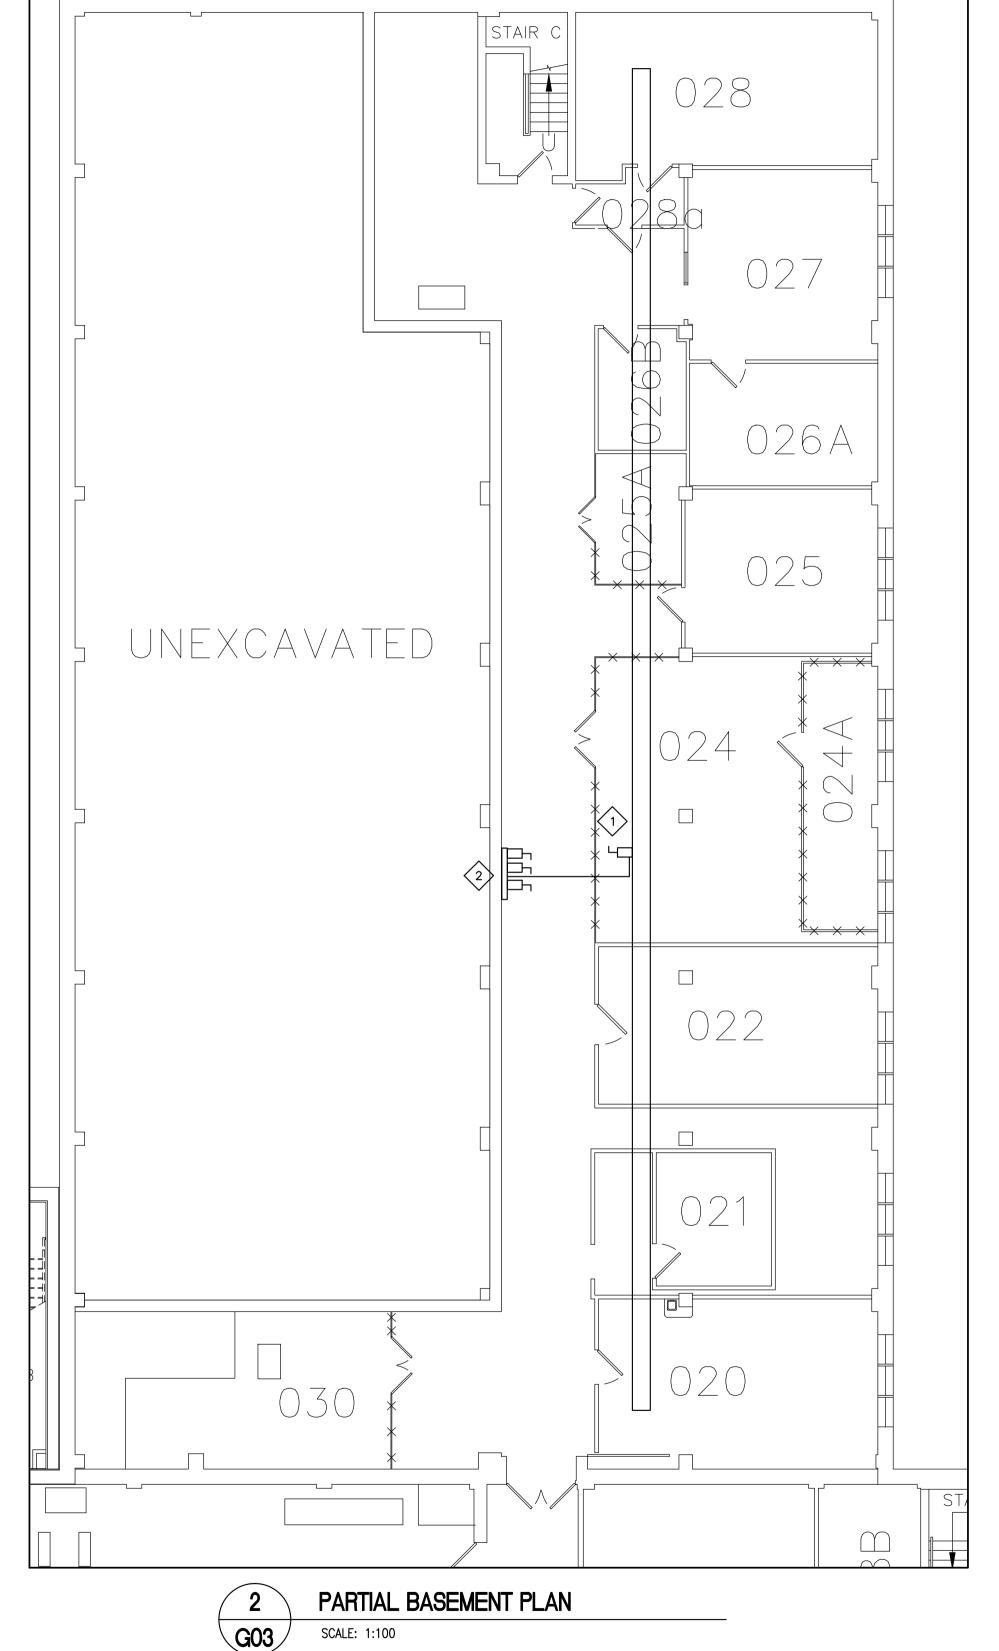

SCALE: 1:100

National Research Council Canada

NAC - CNAC

GENERAL NOTES

- CONTRACTORS TO CHECK AND VERIFY ALL DIMENSIONS ON SITE PRIOR TO DEMOLITION OR CONSTRUCTION AND REPORT ANY ERRORS OR OMISSIONS TO DEPARTMENTAL REPRESENTATIVE.
- CONTRACTORS MUST VISIT THE SITE & FULLY FAMILIARIZE THEMSELVES WITH THE SCOPE OF THE WORK.
- PREVENT THE SPREAD OF DUST & DEBRIS BEYOND THE WORK AREA AND CLEAN ALL SURFACES AT COMPLETION.
- MAKE GOOD ALL SURFACES AFFECTED BY THIS WORK.
- COORDINATE ALL SHUTDOWNS WITH THE DEPARTMENTAL REPRESENTATIVE.
- PROVIDE ALL LABOUR AND MATERIAL REQUIRED TO FORM A COMPLETE, FUNCTIONAL SYSTEM AS DESCRIBED ON DRAWINGS.

ISSUED FOR TENDER JAN. 2014 Date Printed DD MM YYYY Date imprimée

• Verify all dimensions and site conditions and be responsible

o Vérifier toutes les dimensions et l'état des liéux et en assumer la responsabilité

No. du détail B Location drawing no. sur dessin no. C Drawing no.

BUILDING M-50- ELECTRICAL HIGH BAY ROOF TOP UNITS REPLACEMENTS

MONTREAL ROAD CAMPUS

SCHEDULES AND DETAILS

designed JWG/DIF	conçu	date date JAN 2014
drawn JWG/DIF	dessiné	scale échelle AS INDICATED
checked	vérifié	sheet feuille 3 of/de 3
approved	approuvé	W.O.no. D.T.no.
BV		A1-000506-42

dessin no.

dwg.no.

3873-G03

ASPM A1 (841x594)