BAMFIELD LIFEBOAT STATION

FUEL SYSTEM UPGRADE

GENERAL NOTES

- 1. ALL CONSTRUCTION AND MATERIALS TO BE IN ACCORDANCE WITH THE CONTRACT DOCUMENTS, SPECIFICATIONS AND AS SHOWN ON THESE DRAWINGS.
- 2. CONTACT BC-1 (1-800-474-6886), BC HYDRO AND LOCAL GAS FOR UNDERGROUND UTILITY LOCATIONS PRIOR TO CONSTRUCTION.
- 3. PERFORM WORK IN ACCORDANCE WITH THE MOST RECENT EDITIONS OF NATIONAL BUILDING CODE, NATIONAL FIRE CODE, CEPA, CAN/CSA-B139 AND CAN/CSA-C282.
- 4. LOCATION OF ALL EXISTING SERVICES, FEATURES AND APPURTENANCES SHOWN ON THE DRAWINGS ARE TO BE CONSIDERED APPROXIMATE ONLY. VERIFY ALL LOCATIONS IN THE FIELD PRIOR TO CONSTRUCTION.
- OBTAIN ALL REQUIRED PERMITS. 5.
- 6. CONTRACTOR SHALL BE SOLELY RESPONSIBLE FOR CONSTRUCTION MEANS, METHODS, TECHNIQUES, SEQUENCES AND PROCEDURES AND CO-ORDINATING THE VARIOUS PARTS OF THE WORK.
- 7. DISPOSE OF ALL EXCAVATED MATERIAL UNSUITABLE FOR REUSE AT A SUITABLE OFF-SITE DISPOSAL AREA, IN ACCORDANCE WITH ALL APPLICABLE REGULATIONS.
- 8. ANY DAMAGE TO EXISTING SERVICES OR UTILITIES, INCLUDING ASPHALT AND CONCRETE SURFACES, SHALL BE REINSTATED TO AS-FOUND OR BETTER CONDITION.
- 9. ANY SURVEY MONUMENT DISTURBED DURING CONSTRUCTION SHALL BE REPLACED AT THE EXPENSE OF THE CONTRACTOR.
- 10. OVERHEAD WIRING IS NOT SHOWN ON THE CONTRACT DRAWINGS.
- 11. ALL SITES AFFECTED BY CONSTRUCTION SHALL BE RESTORED TO AS FOUND OR BETTER CONDITION.
- 12. CAREFULLY RELOCATE EXISTING LANDSCAPE FEATURES AND SITE FEATURES TO ACCOMODATE CONSTRUCTION WORK, ALL SUCH ITEMS SHALL BE REPLACED TO ORIGINAL OR BETTER CONDITION, TO THE APPROVAL OF THE CONTRACT ADMINISTRATOR.
- 13. ALL DEBRIS AND EQUIPMENT FROM DEMOLITION AND CONSTRUCTION TO BE DISPOSED OF AT AN OFFSITE LOCATION APPROVED BY THE CONTRACT ADMINISTRATOR.
- 14. GROUND PLATES ARE AN ACCEPTABLE ALTERNATE TO GROUND RODS IF BEDROCK IS PRESENT.
- 15. SUB PANEL A1 TO BE LOCATED BESIDE EXISTING PANEL A FACING INTO THE EXERCISE ROOM.
- 16. PUMP CONTROLLERS TO BE MOUNTED IN THE MECHANICAL ROOM.
- 17. WASHROOM FACILITIES ARE AVAILABE ON-SITE.
- 18. TESTING OF EXISTING UNDERGROUND FUEL PIPE IS NOT REQUIRED.
- 19. THE LEAK DETECTION SENSOR IN THE TANK PAD TRANSITION SUMP, SHOWN ON DRAWING M-01 IS NOT REQUIRED. REMOVE FROM CONTRACT.
- 20. THE APPROXIMATE WEIGHT OF THE OWNER SUPPLIED FUEL TANK AND STAIRS IS 4082 KG (9000 LBS).


LIST OF DRAWINGS


COVER SHEET

M-01 - BAMFIELD LIFEBOAT STATION - SITE LAYOUT AND PIPING DETAILS


- E-01 SITE PLAN, GROUNDING GRID AND LEGEND
- E-02 SINGLE LINE DIAGRAMS
- E-03 LIGHTING DETAILS AND TRENCH SECTION

DWG. NO.	DRAWING REFERENCES	NOTES

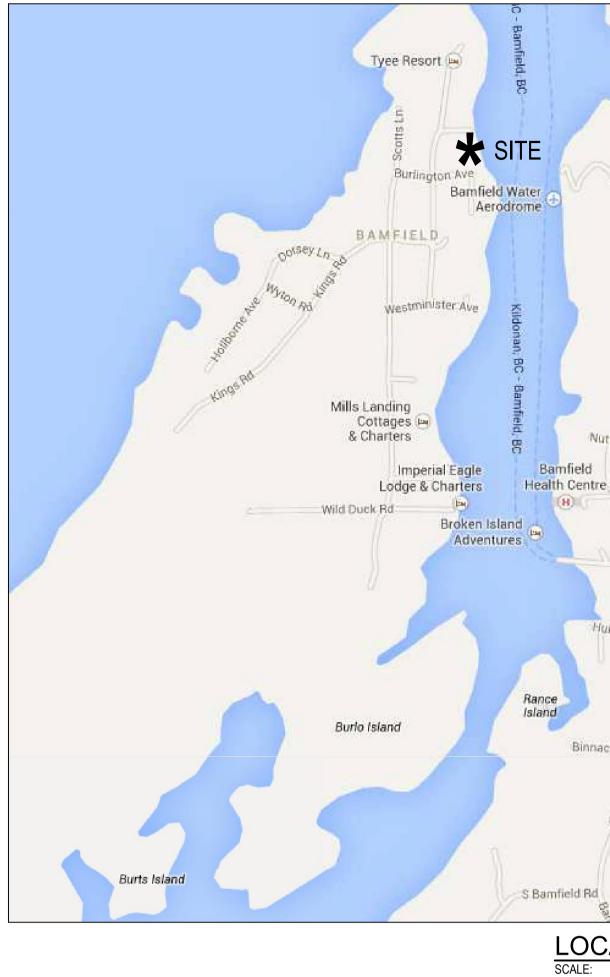

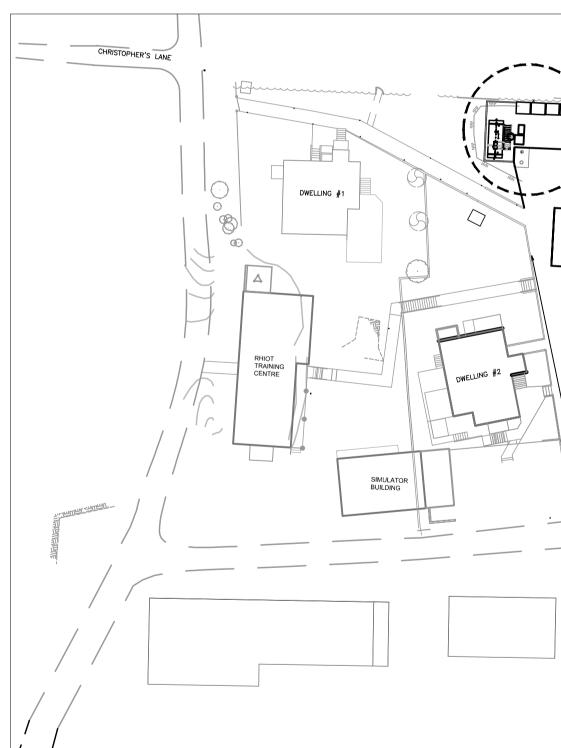

SCAL

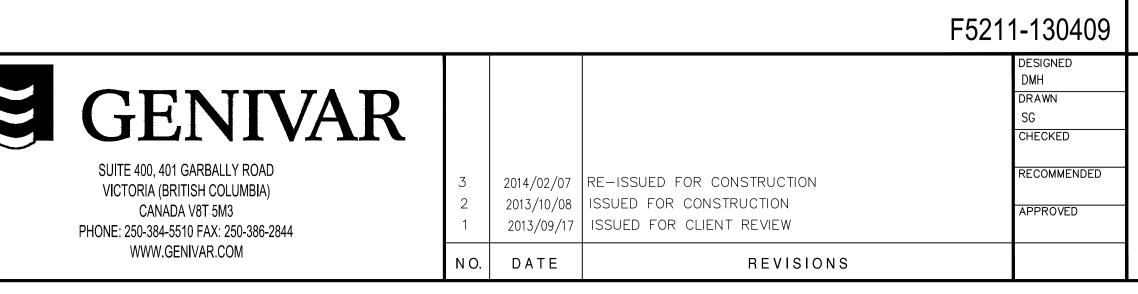

Thatch Rd Thatch Rd Rocky Ln Tower Rd N Rd Mr Rd			
De Rd Binnacle Rd			
LOCATION OF WORKS			
TE PLAN LE: 1:500			
FISHERIES AND OCEANS CANADA REAL PROPERTY AND SAFETY AND SECURITY			
BAMFIELD LIFEBOAT STATION	SCALE AS NOTED START DATE		
FUEL SYSTEM UPGRADE COVER SHEET	7/31/2013 DRAWING NUMBER		
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