

1 LETHBRIDGE RESEARCH CENTRE SITE PLAN E-0.1 SCALE N.T.S.

SYMBOL LEGEND:

POWER

MISCELLANEOUS CABINETS AS INDICATED

208V PANELBOARD — SURFACE MOUNTED DISCONNECT SWITCH

JUNCTION BOX - CEILING MOUNTED

SECURITY

) AUDIO/ VISUAL ALARM — CEILING MOUNTED

CR CARD READER

CRK CARD READER WITH A KEYPAD

DOOR POSITION SWITCH

ES ELECTRIC DOOR STRIKE

M MAGNETIC DOOR LOCK

SECURITY CAMERA

ACCESS CONTROL PANEL

COMMUNICATION

TELEPHONE PANEL

FIBER OPTIC

### ABBREVIATIONS

ERL - EXISTING TO BE RELOCATED

R — EXISTING TO BE REMOVED

RL - NEW LOCATION OF RELOCATED DEVICE

N — NEW
E — EXISTING TO REMAIN

## SCOPE OF WORK IDENTIFICATION

REFER TO SPECIFICATION SECTION 260502— SCOPES OF WORK FOR WRITTEN DESCRIPTION OF EACH DEFINED SCOPE OF WORK.

(A##) - ACCESS CONTROL SYSTEM SCOPE OF WORK

⟨C##⟩ - CCTV SCOPE OF WORK

— MISCELLANEOUS/MIXED/OTHER SCOPE OF WORK

### **DRAWING LIST:**

RAWING NUMBER	DRAWING TITLE
E-0.1	SITE PLAN, DRAWING LIST, SYMBOL LEGEND
E-1.1	LRC BASEMENT SECURITY PLAN
E-1.2	LRC MAIN FLOOR (WEST) SECURITY PLAN
E-1.3	LRC MAIN FLOOR (EAST) SECURITY PLAN
E-1.4	LRC SECOND FLOOR SECURITY PLAN
E-1.5	LRC THIRD FLOOR SECURITY PLAN
E-1.6	LRC SECURITY DETAILS
E-1.7	LRC SECURITY DETAILS
E-1.8	LRC SECURITY DETAILS
E-2.1	LRC OUTBUILDINGS SECURITY PLAN
E-2.2	LRC OUTBUILDINGS SECURITY PLAN
S1	STRUCTURAL NOTES

STRUCTURAL DETAILS

Public Works and Travsaux publics et
Government Services Services gouvernmentaux
Canada

Agriculture and Agriculture et Agriculture Canada

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 14/04/08

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 14/03/26

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ELECTRONIC SECURITY
SYSTEM UPGRADES

LETHBRIDGE RESEARCH CENTRE

Lethbridge, Alberta

SITE PLAN, DRAWING LIST, SYMBOL LEGEND


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Project Manager Administrateur number

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E-0.1

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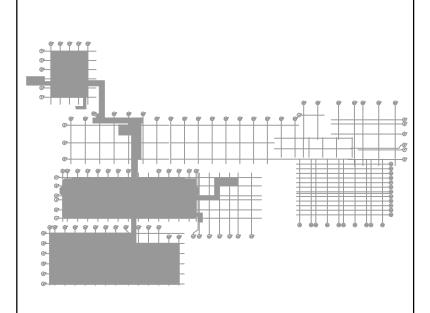
Agriculture and Agriculture et Agriculture Canada

Security consultant

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## KEY PLAN - BASEMENT N.T.S.

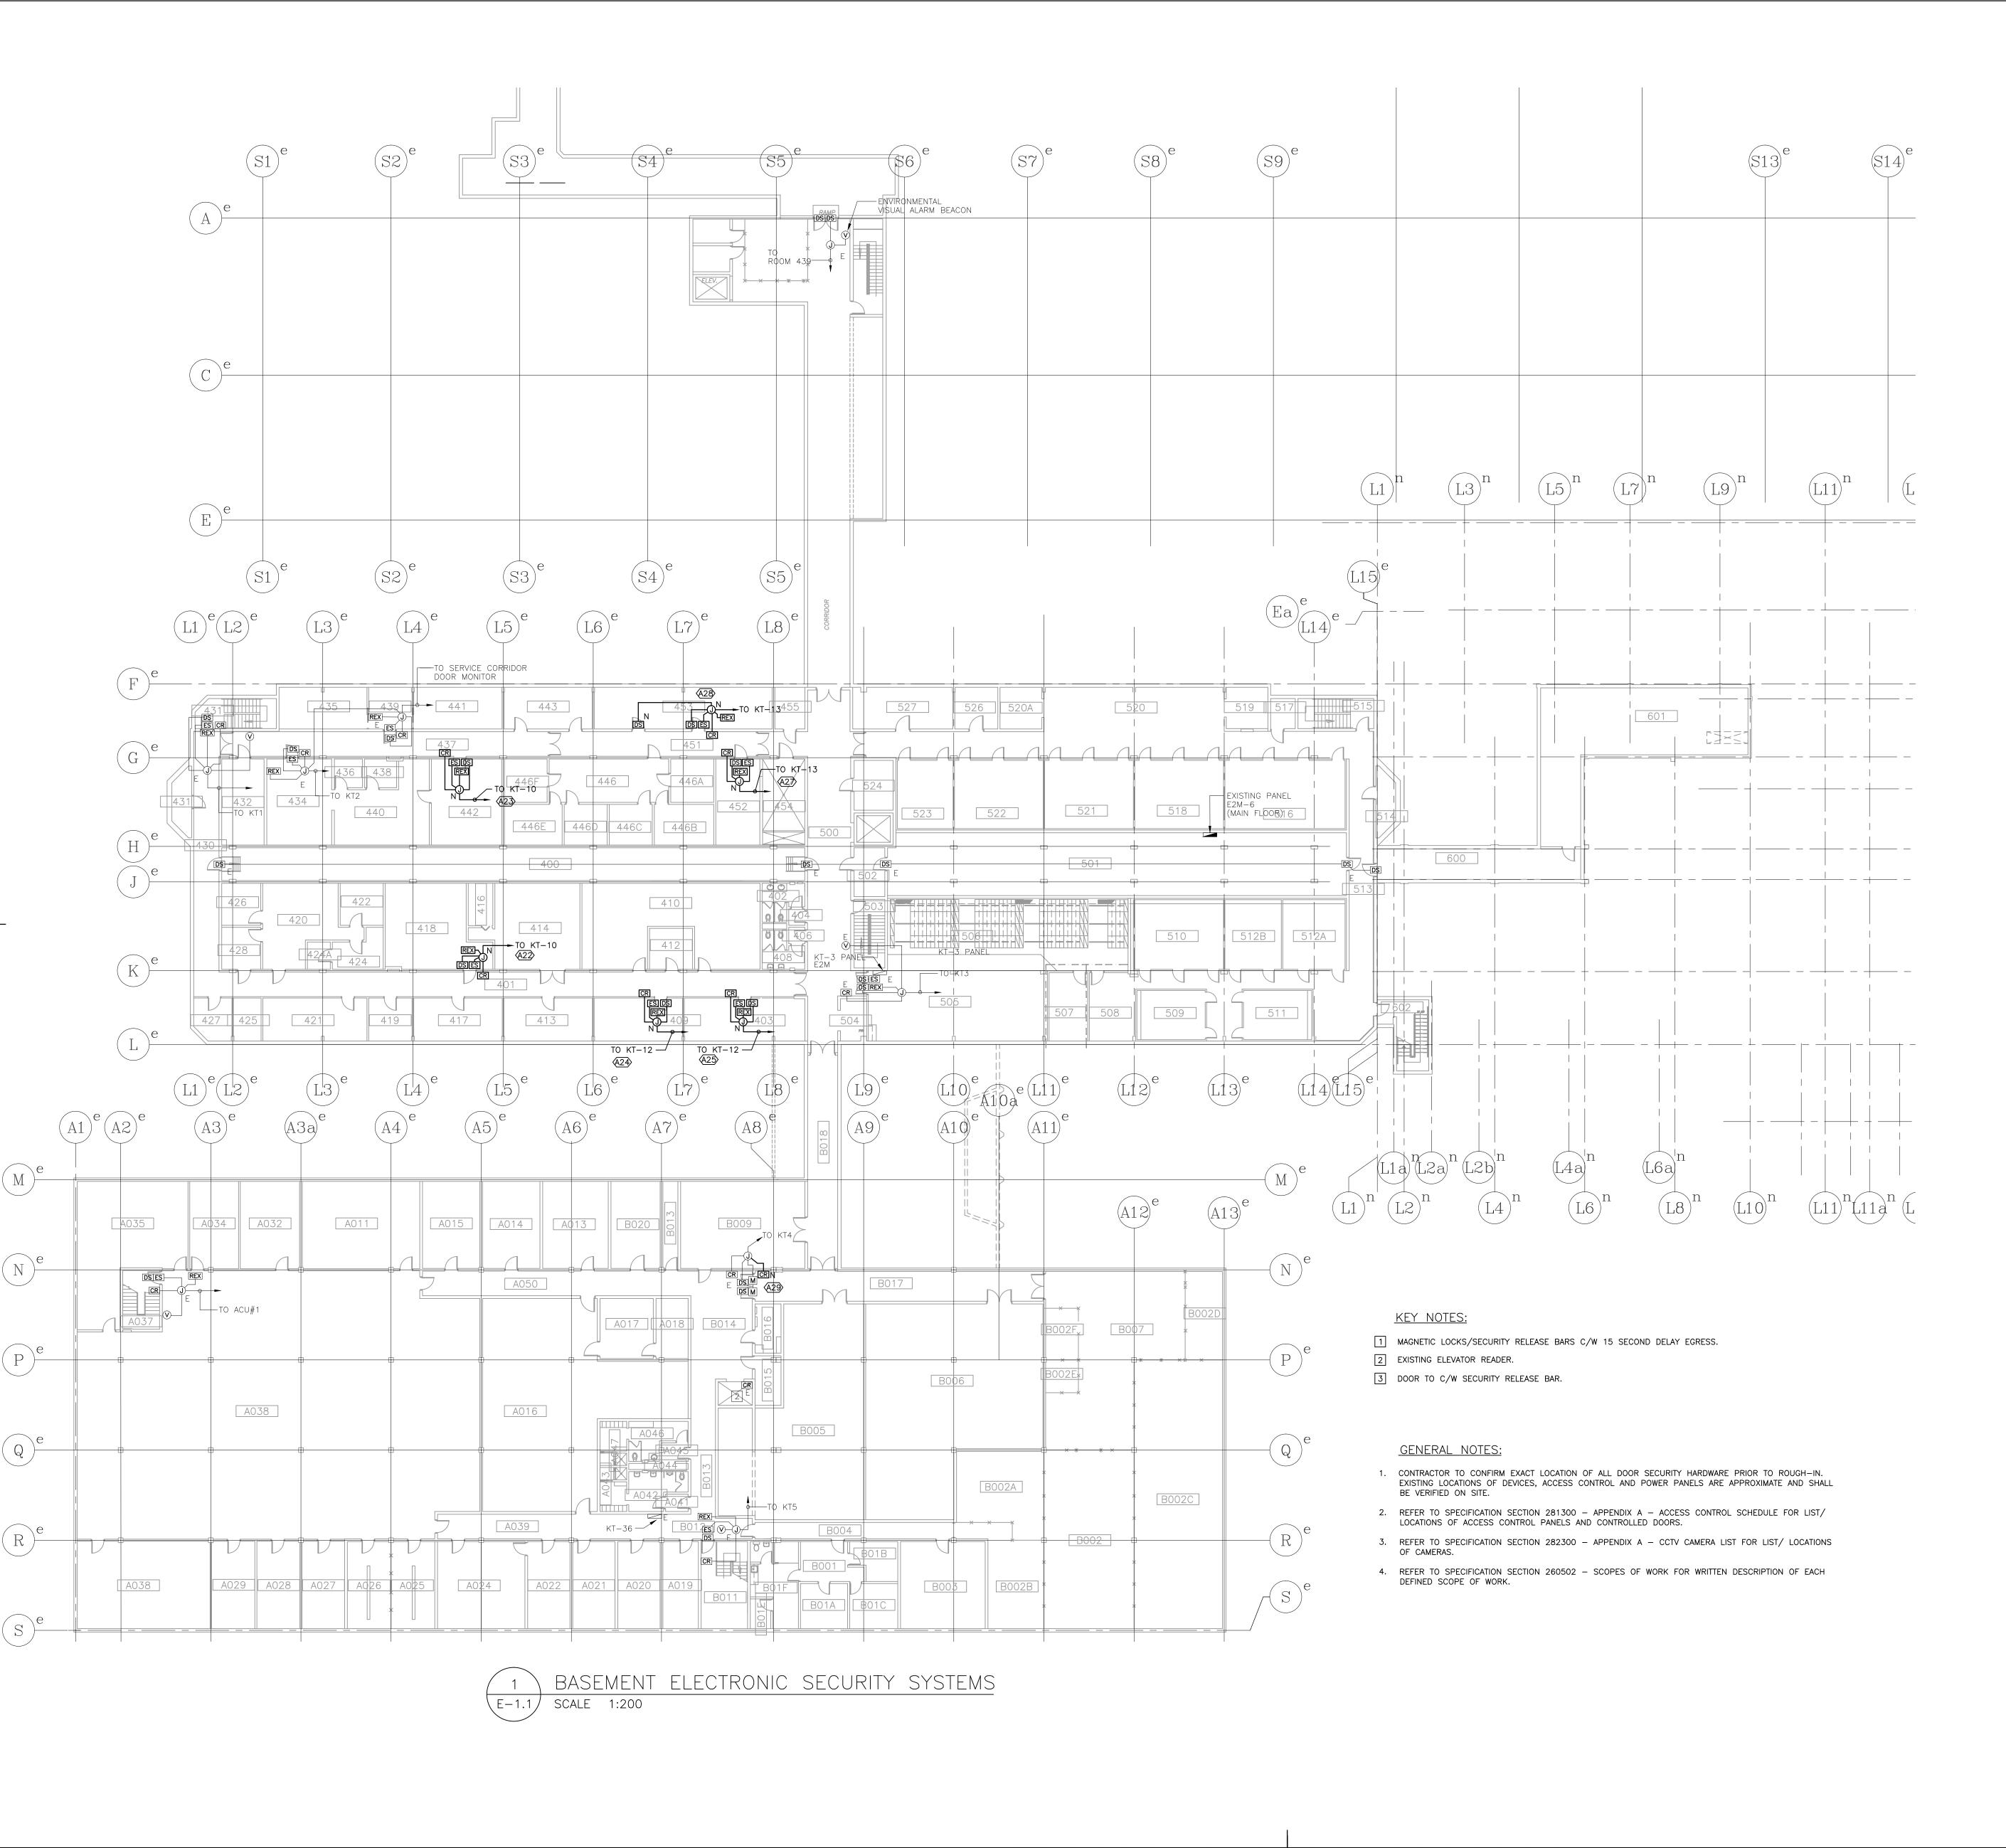D	ISSUED FOR TENDER		14/06/06
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Α	ISSUED FOR REVIEW		14/03/26
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ELECTRONIC SECURITY

SYSTEM UPGRADES

LETHBRIDGE RESEARCH CENTRE

Lethbridge, Alberta

BASEMENT OVERALL
PLAN — ELECTRONIC
SECURITY SYSTEMS

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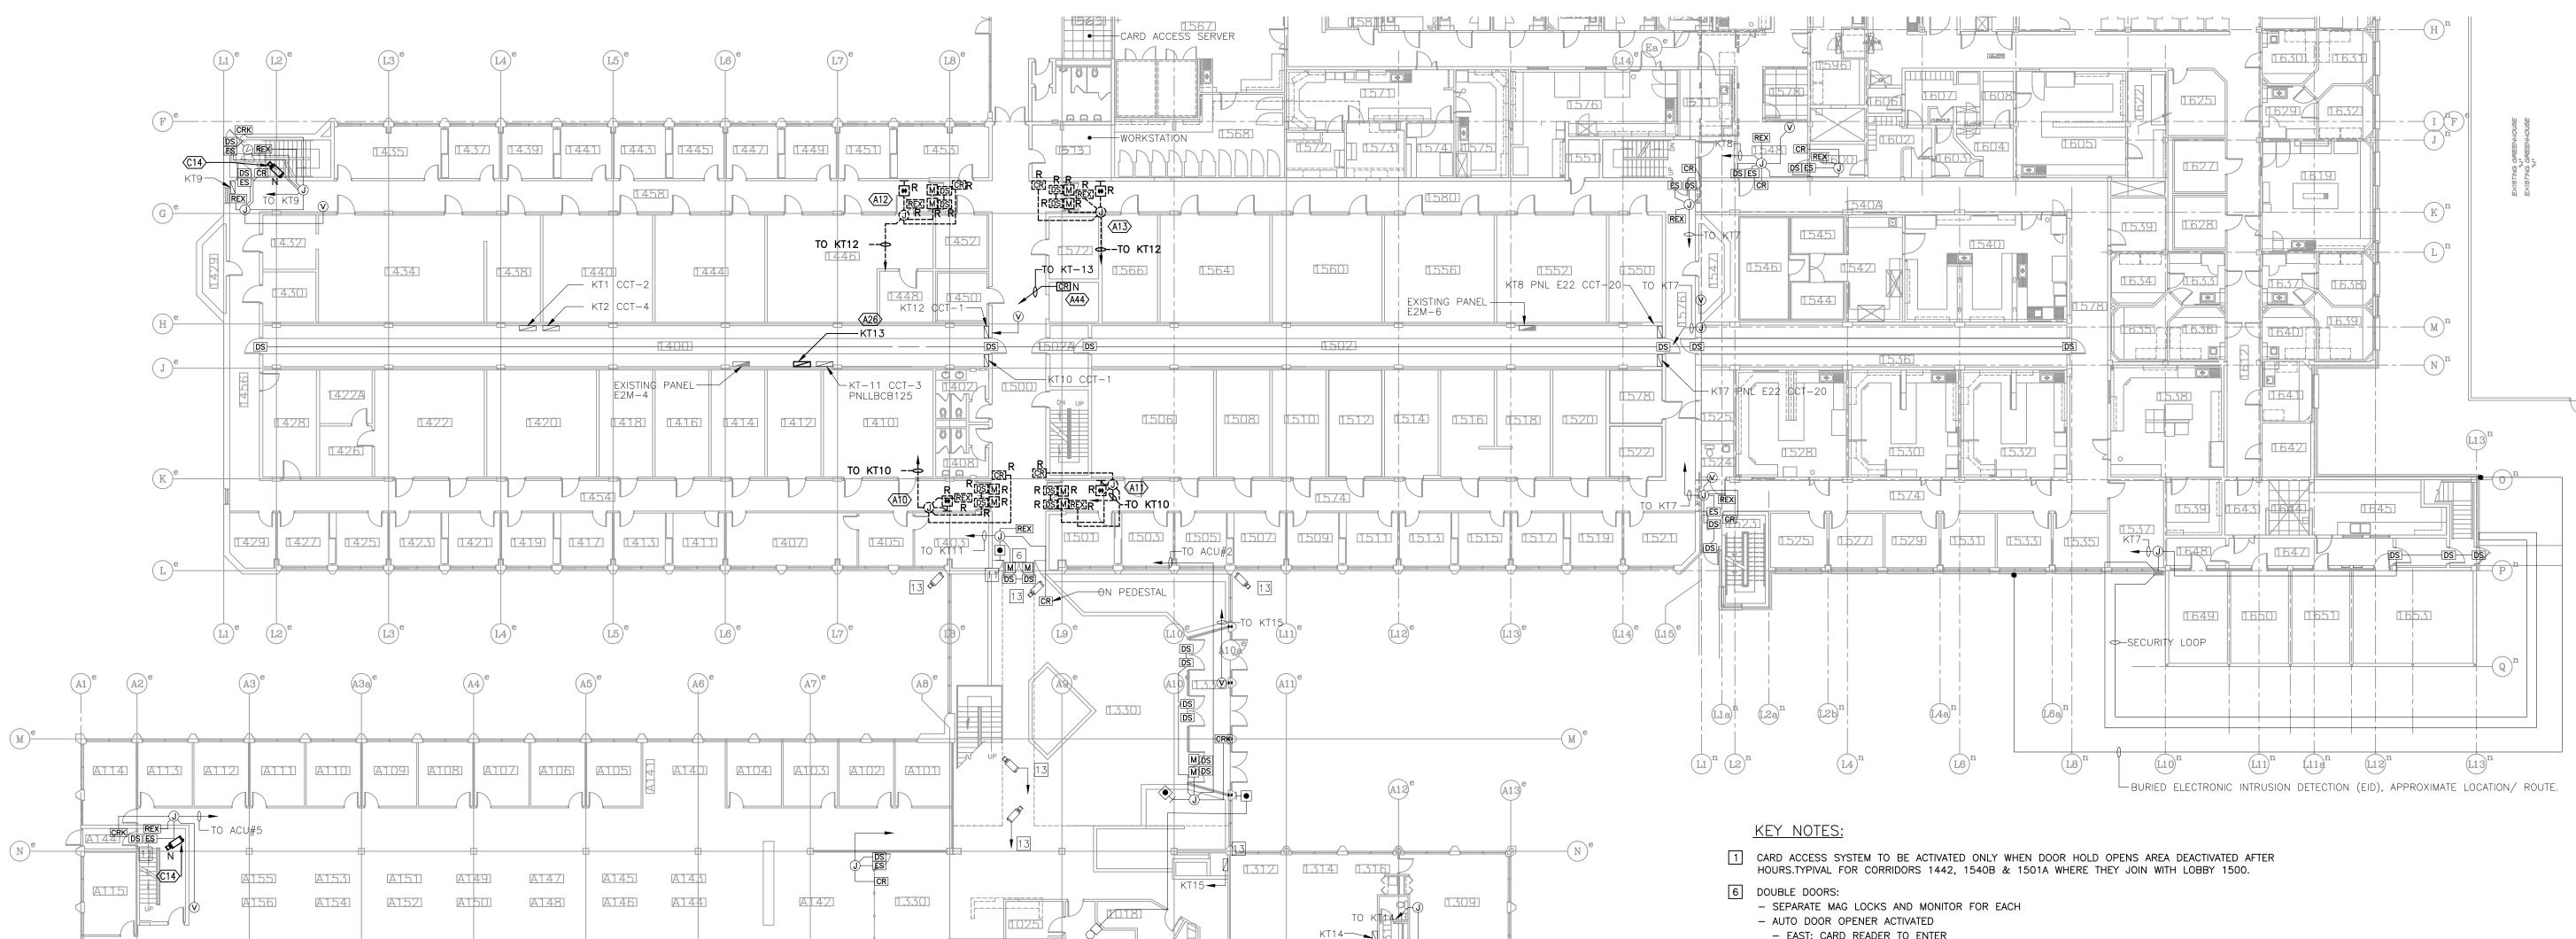
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E - 1.1

0 10 20 mm 40 60 80 100 120 140 160 180 200 mm



1006

1303A

MAIN FLOOR - ADMINISTRATION & SERVICE WING SCALE 1:200

A130

A137

A1391 A1381

A131

A120

A1361

A123 A124

A157

A158

A132

A162

A119

A1161

A169

A161

A128

A164

A133

A134

A1631

A1251 A1261 A1271

- EAST: CARD READER TO ENTER - EXIT BUTTON OR MOTION TO EXIT
- 8 MAGNETIC LOCKS/SECURITY RELEASE BARS C/W 15 SECOND DELAY EGRESS.
- 9 KEY SWITCH TO DE-ACTIVATE (TIME DELAY PROGRAMMABLE UP TO 4 HOURS) ALARM & OPEN DOORS.
- 10 DOOR STRIKE/ SECURITY RELEASE BAR C/W15 SECONDS DELAY EGREES.
- 13 EXISTING/ NEW CCTV CAMERAS ARE CABLED TO CCTV DVR IN CLOSET ADJACENT TO COMISSIONARIE'S DESK.

**GENERAL NOTES:** 


- 1. CONTRACTOR TO CONFIRM EXACT LOCATION OF ALL DOOR SECURITY HARDWARE PRIOR TO ROUGH-IN. EXISTING LOCATIONS OF DEVICES, ACCESS CONTROL AND POWER PANELS ARE APPROXIMATE AND SHALL BE VERIFIED ON SITE.
- 2. REFER TO SPECIFICATION SECTION 281300 APPENDIX A ACCESS CONTROL SCHEDULE FOR LIST/ LOCATIONS OF ACCESS CONTROL PANELS AND CONTROLLED DOORS.
- 3. REFER TO SPECIFICATION SECTION 282300 APPENDIX A CCTV CAMERA LIST FOR LIST/ LOCATIONS OF CAMERAS.
- 4. REFER TO SPECIFICATION SECTION 260502 SCOPES OF WORK FOR WRITTEN DESCRIPTION OF EACH

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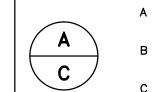
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A detail number number du detail B source drawing no. de dessin no.

BC C detail on drawing no. detail sur dessin no. ELECTRONIC SECURITY

LETHBRIDGE RESEARCH CENTRE

SYSTEM UPGRADES

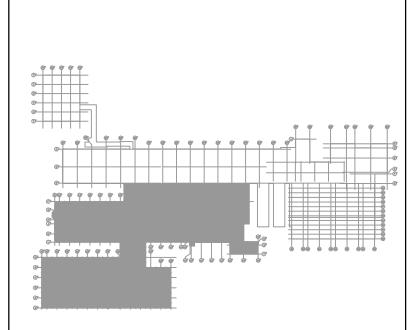Lethbridge, Alberta

MAIN FLOOR PLAN LAB BUILDING & ADMINISTRATION BUILDING - ELECTRONIC SECURITY SYSTEMS

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PWGSC Project Manager Administrateur de projets TPSGC


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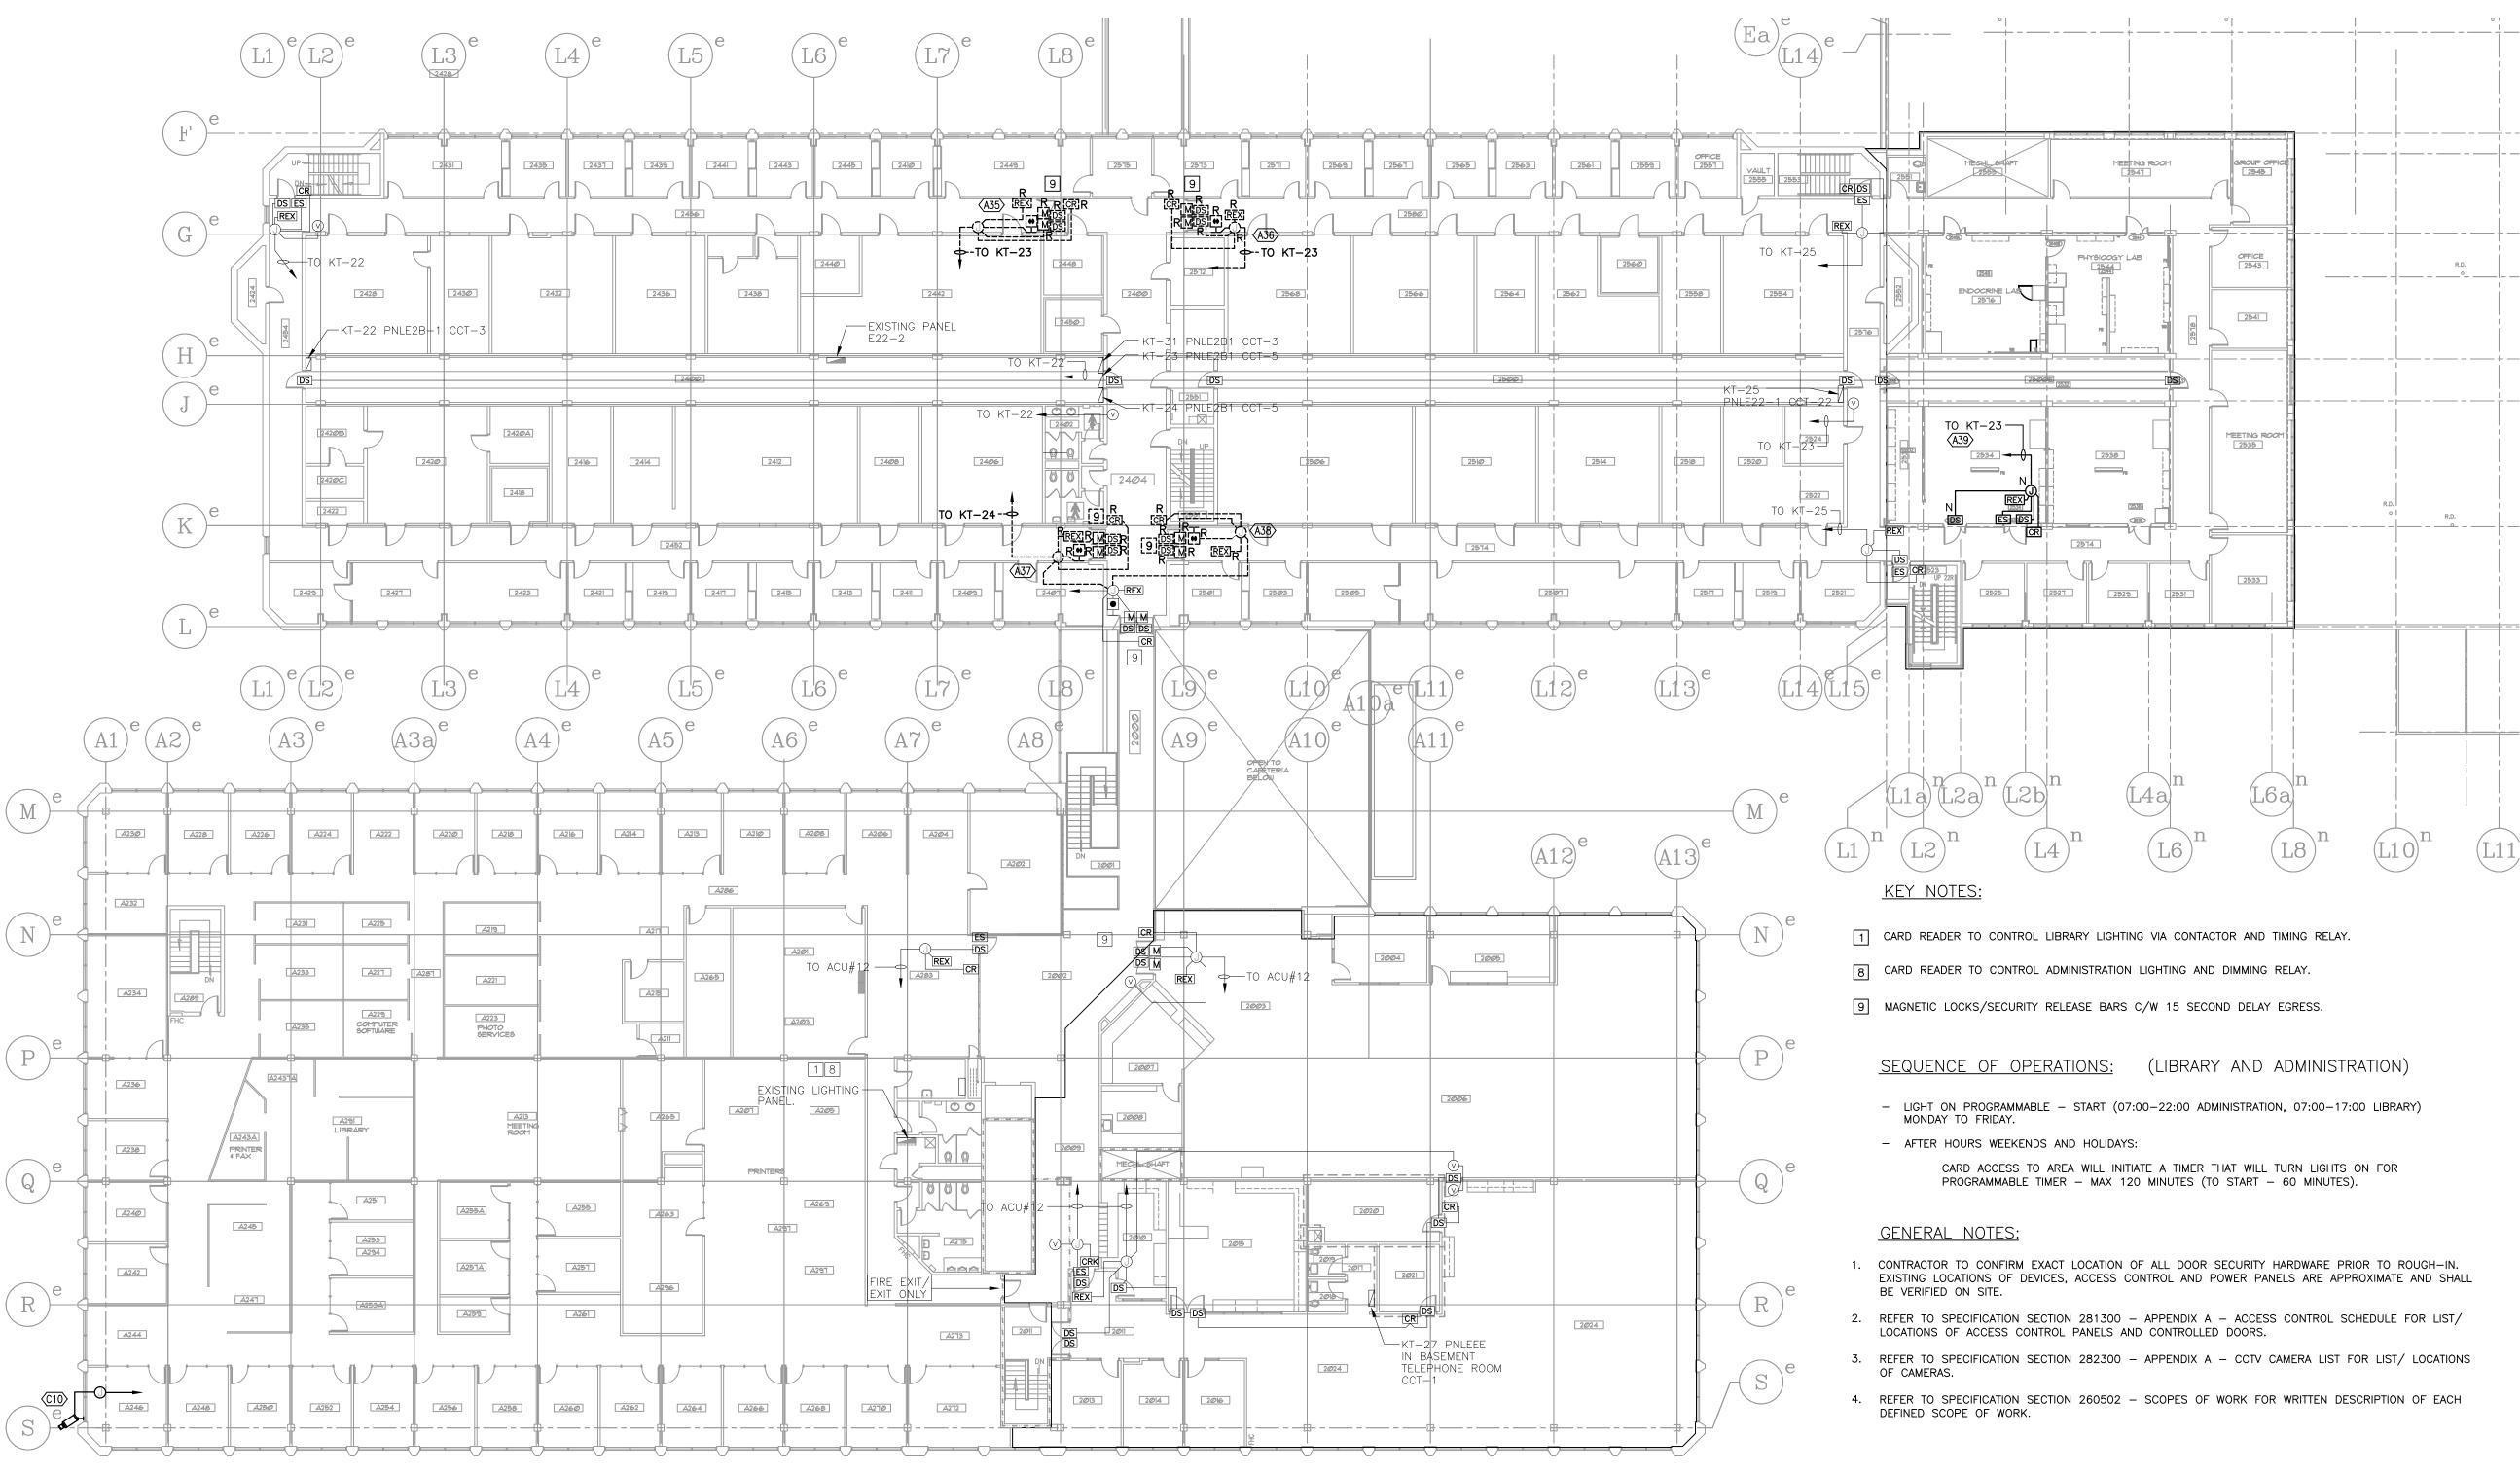
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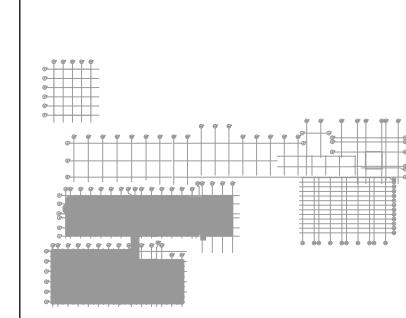
SECOND FLOOR

E-1.4 SCALE 1:200

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KEY PLAN - 2ND FLOOR
N.T.S.

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ELECTRONIC SECURITY

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Lethbridge, Alberta

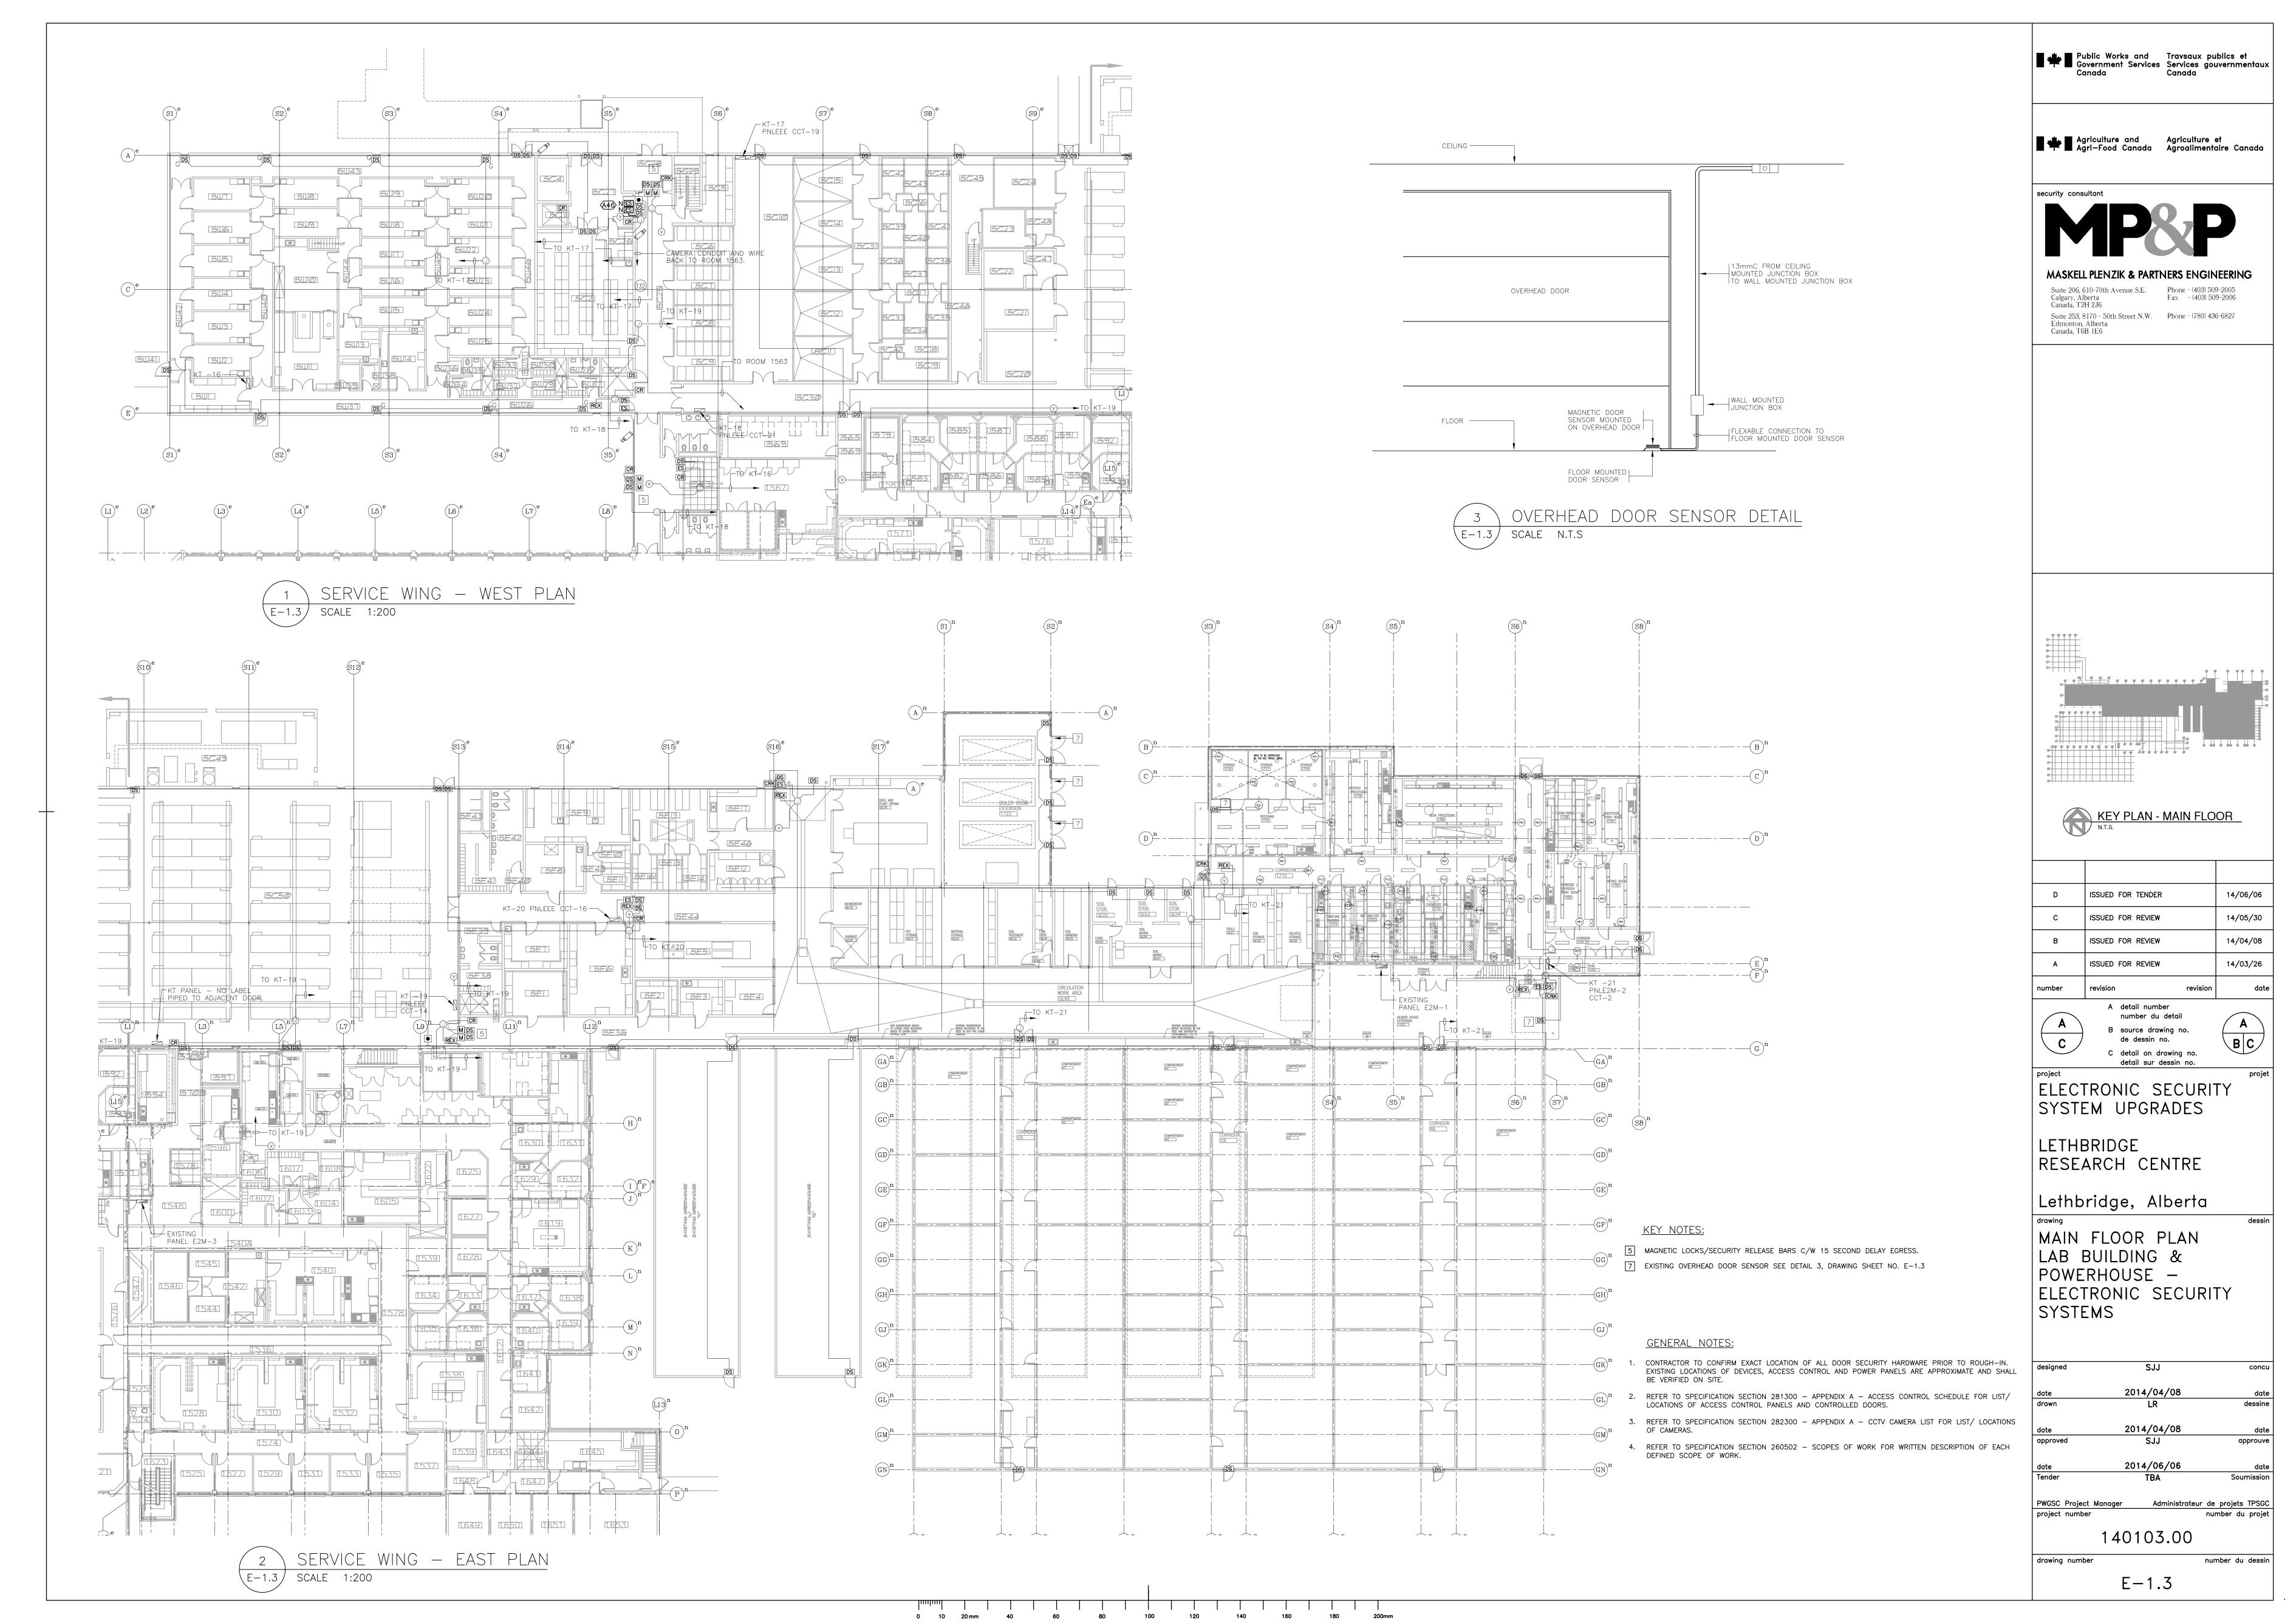SECOND FLOOR PLAN —
ELECTRONIC SECURITY
SYSTEMS

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date 2014/04/08 date
approved SJJ approuve


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KEY NOTES:

1 CARD ACCESS WHEN ACTIVATED TURNS POWER ON EXISTING CONTACTOR TO CENTRIFUGE RECEPTACLE (ROOM 3568) FOR 120 MIN. VIA EXISTING CONTROL RELAY.

4 MAGNETIC LOCKS/SECURITY RELEASE BARS TO C/W 15 SECOND DELAY EGRESS.

**GENERAL NOTES:** 

- 1. CONTRACTOR TO CONFIRM EXACT LOCATION OF ALL DOOR SECURITY HARDWARE PRIOR TO ROUGH-IN. EXISTING LOCATIONS OF DEVICES, ACCESS CONTROL AND POWER PANELS ARE APPROXIMATE AND SHALL BE VERIFIED ON SITE.
- 2. REFER TO SPECIFICATION SECTION 281300 APPENDIX A ACCESS CONTROL SCHEDULE FOR LIST/ LOCATIONS OF ACCESS CONTROL PANELS AND CONTROLLED DOORS.
- 3. REFER TO SPECIFICATION SECTION 282300 APPENDIX A CCTV CAMERA LIST FOR LIST/ LOCATIONS
- 4. REFER TO SPECIFICATION SECTION 260502 SCOPES OF WORK FOR WRITTEN DESCRIPTION OF EACH DEFINED SCOPE OF WORK.
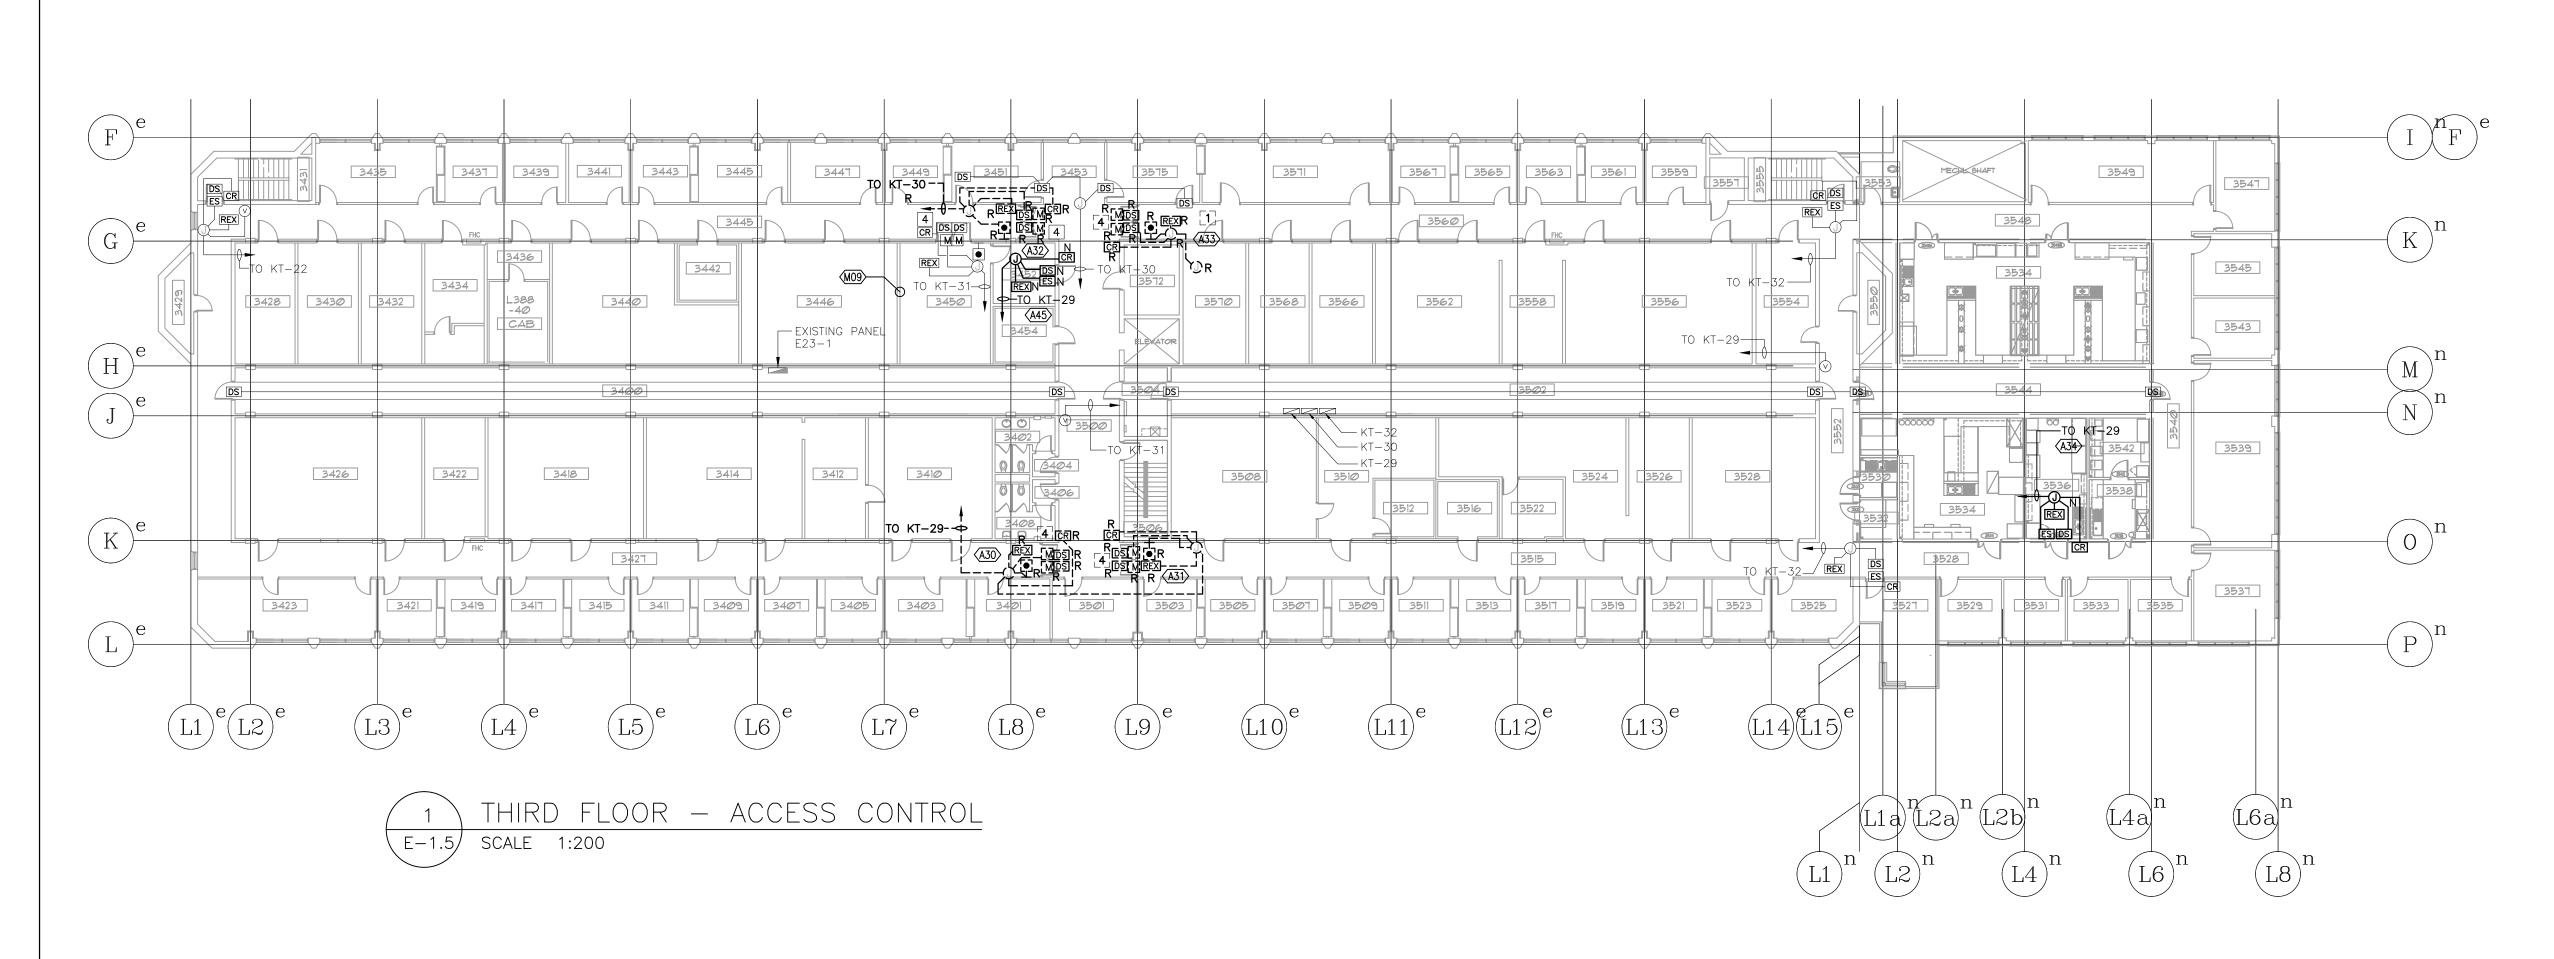
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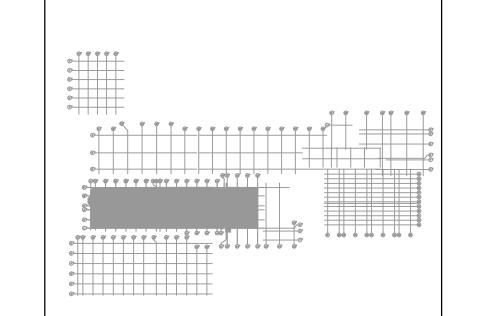
Agriculture and Agriculture et


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ELECTRONIC SECURITY SYSTEM UPGRADES

LETHBRIDGE RESEARCH CENTRE


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THIRD FLOOR PLAN -ELECTRONIC SECURITY SYSTEMS


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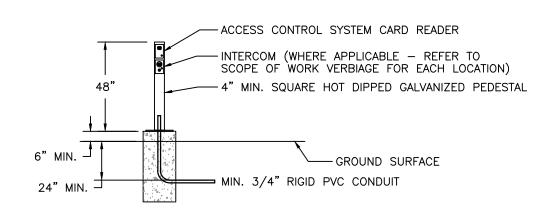
E - 1.5



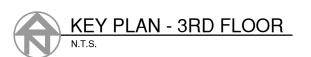

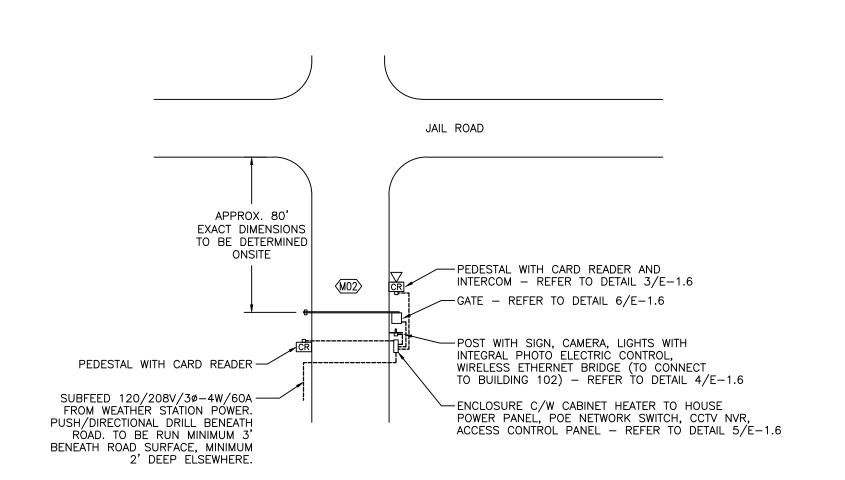

2 FUEL TANKS WEST OF BUILDING 122 E-1.6 SCALE N.T.S.

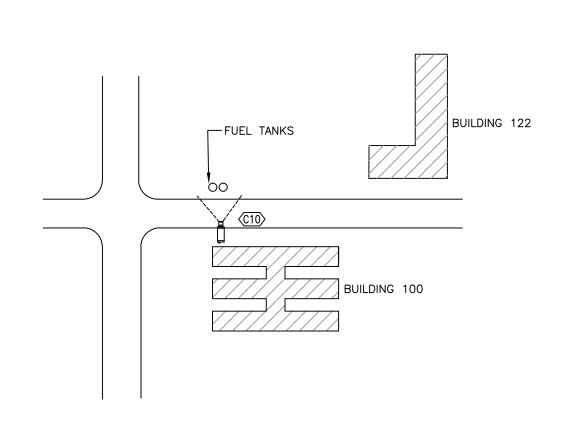


NOTES:

1. CARD READER & INTERCOM (WHERE APPLICABLE) SHALL FACE TOWARD APPROACHING VEHICLE. COORDINATE PLACEMENT/ORIENTATION WITH FACILITY MANAGER.

2. REFER TO MANUFACTURER'S INSTALLATION INSTRUCTIONS FOR ANCHOR BOLT REQUIREMENTS.

3. REFER TO STRUCTURAL DRAWINGS S1 AND S2 FOR DETAILS OF STRUCTURE/CONCRETE/REINFORCEMENT FOR GATE, POST, ENCLOSURE, AND PEDESTALS.


3 TYPICAL PEDESTAL DETAIL E-1.6 SCALE N.T.S.

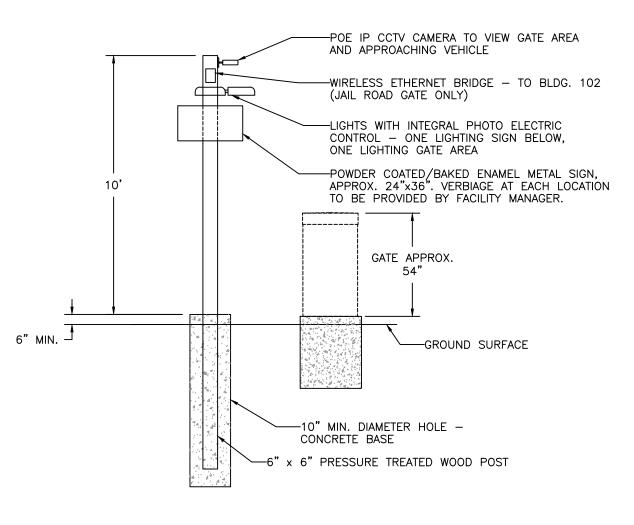

NOTES:
1. REFER TO STRUCTURAL DRAWINGS S1 AND S2 FOR DETAILS OF STRUCTURE/CONCRETE/ REINFORCEMENT FOR GATE, POST, ENCLOSURE, AND



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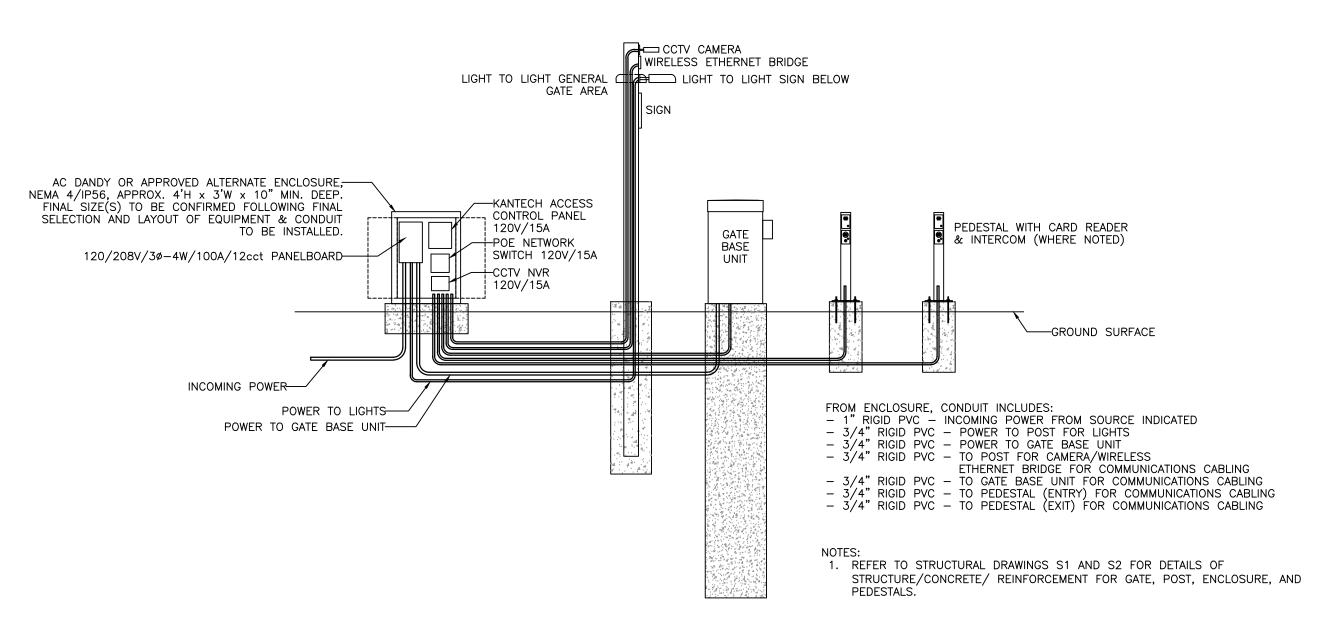
NOTES:

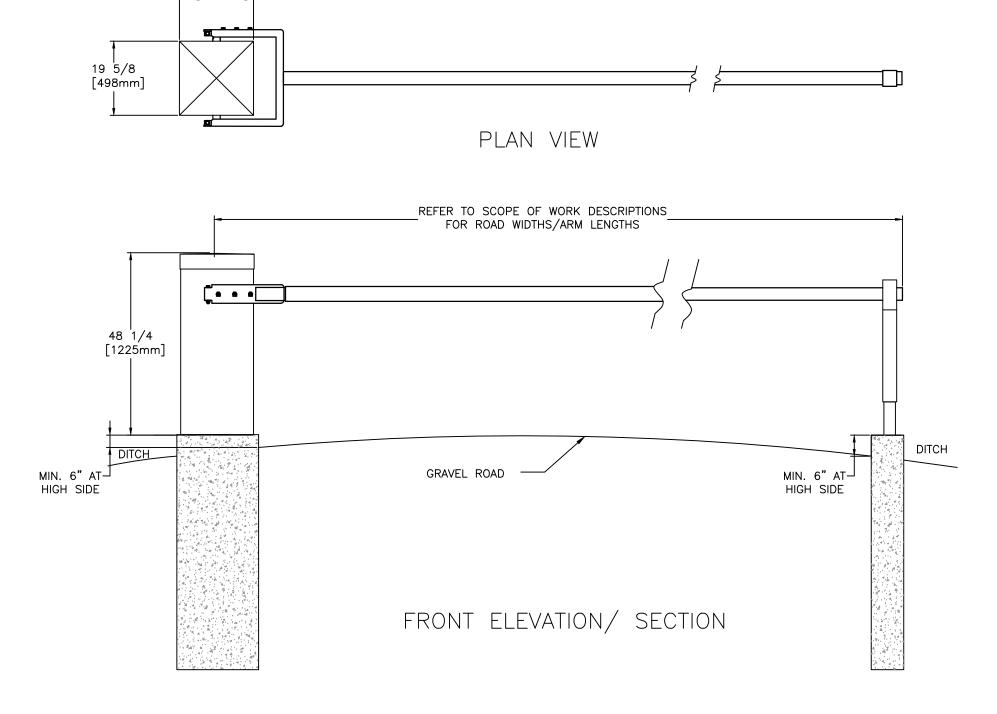1. GATE INSTALLATION SHALL FULLY COMPLY WITH MANUFACTURER'S INSTALLATION INSTRUCTIONS/DETAILS, AS WELL AS APPLICABLE CODES.


2. REFER TO MANUFACTURER'S INSTALLATION INSTRUCTIONS FOR ANCHOR BOLT REQUIREMENTS.

3. REFER TO STRUCTURAL DRAWINGS S1 AND S2 FOR DETAILS OF STRUCTURE/CONCRETE/REINFORCEMENT FOR GATE, POST, ENCLOSURE, AND PEDESTALS.





5 TYPICAL GATE ENCLOSURE/CONDUIT DETAIL E-1.6 SCALE N.T.S.

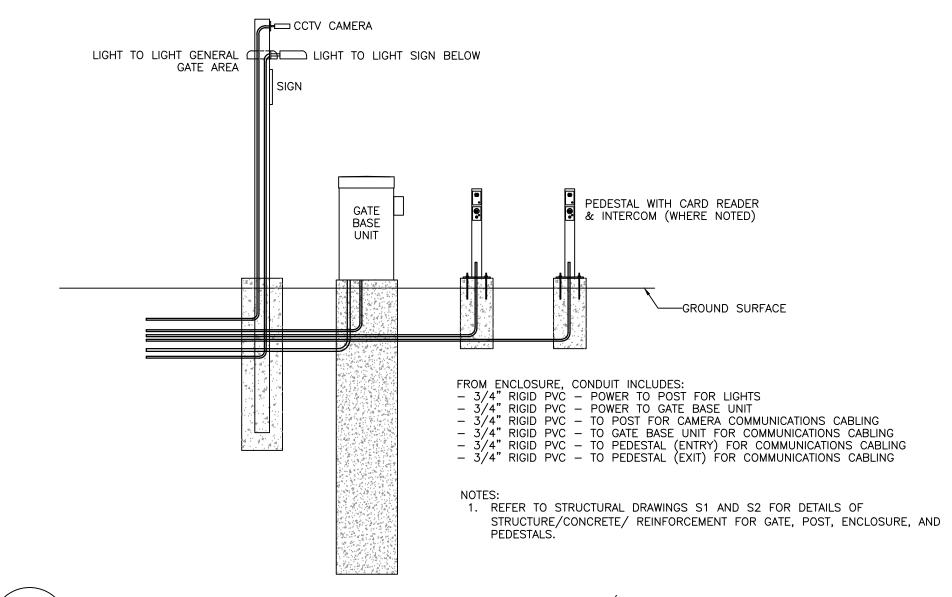

7 TYPICAL GATE WITHOUT ENCLOSURE/CONDUIT DETAIL E-1.6) SCALE N.T.S.

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ELECTRONIC SECURITY SYSTEM UPGRADES

LETHBRIDGE RESEARCH CENTRE

Lethbridge, Alberta

LRC OUTBUILDINGS
SECURITY PLANS

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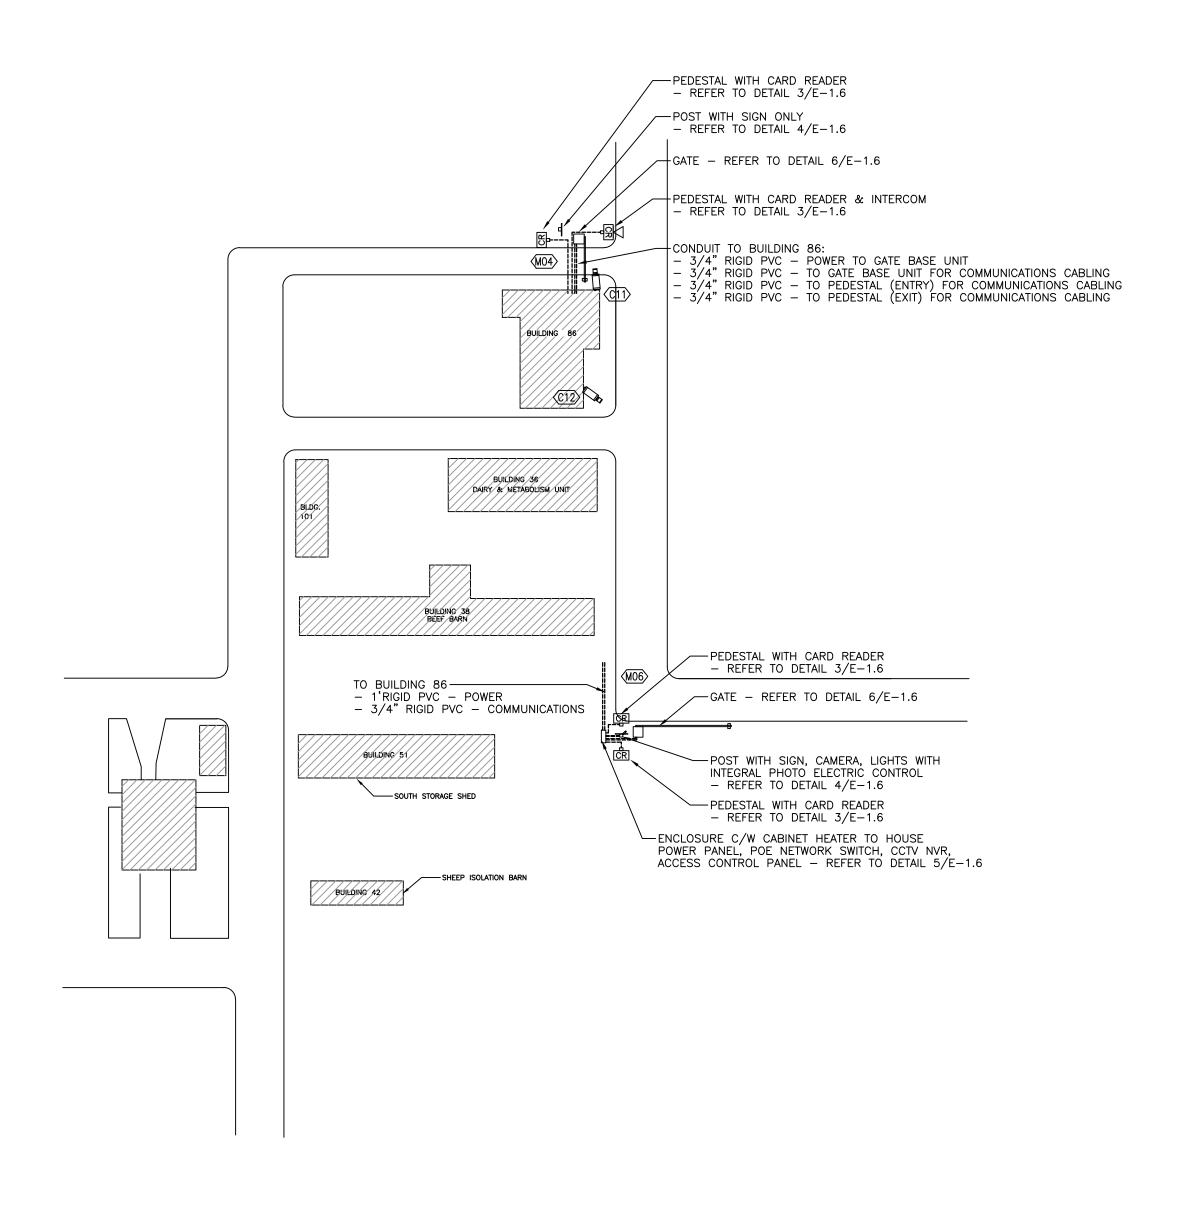
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1 DETAIL - AREA OF BUILDING 86 E-1.7) SCALE N.T.S.

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ELECTRONIC SECURITY SYSTEM UPGRADES

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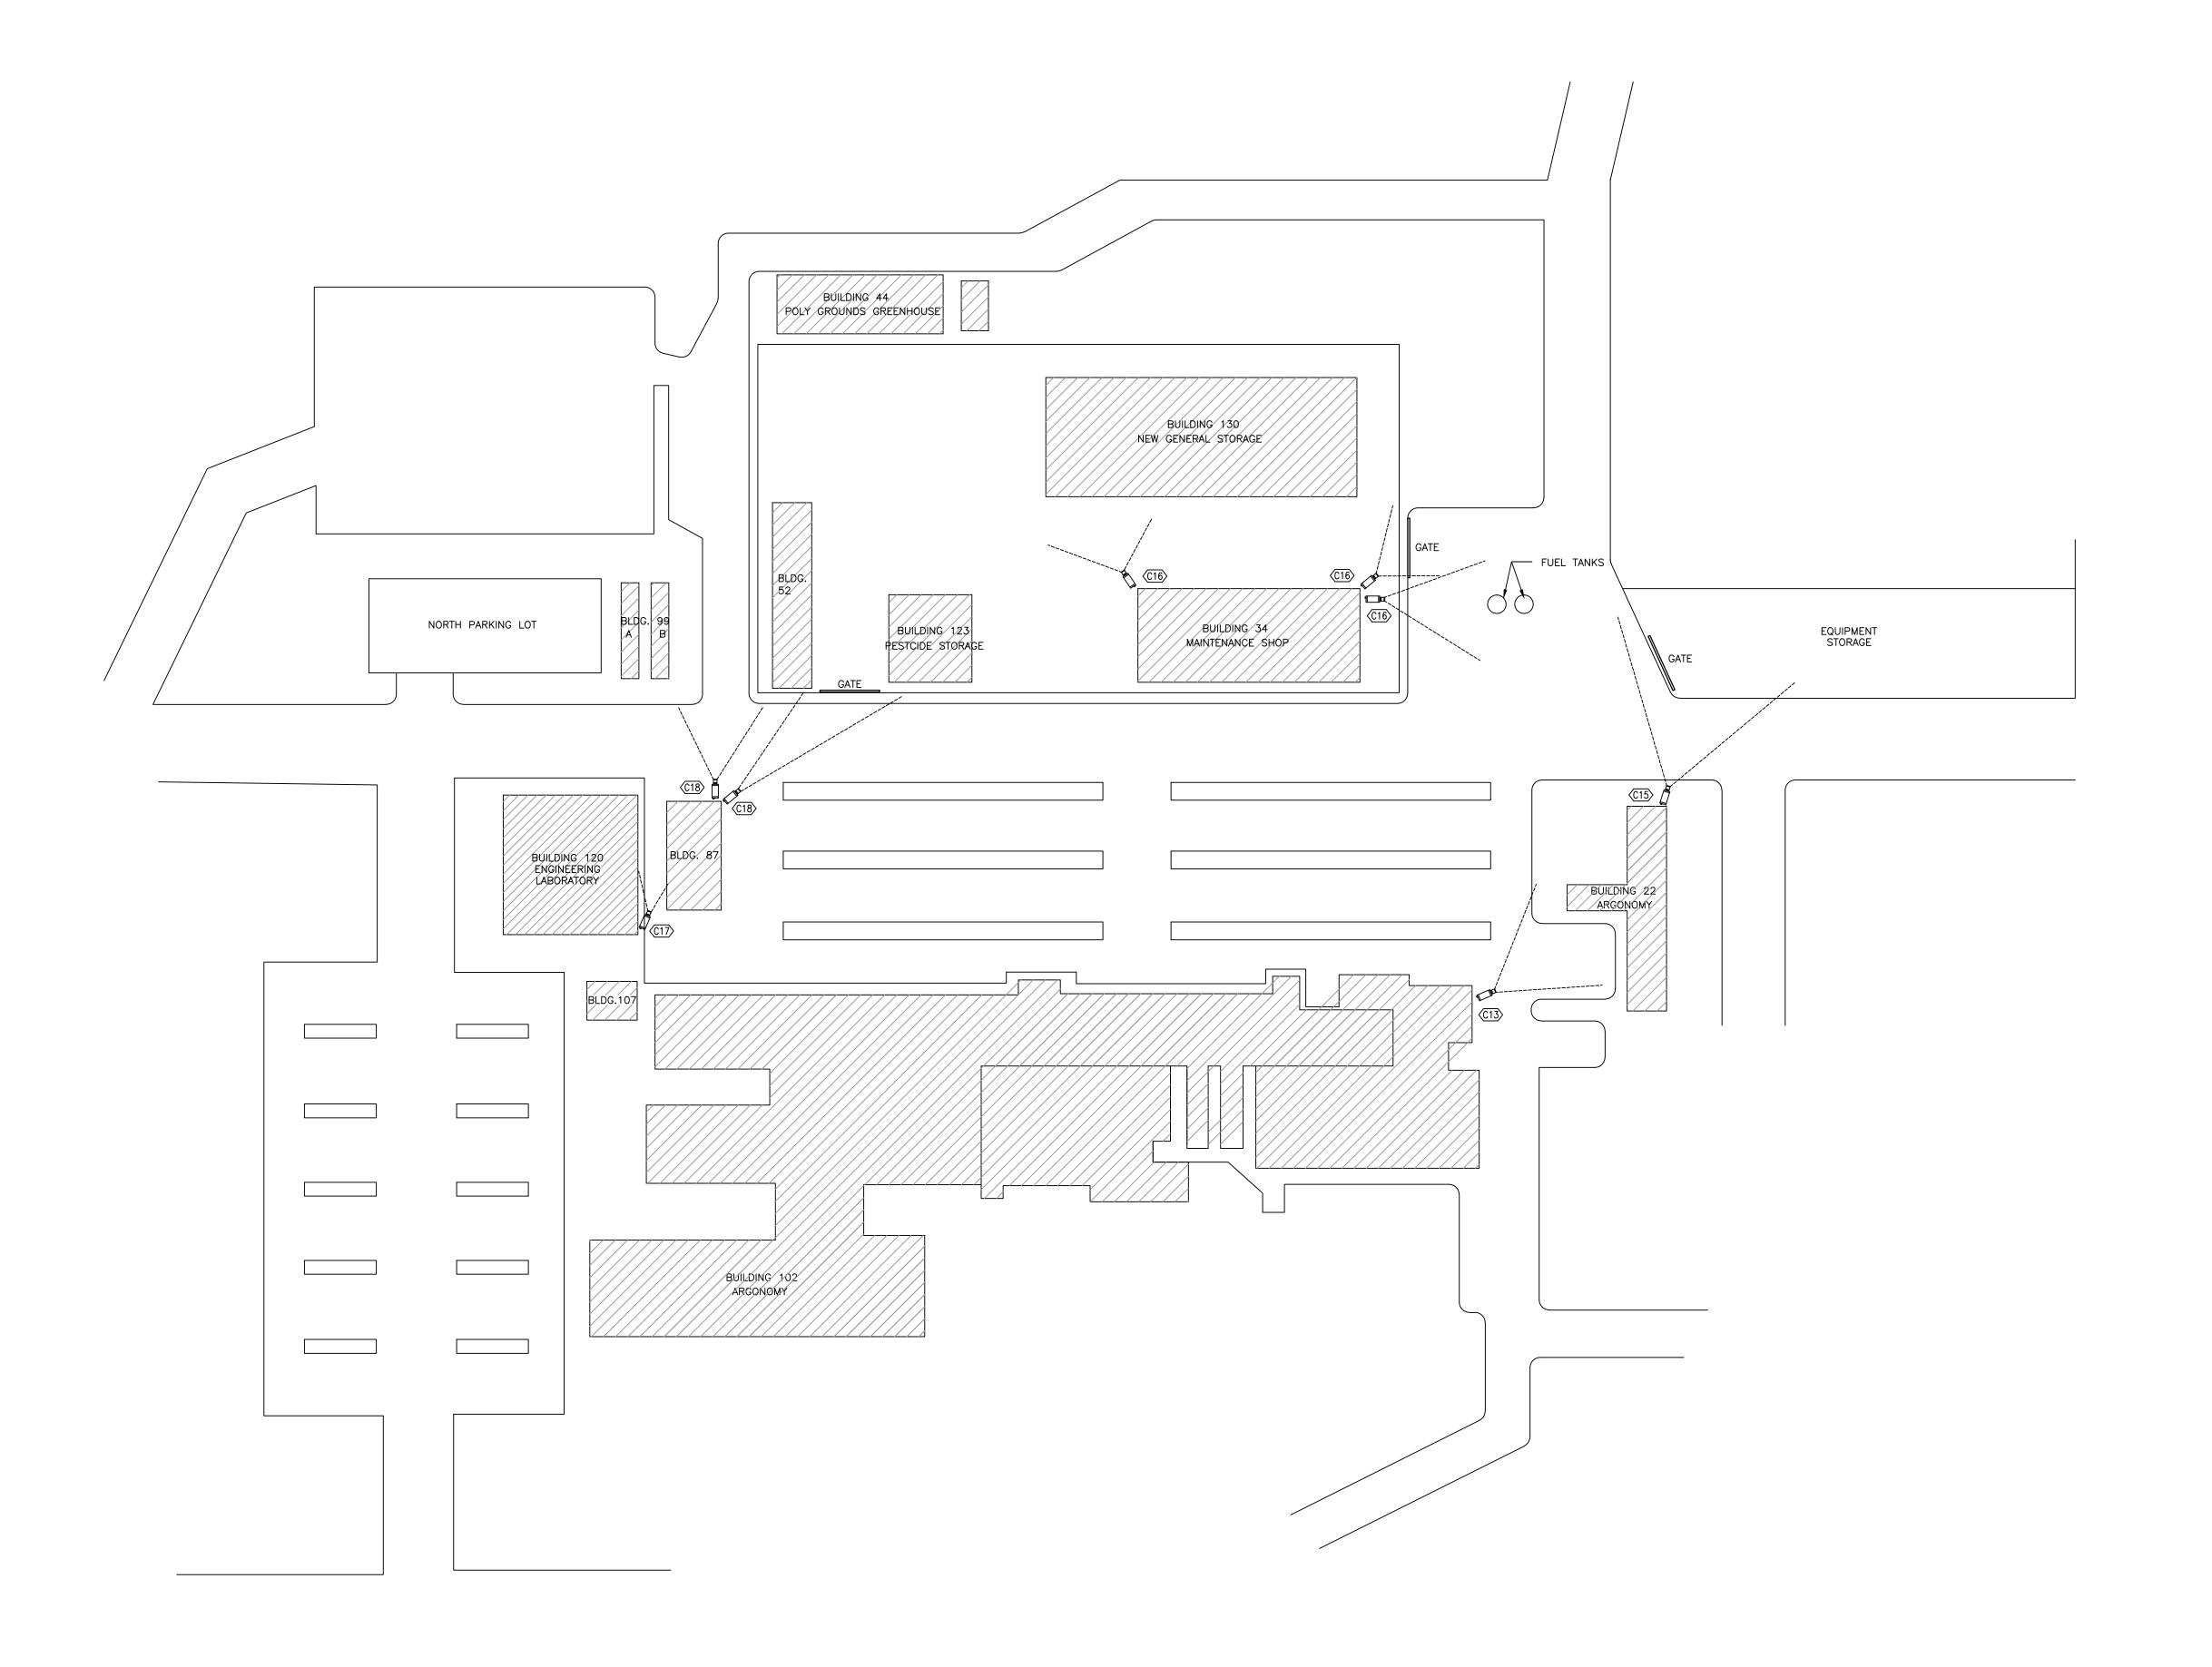
LRC OUTBUILDINGS SECURITY PLANS

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DETAIL - AREA NORTH OF BUILDING 102 1 DETAIL — E-1.8 SCALE N.T.S.

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ELECTRONIC SECURITY SYSTEM UPGRADES

LETHBRIDGE RESEARCH CENTRE


Lethbridge, Alberta

LRC OUTBUILDINGS SECURITY PLANS

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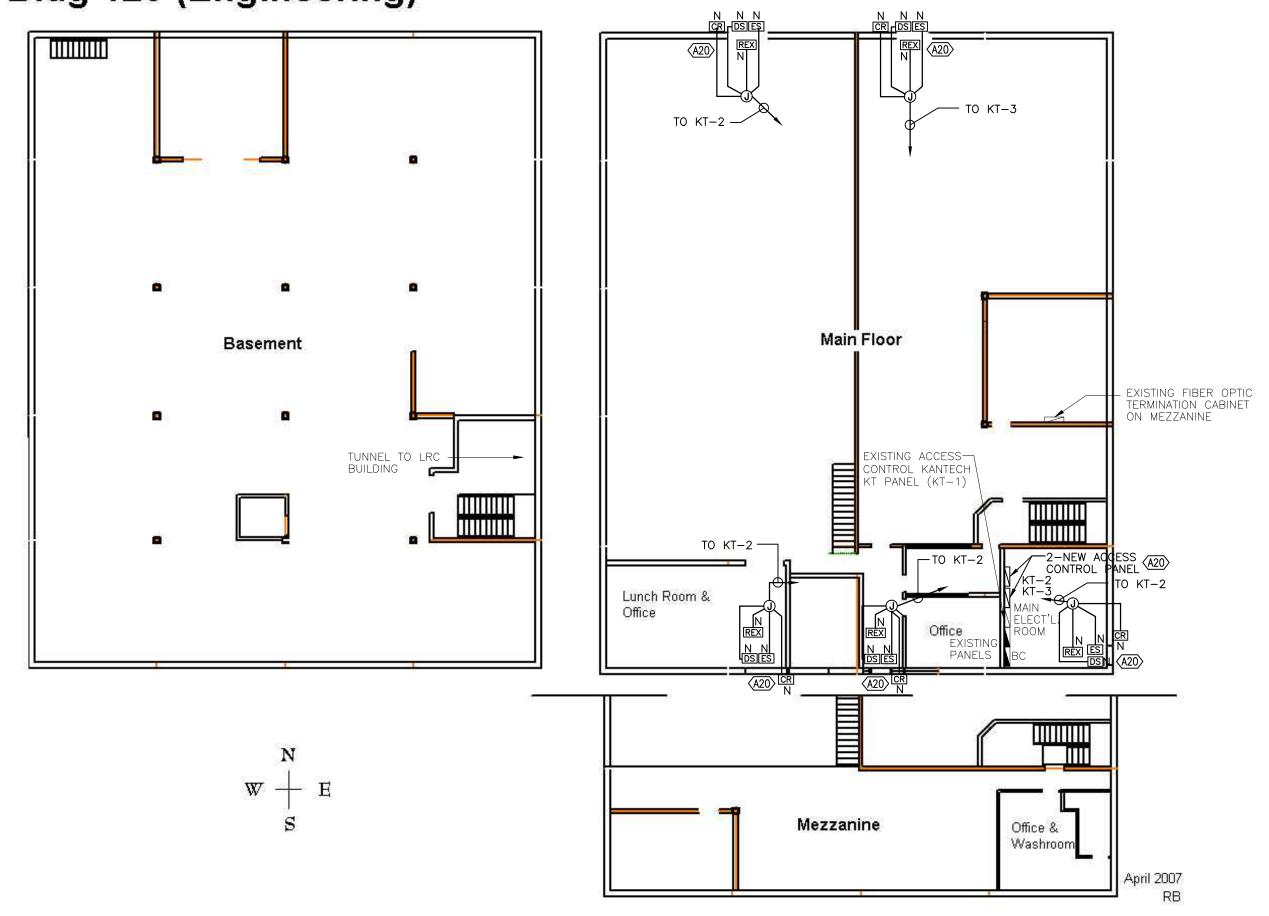
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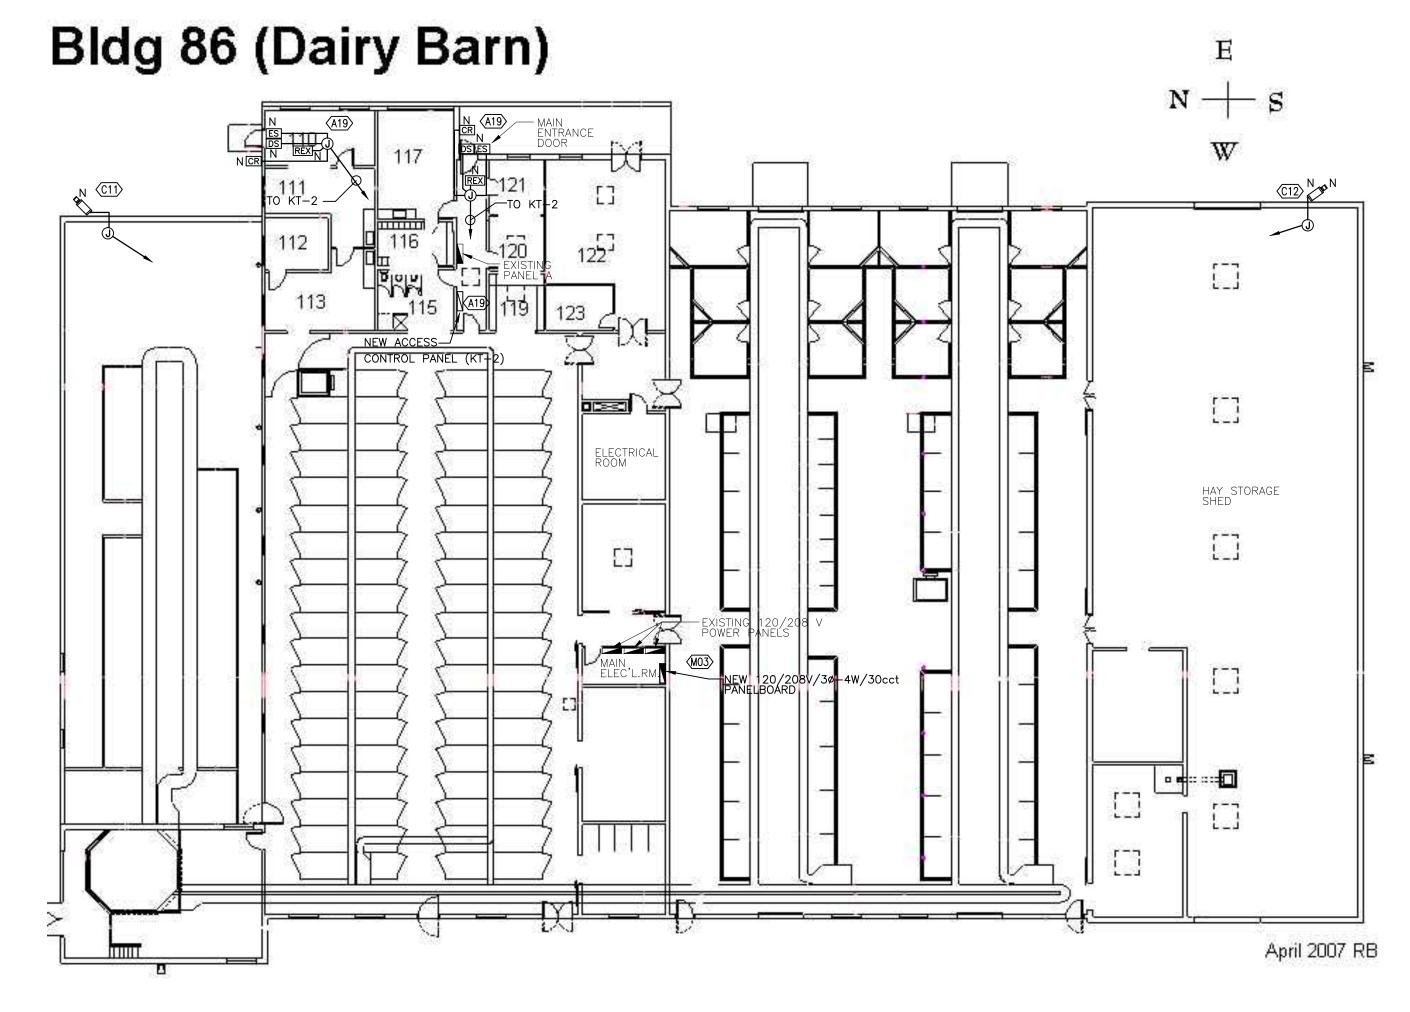





# Bldg 120 (Engineering)

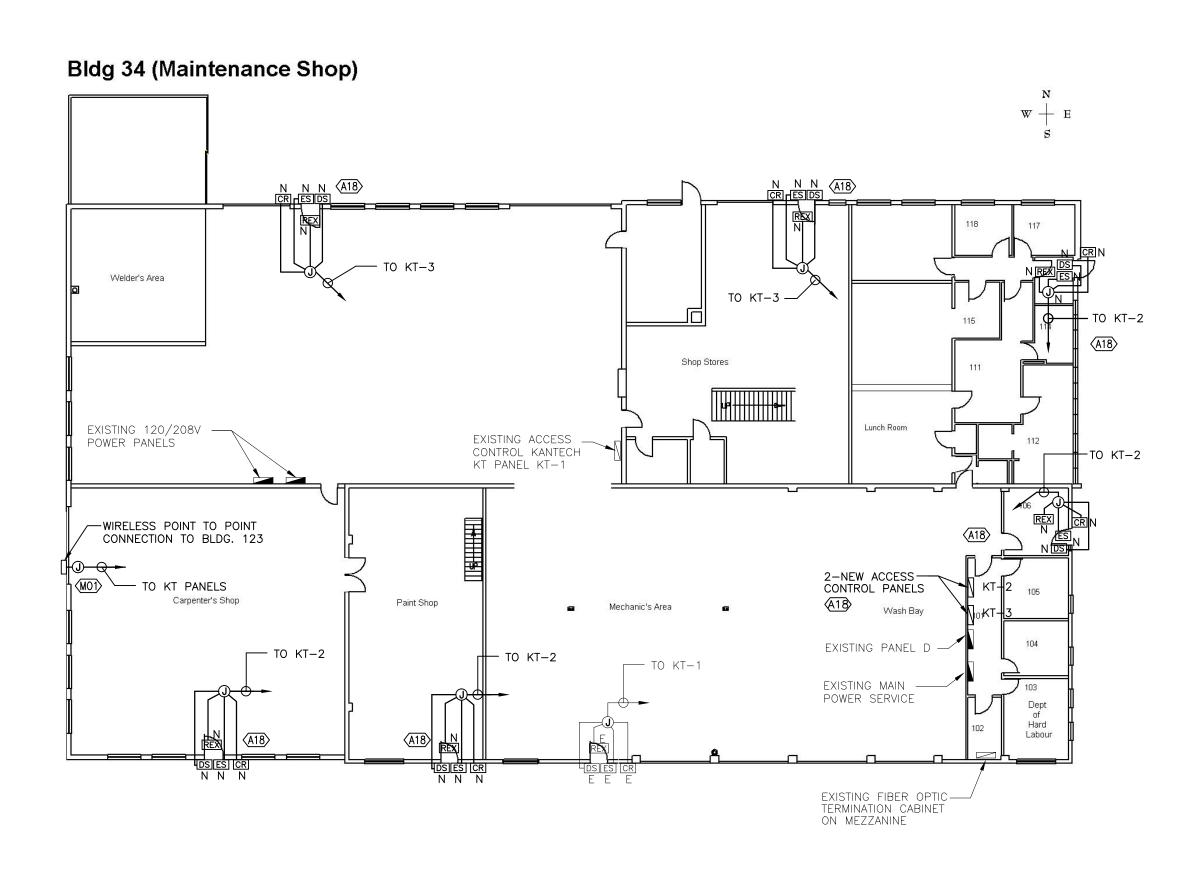







BLDG. 86 DAIRY BARN — SECURITY PLAN E-2.1 SCALE 1:200

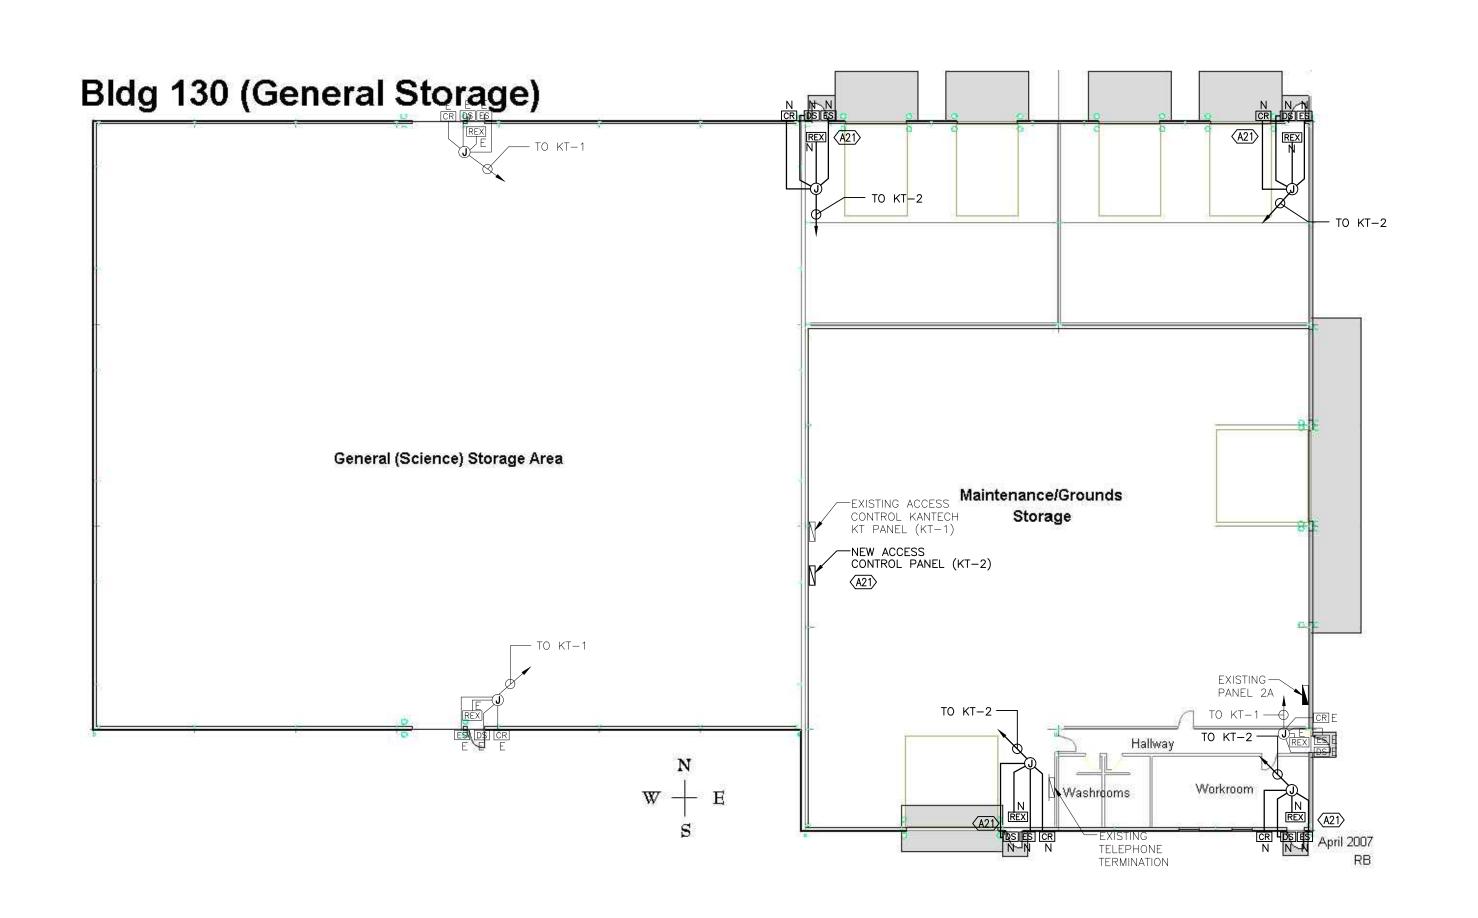

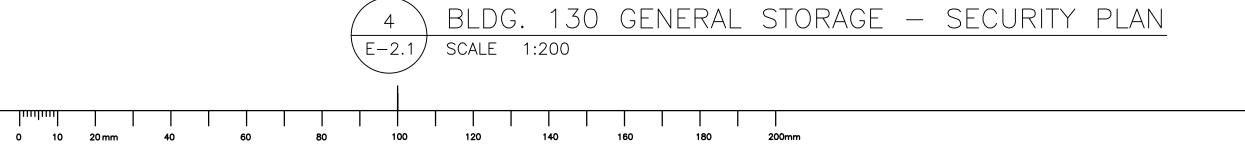

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ELECTRONIC SECURITY SYSTEM UPGRADES
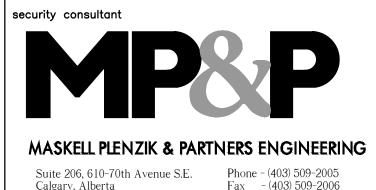
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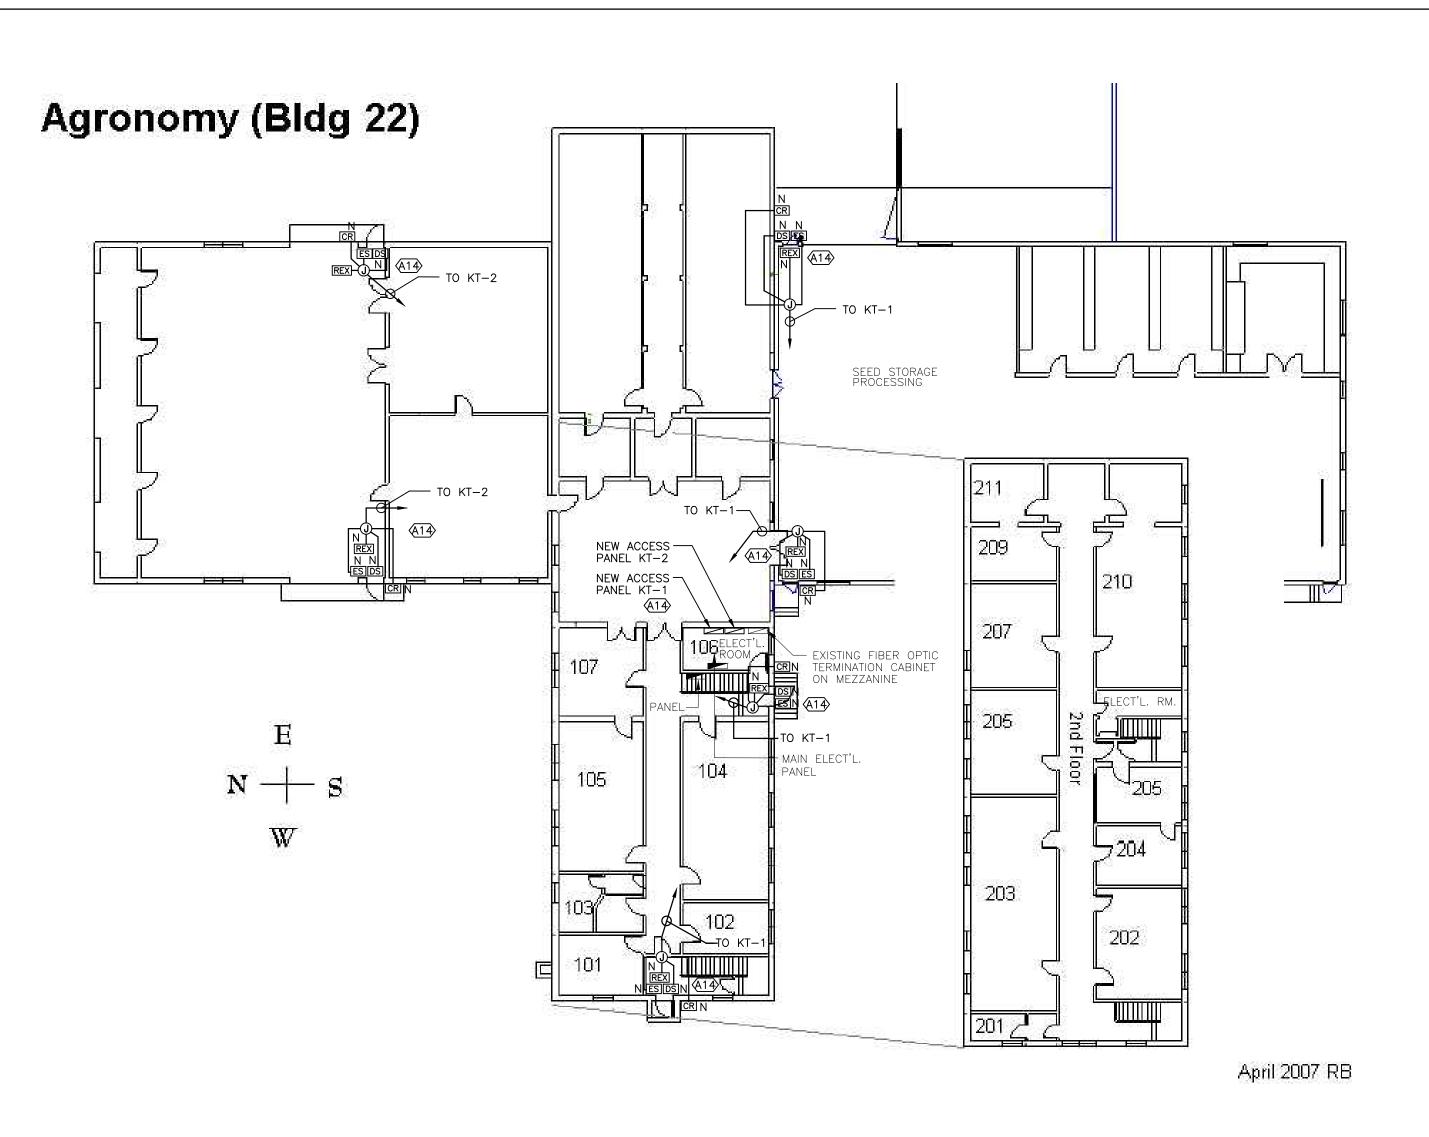
Lethbridge, Alberta

LRC OUTBUILDINGS SECURITY PLANS


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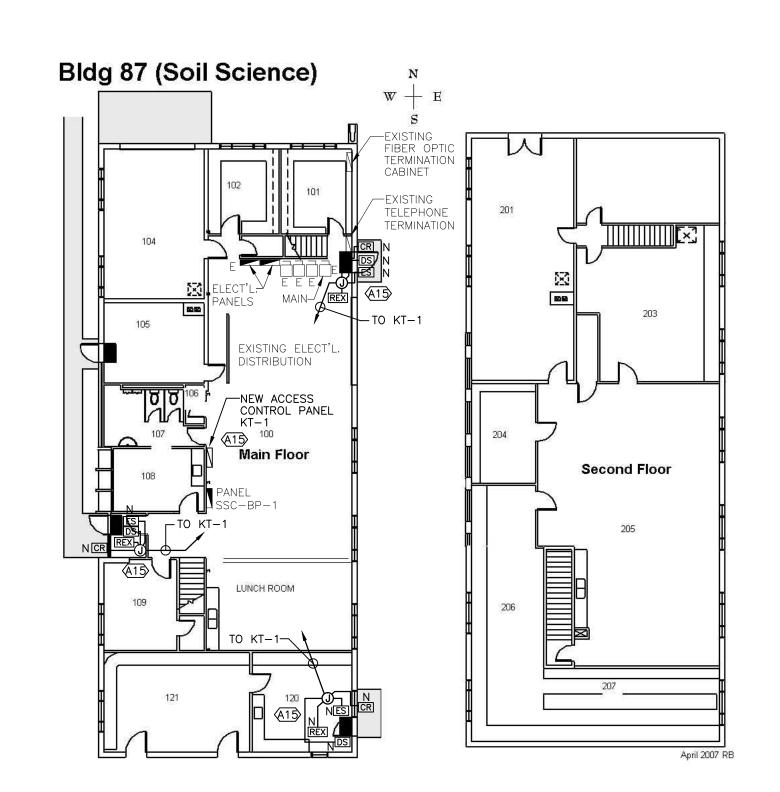
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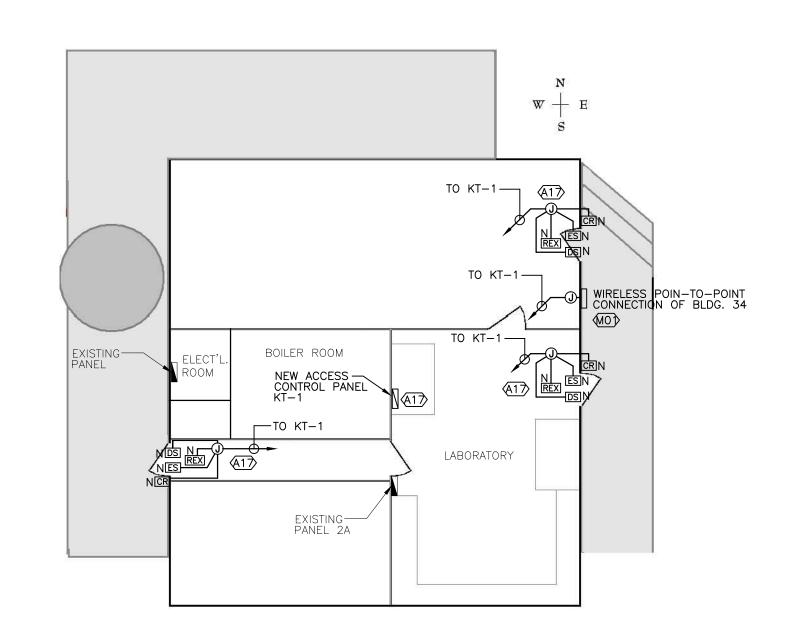


3 BLDG. 118 CONTROLLED ENVIRONMENT BUILDING — SECURITY PLAN E-2.2 SCALE 1:200





## Bldg 123 (Pesticide Storage)

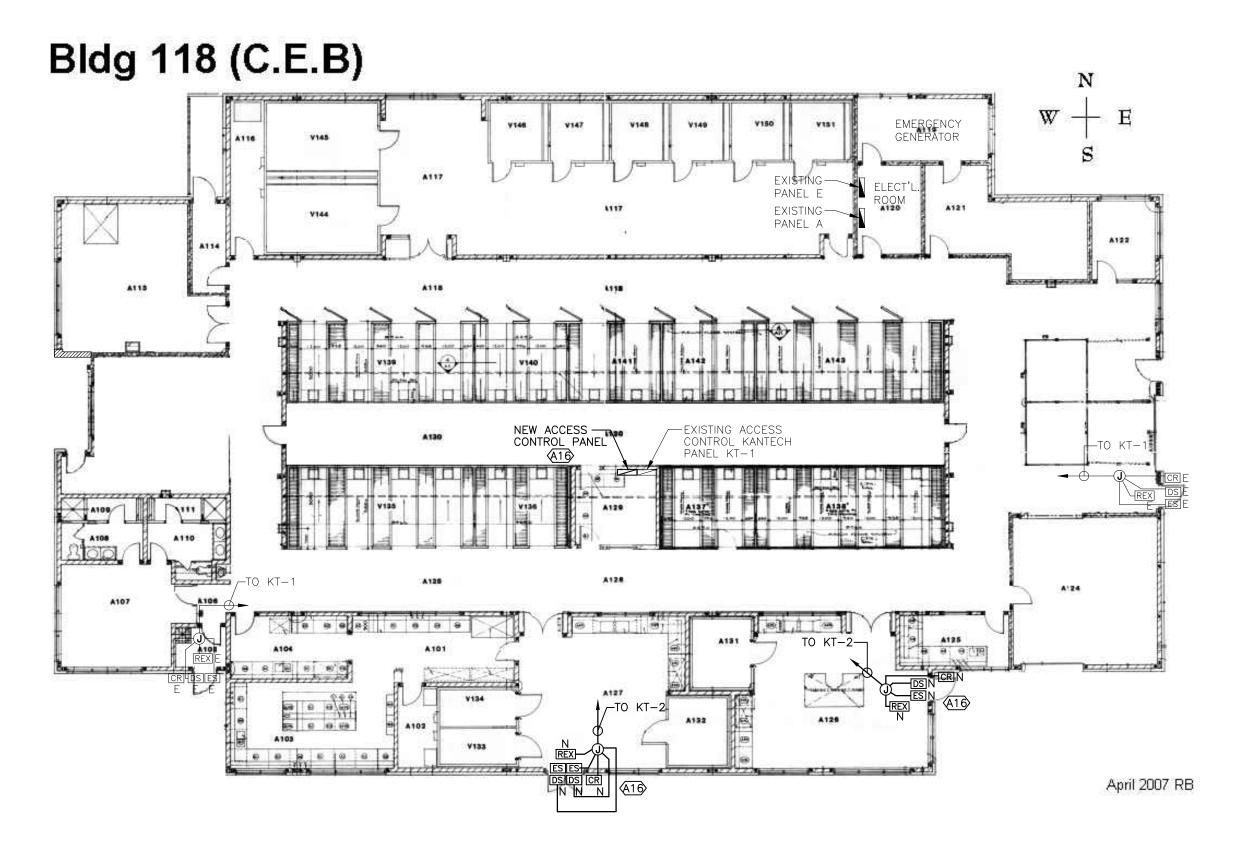

4 BLDG. 123 PESTICIDE STORAGE — SECURITY PLAN E-2.2 SCALE 1:100

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ELECTRONIC SECURITY SYSTEM UPGRADES

LETHBRIDGE RESEARCH CENTRE

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LRC OUTBUILDINGS SECURITY PLANS

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te 2014/04/08 date approved

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#### GENERAL NOTES:

- 1. ALL WORK TO BE IN ACCORDANCE WITH ALBERTA BUILDING CODE 2006.
- 2. READ THE CONSTRUCTION DRAWINGS IN CONJUNCTION WITH THE ARCH., MECH., AND ELECT. DRAWINGS. REPORT ANY INCONSISTENCIES TO THE ENGINEER BEFORE PROCEEDING WITH THE WORK.
- 3. DO NOT SCALE DRAWINGS.
- 4. FOR THE PURPOSES OF THESE DRAWINGS, THE ENGINEER IS KASSIAN DYCK AND ASSOCIATES.
- 5. THE USE OF THESE DRAWINGS IS LIMITED TO THAT IDENTIFIED IN THE REVISIONS COLUMN. DO NOT CONSTRUCT FROM THESE DRAWINGS UNLESS MARKED "ISSUED FOR CONSTRUCTION" IN THE REVISIONS COLUMN BY KASSIAN DYCK & ASSOCIATES.
- 6. ALL EXISTING DIMENSIONS, ELEVATIONS, AND EXISTING STRUCTURAL SYSTEMS SHOWN ON THE STRUCTURAL DRAWINGS ARE TO BE VERIFIED ON SITE PRIOR TO CONSTRUCTION, AND DISCREPANCIES ARE TO BE REPORTED TO THE ENGINEER BEFORE PROCEEDING.
- 7. ALL SECTIONS, DETAILS, AND STATEMENTS ARE TYPICAL AND APPLY TO ALL SIMILAR SITUATIONS IN THE STRUCTURE.
- 8. ALL TEMPORARY SAFETY GUARDS SHALL BE THE CONTRACTORS RESPONSIBILITY.
- 9. THE CONTRACTOR SHALL EXAMINE THE SITE AND THE SUBSURFACE INVESTIGATION REPORT AND ACCEPT ALL CHARACTERISTICS AND IRREGULARITIES OF THIS SITE.
- 10. DESIGN LOADS DEAD LOAD = SELF WEIGHT
  - WIND: q(1/50) = 0.82 kPa (17 PSF)
- 11. CONTRACTOR'S CONSTRUCTION LOADS MUST NOT EXCEED THE ABOVE DESIGN LOADS. DESIGN LOADS MAY ONLY BE APPLIED AFTER THE CONCRETE REACHES ITS DESIGN STRENGTH.
- 12. UNDERPIN WHERE NECESSARY ANY EXISTING STRUCTURE AND PROVIDE ALL BRACING, SHORING, ETC. TO SUPPORT ADJOINING SOIL, FLOORS, WALLS, ETC. AS REQUIRED TO RETAIN ALL WORK IN PLACE AND PREVENT ANY OVERSTRESSING OF THE STRUCTURE.
- 13. THE CONTRACTOR SHALL COORDINATE ALL TESTING, INSPECTION, AND QUALITY CONTROL WITH ONSITE FACILITY MANAGER AND WILL PROVIDE CASUAL LABOUR FORCES AS REQUIRED TO ASSIST IN ALL THE FIELD REVIEW PROCEDURES. THE CONTRACTOR SHALL GIVE REASONABLE NOTICE TO THESE AGENCIES PRIOR TO REQUIRING THEIR SERVICES.
- 14. PERIODIC SITE REVIEWS FOR WORK SHOWN ON THESE DRAWINGS TO ASCERTAIN WHETHER THE STRUCTURAL WORK IS IN GENERAL CONFORMANCE WITH THE CONTRACT DOCUMENTS SHALL BE AS DIRECTED BY THE ONSITE FACILITY MANAGER. THE SITE REVIEWS ARE NOT FOR THE CONTRACTOR'S BENEFIT AND THE CONTRACTOR REMAINS FULLY RESPONSIBLE TO ENSURE THAT ALL STRUCTURAL WORK IS CARRIED OUT IN ACCORDANCE WITH THESE DRAWINGS AND ALL APPLICABLE CODES. THE WORK TO BE REVIEWED SHALL GENERALLY BE COMPLETE.
- 15. PROVIDE 48 HOURS ADVANCE NOTICE OF EACH REQUIRED SITE REVIEW TO THE ONSITE FACILITY MANAGER. SITE REVIEWS SHALL BE SCHEDULED TO BE CARRIED OUT DURING NORMAL BUSINESS HOURS UNLESS SPECIAL ARRANGEMENTS ARE MADE.
- 16. PROVIDE 48 HRS. NOTICE PRIOR TO POURING CONCRETE. ALL REINFORCEMENT SHALL BE IN PLACE AND SECURED AT THE TIME OF THE REVIEW. REINFORCEMENT SHALL BE REVIEWED IN PLACE AS DIRECTED BY THE ONSITE FACILITY MANAGER, PRIOR TO PLACING CONCRETE
- 17. BEFORE CONCEALING ANY STRUCTURAL ELEMENTS, PROVIDE MINIMUM 48 HRS. NOTICE TO ONSITE FACILITY MANAGER SO THE STRUCTURE CAN BE INSPECTED AS DIRECTED BY THE ONSITE FACILITY MANAGER.
- 18. DO NOT CUT OR DRILL ANY OPENINGS INTO STRUCTURAL MEMBERS WITHOUT OBTAINING WRITTEN APPROVAL FROM THE ONSITE FACILITY MANAGER.

#### CONCRETE NOTES:

- 1. ALL WORK TO BE IN ACCORDANCE WITH CSA A23.1-04, A23.2-04, AND A23.3-04.
- 2. CEMENT: NORMAL PORTLAND CEMENT TO CAN/CSA-A5, TYPE GU OR SULPHATE RESISTANT CEMENT TO CAN/CSA-A5 TYPE HS.
- 3. CONCRETE TO BE IN ACCORDANCE WITH FOLLOWING PERFORMANCE SCHEDULE. RESPONSIBILITIES OF OWNER, CONTRACTOR, AND SUPPLIER ARE IN ACCORDANCE WITH ALTERNATIVE 1, TABLE 5 OR CSA A23.1-04:

LOCATION	STRENGTH	EXPOSURE	AIR	MAX AGGREG.	MAX W/C
FOOTINGS + PILES , EXTERIOR	32 MPa 4600 psi	S-2 F-2	4-7%	40 mm 1½ INCH	0.45

#### 4. AIR ENTRAINING ADMIXTURE TO ASTM C 260.

- 5. CALCIUM CHLORIDE SHALL NOT BE USED AS ADMIXTURE.
- 6. CONTRACTOR TO PREPARE AND IMPLEMENT QUALITY CONTROL PLAN TO ENSURE THAT CONCRETE PERFORMANCE CRITERIA WILL BE MET, AND SUBMIT DOCUMENTATION DEMONSTRATING THAT PERFORMANCE REQUIREMENTS HAVE BEEN MET.
- PERFORM AT LEAST ONE CONCRETE TEST (3 CYLINDERS) FOR EACH 50 CUBIC METRES OF CONCRETE, OR FRACTION THEREOF OF EACH TYPE OF CONCRETE POURED IN ANY ONE DAY.
- 8. CONTRACTOR TO COORDINATE CONCRETE TESTING REQUIREMENTS AND TIMING WITH FACILITY MANAGER.
- 9. DRY PACK GROUT: NON-METALLIC, NON-SHRINK, CEMENTITIOUS GROUT, WITH MINIMUM 28 DAY STRENGTH OF 25 MPa (3600 psi).
- 10. PLACE CONCRETE AS CLOSE AS POSSIBLE TO FINAL LOCATION TO AVOID SEGREGATION. VIBRATE ALL CONCRETE.
- BRING ALL FLOORS TO AN EVEN, LEVEL, OR SLOPING SURFACE AS INDICATED ON THE DRAWINGS, READY TO RECEIVE THE SPECIFIED FINISH.
- 12. UNLESS NOTED OTHERWISE PROVIDE THE FOLLOWING FINISHES TO CONCRETE FLOORS:
  - EXTERIOR SIDEWALKS AND SLABS BROOM FINISH DO NOT OVERWORK SLAB SURFACE; FLOOR TO BE LEVEL WITHIN 3 mm (1/8 INCH) IN 3000 mm (10 FT).
- 13. PROTECT CONCRETE FROM FREEZING. DO NOT PLACE CONCRETE AGAINST FROZEN GROUND. USE WINTER CONCRETING METHODS IN ACCORDANCE WITH CSA A23.1-04.
- 14. PROTECT CONCRETE FROM EXCESSIVE HEAT AND DRYING. USE HOT WEATHER CONCRETING METHODS IN ACCORDANCE WITH
- 15. CURE CONCRETE IN ACCORDANCE WITH A23.1-04, AND FOR A MINIMUM OF 7 DAYS AT A MINIMUM TEMPERATURE OF 10 DEGREES C. OR FOR THE TIME NECESSARY TO OBTAIN 70% OF THE SPECIFIED 28 DAY COMPRESSIVE STRENGTH.

#### CONCRETE REINFORCEMENT NOTES:

- 1. ALL WORK TO BE IN ACCORDANCE WITH CSA A23.1-04 AND A23.3-04.
- REINFORCING BARS: DEFORMED BARS, GRADE 400 CONFORMING TO CSA G30.18 UNLESS NOTED OTHERWISE.
   PROVIDE ADDITIONAL SUPPORT BARS AS REQUIRED TO ADEQUATELY SUPPORT AND SECURE ALL REINFORCEMENT AND PREVENT MOVEMENT WHEN PLACING CONCRETE. PROVIDE AS A MINIMUM THE FOLLOWING:
- MOVEMENT WHEN PLACING CONCRETE. PROVIDE AS A MINIMUM THE FOLLOWING:

   10M U BAR SPACERS AT 3 m (10 FT) O/C HORIZONTALLY AND 1.5 m (5 FT) O/C VERTICALLY TO HOLD WALL REINFORCING MATS IN
- POSITION
   15M SUPPORT BARS FOR SLAB TOP REINFORCING, SPACED AT A MAXIMUM OF 600 mm (2 FT) O/C FOR 10M BARS, AND 1200 mm (4 FT) O/C FOR 15M AND LARGER BARS
  - 15M SUPPORT BARS AT A MAXIMUM OF 1200 mm (4FT) O/C SPACING IN EACH DIRECTION FOR BOTTOM REINFORCING 15 M SUPPORT BARS IN HOOKS AND EACH CORNER OF STIRRUPS UNLESS SHOWN OTHERWISE
- 4. LOCATE CHAIRS FOR REINFORCING AT A MAXIMUM OF 1200 mm (4 FT) CENTRES.
- 5. UNLESS OTHERWISE SHOWN, CLEAR CONCRETE COVER TO REINFORCEMENT TO BE AS FOLLOWS:

SUPPORT PILE CAP REINFORCEMENT AT 900 mm (3 FT) MAXIMUM O/C

- CONCRETE POURED AGAINST EARTH
- EXPOSED MEANS EXPOSURE TO EARTH AND/OR WEATHER
- 6. ENSURE REINFORCING IS CLEAN; FREE OF LOOSE SCALE, OIL, DIRT, RUST, AND ANY OTHER FOREIGN COATINGS THAT AFFECT BONDING CAPACITY BEFORE PLACING REBAR.
- UNLESS NOTED OTHERWISE, ALL REBAR EMBEDMENT AND LAP SPLICE LENGTHS TO BE AS SHOWN IN FOLLOWING TABLE. ALL TENSION LAP SPLICES ARE CLASS B. WHERE NO EMBEDMENT TYPE IS INDICATED, PROVIDE TENSION EMBEDMENT. WHERE NO LAP SPLICE TYPE IS INDICATED. PROVIDE TENSION LAP SPLICE.

#### TENSION DEVELOPMENT (EMBEDMENT) LENGTHS / LAP SPLICE LENGTHS (mm)

BAR SIZE		CONCRETE STRENGTH						
	2	20 MPa		25 MPa		30 MPa		35 MPa
	EMBED.	LAP	EMBED	LAP	EMBED	LAP	EMBED	LAP
10M	320	420	300	390	300	390	300	390
15M	480	630	430	560	390	510	370	480
20M	640	840	580	750	530	680	490	630
25M	1010	1310	900	1170	820	1070	760	990
30M	1210	1570	1080	1400	990	1280	910	1190
35M	1410	1830	1200	1640	1150	1500	1070	1380

NOTES: - ALL TOP BAR SPLICES AND EMBEDMENT LENGTHS TO BE 1.3 TIMES LONGER THAN VALUES SHOWN ABOVE.
- TOP BARS ARE THOSE WHICH ARE CAST WITH 300 mm OR MORE CONCRETE BELOW BAR.
- STIRRUP SPLICES NOT ALLOWED EXCEPT WHEN APPROVED BY ENGINEER
- SPLICES FOR EPOXY COATED REINFORCEMENT TO BE INCREASED AS PER ENGINEERS INSTRUCTIONS.

#### COMPRESSION LAP SPLICE LENGTHS (mm)

BAR SIZE	LAP
10M	300
15M	440
20M	580
25M	730
30M	880
35M	1020

#### EXCAVATION AND BACKFILL NOTES:

- 1. ALL EARTHWORK INCLUDING EXCAVATION AND BACKFILL TO BE DONE IN ACCORDANCE WITH GEOTECHNICAL ENGINEER'S
- 2. LOCATE ALL UNDERGROUND SERVICES PRIOR TO EXCAVATING OR DRILLING.
- 3. STRIP ALL TOPSOIL, FILL, FROZEN SOIL, WET AND/OR WEAK SOILS, AND DEBRIS FROM THE BUILDING AREA.
- 4. EXCAVATE TO ELEVATIONS SHOWN.
- 5. TEMPORARY SLOPES FOR EXCAVATIONS NOT TO EXCEED 1 HORIZ. TO 1 VERT. IN CLAY, OR 2 HORIZ. TO 1 VERT. IN SAND. PROVIDE SHALLOWER SLOPES AS REQUIRED BY SOIL CONDITIONS.
- 6. PRIOR TO PLACING FILL BELOW SLABS ON GRADE OR ASPHALT PAVING, PROOF ROLL THE SUBGRADE, REMOVE ANY SOFT AREAS AND REPLACE WITH COMPACTED PIT RUN GRAVEL, AND COMPACT EXISTING SUBGRADE TO OBTAIN THE SAME COMPACTION AS SPECIFIED FOR THE FILL.
- 7. PIT RUN GRAVEL TO BE WELL GRADED, 100 mm (4 INCH) MINUS.
- 8. CRUSHED GRAVEL TO BE 20 mm (3/4 INCH) ROAD CRUSH.
- 9. BACKFILL AND FILL TO BE AS FOLLOWS:
  - CRUSHED GRAVEL BELOW SLAB ON GRADE APPROVED NATIVE SOIL BELOW LANDSCAPED AREAS
- 10. COMPACT ALL BACKFILL BELOW SLABS ON GRADE, ASPHALT PAVING, AND STRUCTURAL SLABS TO 98% STANDARD PROCTOR MAXIMUM DRY DENSITY. COMPACT ALL BACKFILL BELOW LANDSCAPED AREAS TO 95% STANDARD PROCTOR MAXIMUM DRY DENSITY. COMPACT IN MAXIMUM 150 mm (6 INCH) LIFTS.
- 11. UNLESS NOTED OTHERWISE, FOUNDATIONS AND WALLS SHALL BE BACKFILLED EVENLY ON BOTH SIDES TO PREVENT LATERAL MOVEMENT. BACKFILL HEIGHTS SHALL NOT VARY BY MORE THAN 300 mm (12 INCH) FROM ONE SIDE TO THE OTHER. EXERCISE EXTREME CAUTION DURING BACKFILL OPERATIONS TO PREVENT DAMAGE TO THE CONCRETE.
- 12. DO NOT ENCROACH A 45-DEGREE ANGLE OF BEARING FROM ADJACENT FOOTING BOTTOMS U.N.O.
- 13. KEEP EXCAVATION DRAINED AND FREE OF WATER AT ALL TIMES.
- 14. TAKE ALL NECESSARY MEASURES AND PRECAUTIONS TO PREVENT FREEZING OF SOILS BELOW FOOTINGS
- 15. REMOVE FROM SITE AND DISPOSE OF ANY SURPLUS MATERIAL.



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SEAL PERMIT TO PRACTICE NUMBER: P 5820

IXMII

TENDER 14.06.06

O. REVISION DATE

ECT TITLE

ELECTRONIC SECURITY SYSTEMS UPGRADE

DRAWING TITLE

LRC OUTBUILDINGS GENERAL NOTES

AS SHOWN DATE 2014-06-06 DWG. NO. S1

