

LEGEND

ASBESTOS-CONTAINING FLOOR TILE

ASBESTOS-CONTAINING INTERIOR WINDOW CAULKING

ASBESTOS-CONTAINING DRYWALL JOINT COMPOUND

ASBESTOS-CONTAINING CEILING TILE

ASBESTOS-CONTAINING CEILING TILE,
DRYWALL JOINT COMPOUND AND FLOOR TILE


ASBESTOS-CONTAINING FLOOR TILE AND CEILING TILE

ASBESTOS-CONTAINING FLOOR TILE AND DRYWALL JOINT COMPOUND

ASBESTOS-CONTAINING CEILING TILE AND JOINT COMPOUND

ASBESTOS-CONTAINING FLOOR TILE AND JOINT COMPOUND

ASBESTOS-CONTAINING BLOCK WALL CAVITY FILL INSULATION

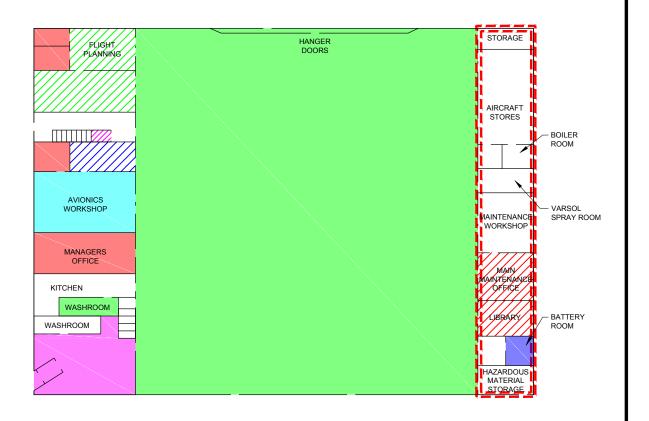

PUBLIC WORKS AND GOVERNMENT SERVICES CANADA
HAZARDOUS BUILDING MATERIALS ASSESSMENT
TRANSPORT CANADA AIRCRAFT SERVICES HANGER, BUILDING 5

TITLE

ASBESTOS-CONTAINING BUILDING MATERIALS - FIRST FLOOR



| lo. 13137502861000 | 5.0286 .1000 | o. 13.1375 | PROJECT N |
|--------------------|--------------|------------|-----------|
| | 2013-11-12 | KH | DESIGN |
| | 2013-11-14 | SLC | CADD |
| FIGURE: 1 | 2014-03-25 | KH | CHECK |
| IOUIL. I | 2014-03-25 | DD | REVIEW |

NTS

NOTES

- 1) ASBESTOS-CONTAINING DRYWALL JOINT COMPOUND MAY BE LOCATED BEHIND PRE-FABRICATED DRYWALL WALLS AND WALLPAPER AS WELL AS WITHIN CONCEALED LOCATIONS (CRAWLSPACES, WALL CAVITIES, MECHANICAL SHAFTS, ETC.).
- 2) BLOCK WALL WITH ASBESTOS-CONTAINING BLOCK WALL CAVITY FILL INSÚLATION MAY BE LOCATED BEHIND DRYWALL WALLS AS WELL AS WITHIN CONCEALED LOCATIONS (CRAWLSPACES, WALL CAVITIES, MECHANICAL SHAFTS, ETC.).



LEGEND


ASBESTOS-CONTAINING DRYWALL JOINT COMPOUND

ASBESTOS-CONTAINING CEILING TILE

ASBESTOS-CONTAINING CEILING TILE, DRYWALL JOINT COMPOUND AND INTERIOR WINDOW CAULKING

ASBESTOS-CONTAINING SINK UNDERCOAT

ASBESTOS-CONTAINING FLOOR TILE AND DRYWALL JOINT COMPOUND

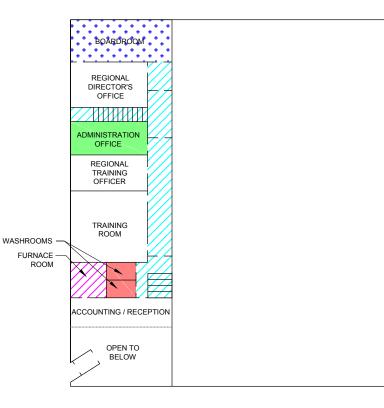

PUBLIC WORKS AND GOVERNMENT SERVICES CANADA
HAZARDOUS BUILDING MATERIALS ASSESSMENT
TRANSPORT CANADA AIRCRAFT SERVICES HANGER, BUILDING 5

TITLE

ASBESTOS-CONTAINING BUILDING MATERIALS - SECOND FLOOR




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| DESIGN | KH | 2013-11-12 | SCALE |
| CADD | SLC | 2013-11-14 | |
| CHECK | KH | 2014-03-25 | F |
| REVIEW | DD | 2014-03-25 | |


FIGURE: 2


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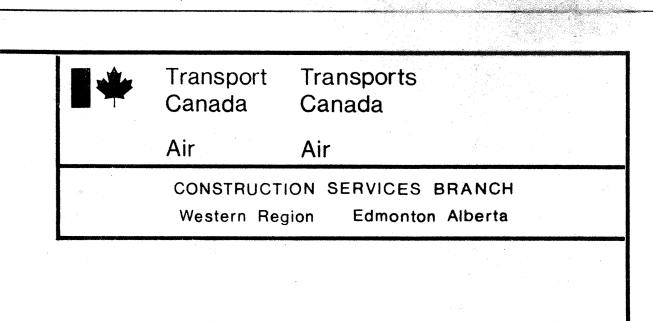
NOTES

- ASBESTOS-CONTAINING DRYWALL JOINT COMPOUND MAY BE LOCATED BEHIND PRE-FABRICATED DRYWALL WALLS AND WALLPAPER AS WELL AS WITHIN CONCEALED LOCATIONS (CRAWLSPACES, WALL CAVITIES, MECHANICAL SHAFTS, ETC.).
- BLOCK WALL WITH ASBESTOS-CONTAINING BLOCK WALL CAVITY FILL INSULATION MAY BE LOCATED BEHIND DRYWALL WALLS AS WELL AS WITHIN CONCEALED LOCATIONS (CRAWLSPACES, WALL CAVITIES, MECHANICAL SHAFTS, ETC.).



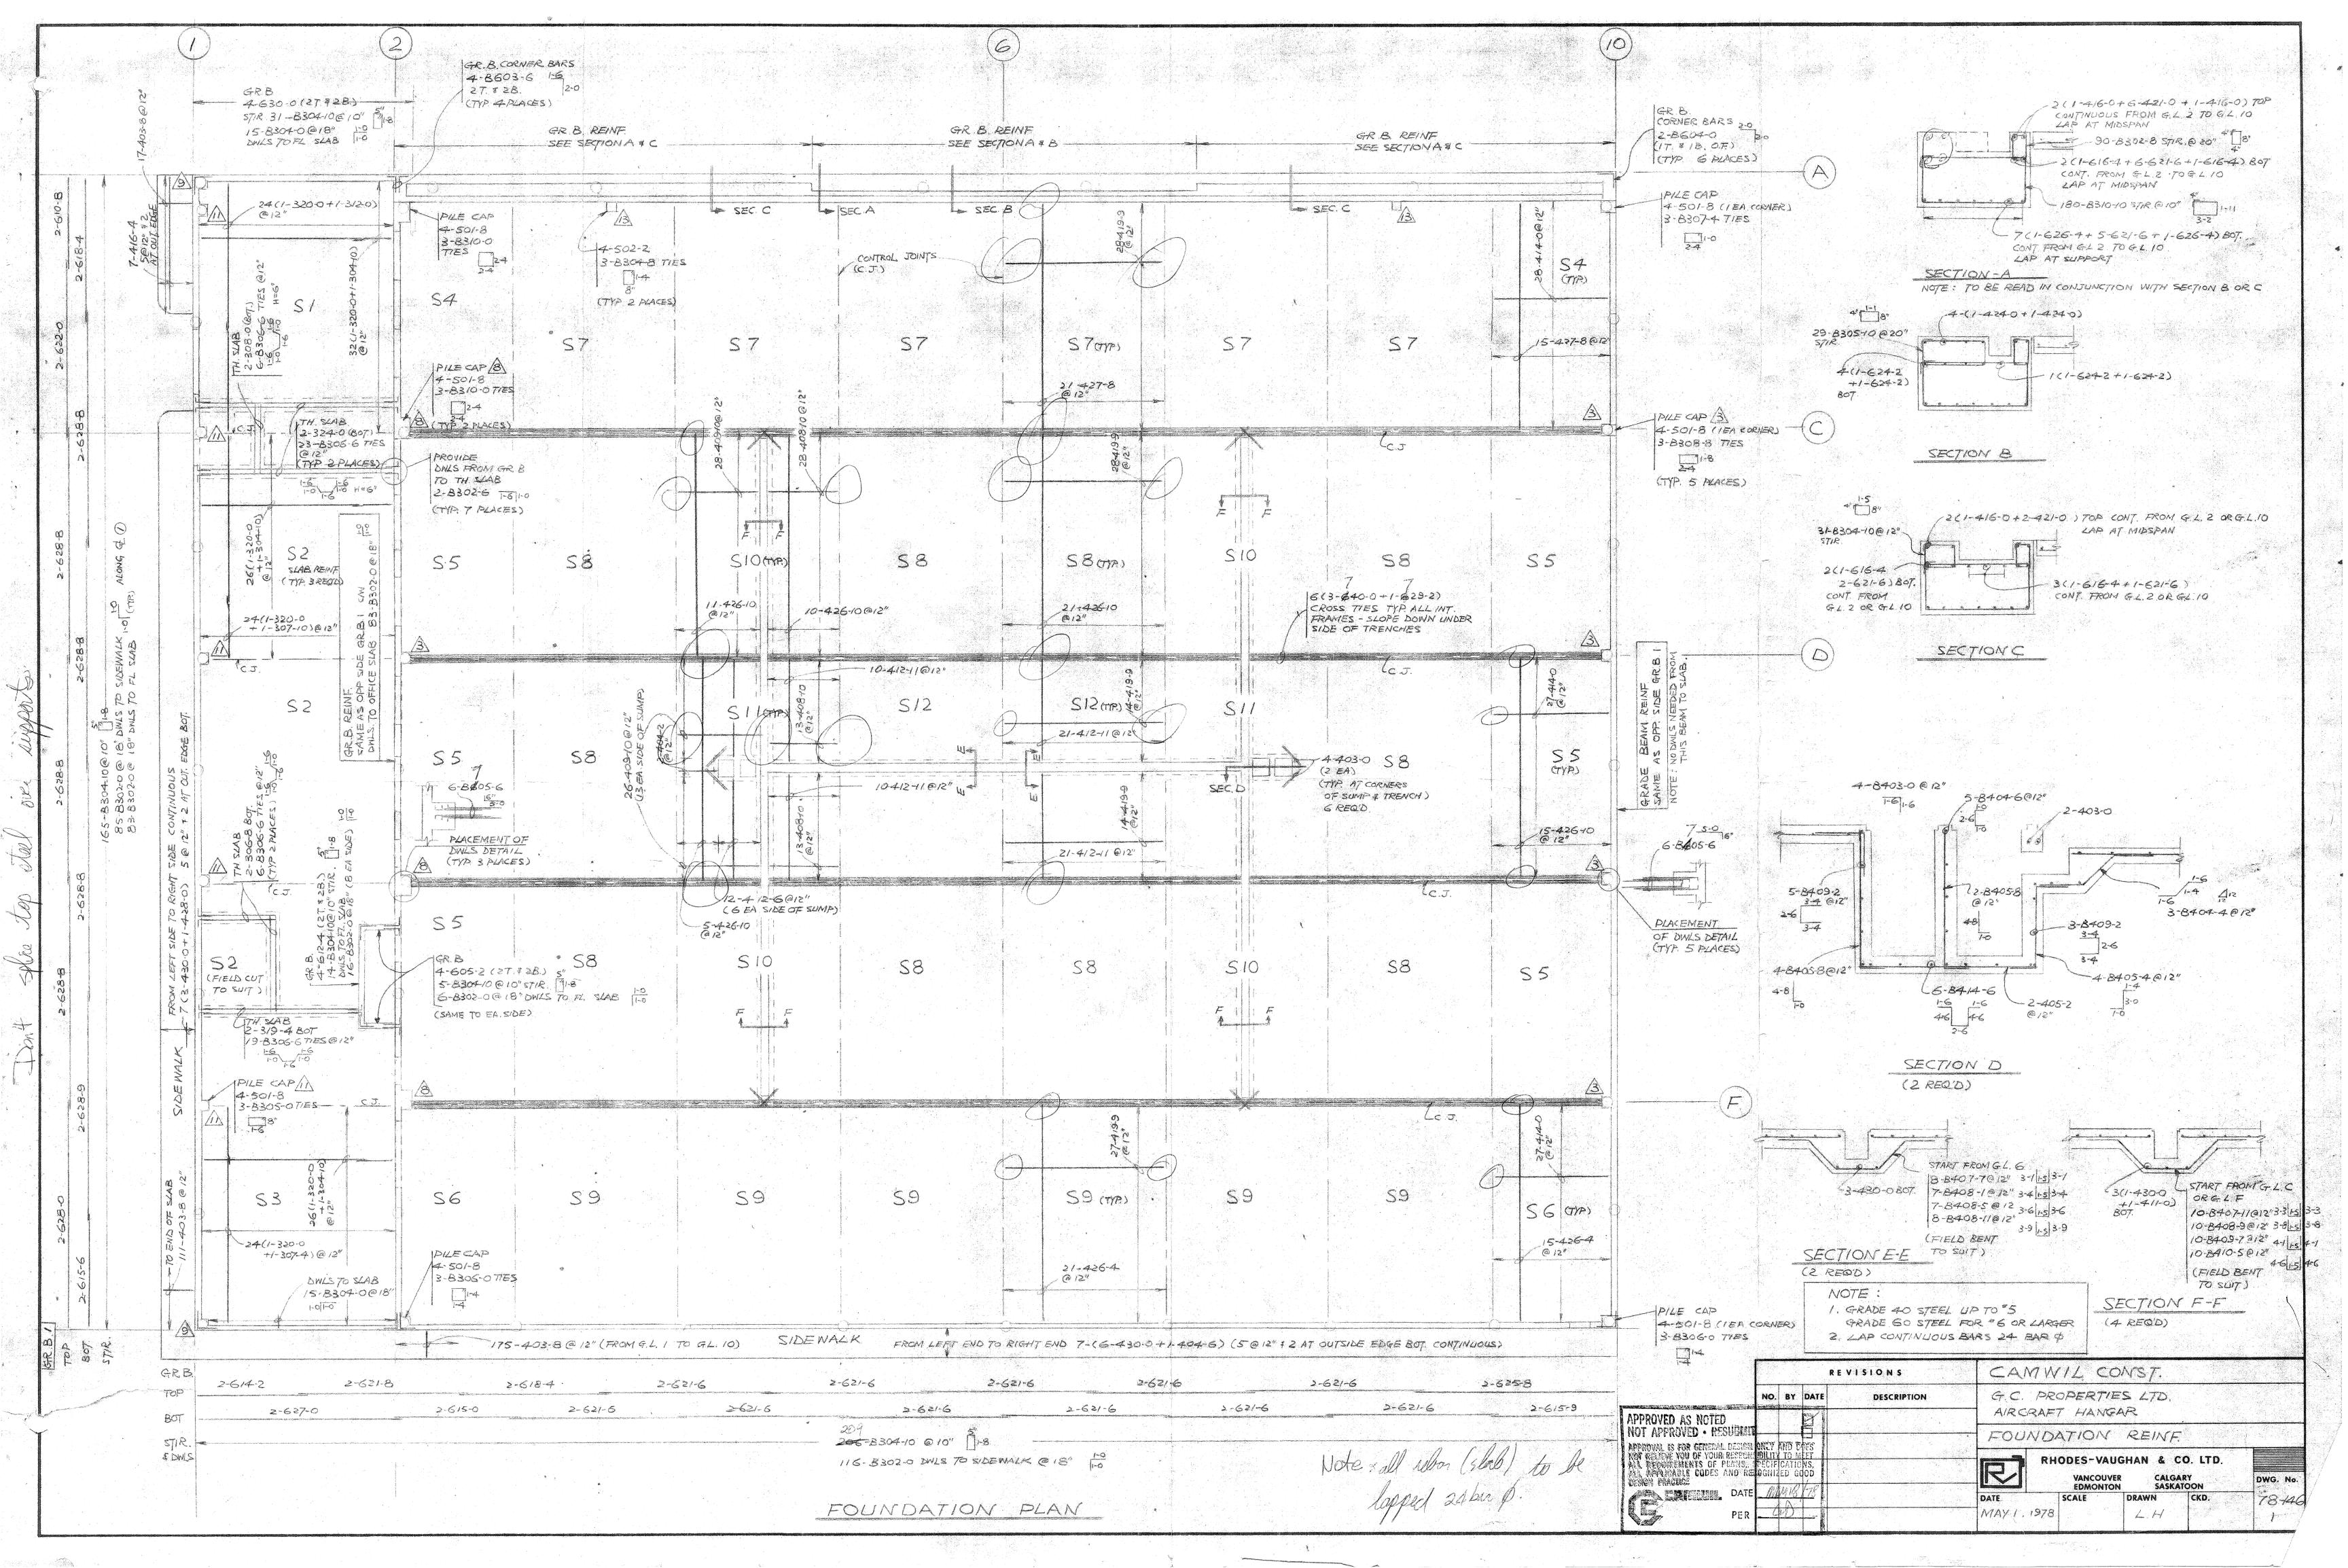


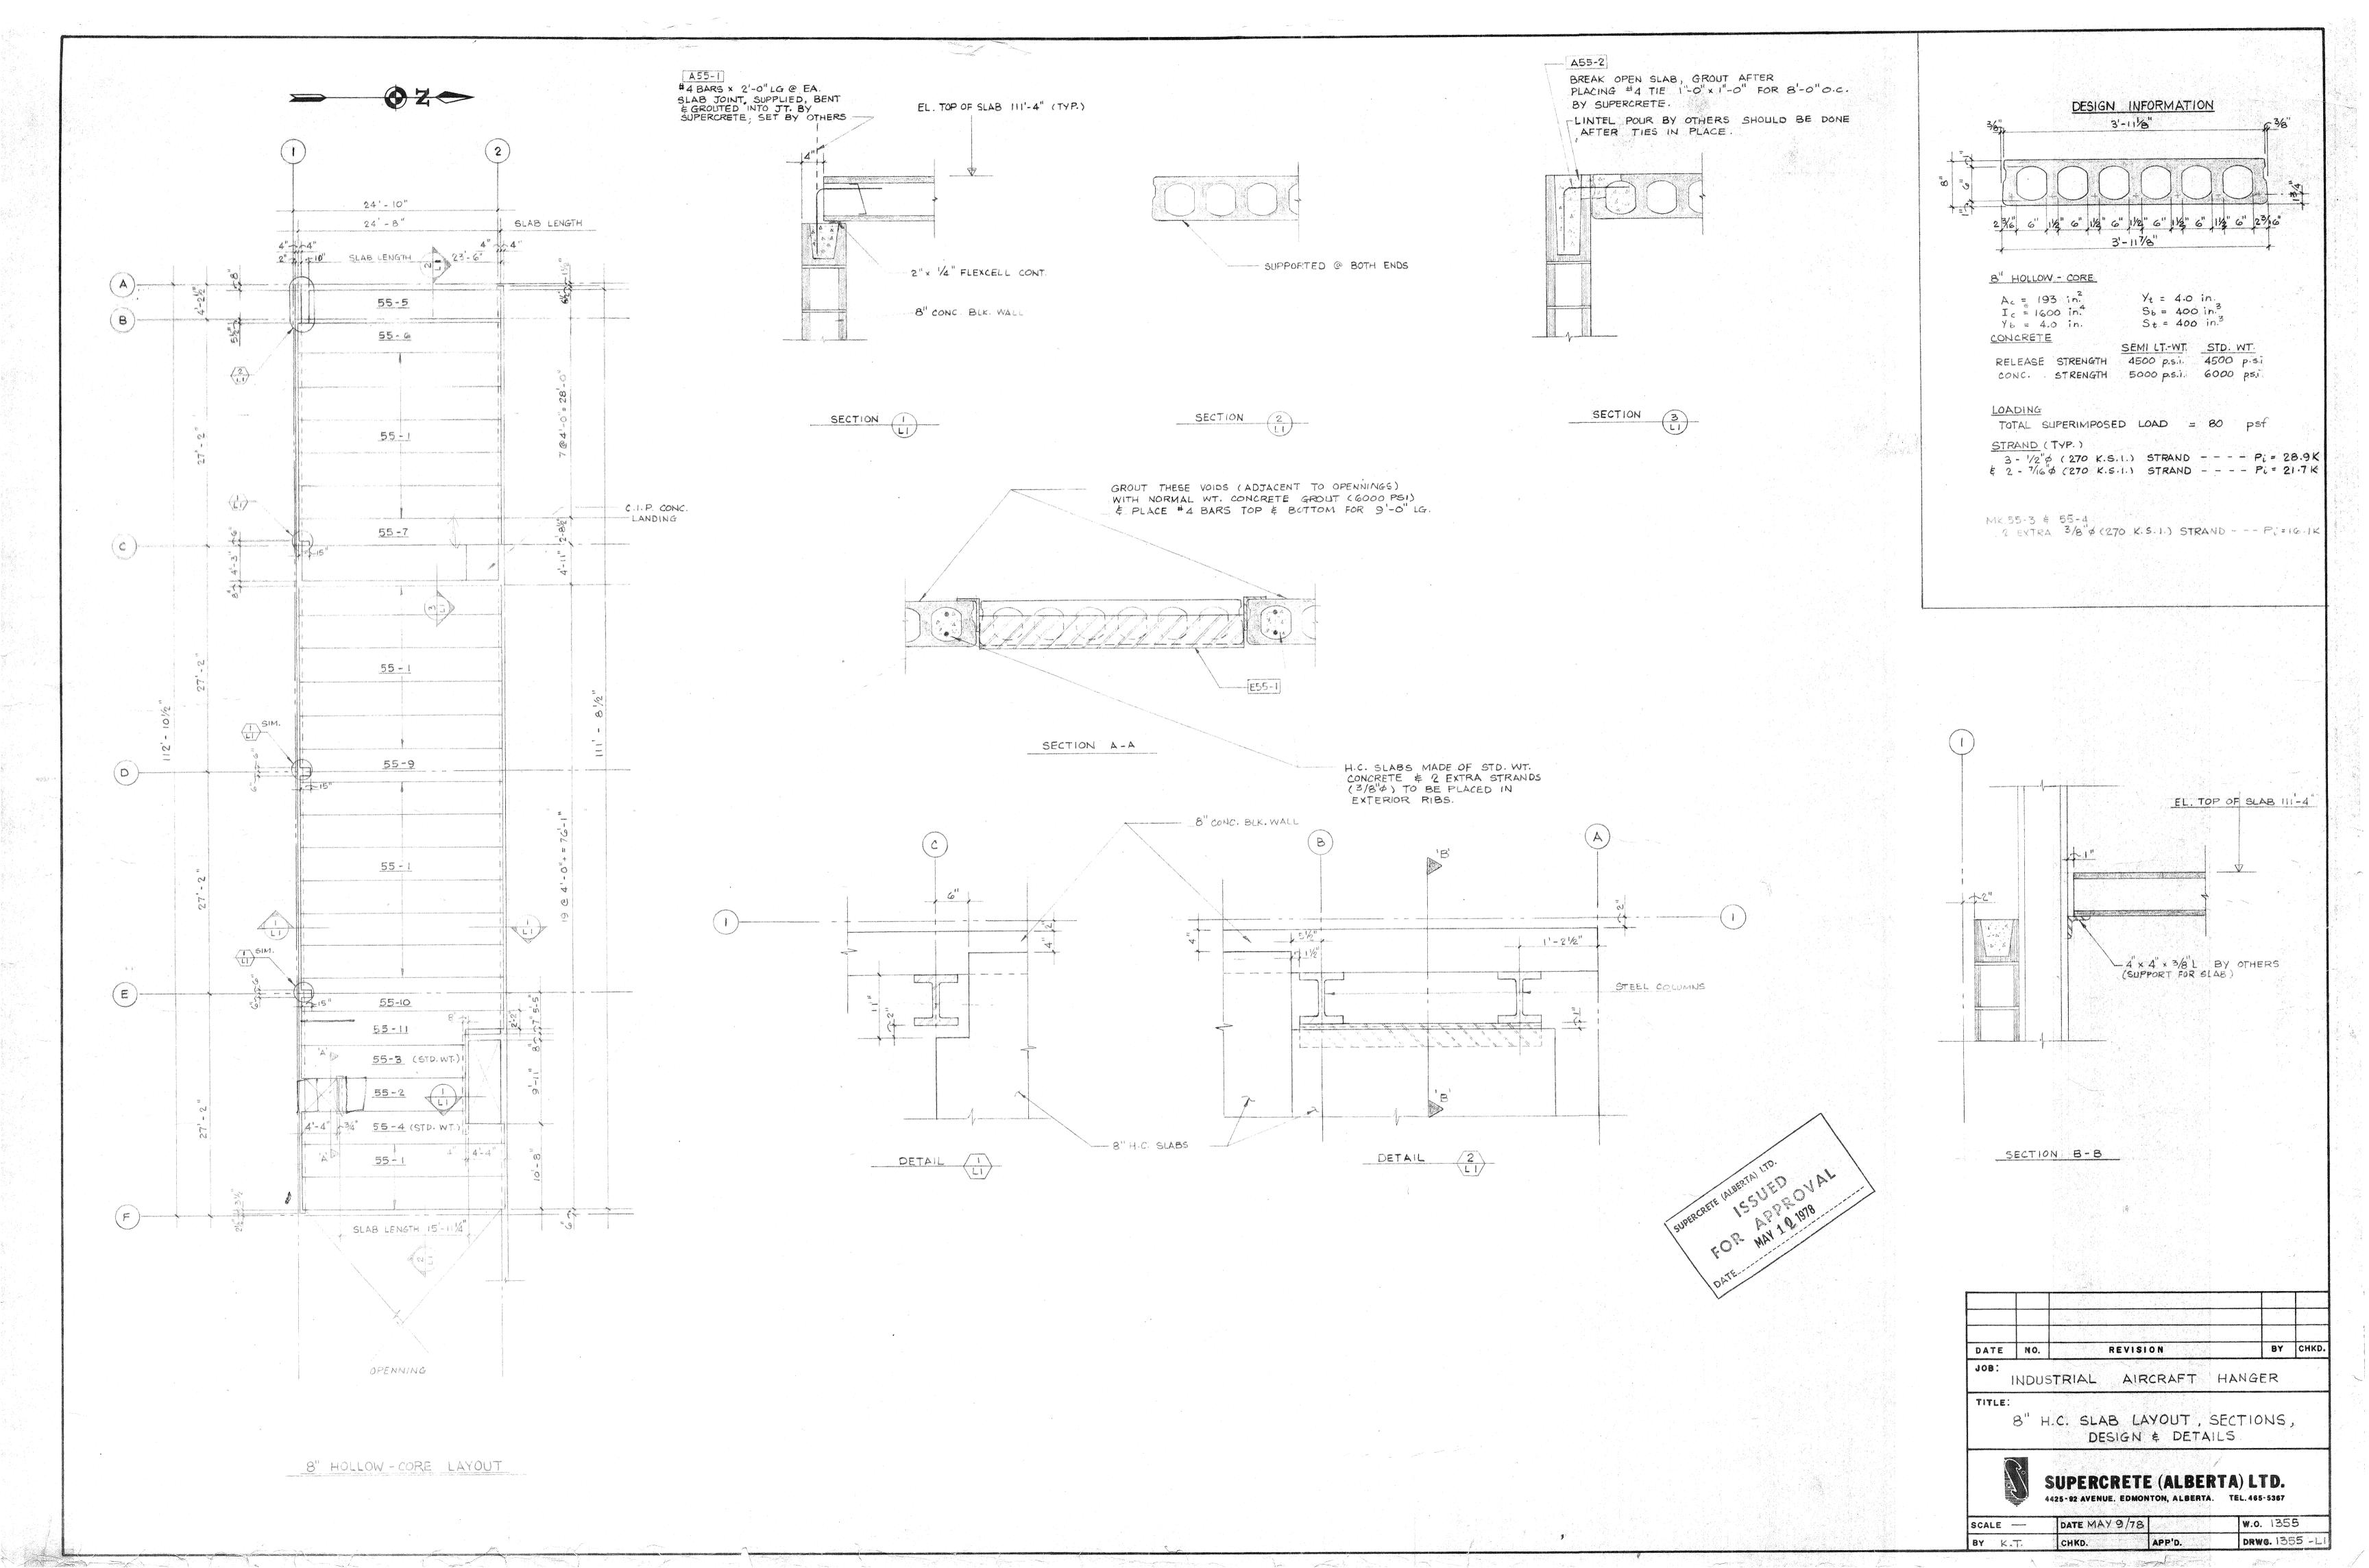


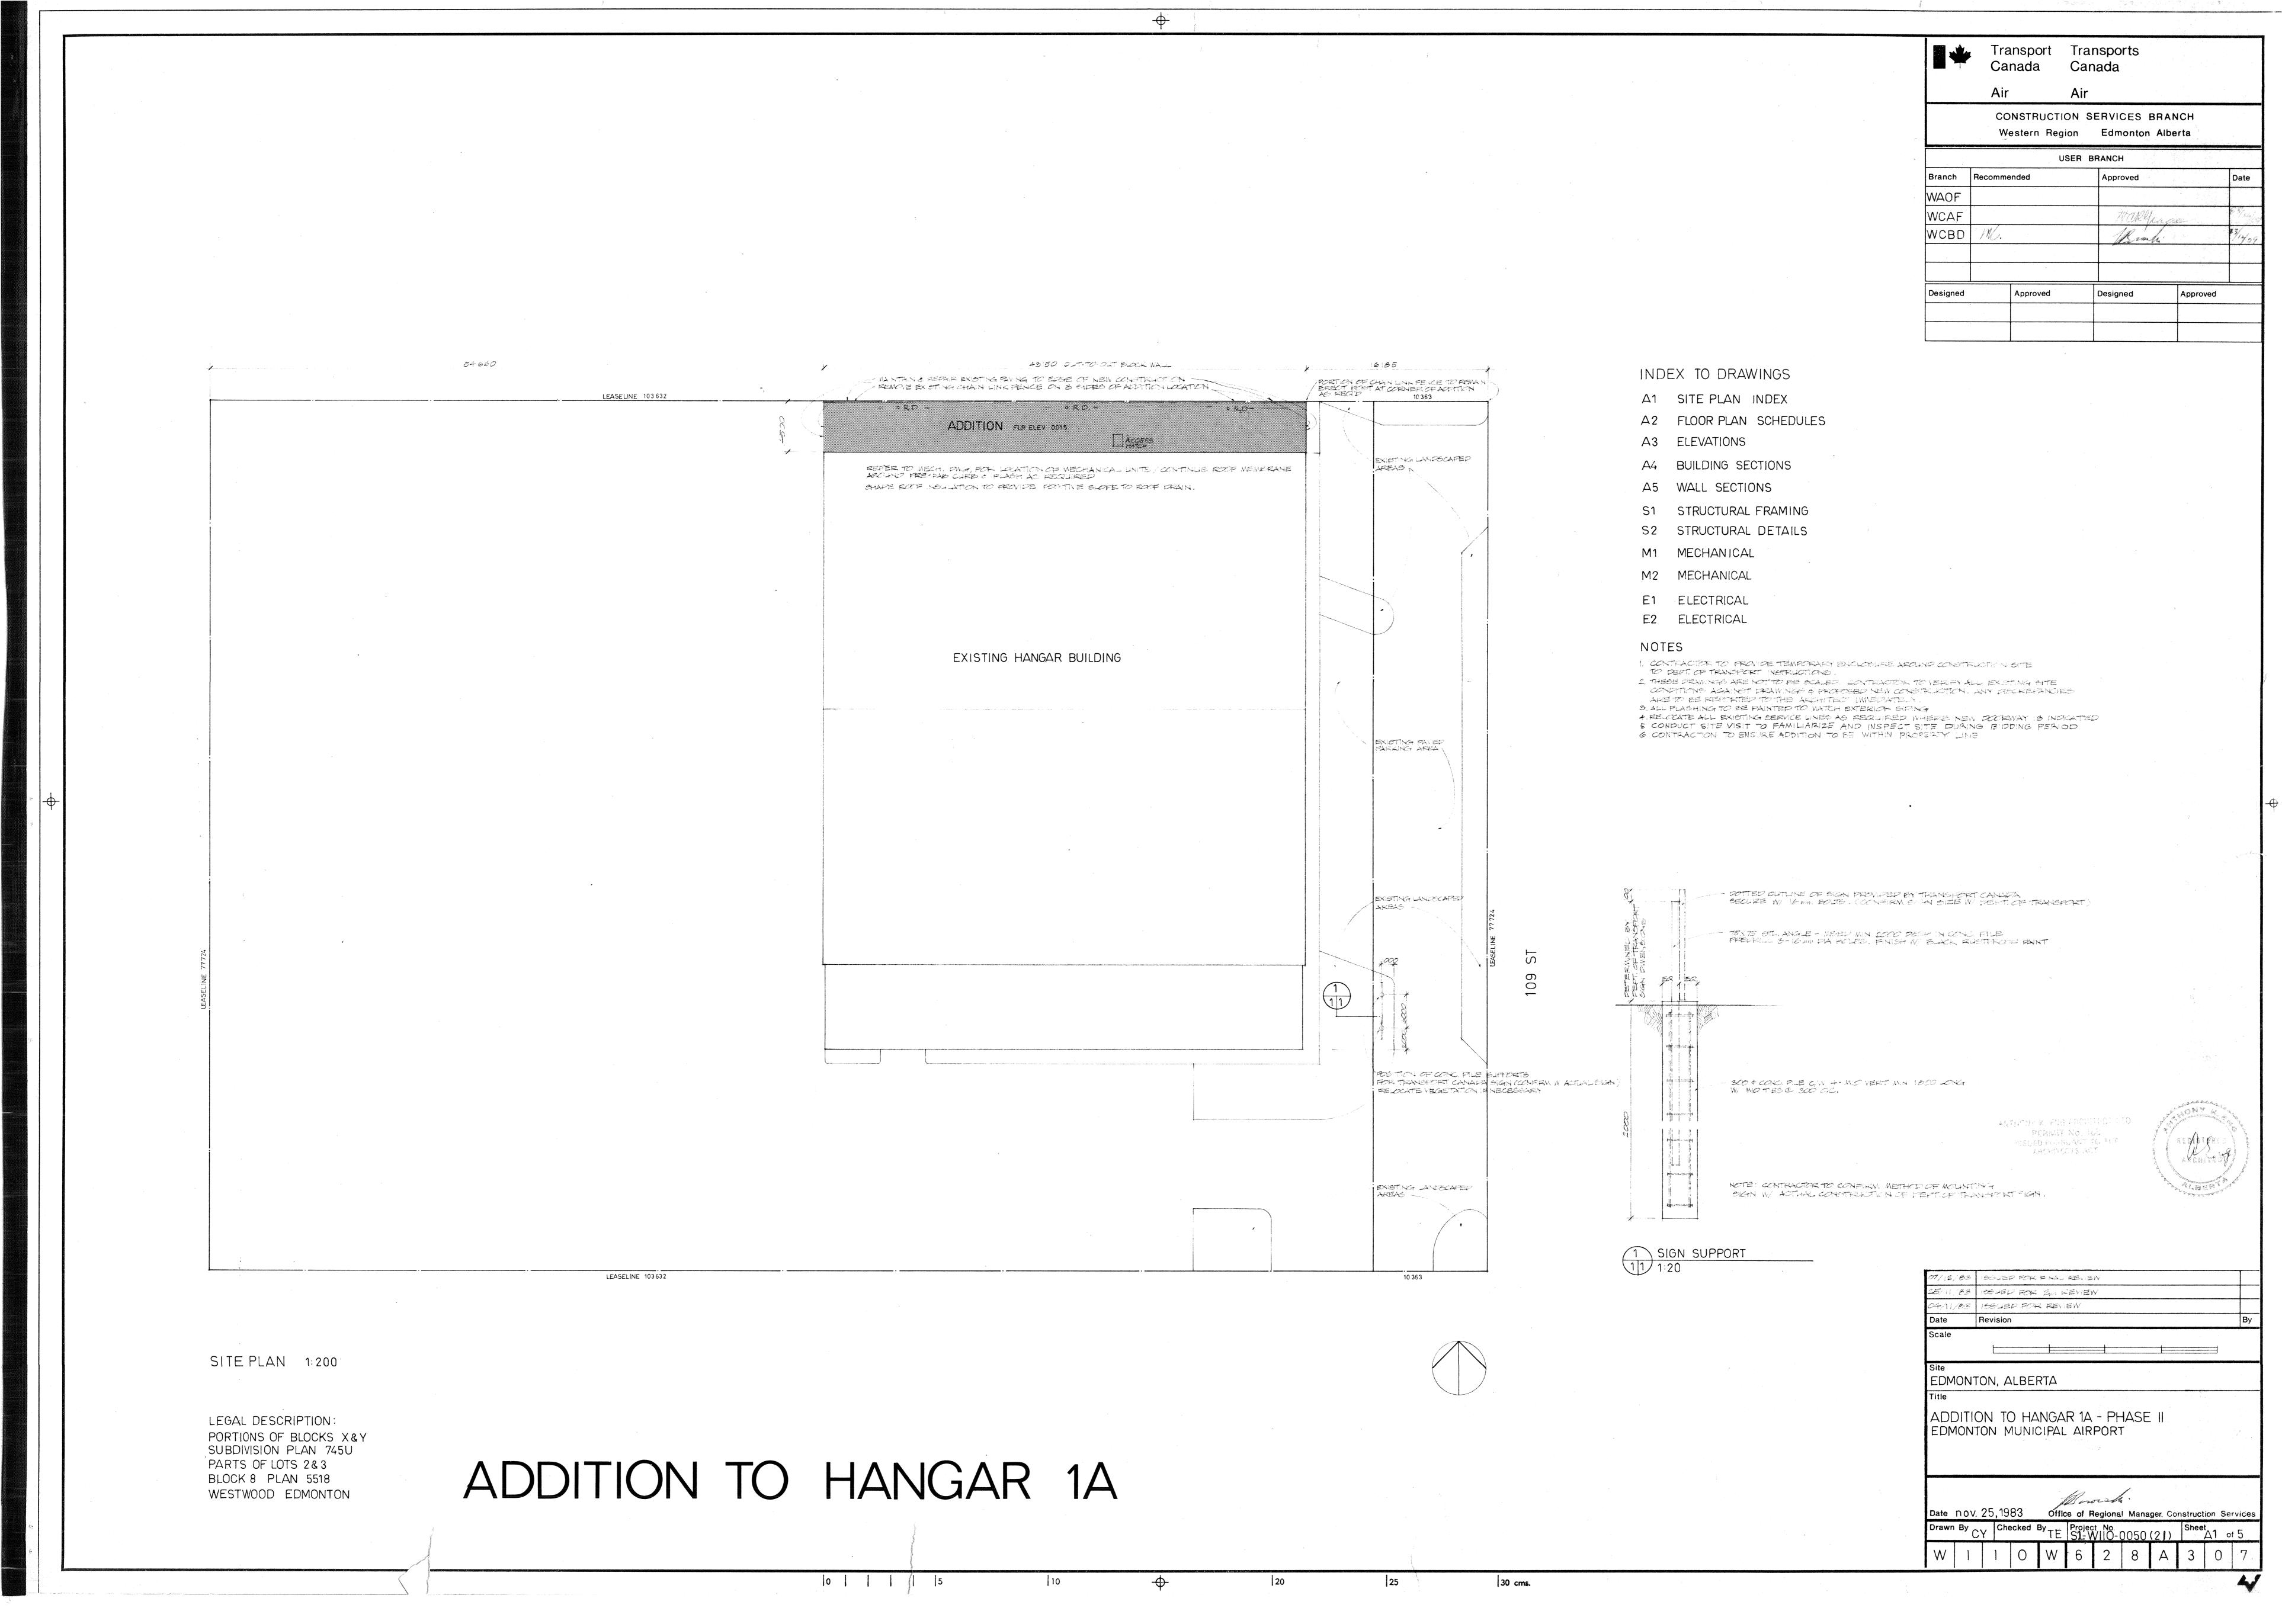



| | | | | | | | WALLS | | | | | | | | | | | | | | | | | | | |
|-------|---------------------------------|-----------------------|--------------------|-------------|-------------|---------------|--------------------------------|-------------|-------------------------|---------------|--------------------------|---------|---------------------------------|--------|---------|--------|--------------|-----------------|--------------------|------------|---------------------|-------------------------------------|---------|--------------|----------------------|--|
| ROOMS | FL00 | R | BASE | | NOR: | TH | EAST | | SOUTH | 4 | WES | T | C | EILING | | | DOOR | <u> </u> | | FRAME | | WINDO | V | FRAME | - | REMARKS |
| | material | fin col | material | fin col | material | fin col | material | fin col | material | fin col | material | fin | col material | fin | col | ht | material | fin c | ol mater | ial f | ín col | material | fin col | material | fin col | |
| 101 | CONCRETE/OIL TROWELSURFACE | | | CLEAN BLK | CONC. PLOCA | FAINT WHITE | CONC. BLOCK | PAINT WHITE | CONC. BLOCK EXIETING | PAINT WHITE | CONC BLOCK | K PAINT | WHITE STL DECK EXPOSED | PAINT | WHITE | 3600 | PRESSED OTL | PAINT GO ACE | ID PRESSE | ED STL PA | AINT SOLID ACCENT | | | | | FLR. TO HAVE ACID RESISTANT EPOXY COATING |
| 102 | CONCRETE/STL. TROWEL SURFACE | | 100 R. BASE | CLEAN BLK | COXC. BLOCK | PAINT WHITE | E CONC. BLOCK | PAINT WHITE | EXISTING | PAINT WHITE | CONC. BLOCK | PAINT | WHITE STL. DECK EXPOSED | PAINT | WHITE | 3600 1 | PRESSED STL. | PAINT 60 | LIP PRESSE | ED STL. PA | AINT SOUD ACCENT | | | | | |
| 103 | CONCRETE/ STL TROWEL SURFACE | | 100 R. BASE | CLEAN BLK | COXC. 3-0CH | PAINT WHITE | E CONC. BLOCK | PAINT WHITE | EXISTING | PAINT WHITE | CONC. BLOCK | K PAINT | WHITE OTL, SECK EXPOSED | PAINT | WHITE | 3600 1 | PRESSED STL. | PAINT SO | LIP PRESSE | DST. PA | AINT SOUD ACCENT | | | | | |
| 104 | CONCRETE/STL TROWEL SURFACE | 1 | 100 R. BASE | CLEAN BLK | CONC. BLOCK | PAINT WHITE | E CONC. BLOCK | PAINT WHITE | EXISTING | PAINT WHITE | CONC. BLOC | KANT | WHITE STL. DECK EXPOSED | PAINT | WHITE | 3600 1 | PRESORD STL. | PAINT BO | UP PRESSE | ED STL PA | AINT SOUP ACCENT | | | | | |
| 105 | CONCRETE OT. TROWEL SURFICE | | 100 R. BASE | CLEAN BLK | CONC. BLOCK | C PAINT WHITE | E CONC. BLOCK/ GLASS WINDOW | PAINT WHITE | EXISTING | PAINT WHITE | CONG, BLOCK | PAINT | WHITE STL PECK EXPOSED | PAINT | WHITE | 3£00 F | PRESOED STL. | PAINT SC AG | LID PRESSE JENT | ED STL. P | 1 1 | 25 mm HERM. SEAL DOUBLE GLAZING | 1 | PRESCED STL. | PAINT SOUP ACCENT | ROOF HATCH AT CEILING STL. DECK. |
| 106 | 300×300 V.A.T. | CLEAN, ACTIONS WAX | 100 RUBBER BASE | CLEAN BLACT | CONC. BLOCK | PAINT WHITE | GLASS WINDOW | PAINT WHITE | EXISTING | FAINT WHITE | CONC. ELOCA | PAINT | WHITE 600 x 1200 40015, TILE | 1 1 | WHITE : | 2745 | PRESSED STL | PAINT SC AC | LIP PRESSE | EP STL. PA | , , | 25 mm HERN. SEAL COLUMNE GLAZING | 1 1 | PRESSED STL | | V.A.T. COLOUR BY AMTICO OR APPROVED EX |
| 107 | 300×300 NAT. | CLEAN ACTIONS WAX | 100 RLEBER BASE | CLEAN BLACK | CONC. BLOCK | PAINT WHITE | E CONC. BLOCK | PAINT WHITE | CONC. BLOCK EXISTING | PAINT WHITE | CANC BLOW GLASS WINDO | 1 | WHITE 600 × 1200 ACO45, TILE |) 1 | WHTE: | 2745 | PRESSED STL. | PAINT 60 | LID PREASE | DSTL. PA | 3 (| 25 mm HERM. SEAL DOJELE GLAZING | 1 1 | , , | | VA.T. COLOLIR BY ANTICO CR APPROVED EX |
| 108 | CONCRETE, STL. TROVEL SURFIXE | | DOR BASE | CLEAN BLK | CONC BLOCK | C PAINT WHITE | E CONC. BLOCK | PANT WHITE | E CONC. BLOCK | PAINT WHITE | CONC. BLOCK | PAINT | WHITE STL DECK EXPOSED | PAINT | WHITE | 8600 | PRESSED STL. | PAINT SC | LID PRESOE | ED ST. PA | ANT SOUP ACCENT | | | | | |
| 109 | 300×300 V.AT. | CLEAN, ACT-1018 | 100 RUBBER BASE | CLEAN BLACK | CONC BLOCK | PAINT WHITE | e conc. Block | PAINT WHITE | EXISTING | , PANT WHITE | CONC BLOCK | PAINT | WHITE 600 X 1200 ACO45, TLE | 1 1 | WHITE : | 2745 | REGIED STL. | FAINT SO | AD PRESSE | SP STL. PA | AINT SOUD ACCENT | | | | 1 1 | V.A.T. COLLUK EY ANTICO OR APPROVED EC OLG. TILE TO GUIDE #40 U.S.1 |
| 110 | CONCRETE/STL TROWEL SURFACE | | 100 R. BASE | CLEAN BIK | CONC. BLOW | S PAINT WHIT | E CONC. BLOCK | PAINT WHITE | CONG BLOCK EXISTING | : PAINT WHITE | CONC. BLOCK | PAINT | WHITE OTL. PECK EXPOSED | PAINT | WHITE | 3600 | PRESSED STL. | PAINT SC | UD PRESSE | 10 STL. PA | ACCENT | | | | | · |
| 111 | CONCRETE/ST_ TROWEL SURFACE | | 100 R BASE , | CLEAN BLA | CONC. BLOC | K PAINT WHIT | E CO.KC. BLOCK | PAINT WHITE | EXISTING | PAINT WHITE | CONC. BLOCK | K PAINT | WHITE STL. PECK EXPOGED | PAINT | WHITE | 3600 | PRESSED STL. | PAINT SO | LID PRESSE | D STL. PA | ACCENT | | | | | |
| | | | | | | | | | | | | | | | | | | | | | | | | | | |


FINISH SCHEDULE NOTES: "HT@TOP OURFACE OF CHILING HUNG LIGHT F,XTURES TO BE 2750.

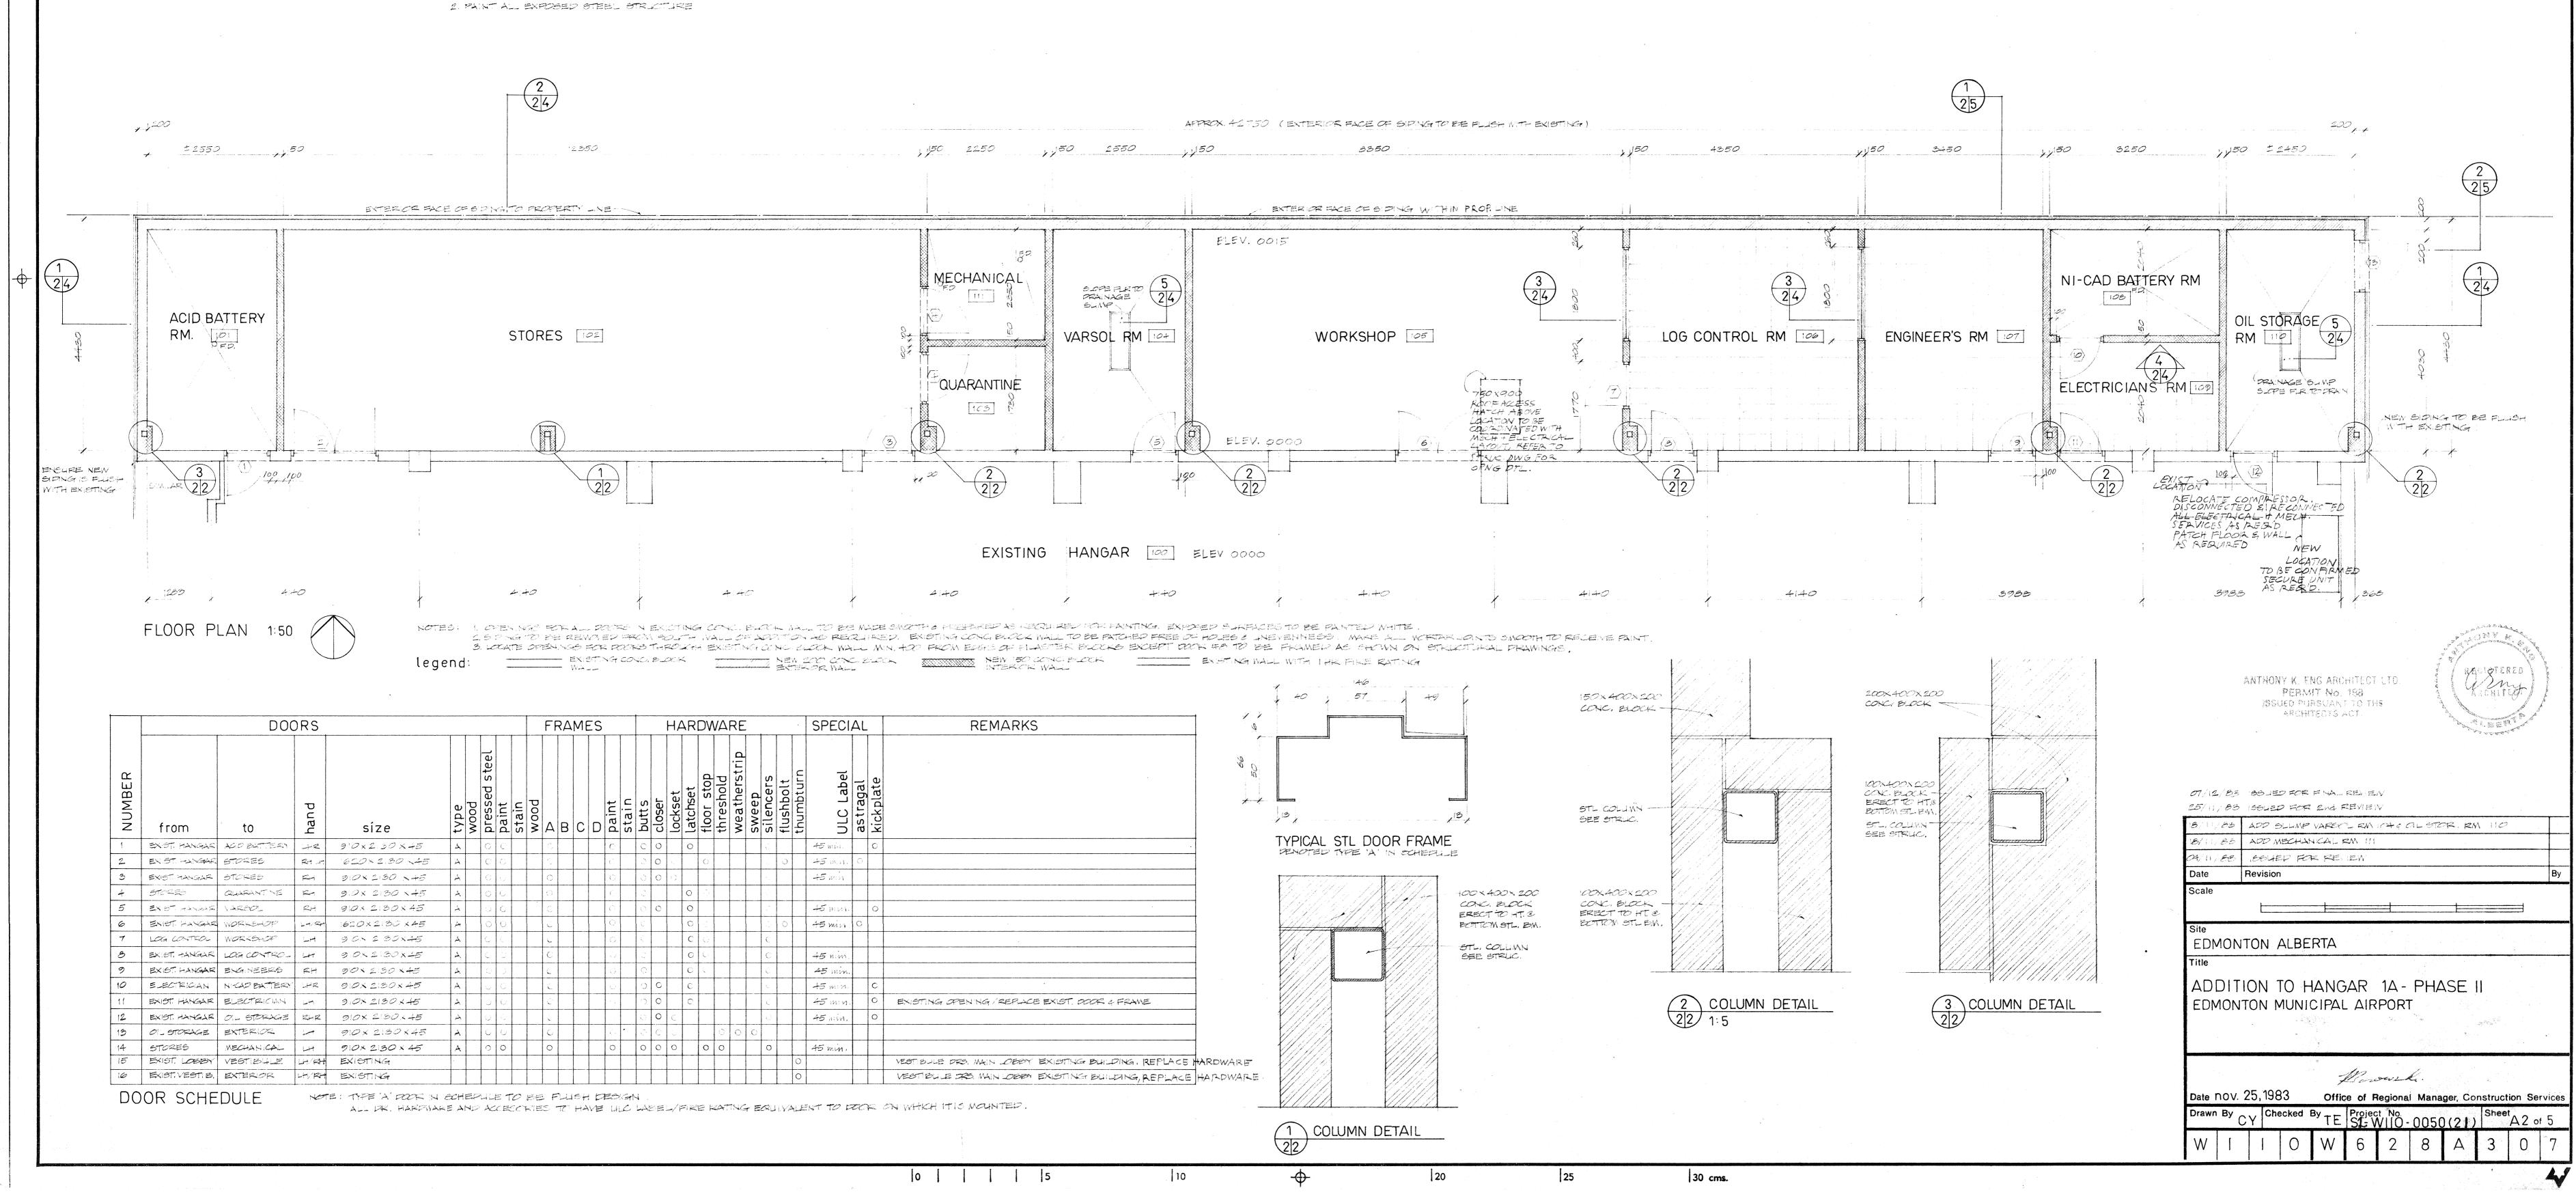


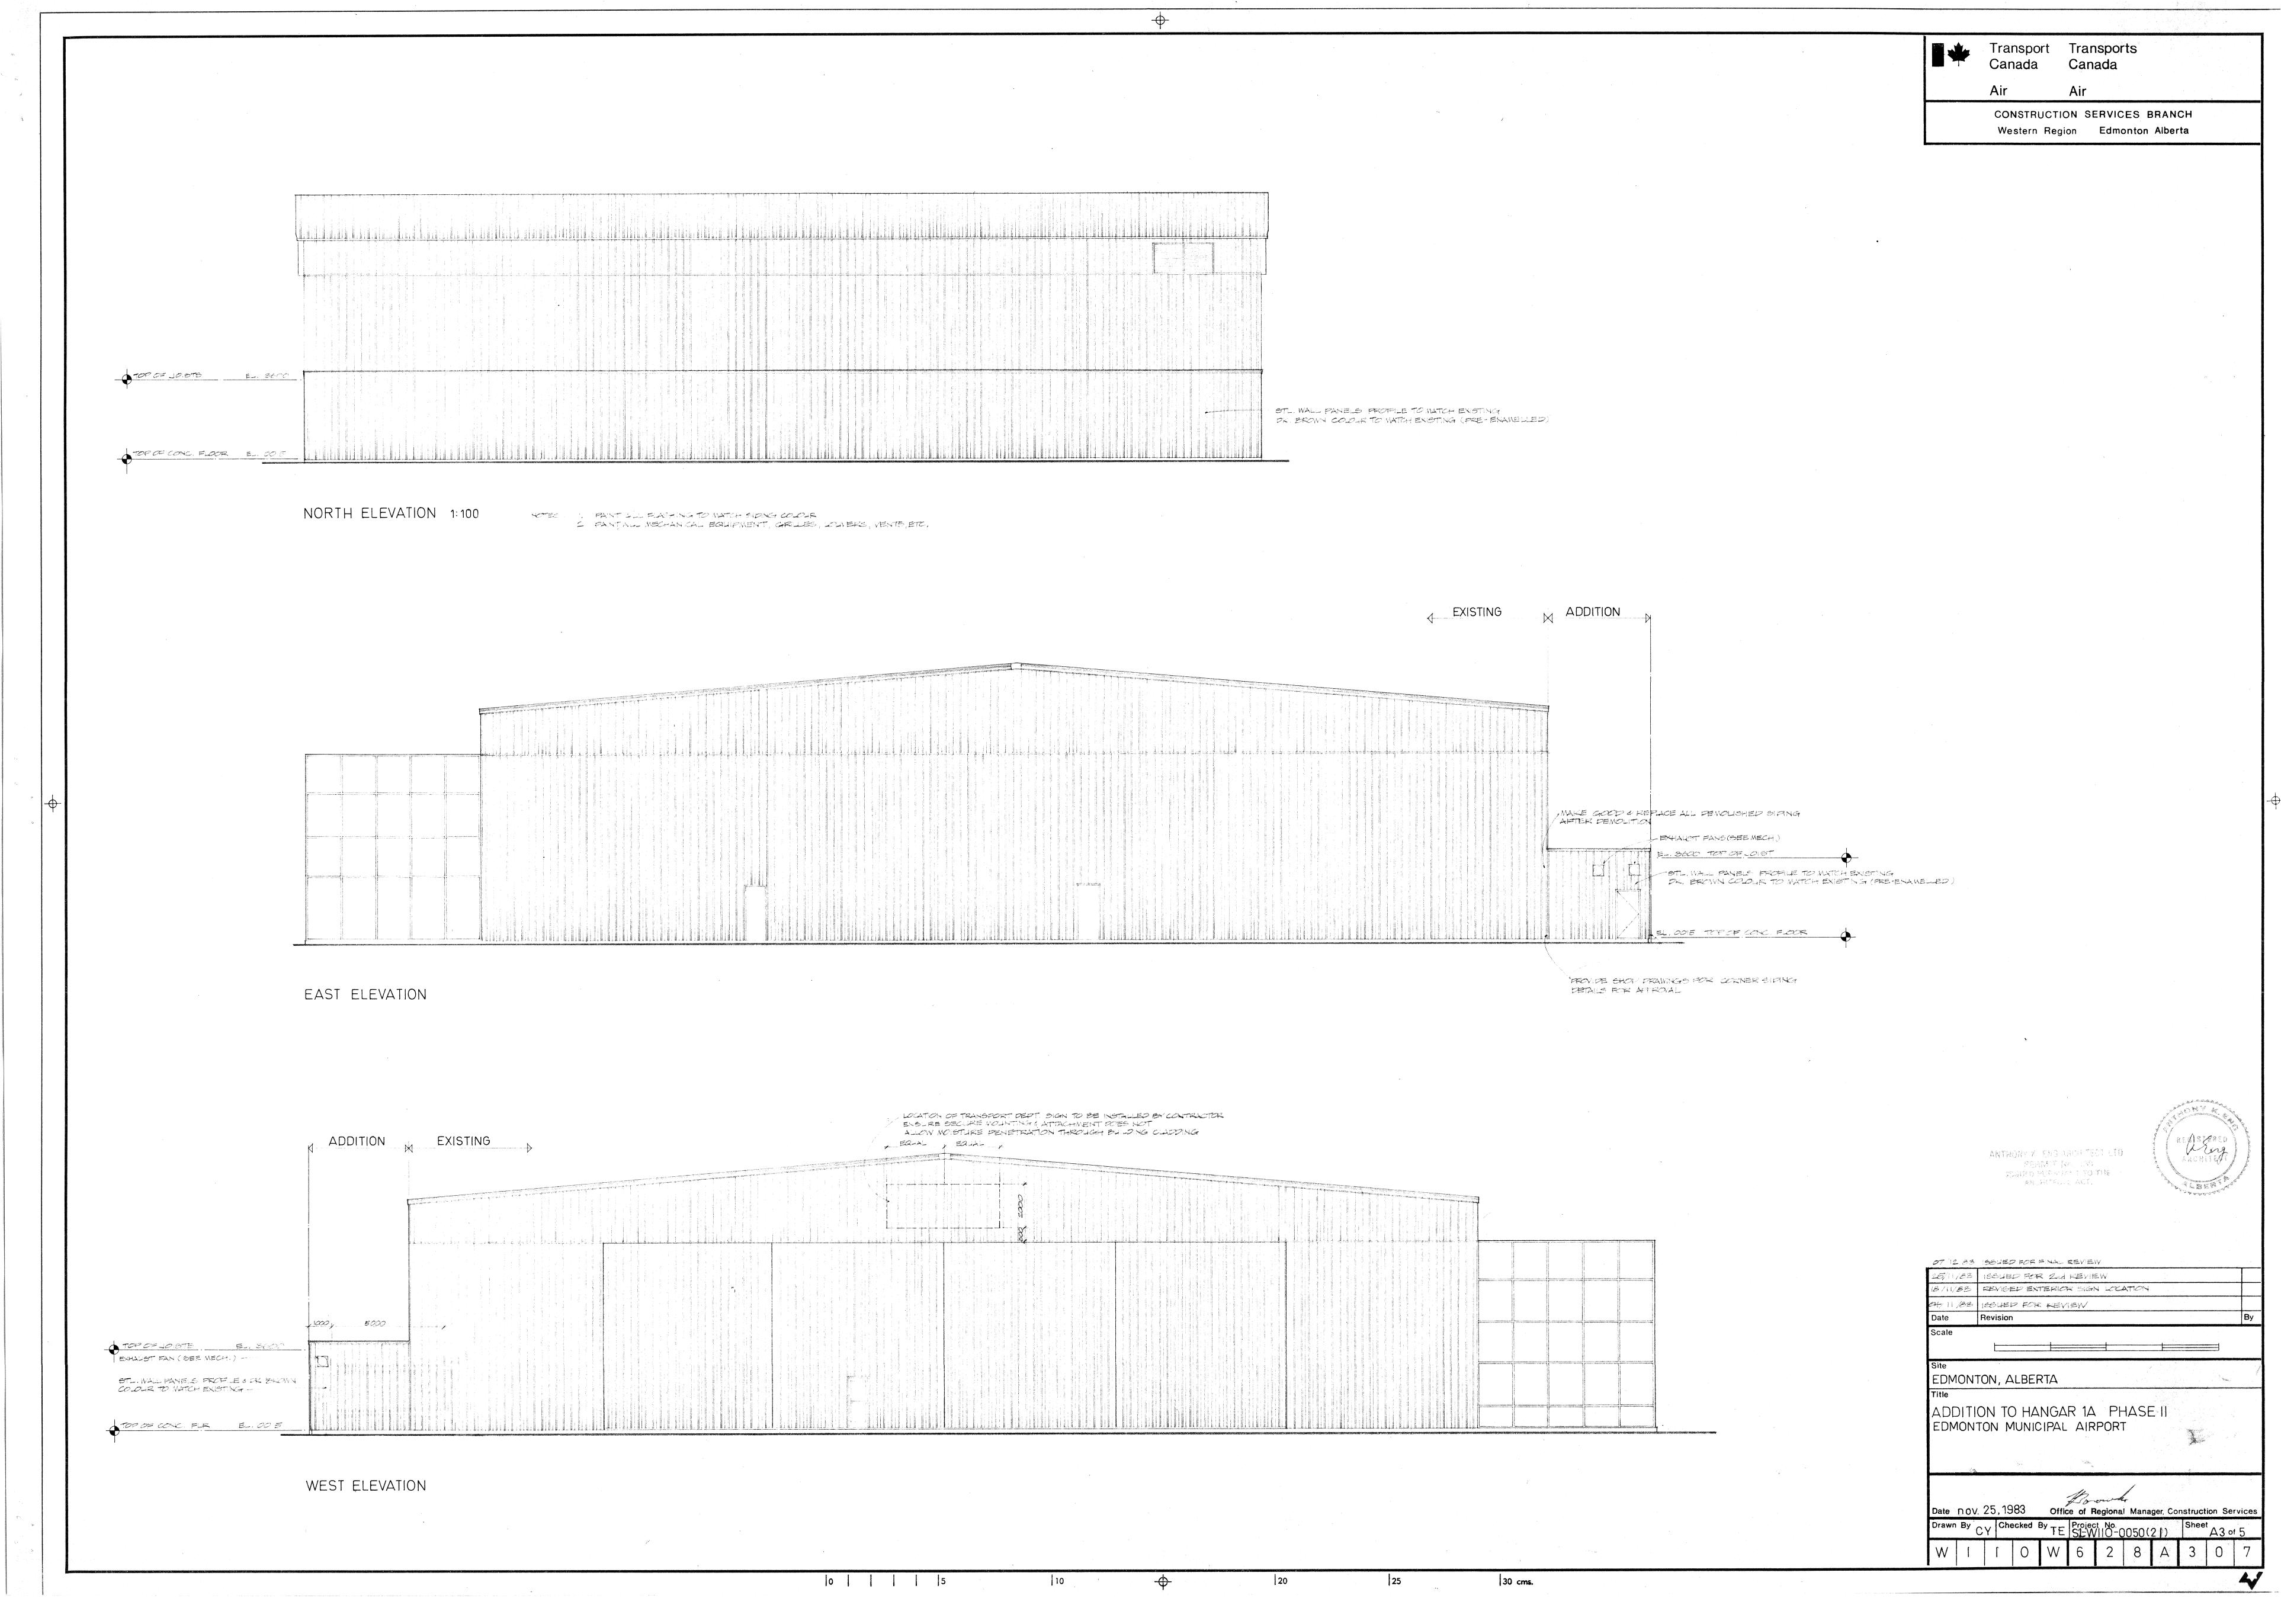

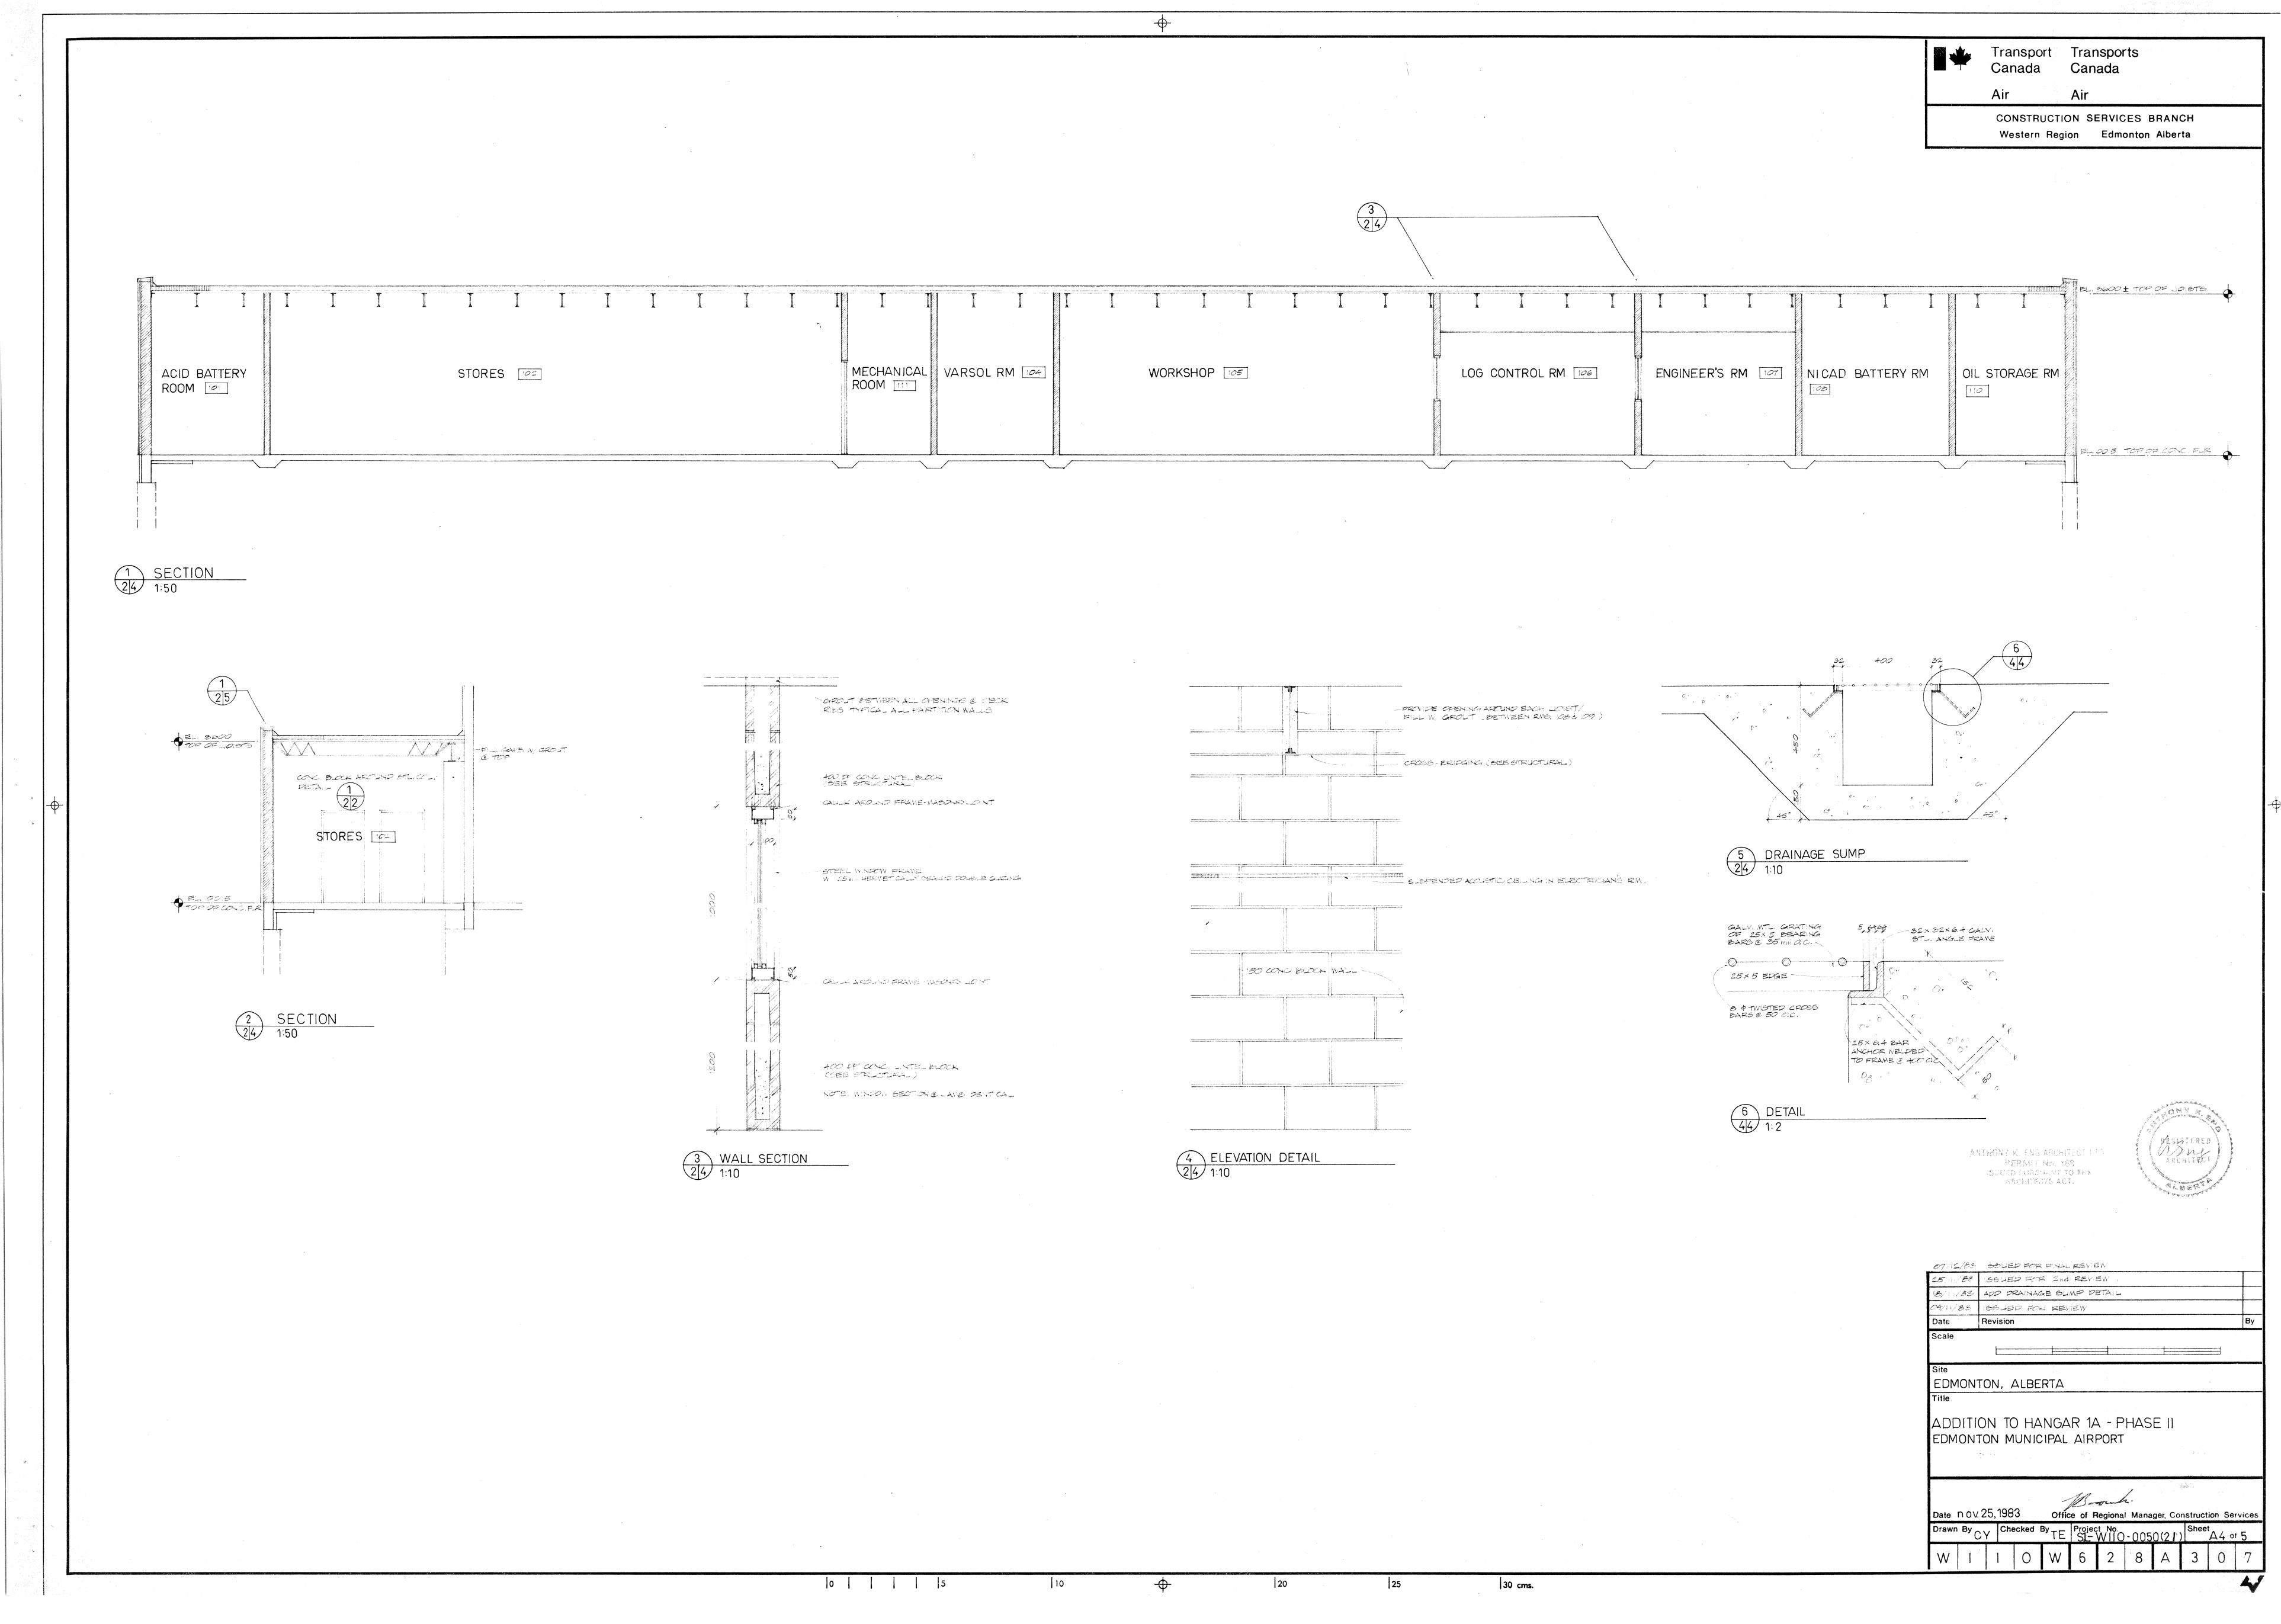


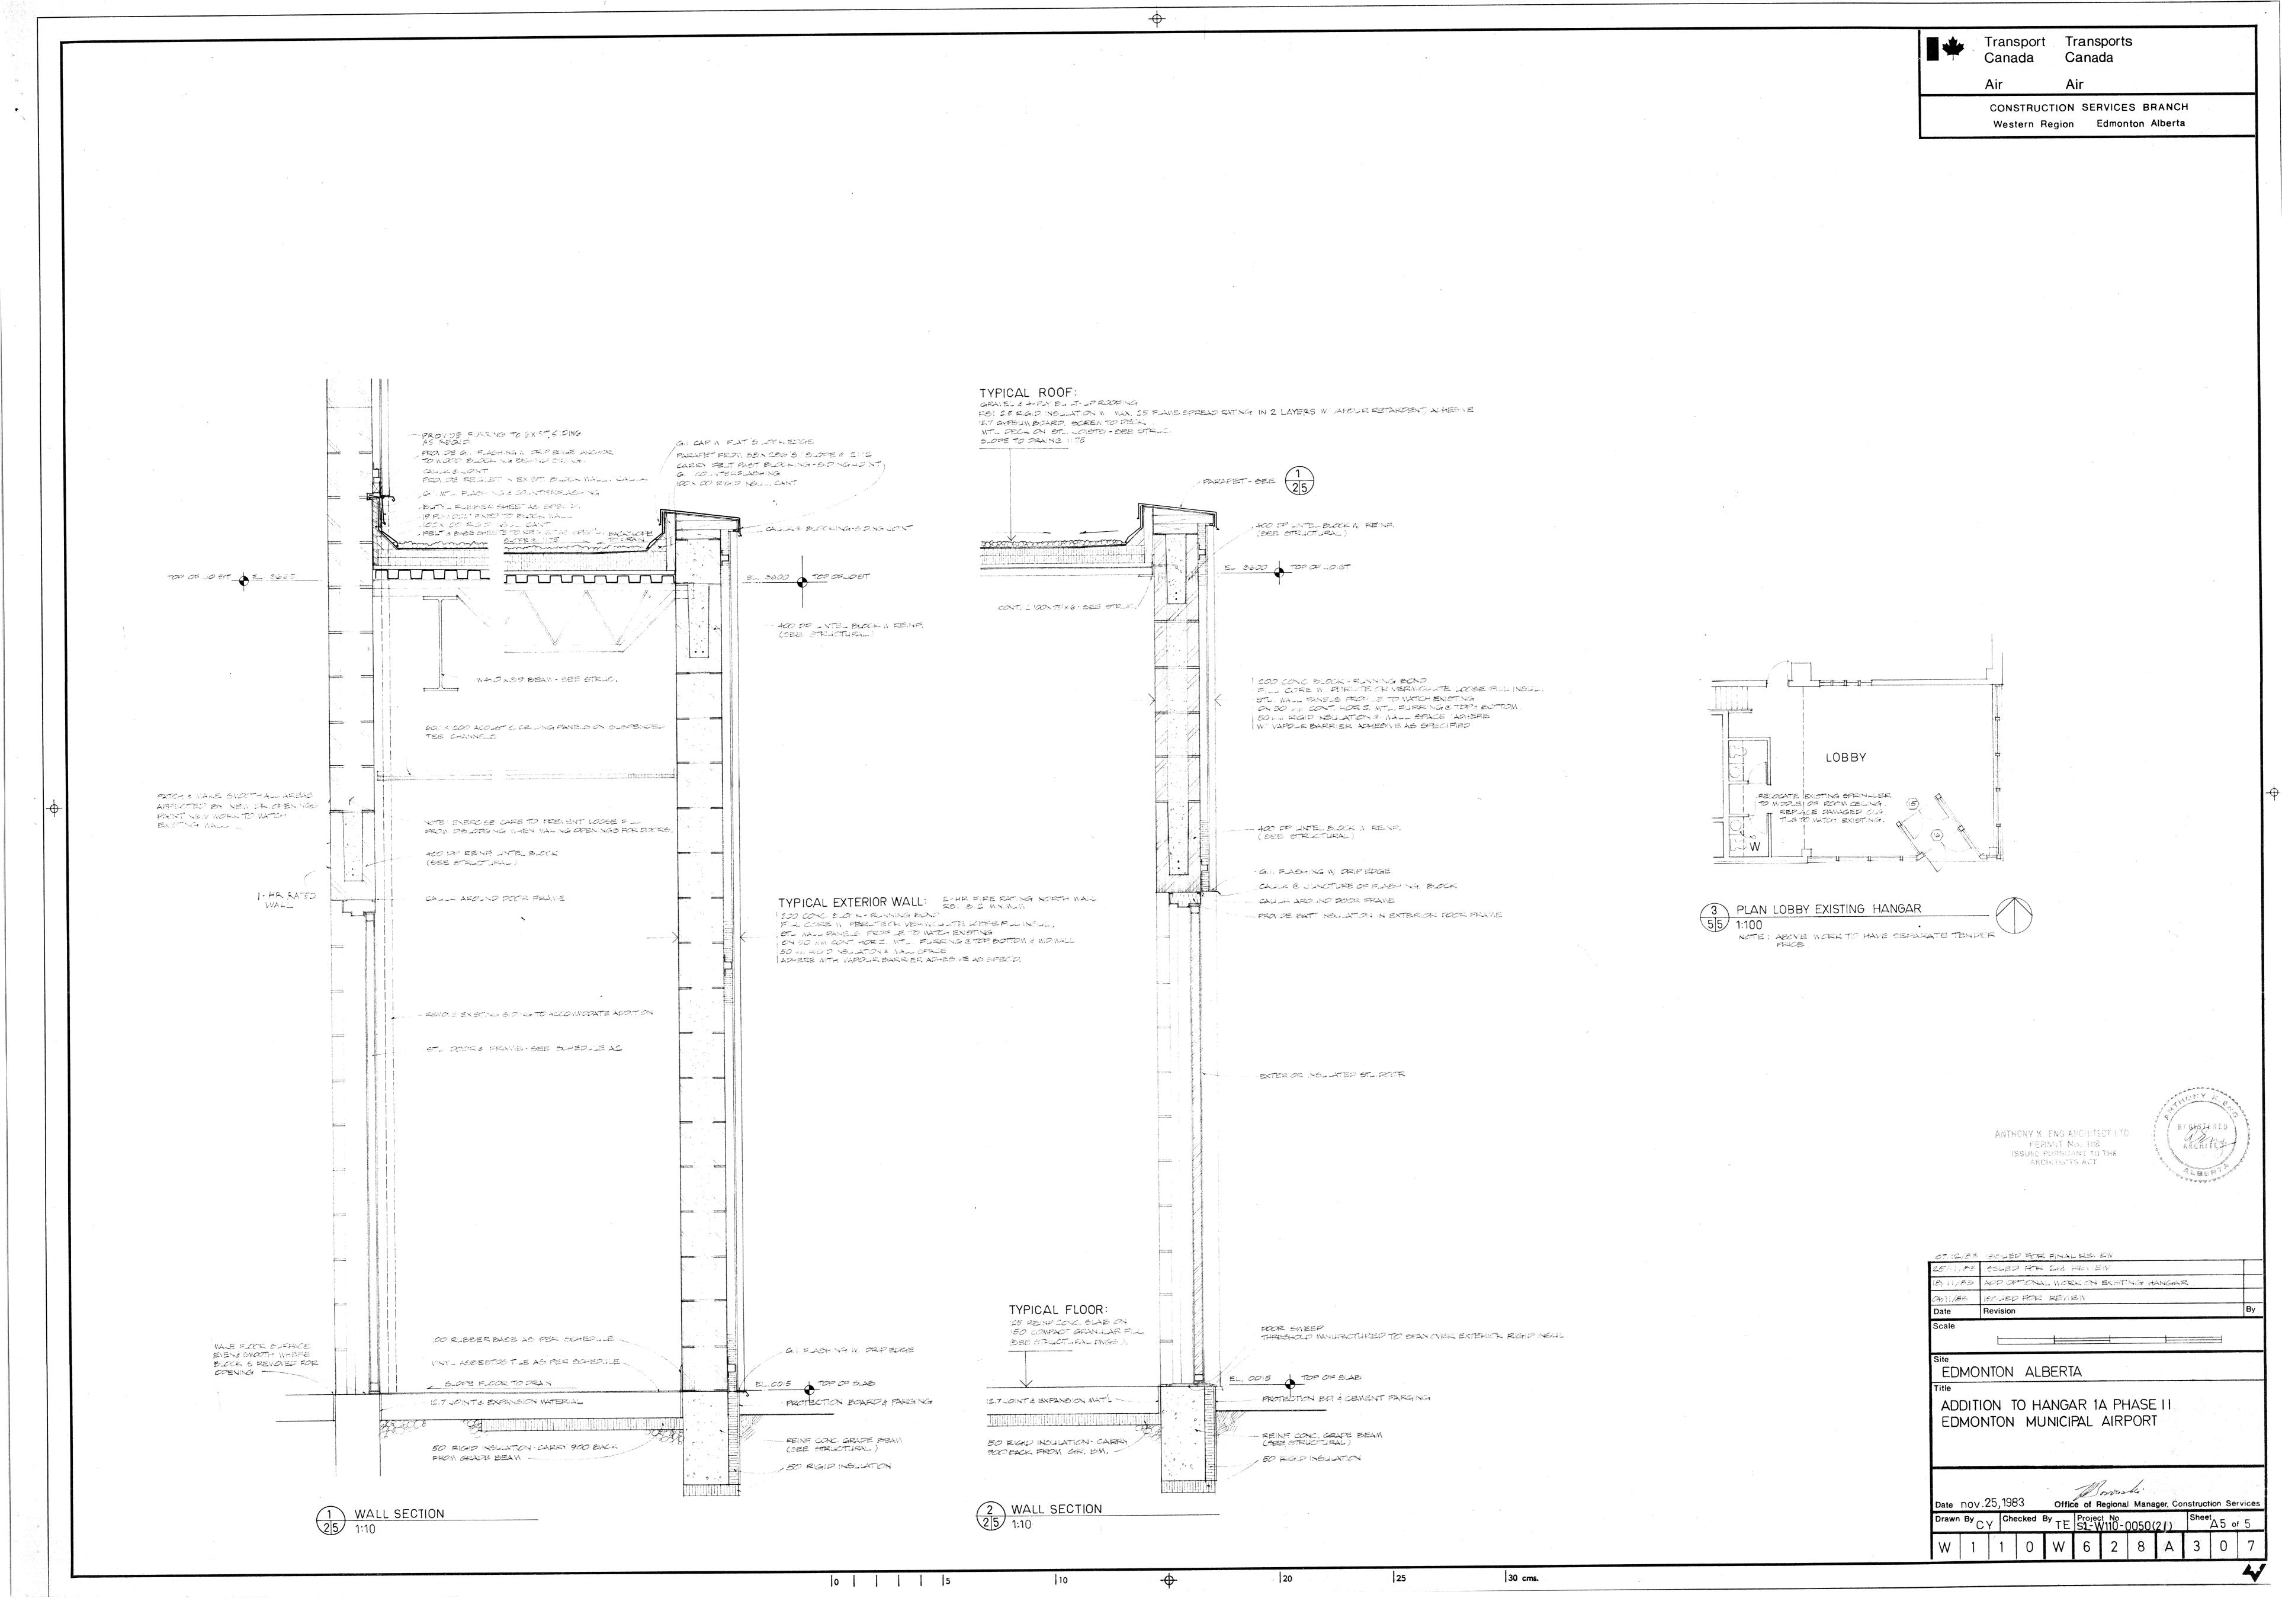


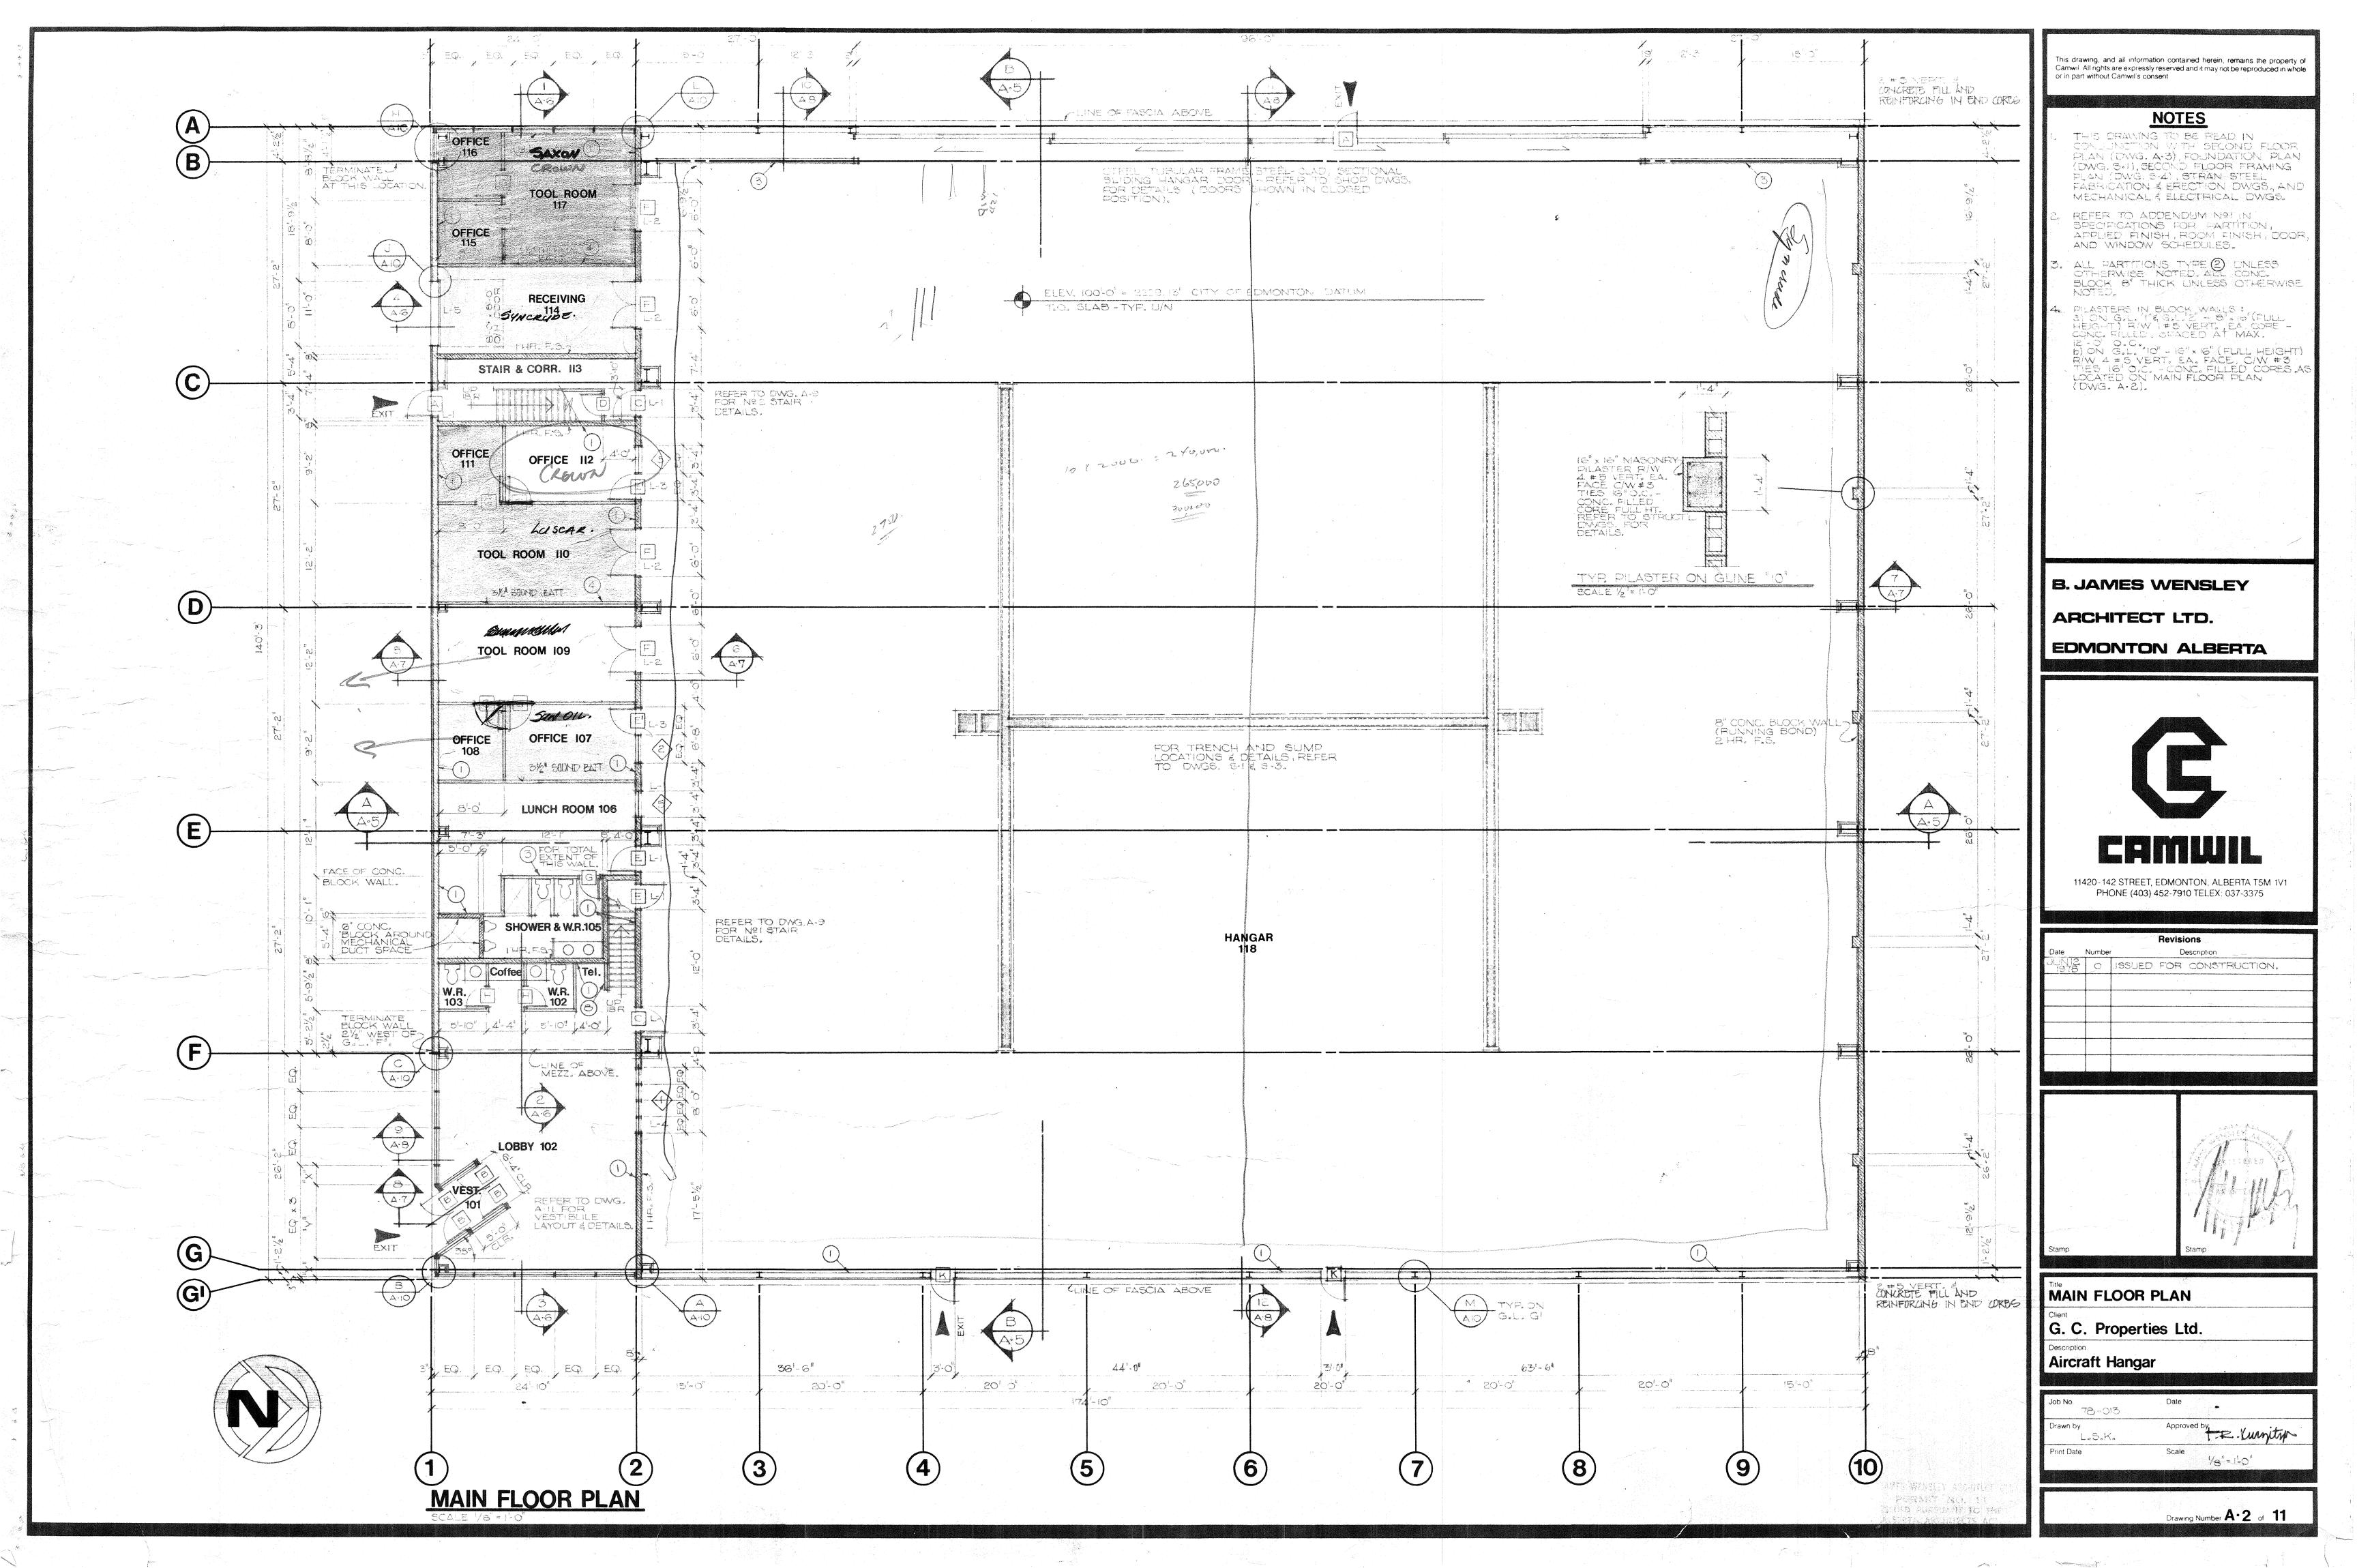

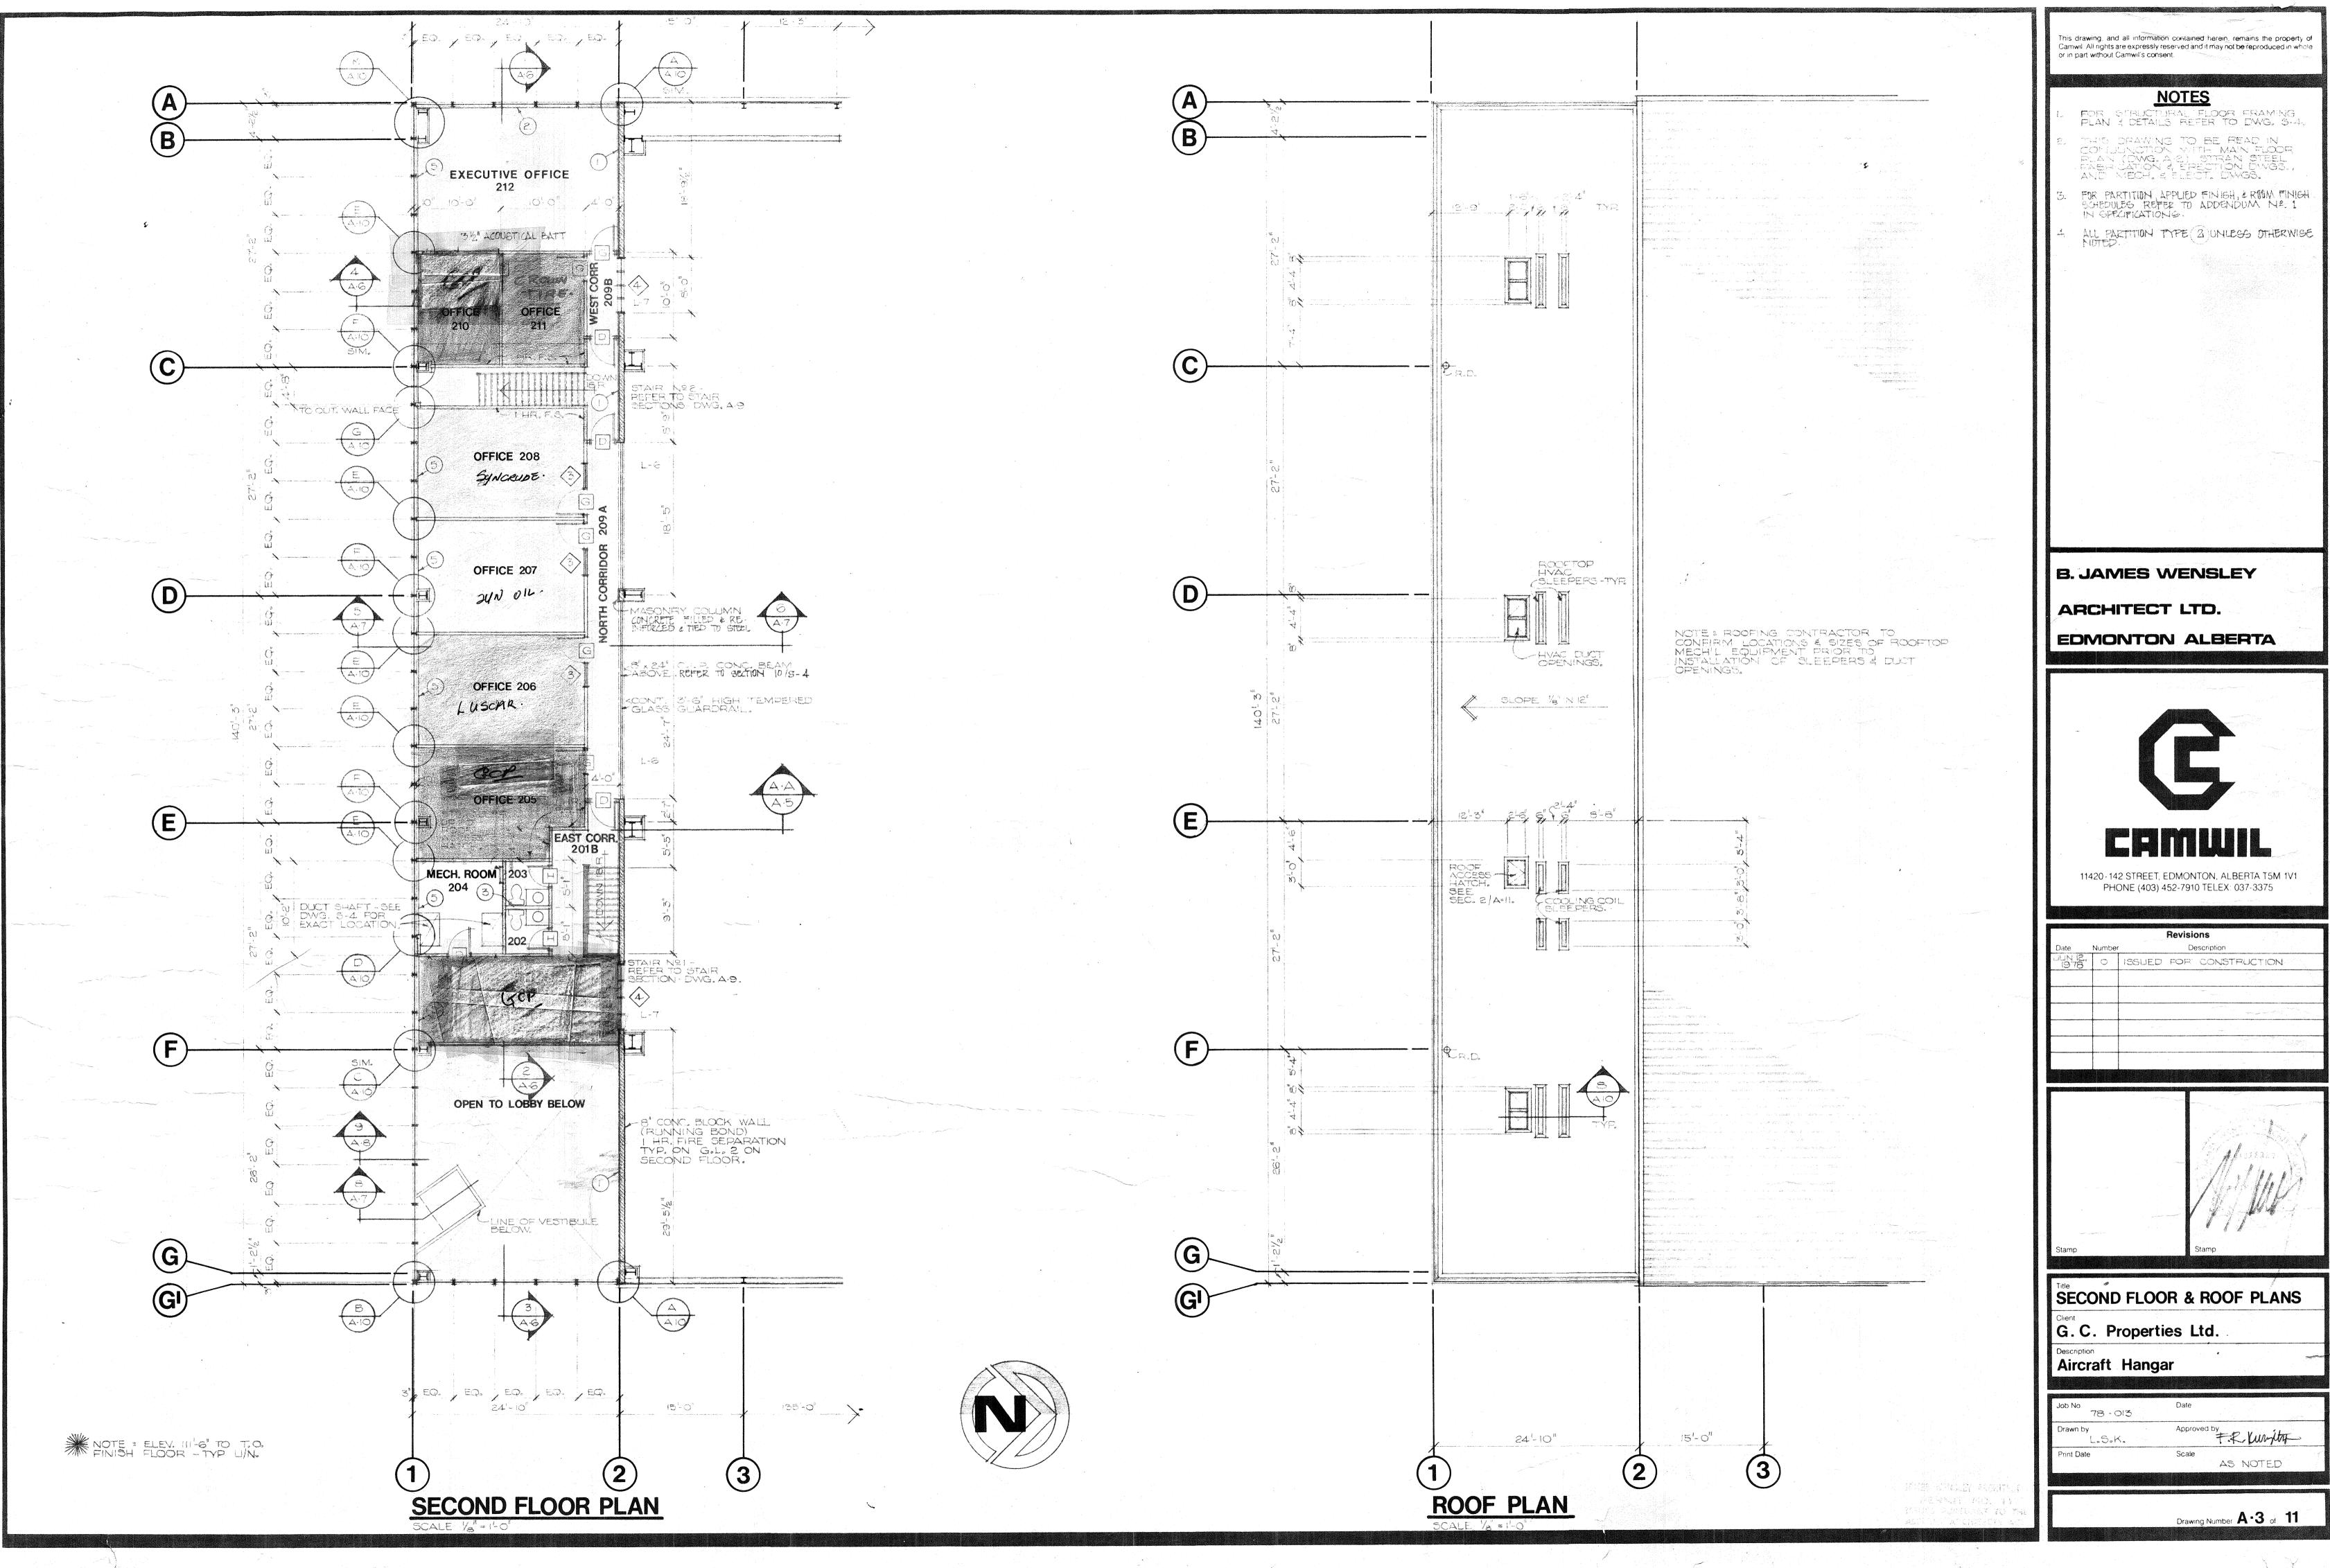

| | Revisions |
|-------------|--|
| Date Number | Description |
| 0 87.6 | ISSUED FOR CONSTRUCTION |
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| Stamp | Stamp |

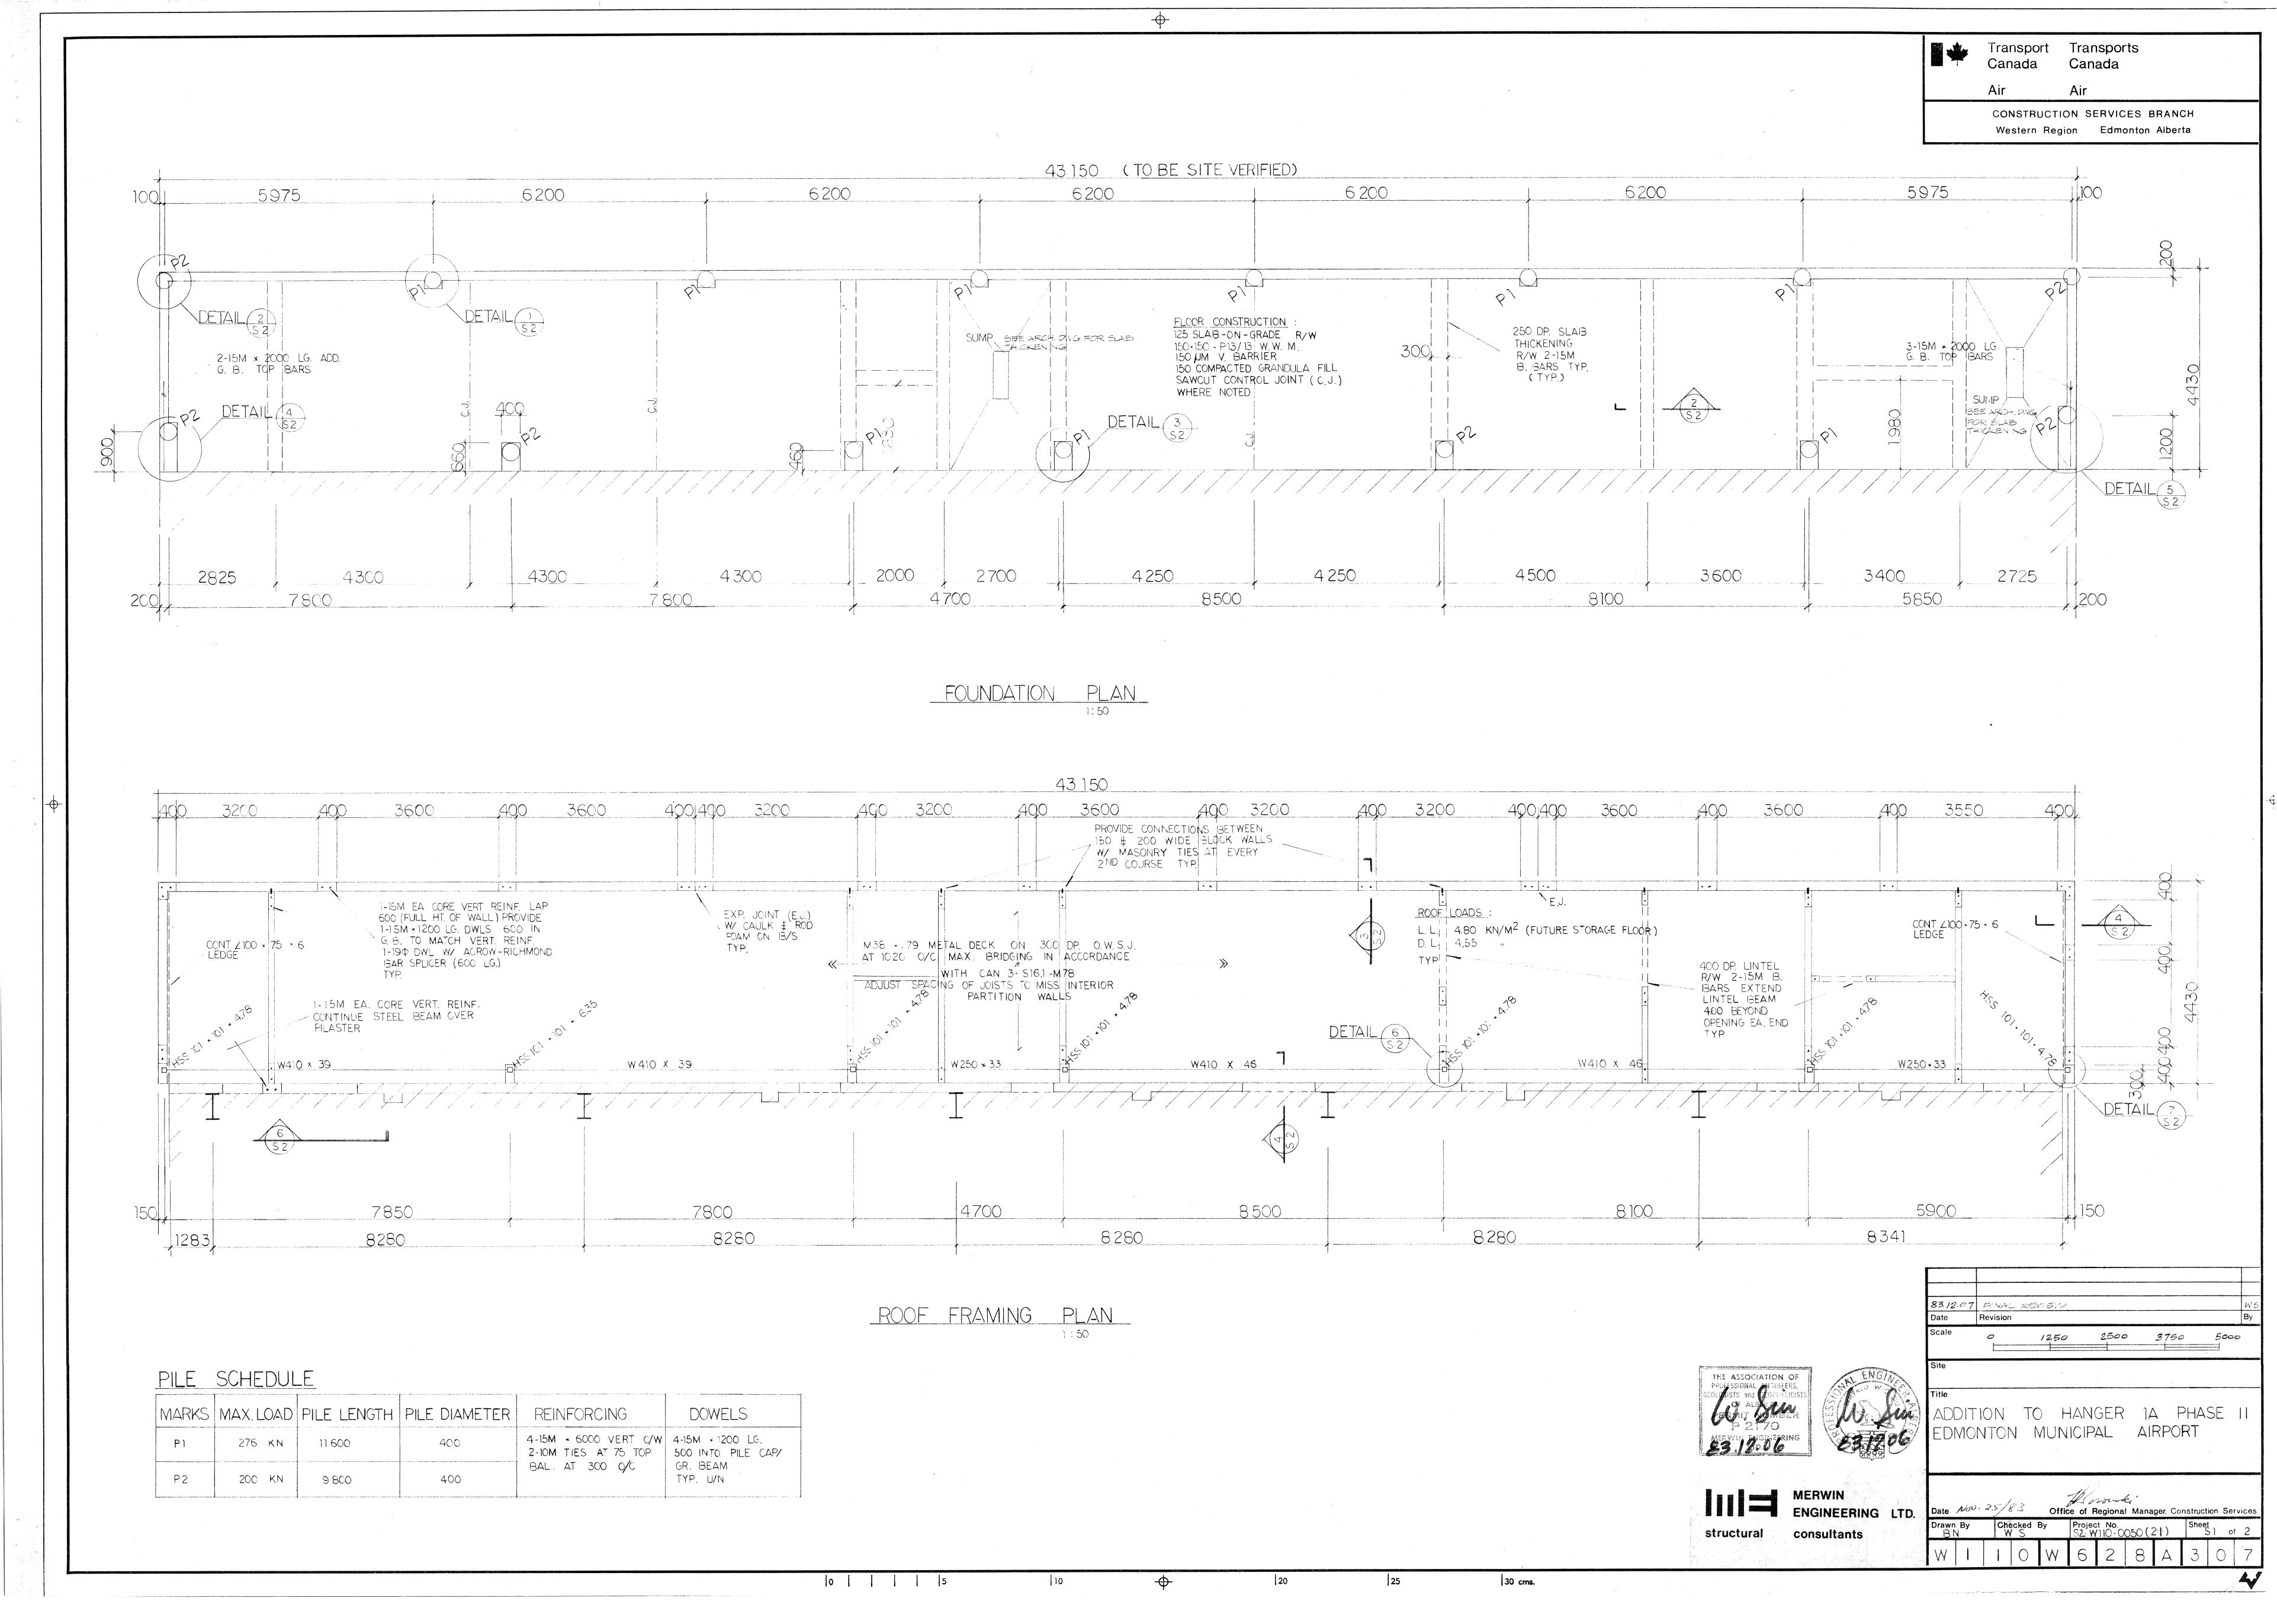

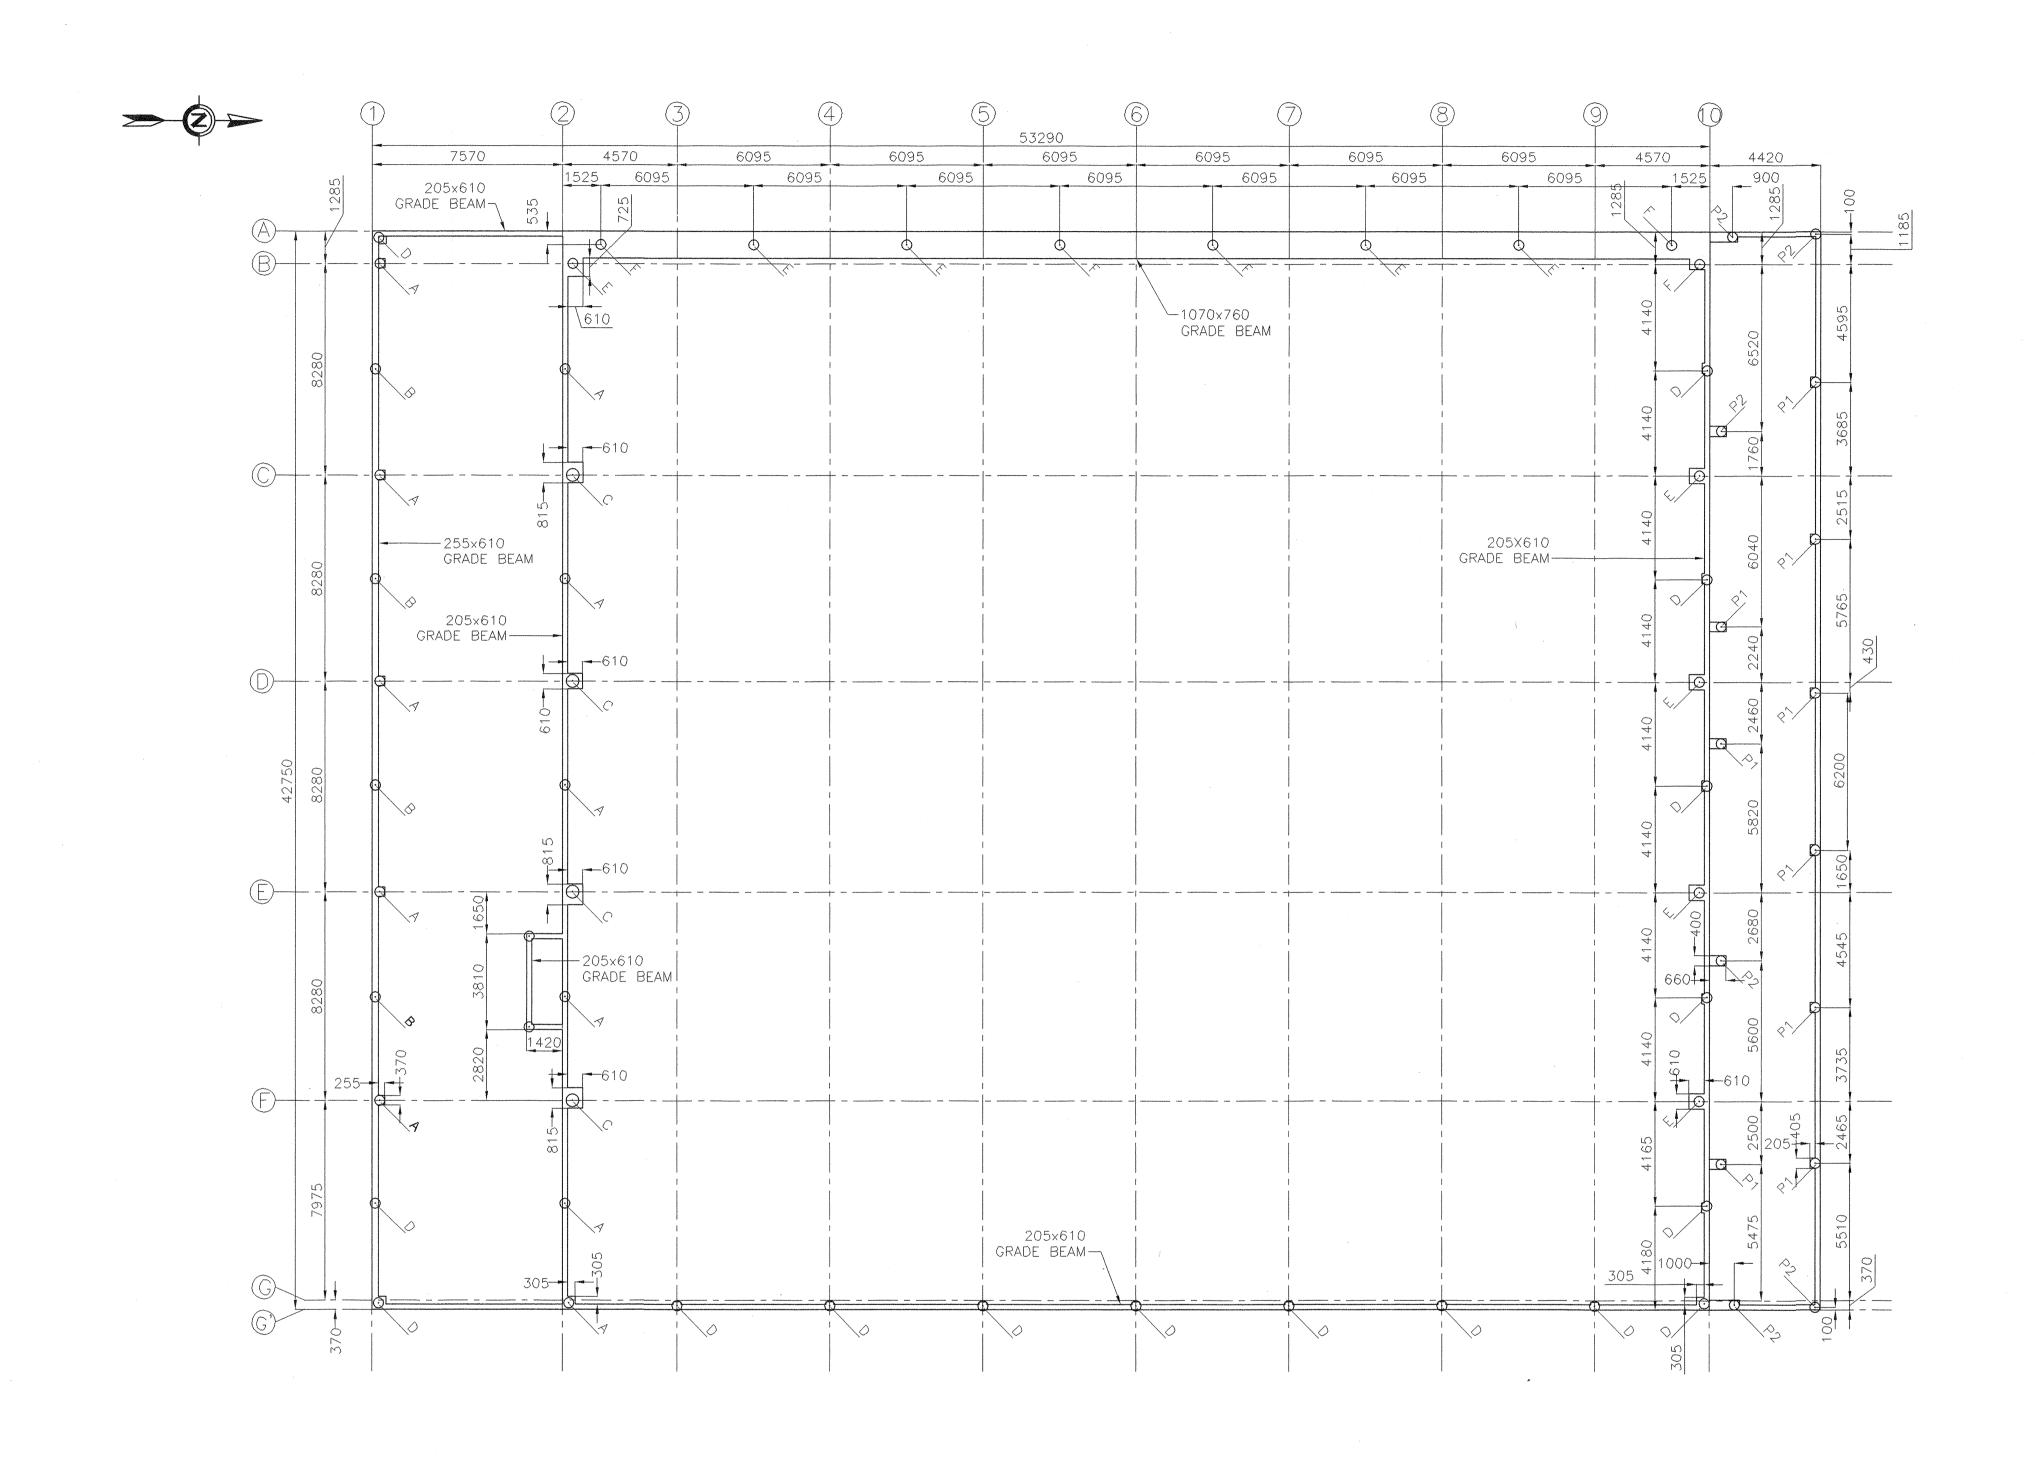

FOUNDATION PLAN SCALE: 1:150

PILE SCHEDILLE

| PILI | E SCHEDULE: | | |
|------|-------------|--------------|-------------|
| [| DESIGNATION | DIAMETER(mm) | LENGTH (mm) |
| | Α | 405 | 8535 |
| | В | 405 | 7010 |
| | С | 510 | 15240 |
| | D | 405 | 5790 |
| | E | 405 | 13410 |
| | F | 405 | 10365 |
| | P1 | 400 | 11600 |
| | P2 | 400 | 9800 |

NOTES: 1. THIS DRAWING REFLECTS THE BEST INFORMATION AVAILABLE GATHERED FROM CONSTRUCTION DRAWINGS AND VISUAL REVIEWS PERFORMED BY TICA CONSULTING.

2. INFORMATION ON THIS DRAWING WAS NOT VISIBLE AND THIS WAS NOT CONFIRMED ON SITE.

Public Works and Travaux publics et Services gouvernementaux Canada

REAL PROPERTY SERVICES
Western Region

TRANSPORTATION CANADA

AS-BUILT 04/03/26 DESCRIPTION A detail number

number du detail B source drawing no.

de dessin no. C detail on drawing no. detail sur dessin no.

PUBLIC WORKS AND GOVERNMENT **SERVICES CANADA**


HANGER 5


FOUNDATION PLAN


concu par dessine par A. BLEZY approved by approuve par T. CARTMELL Administrateur de Projets TPSGC M. DUMITRESCU AS SHOWN 412331


MARCH 26, 2004


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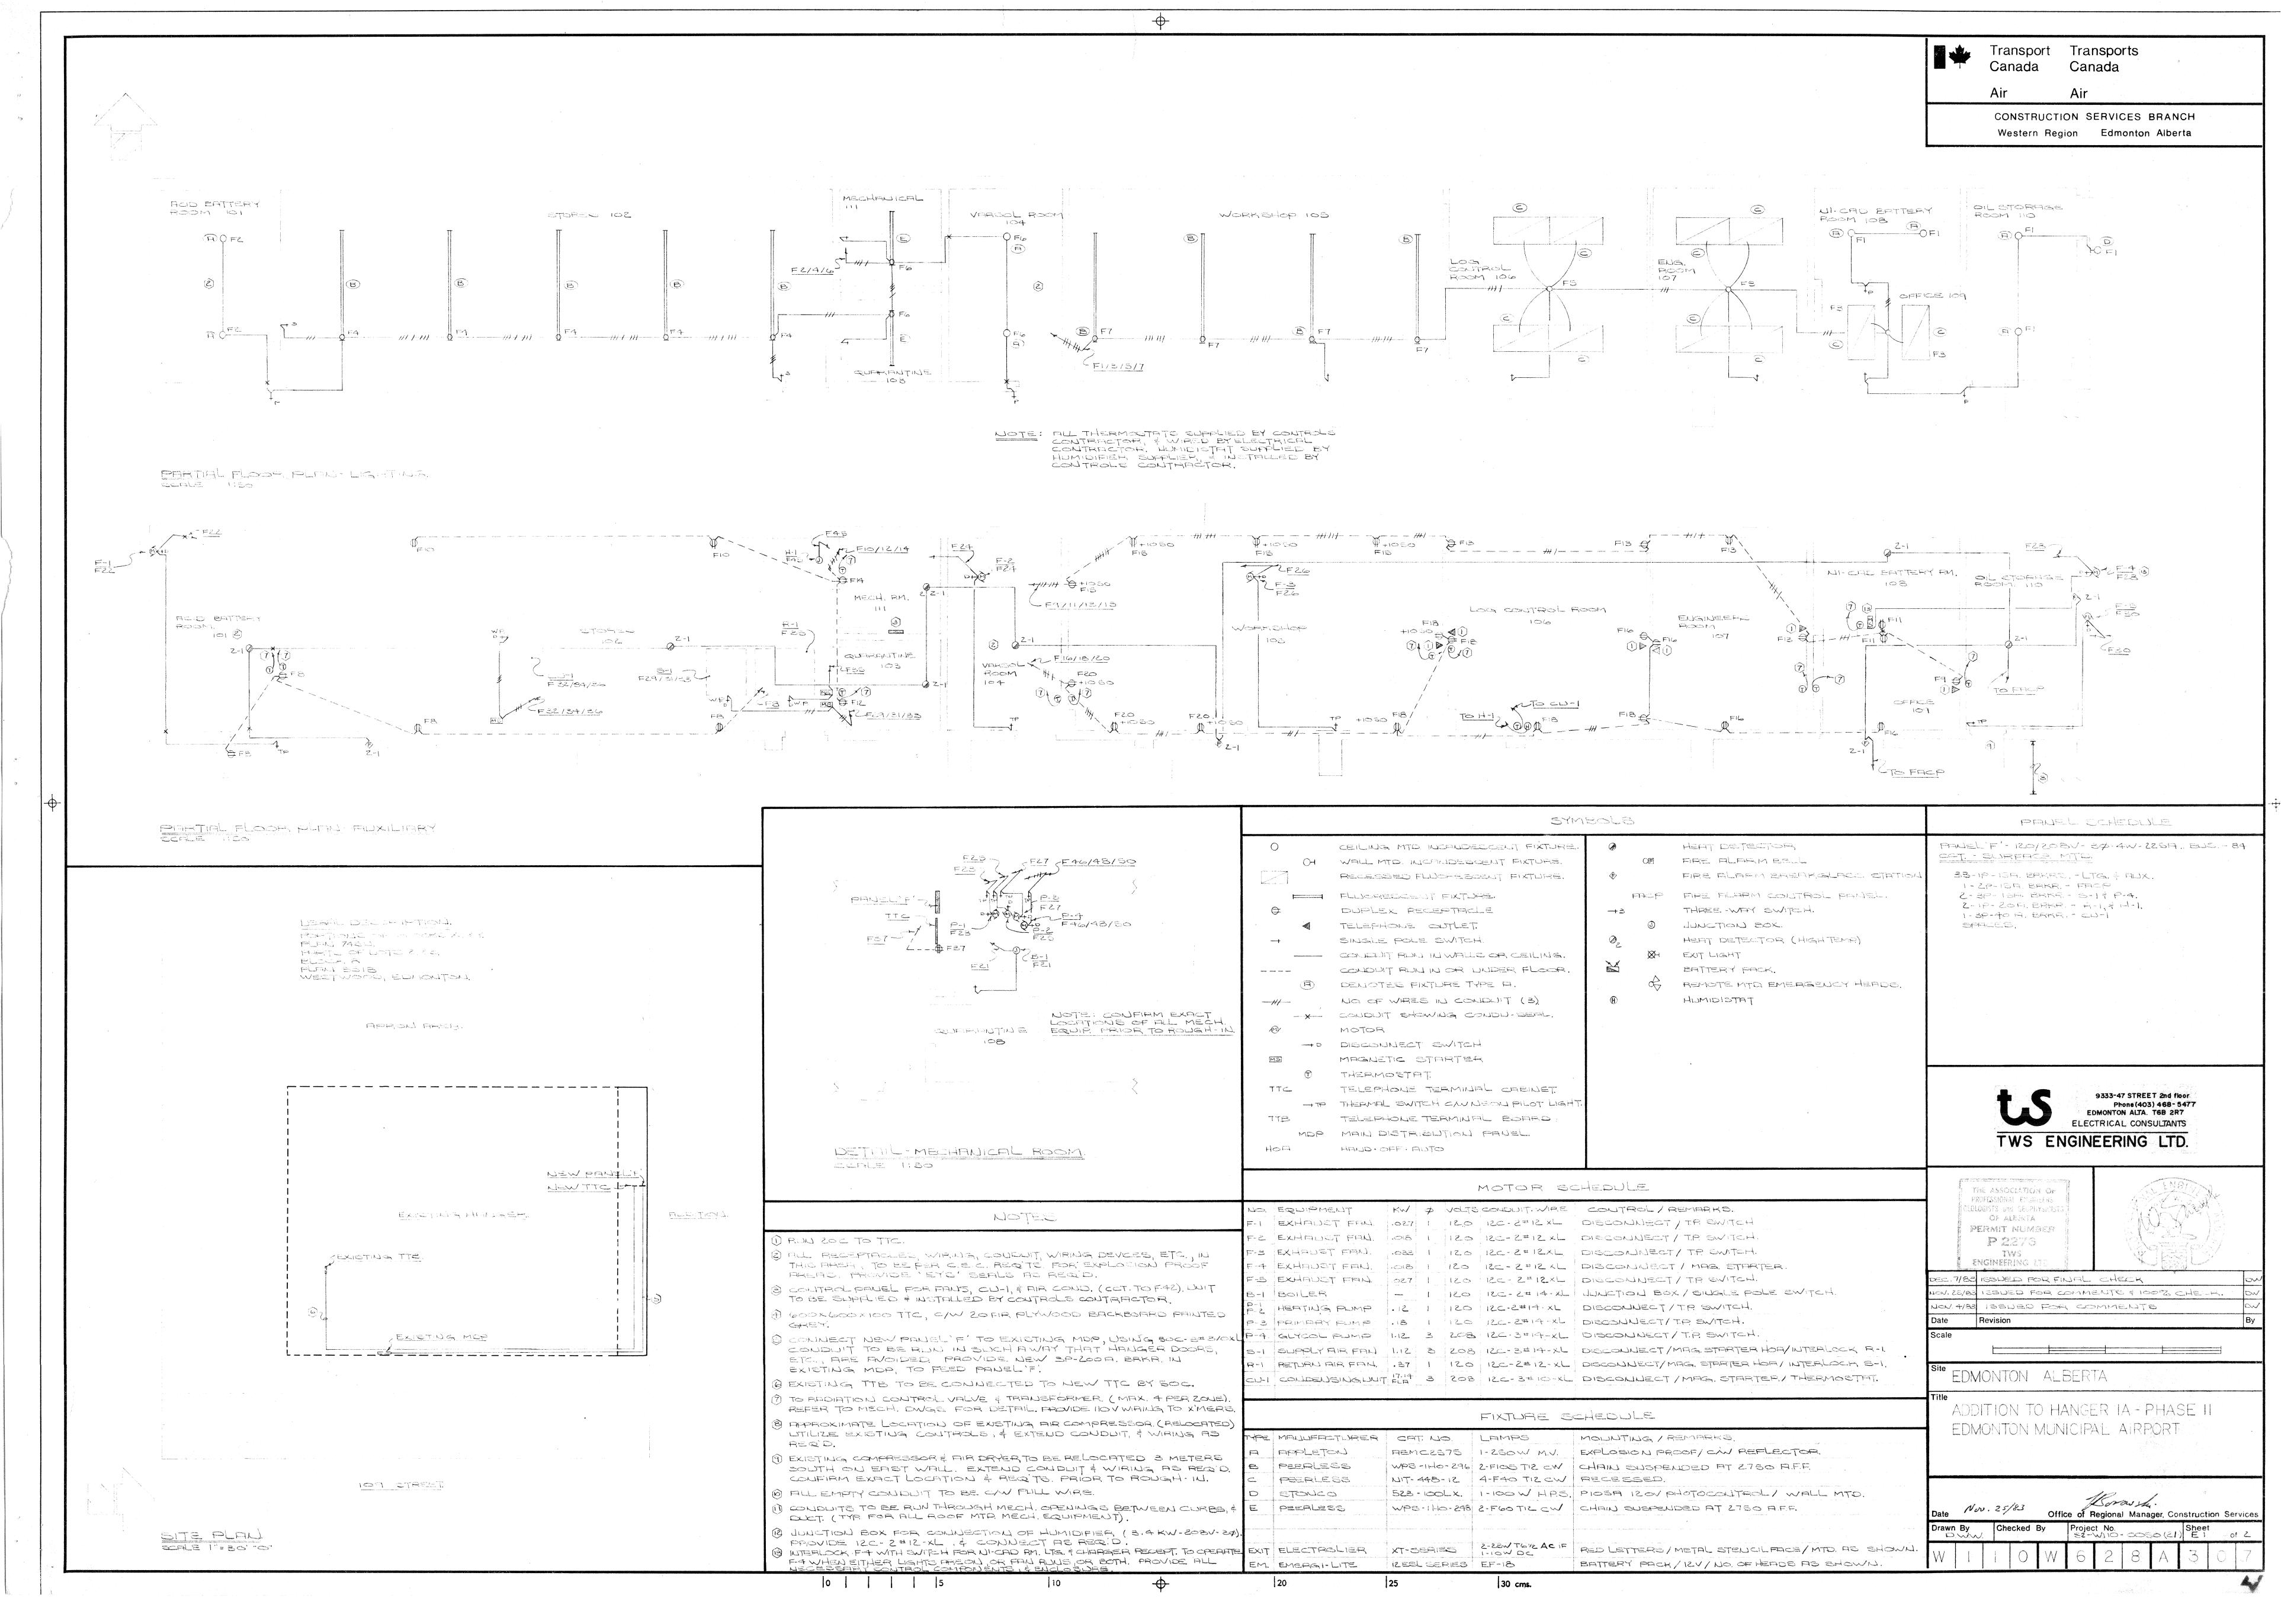


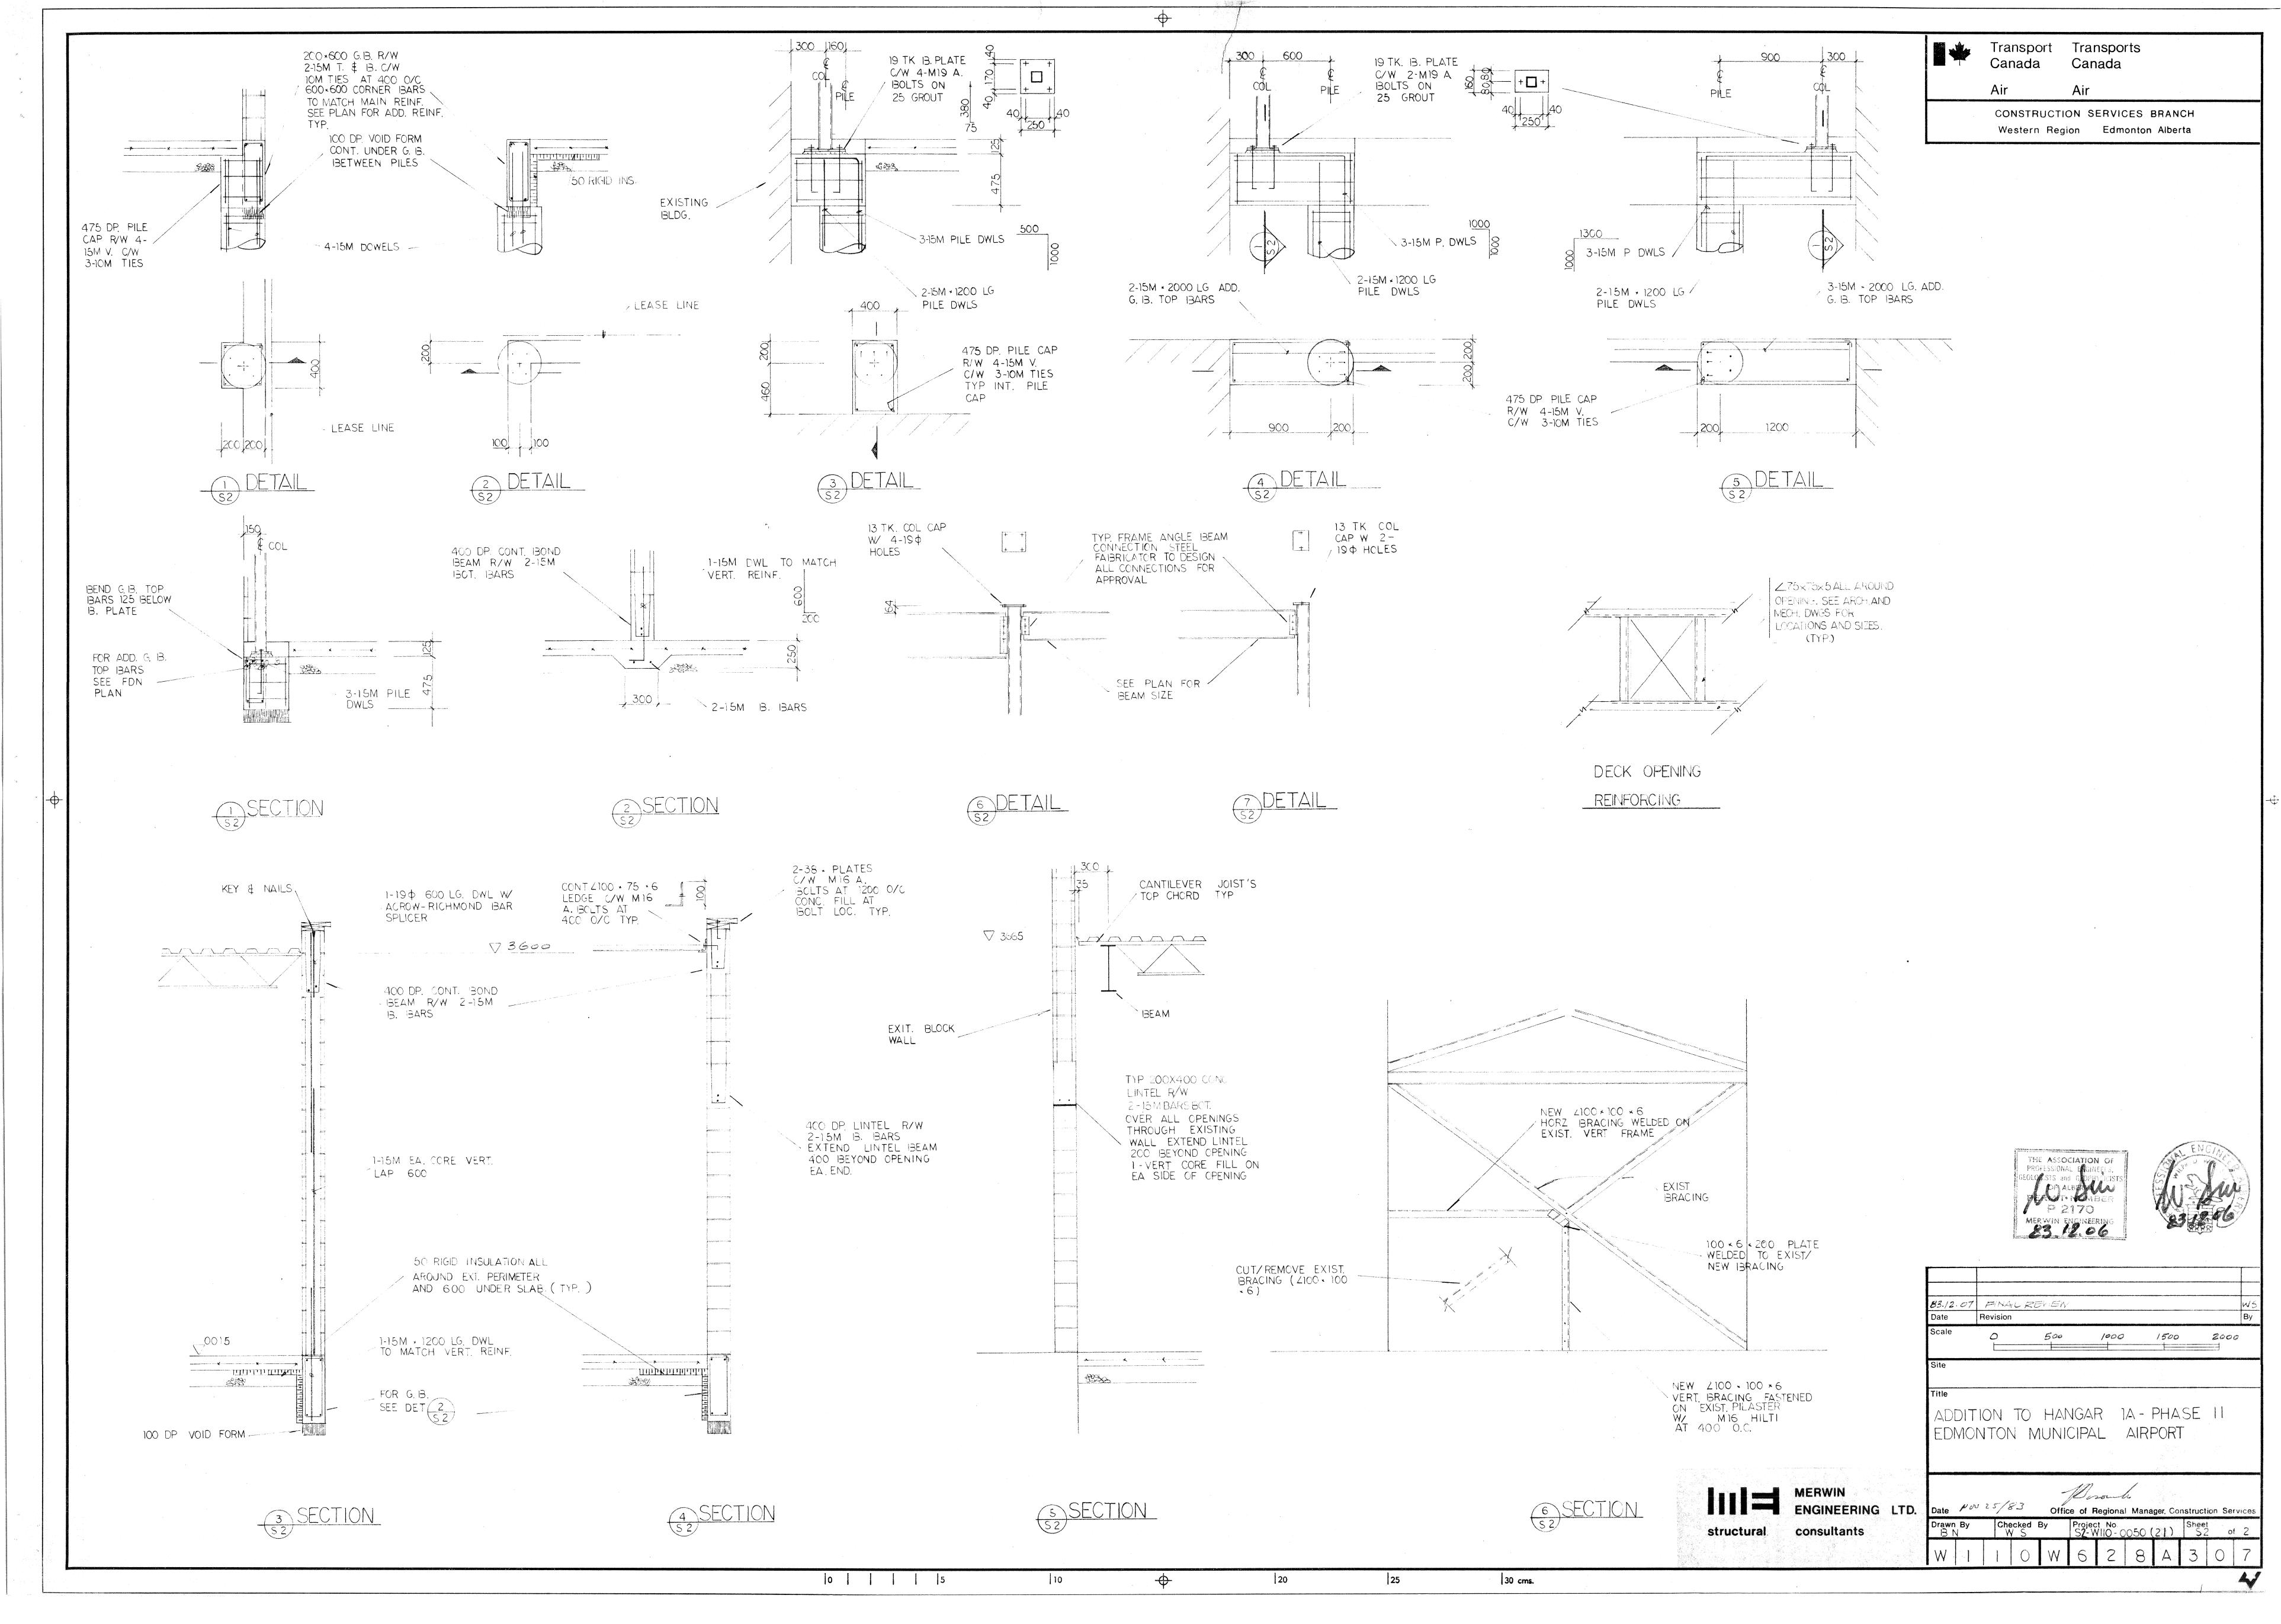


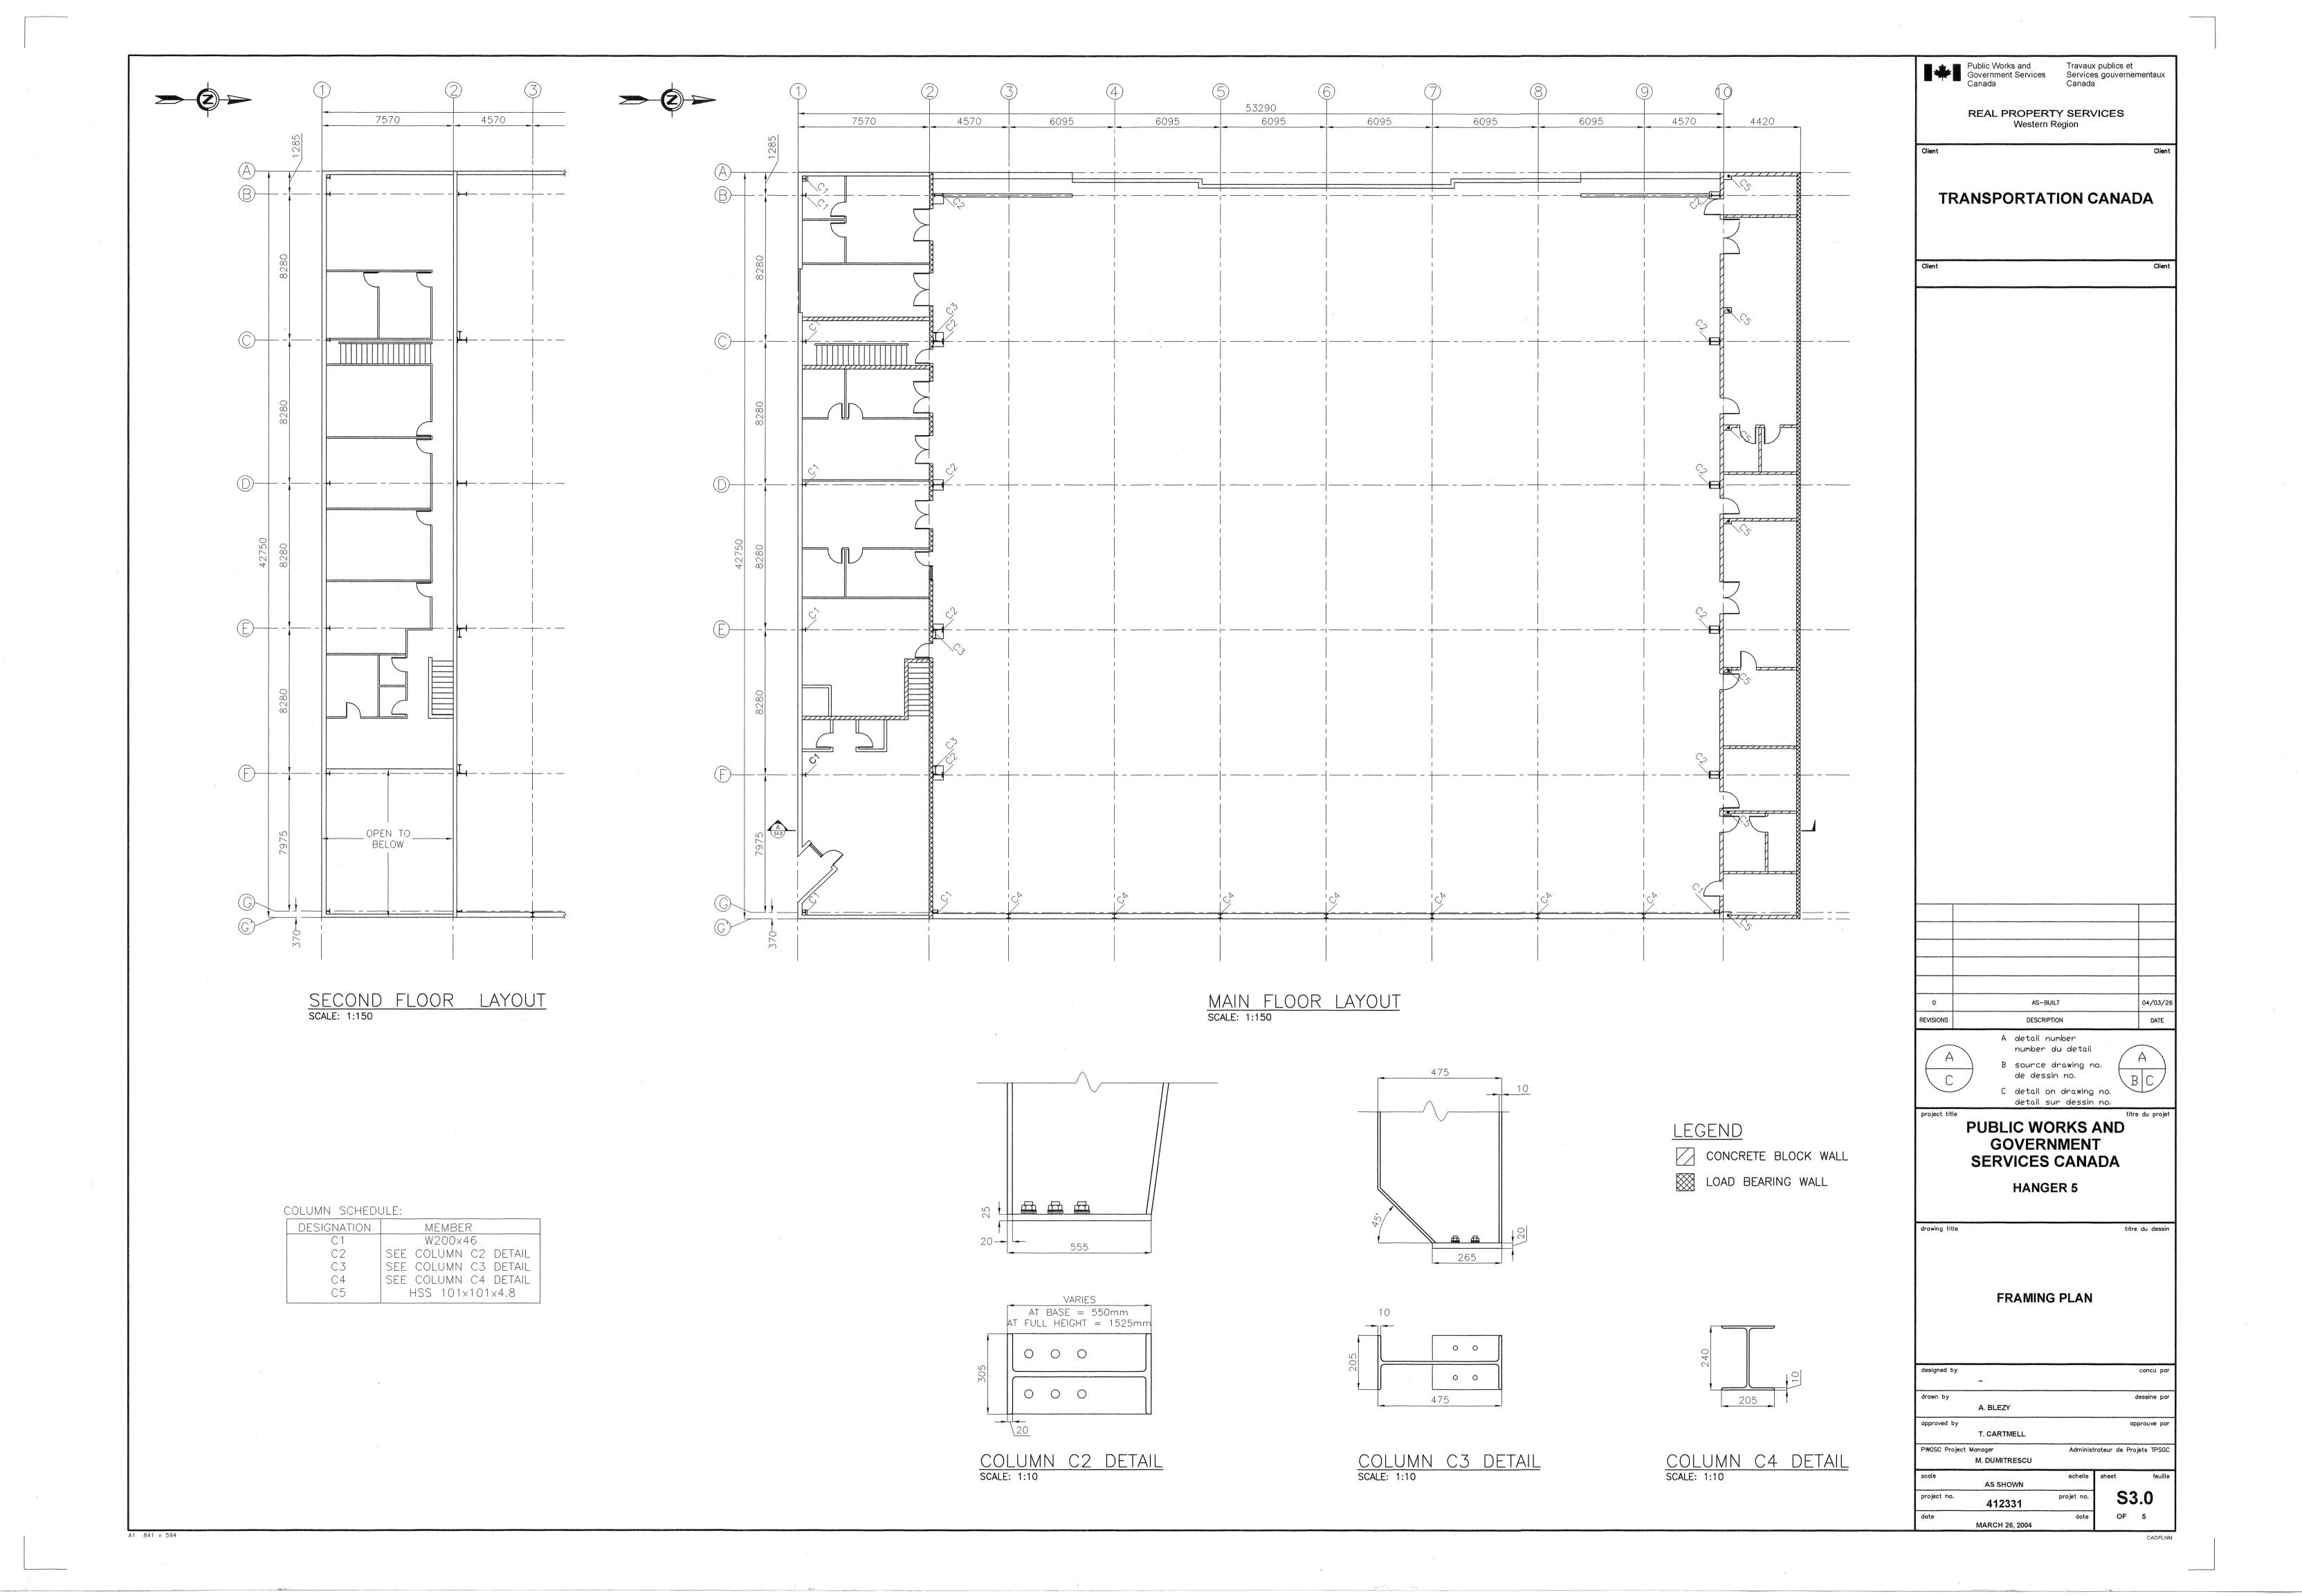


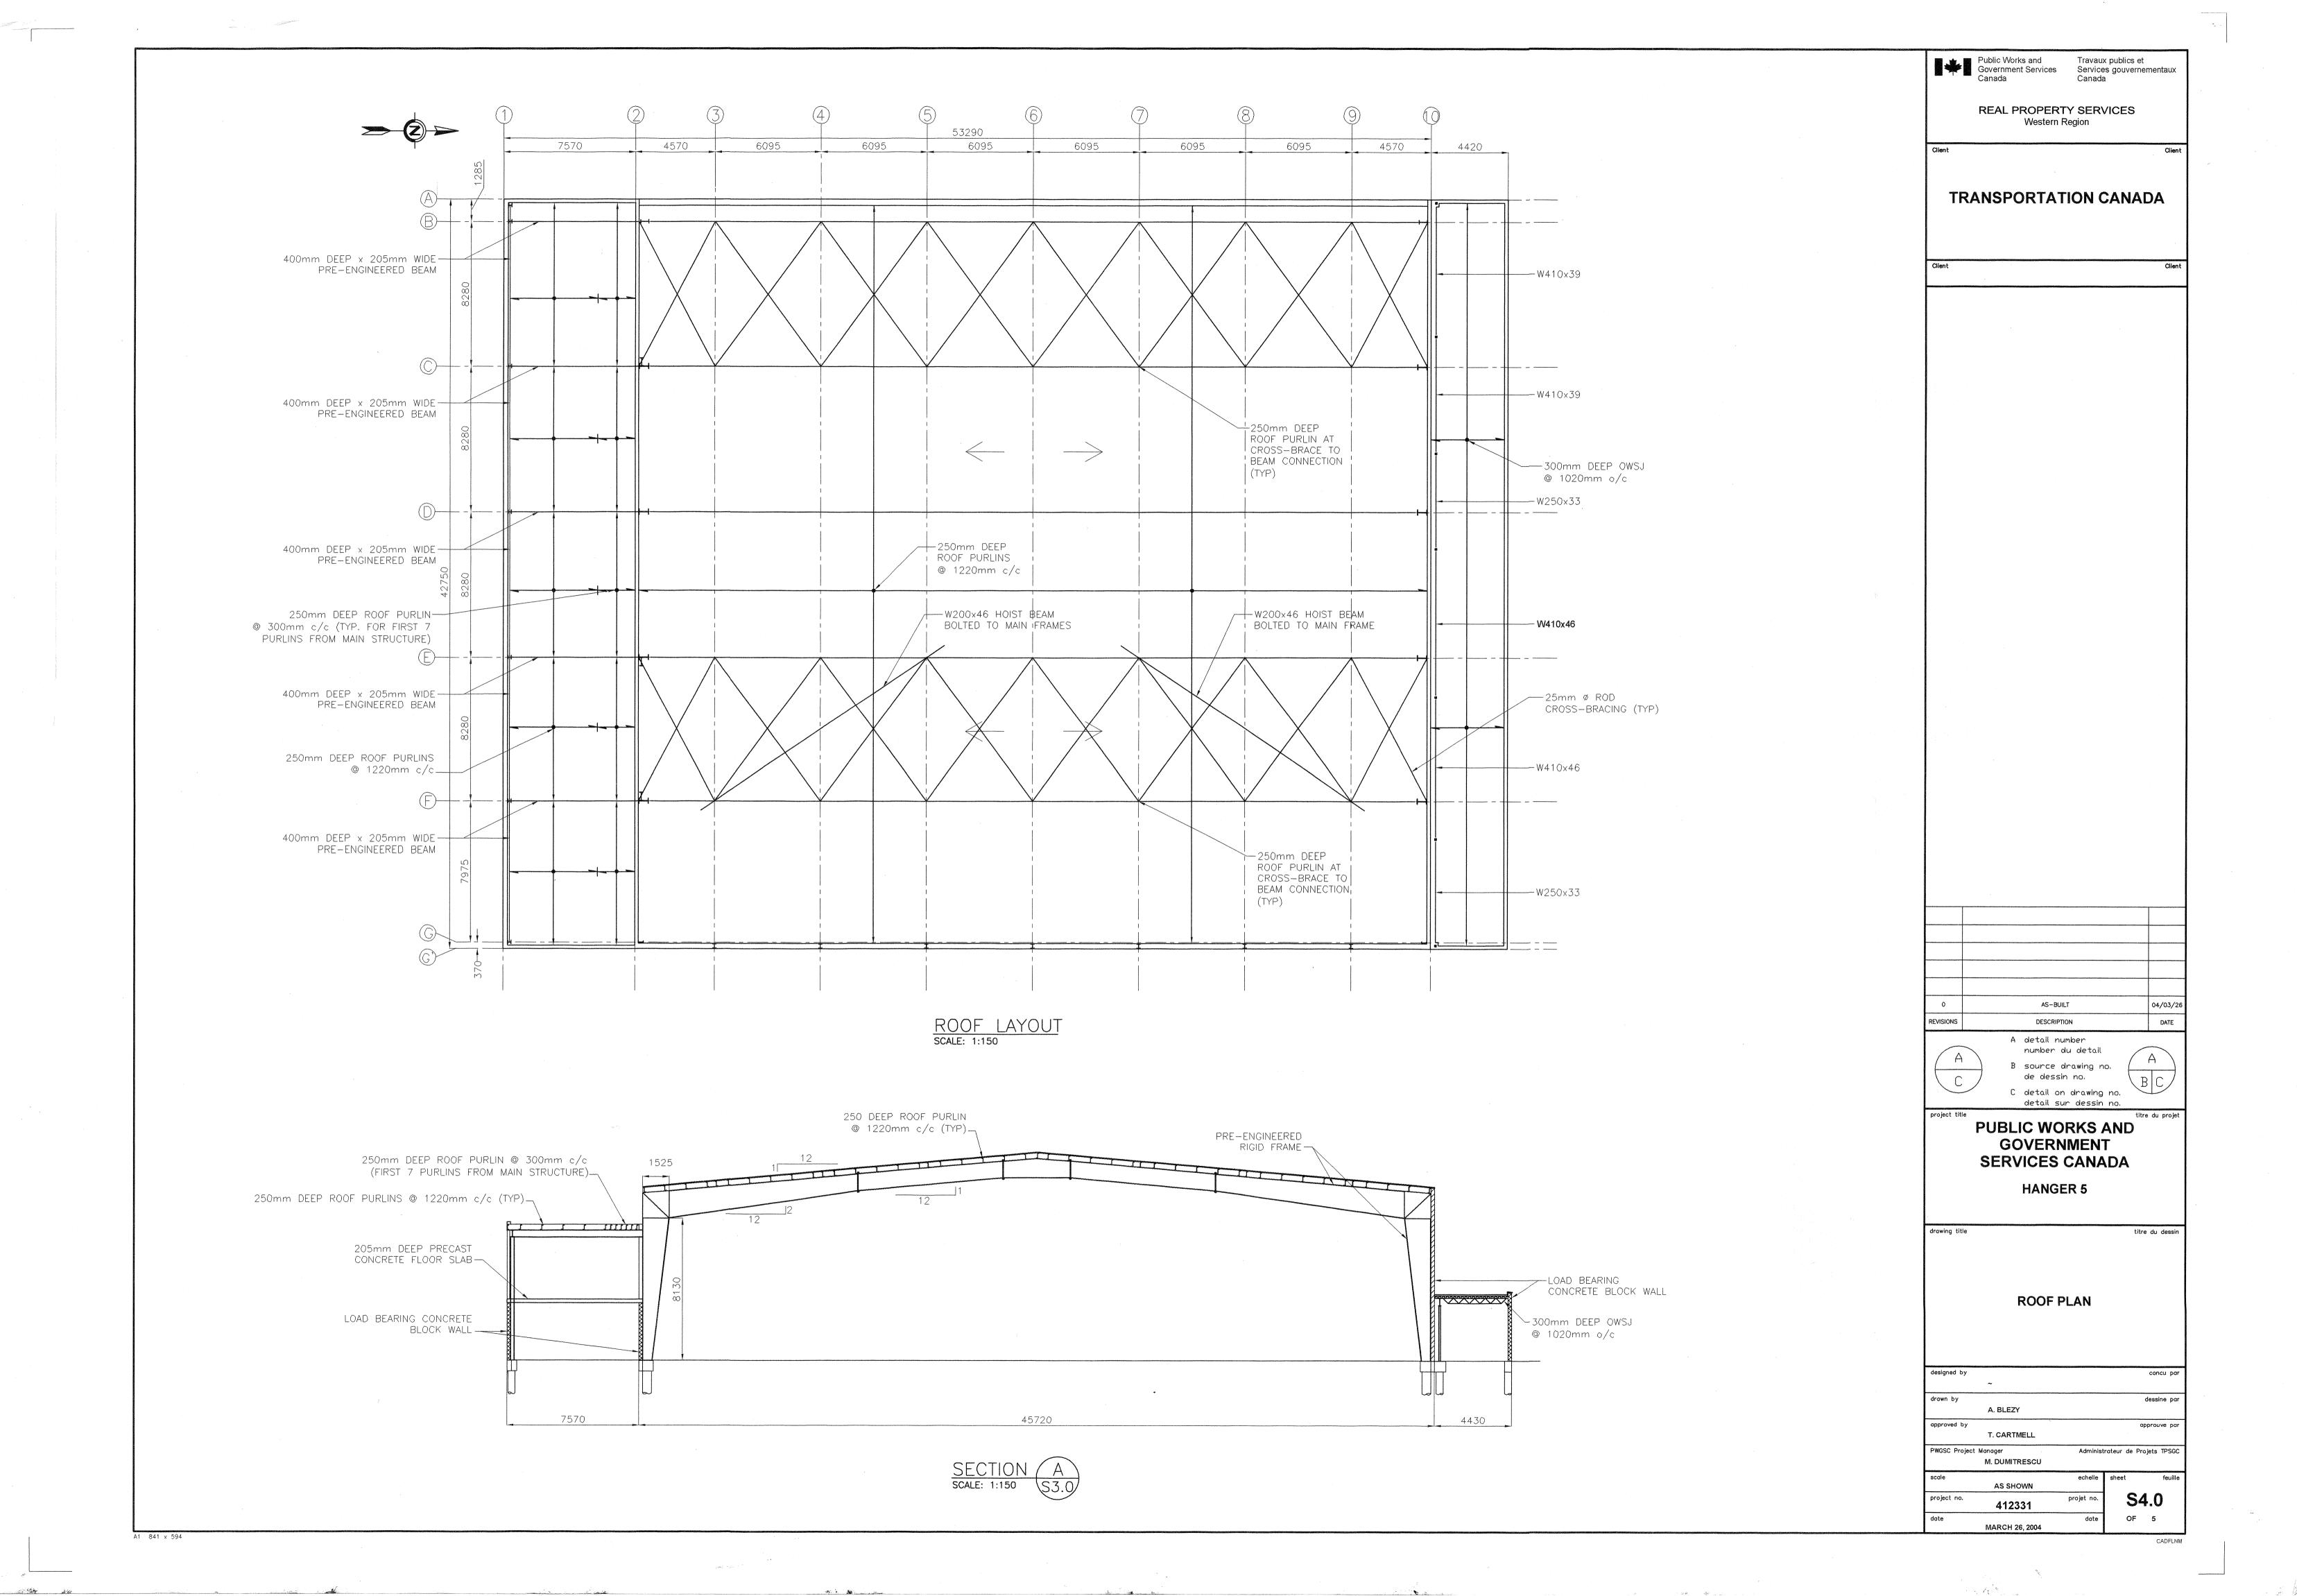


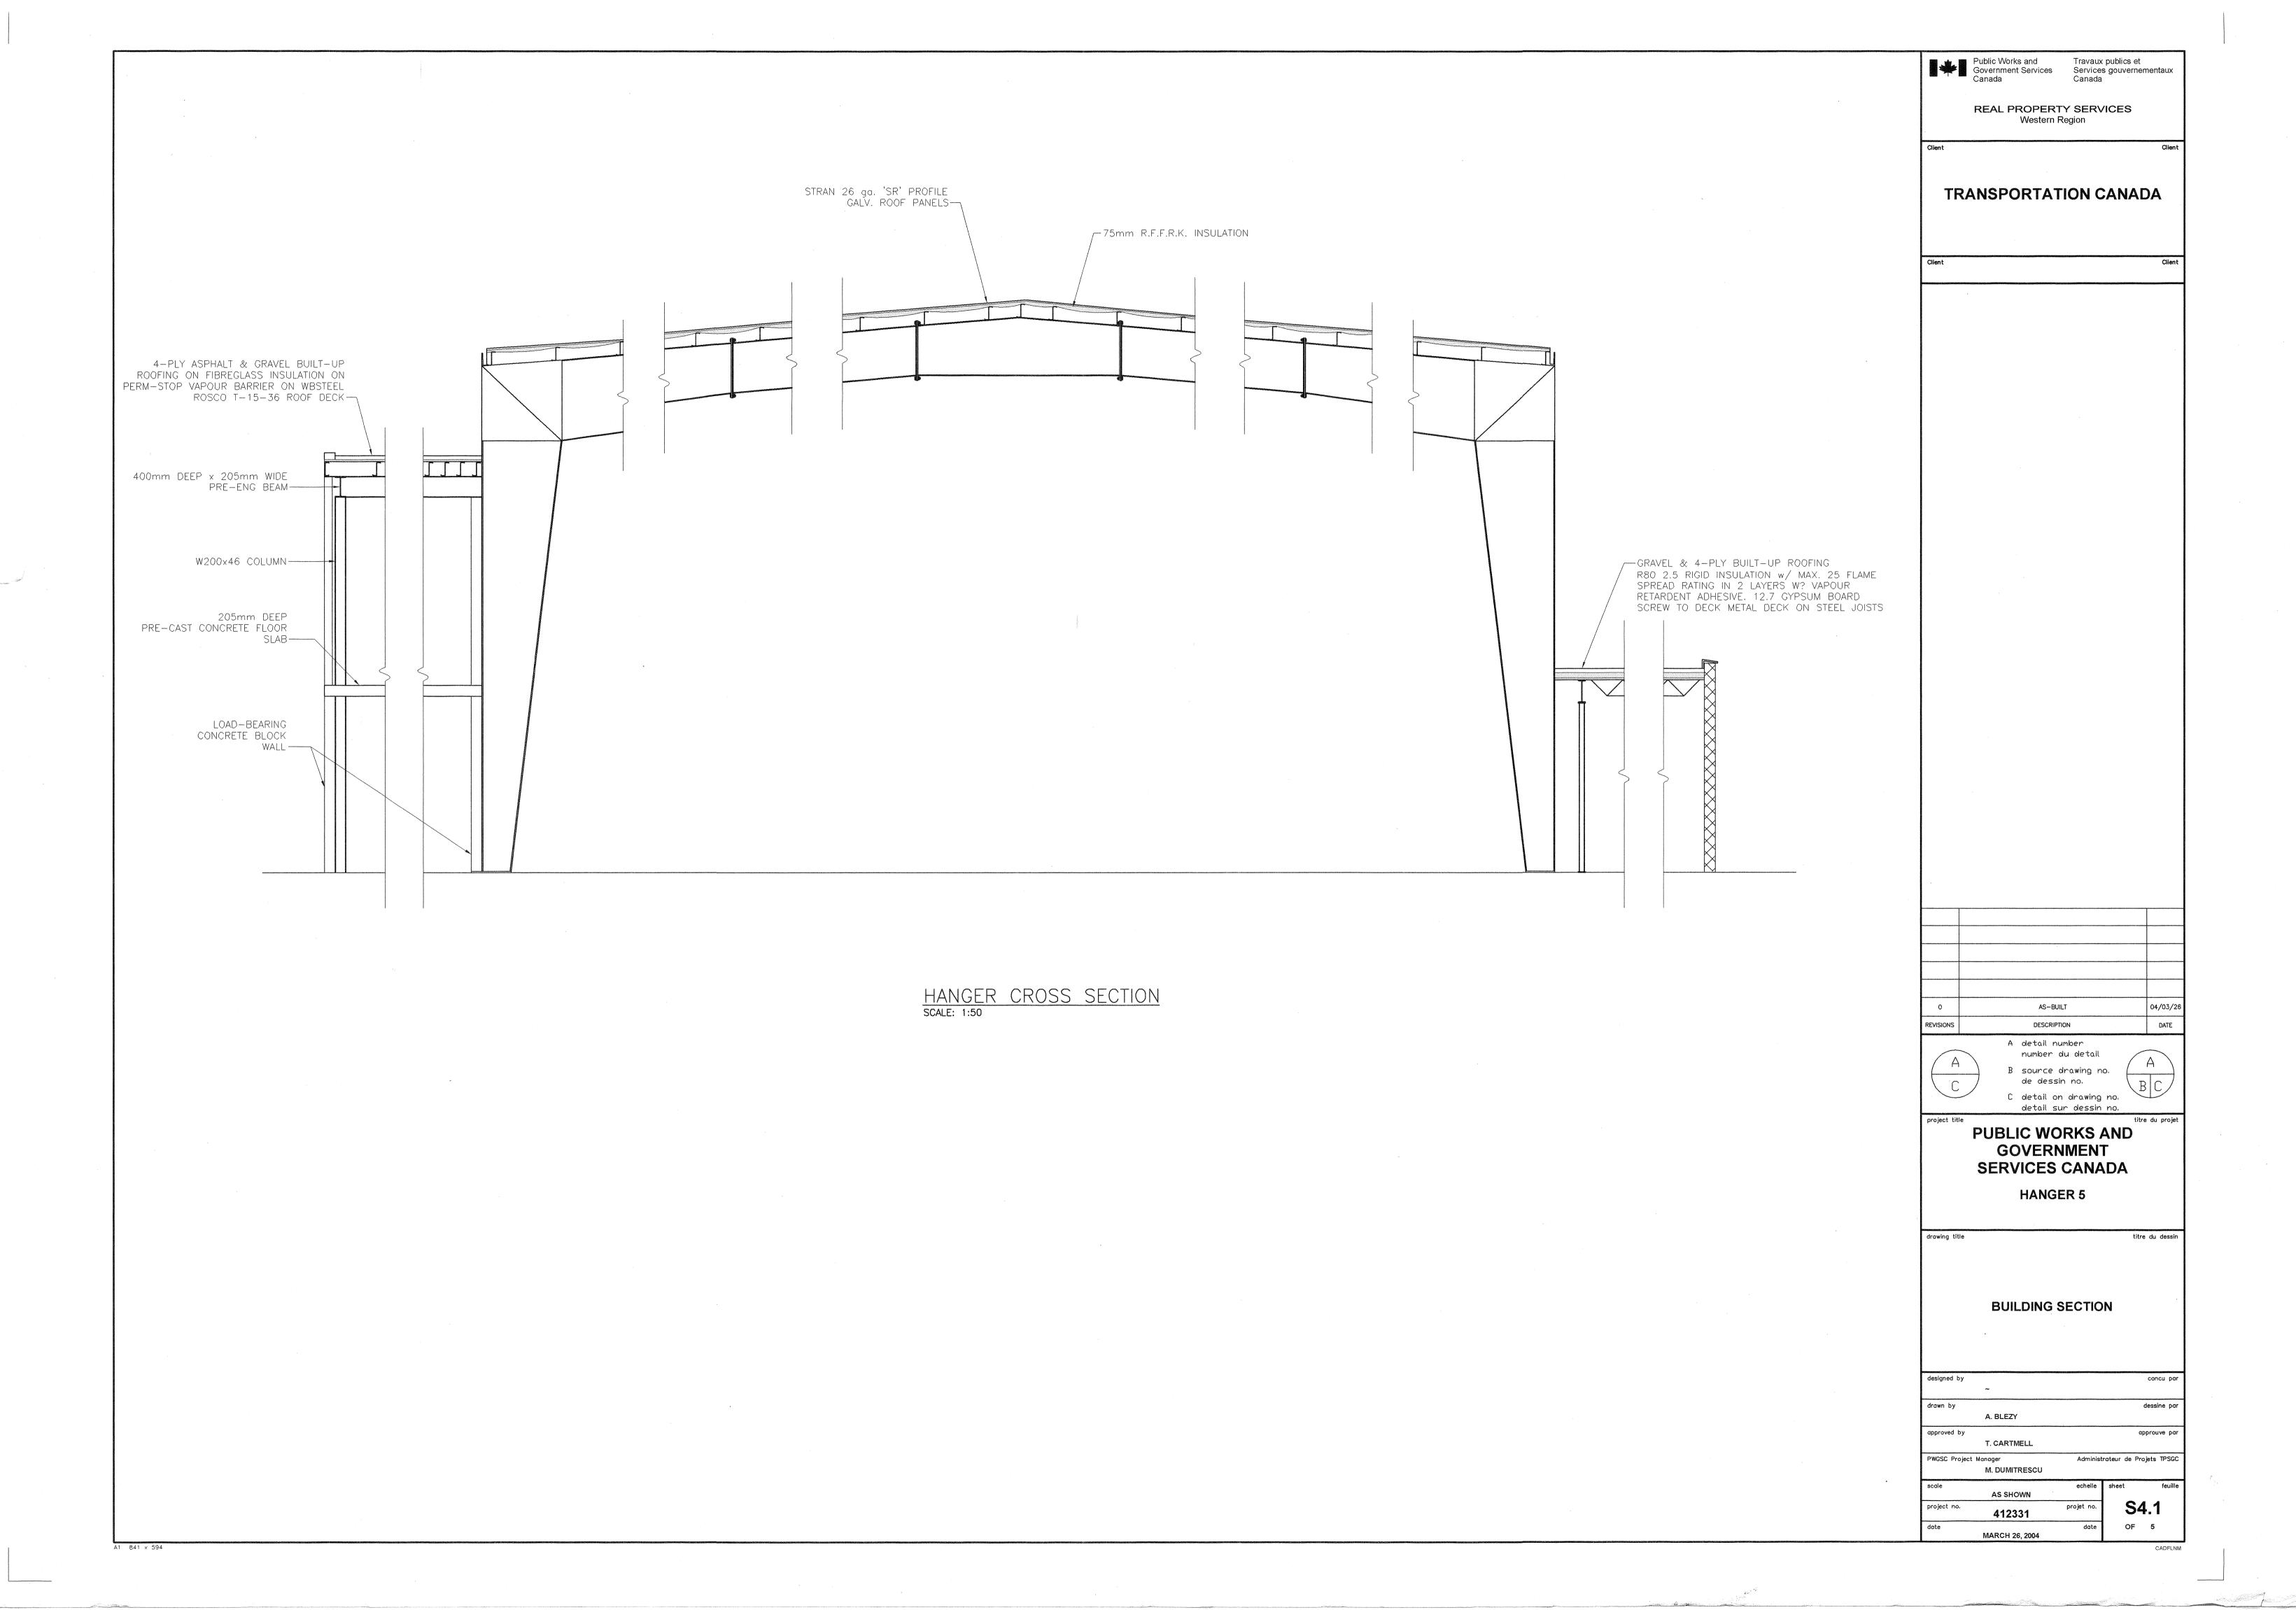


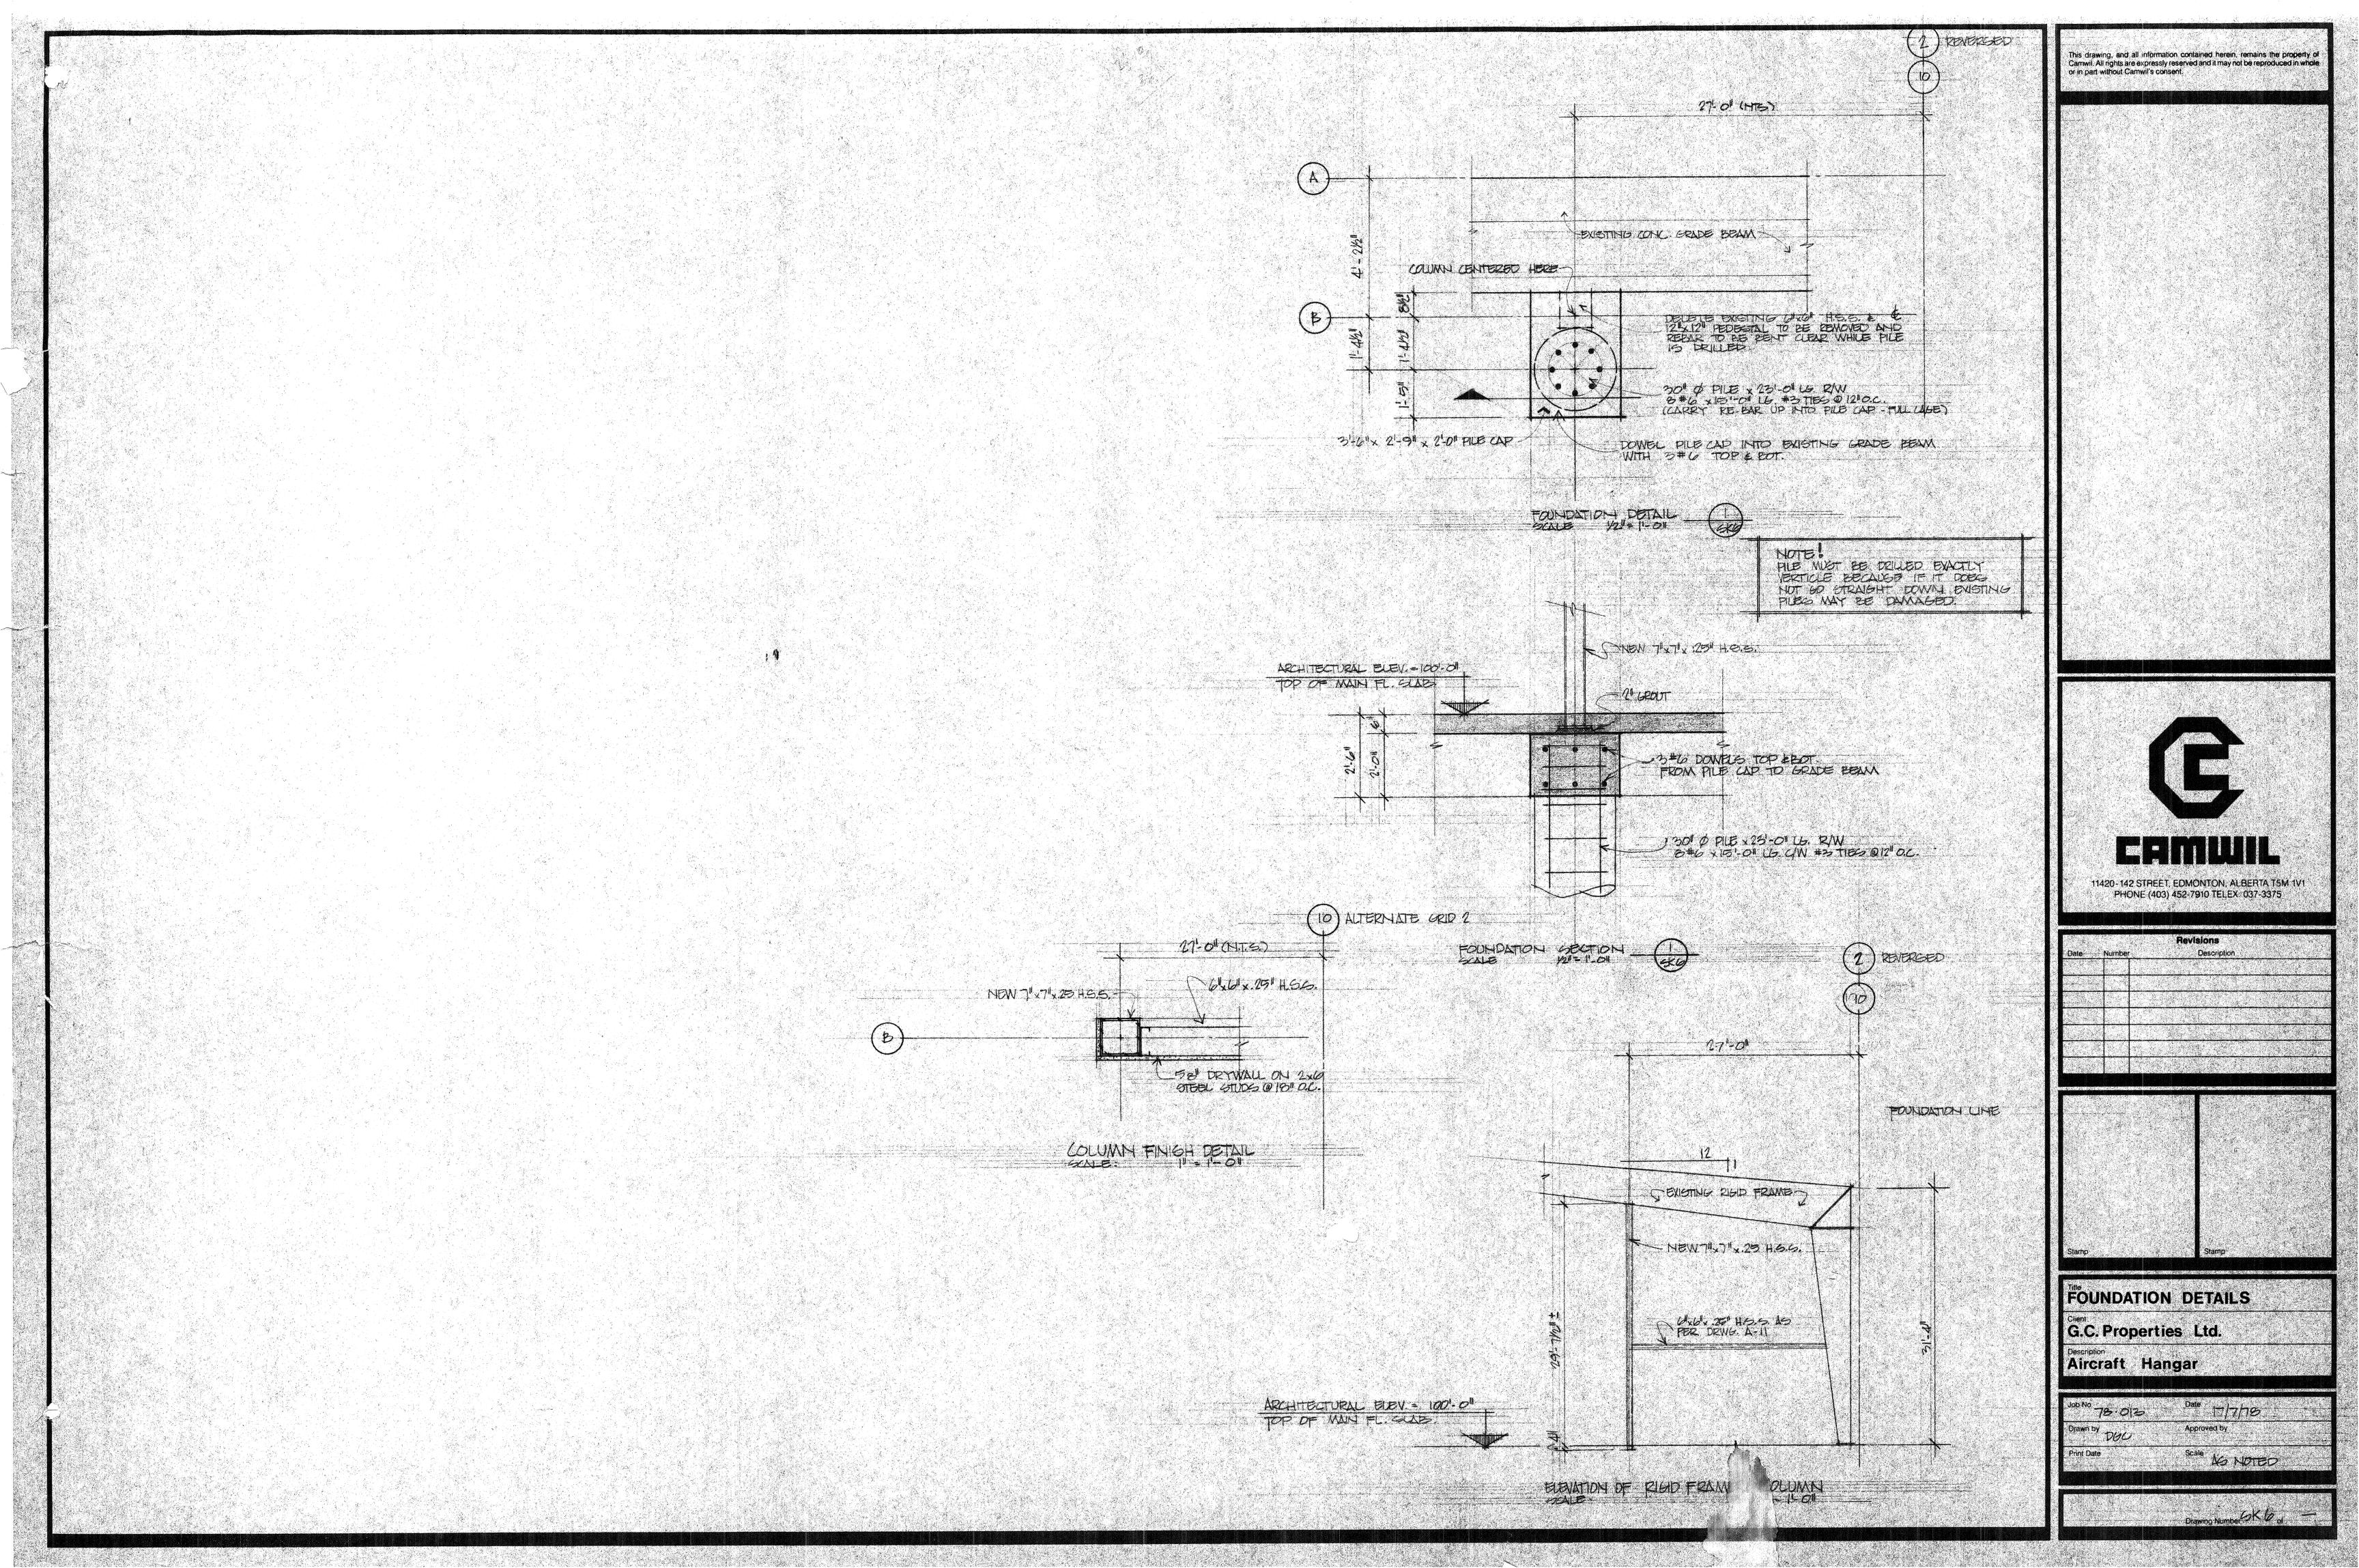

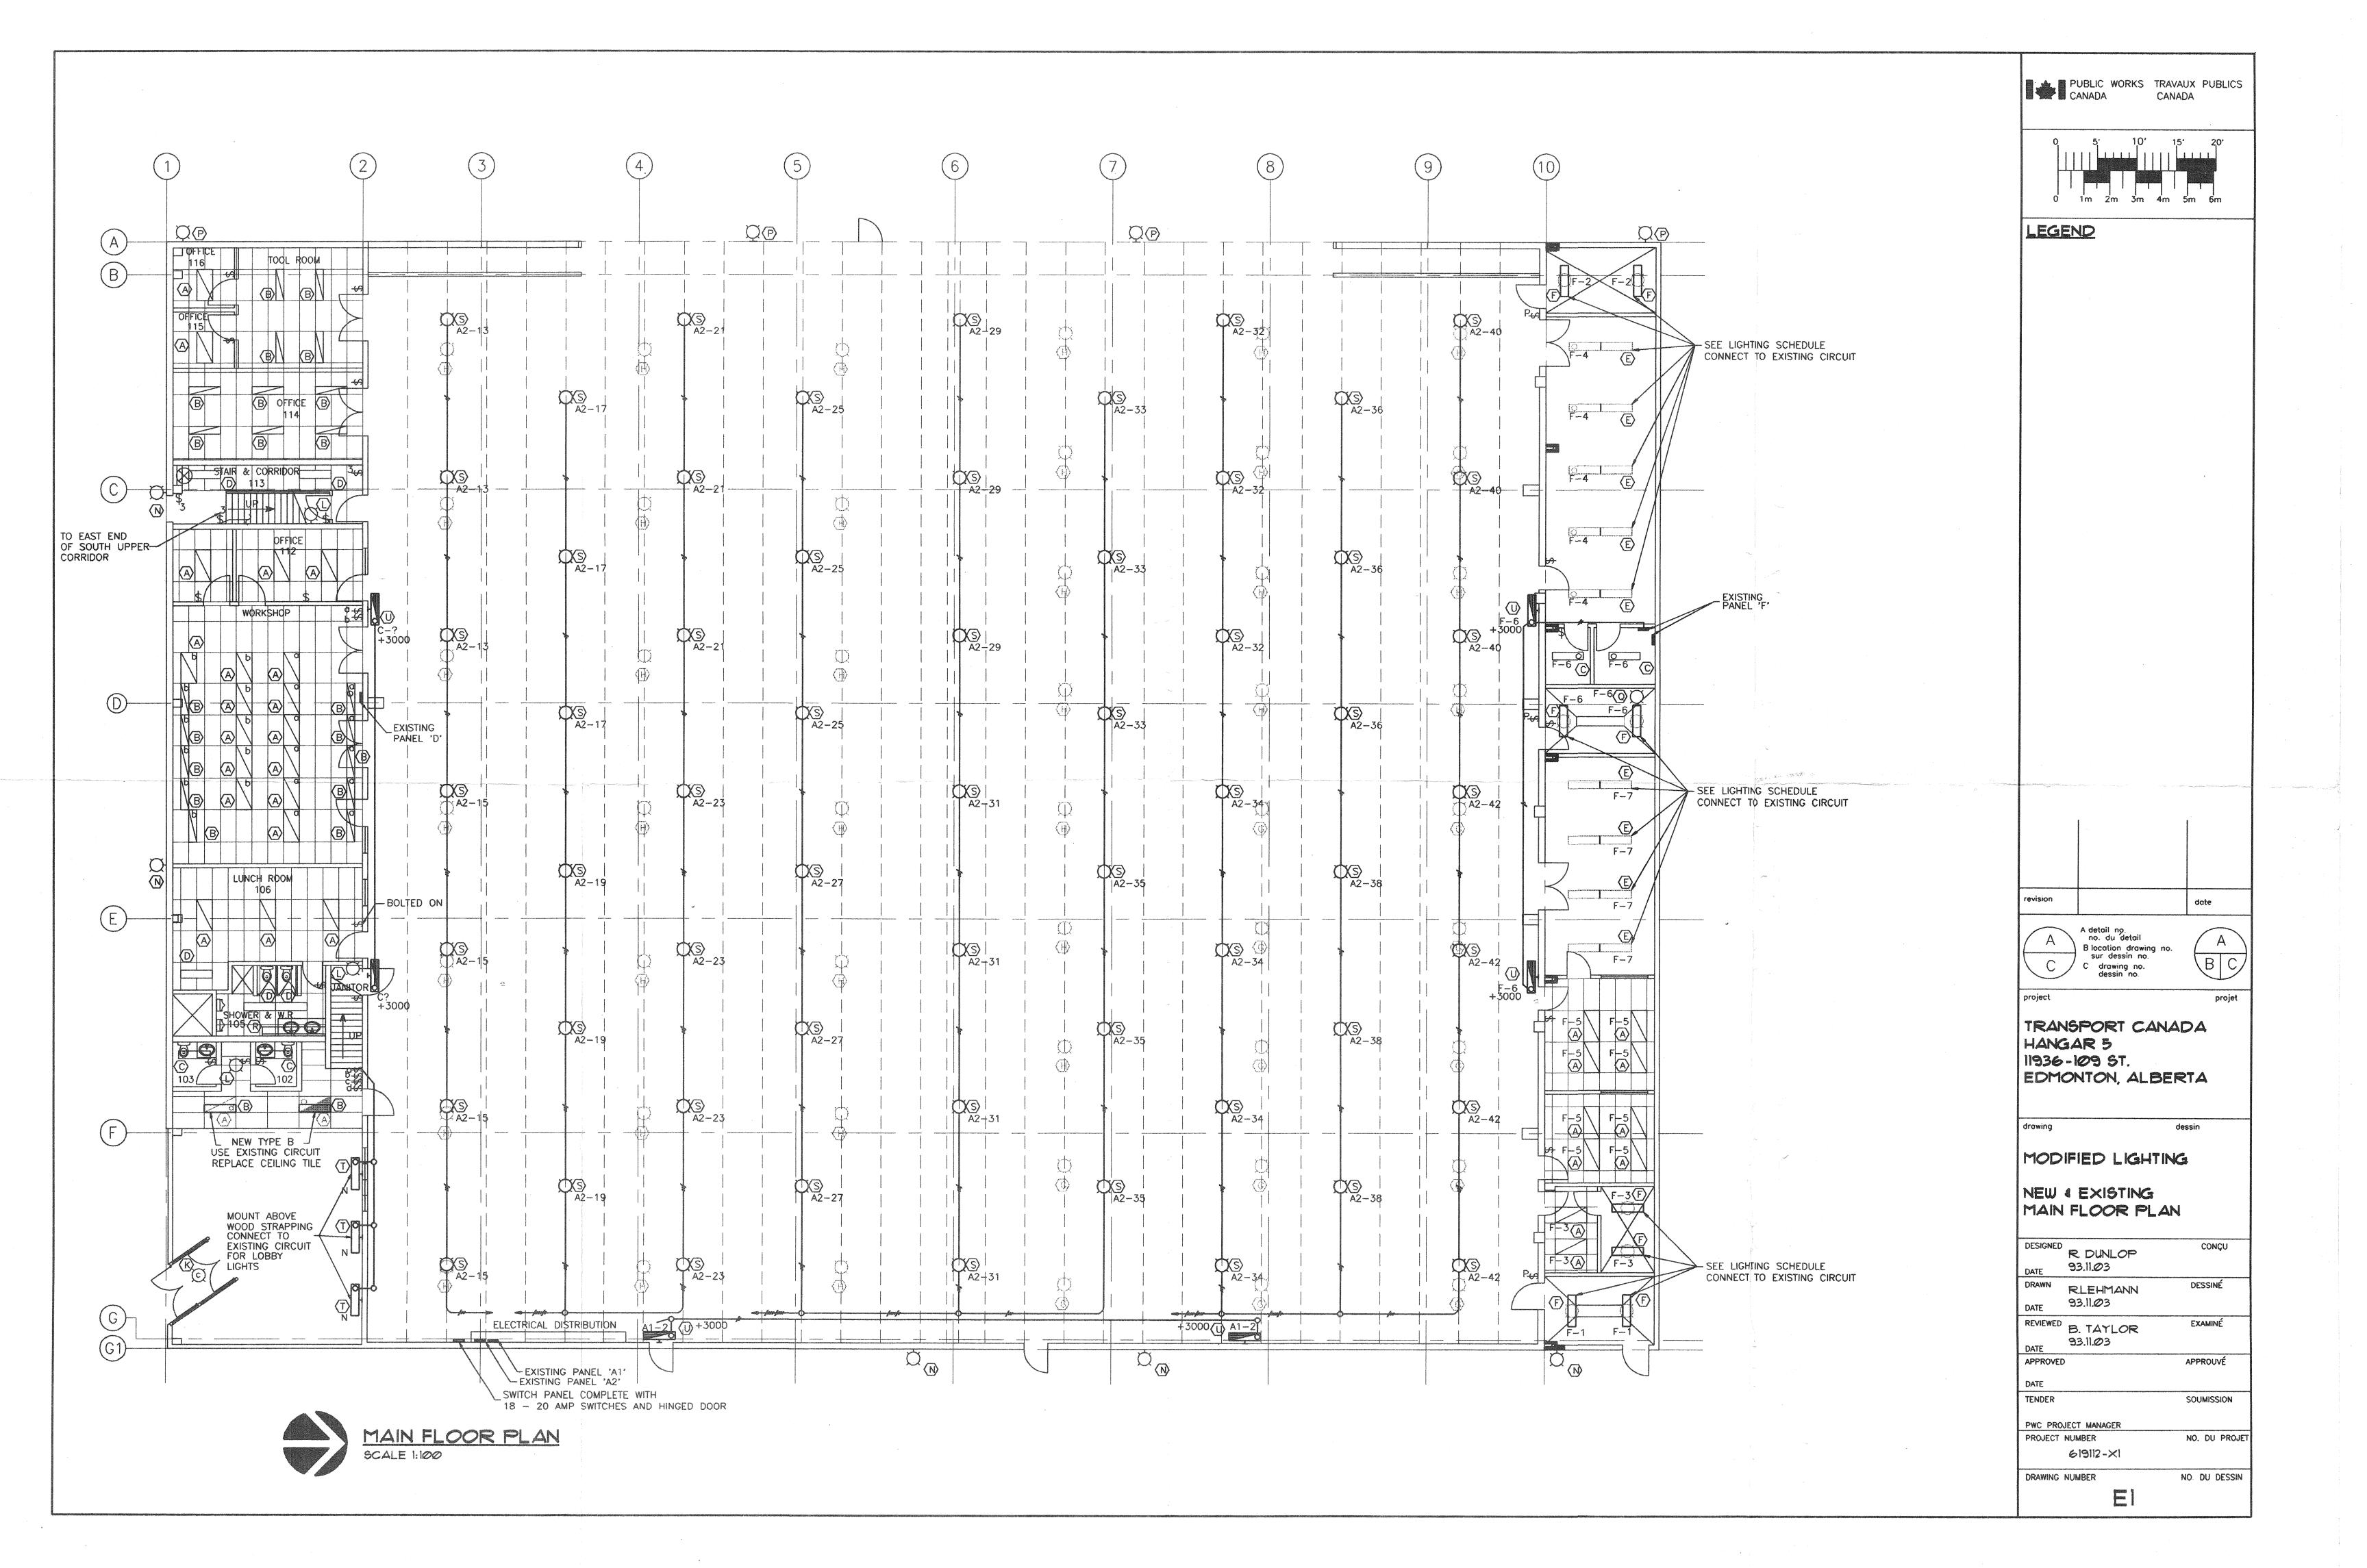


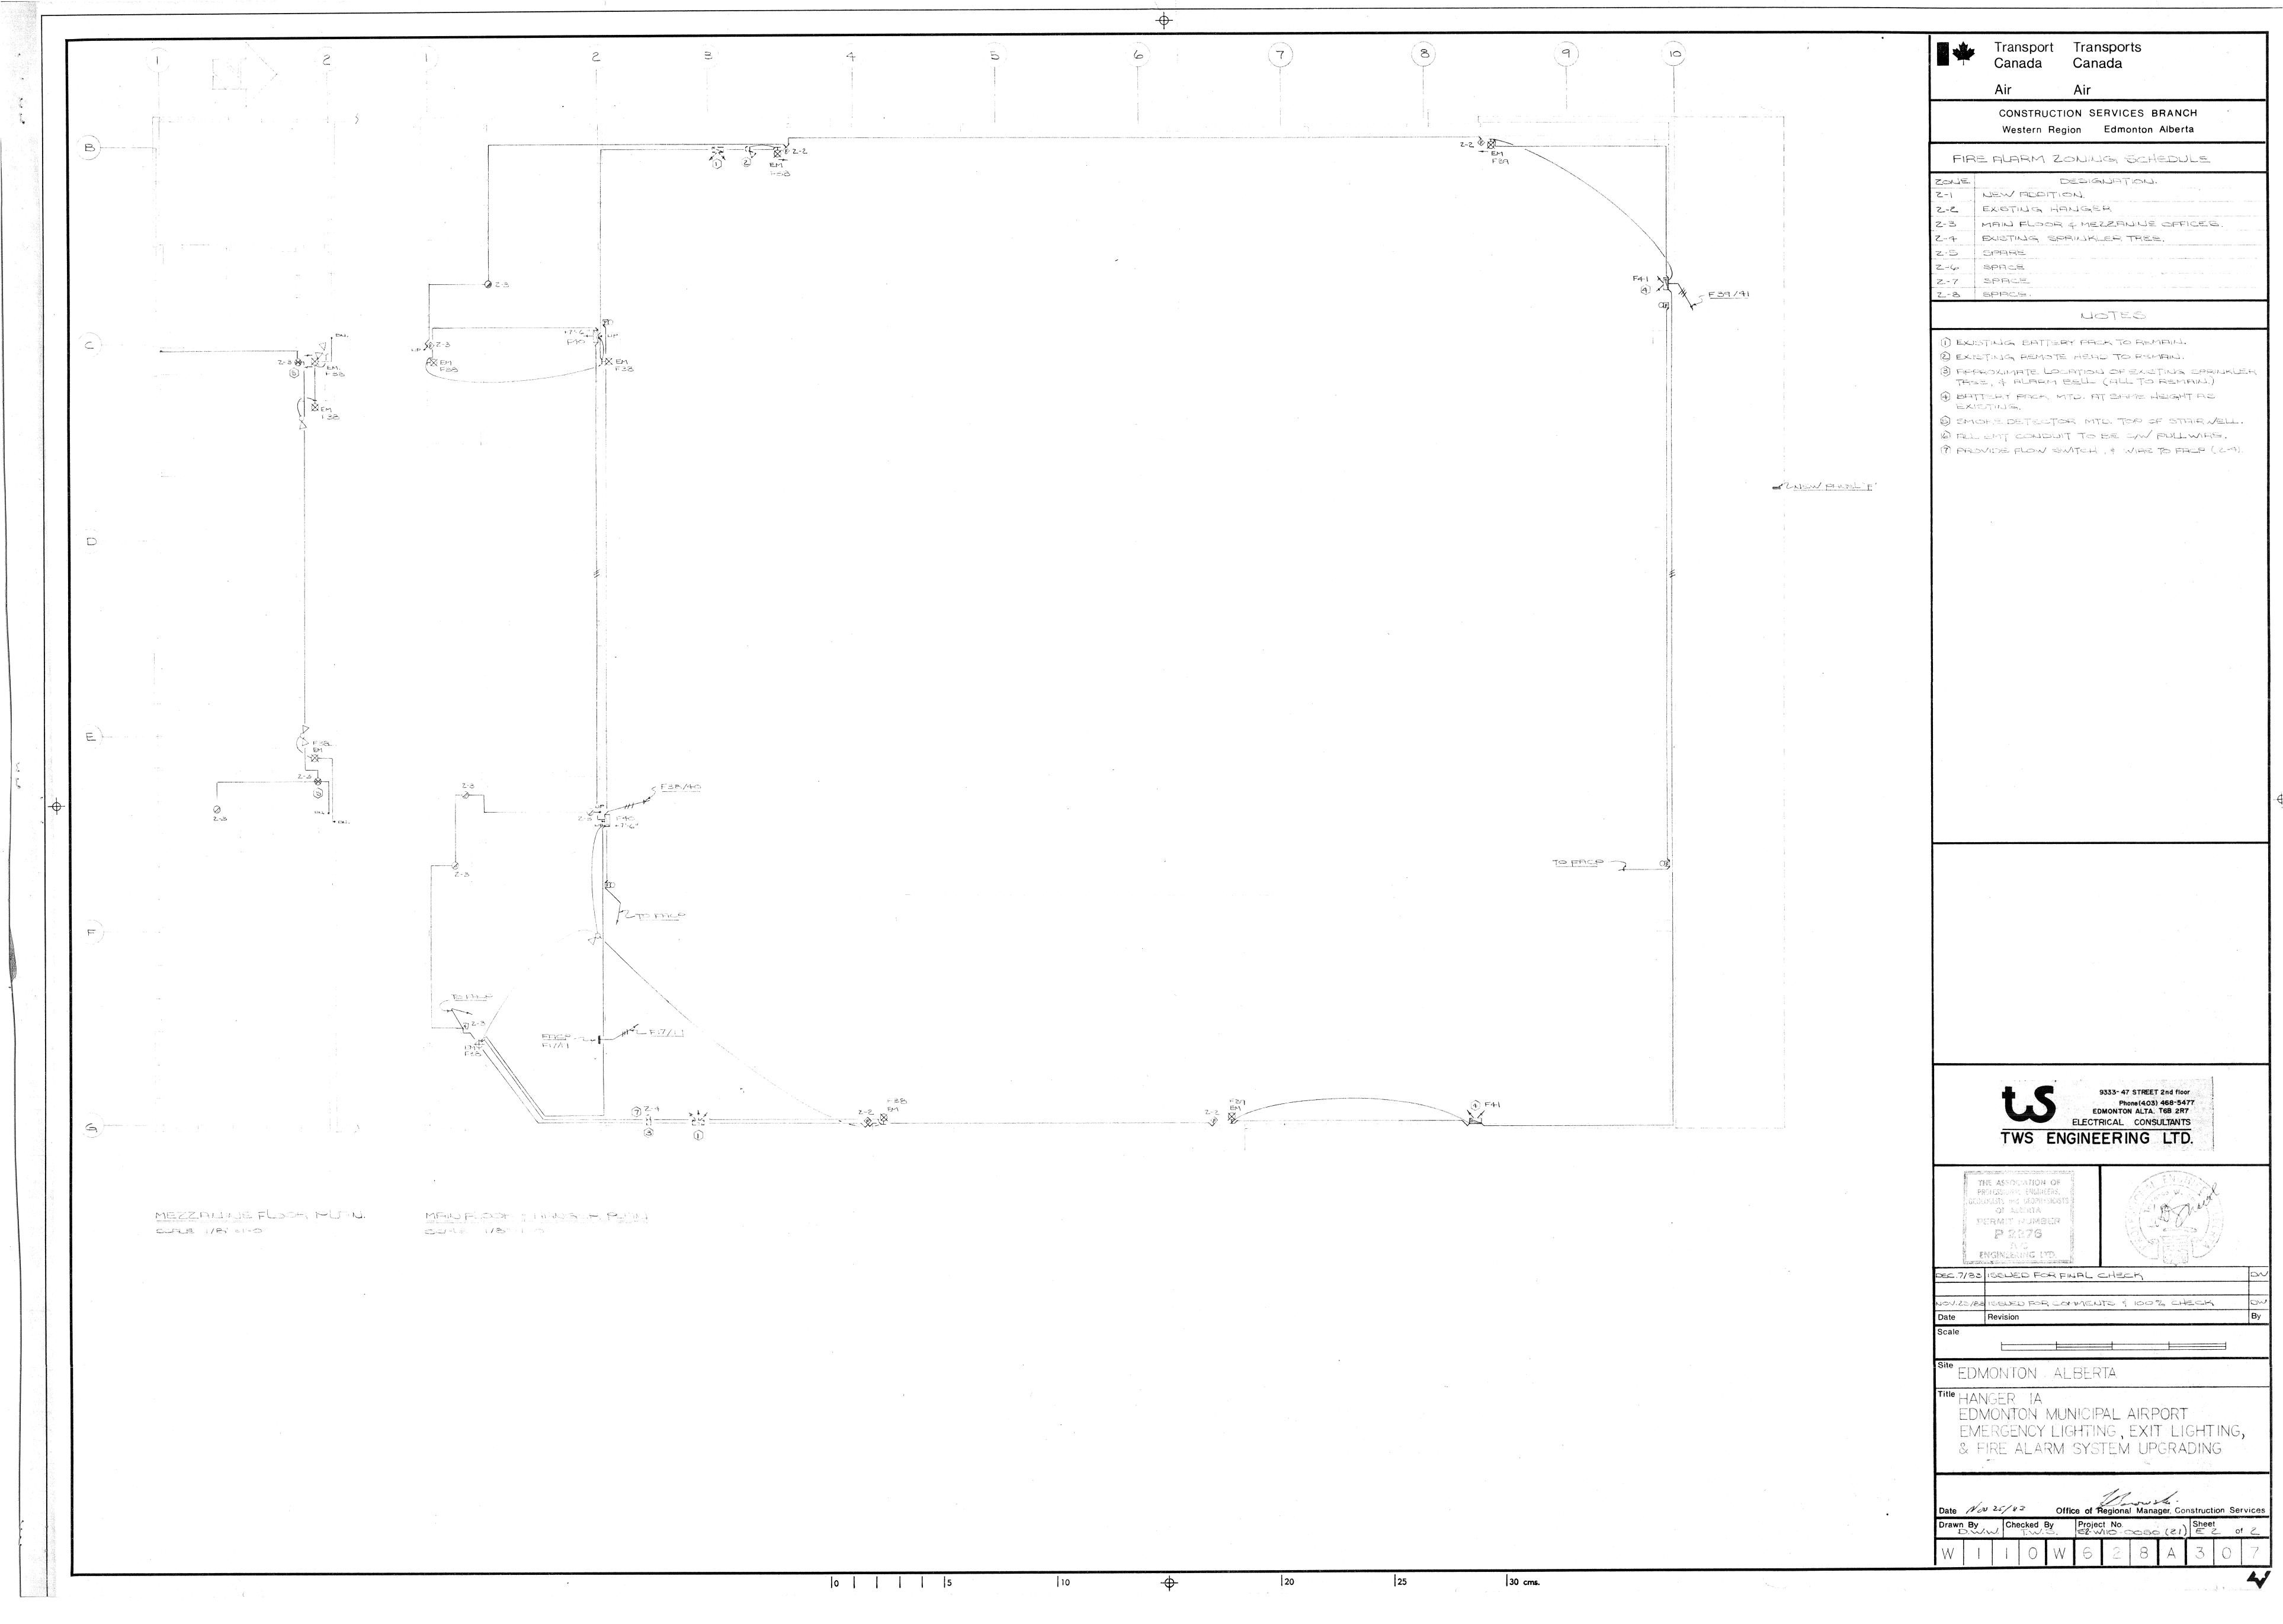

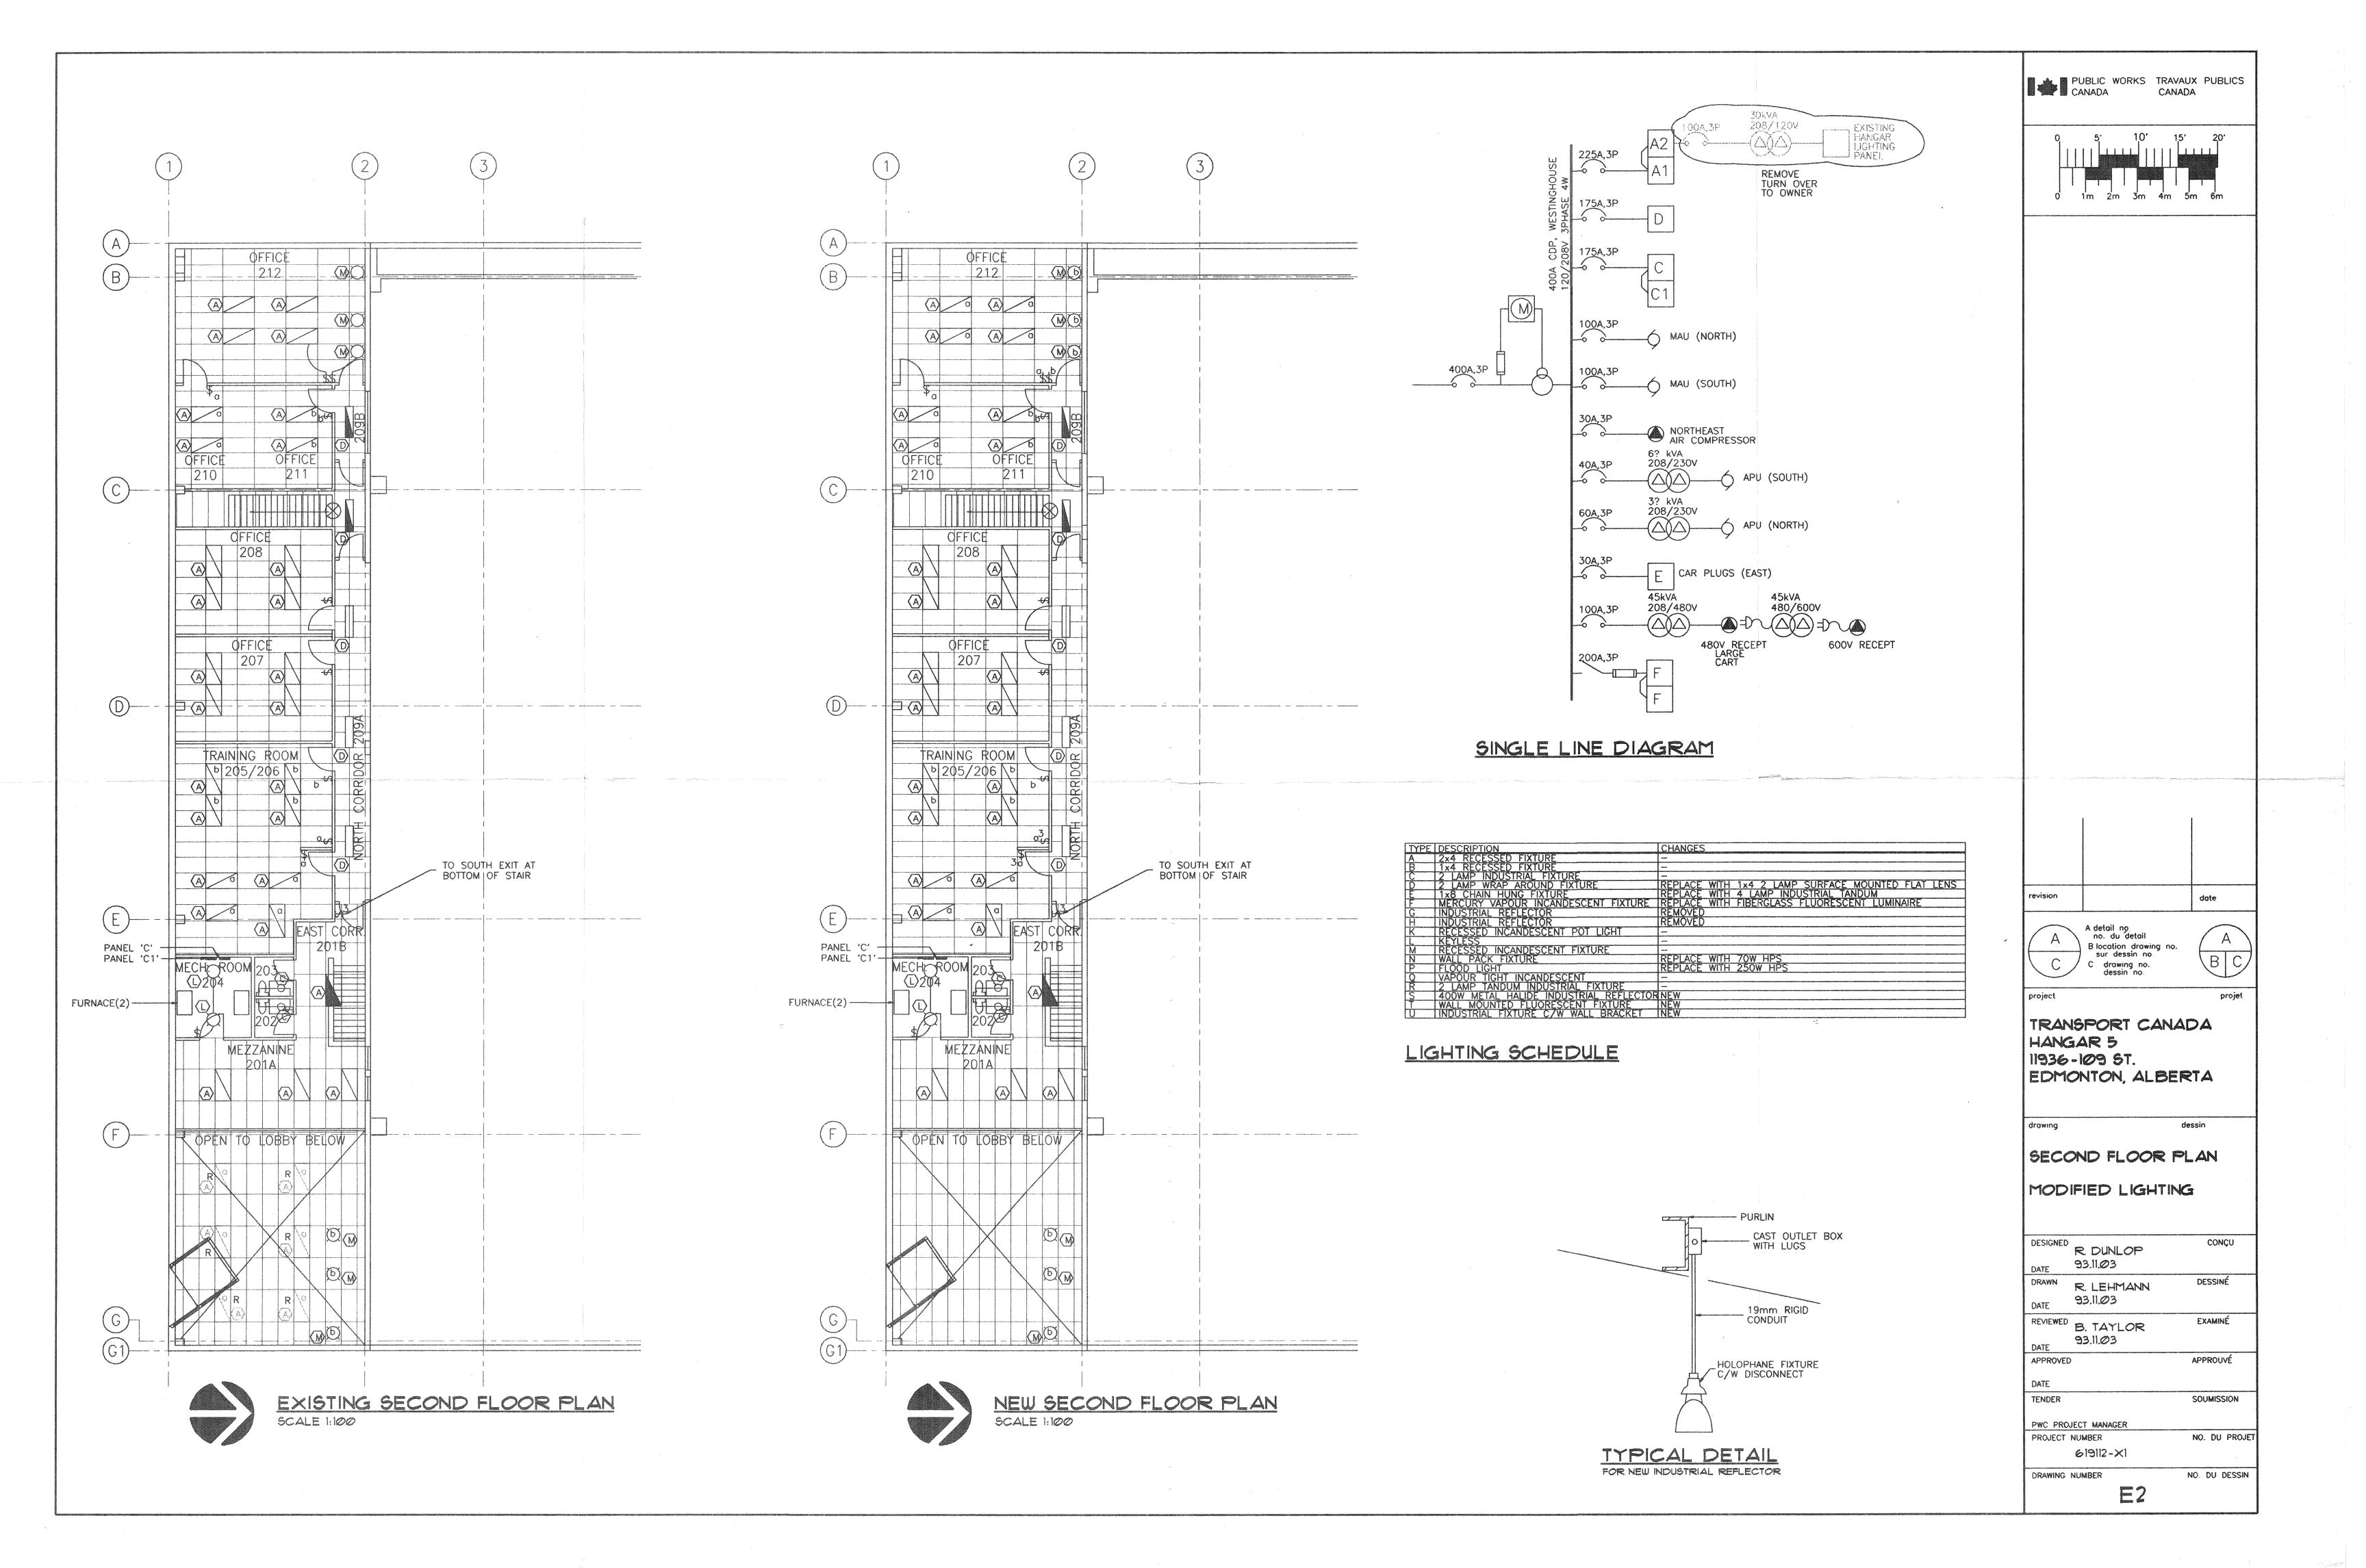


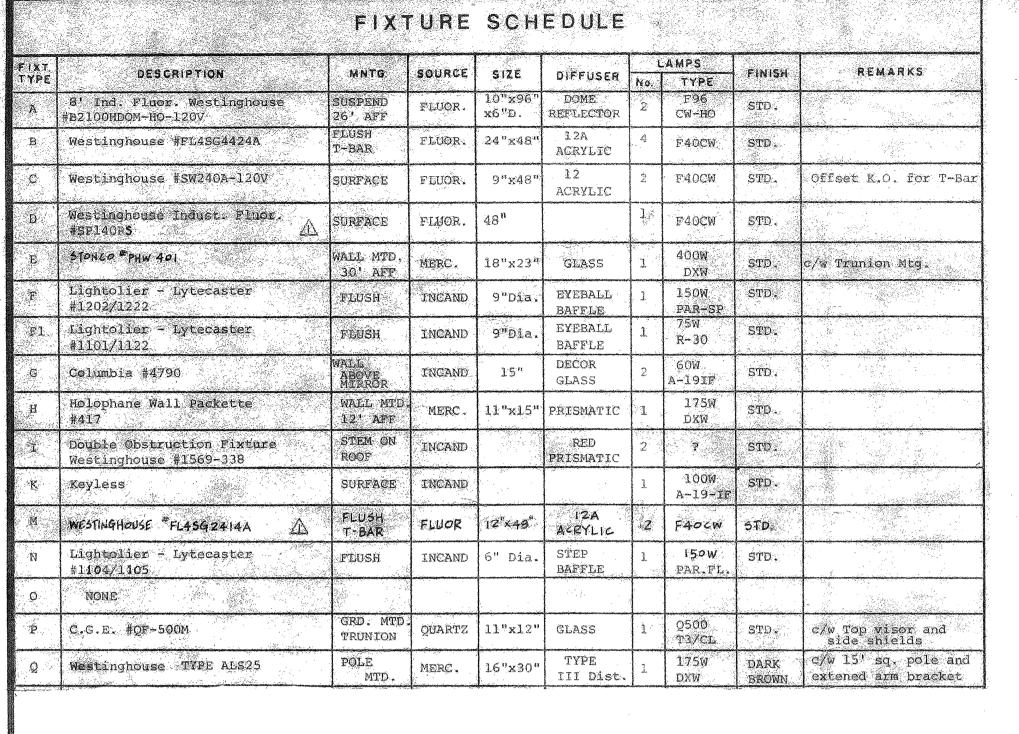

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| DES. | SIZE (CCT) | LOCATION | MNTG. | ENT | CAP (AMP) | VOLT | ø | R | FEEDER | 15A | 20A | 30A | 40A | 50A | ОТИЕЯ | REMARKS |
| A & A2 | EA. at 30 | HANGER | SURFACE | Batom | 225 | 120/ 208 | | 4 | 2½" C 4 #3/0 | 22 -1P 2-3P | 15-lp | | | | | PNL A to bec/w double lugs. |
| вľ | 12 | WORK SHOP (MAIN FUR.) | SURFACE | βa[1aH | | 120/ 208 | | 4 | 3/4"C 4 #8 | 6-1P | | erren er | *************************************** | | | |
| B2 | 12 | Work Shop Main Flr. | SURFACE | Bollori | 100 | 120/ 208 | , | 4 | 3/4°C 4 #8 | 6-1P | | g manamag fi in mag ng guyang mang mang ng manamag ng manamag ng manamag ng manamag ng manamag ng manamag ng m | , | | | |
| C | 42 | FURNACE RM. | SURFACE | Botton | 225 | 120/ _268 | į. | 4 | 2"C 4 #11/0 | 13-1P | | Lance 3 P | | 4-3P | Space of the control | The second secon |
| D | 42 | work shop Main Flr. | | BUTTER | 225 | 120/ 208 | ' R | 4 | 2"C 4 #170 | 20-IP 2-3P | 1-1P | 1-3P 3-2P | Material Response of Proposition of Manager England (Manager England (Manager England (Manager England (Manager | | | |
| E | 1/2 | HANGER | SURFACE | TOP | 100 | 1207 208 | | 4 | 3/4"C 4 #8 | 8-1P | | | | | | |
| | | | | | | | | | | | | V. | | | | |

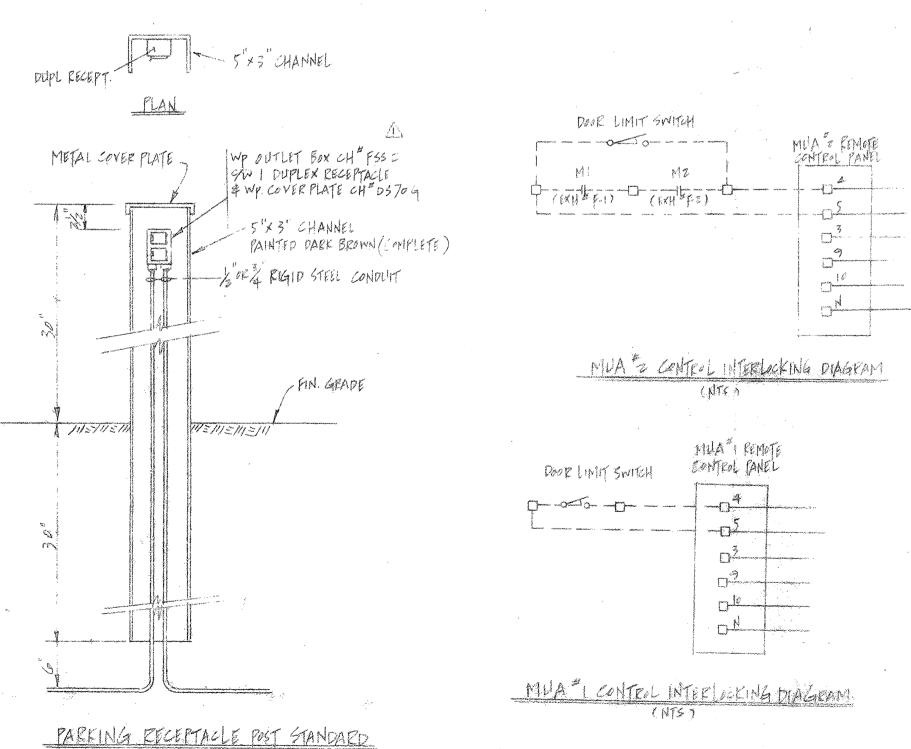

(NTS)

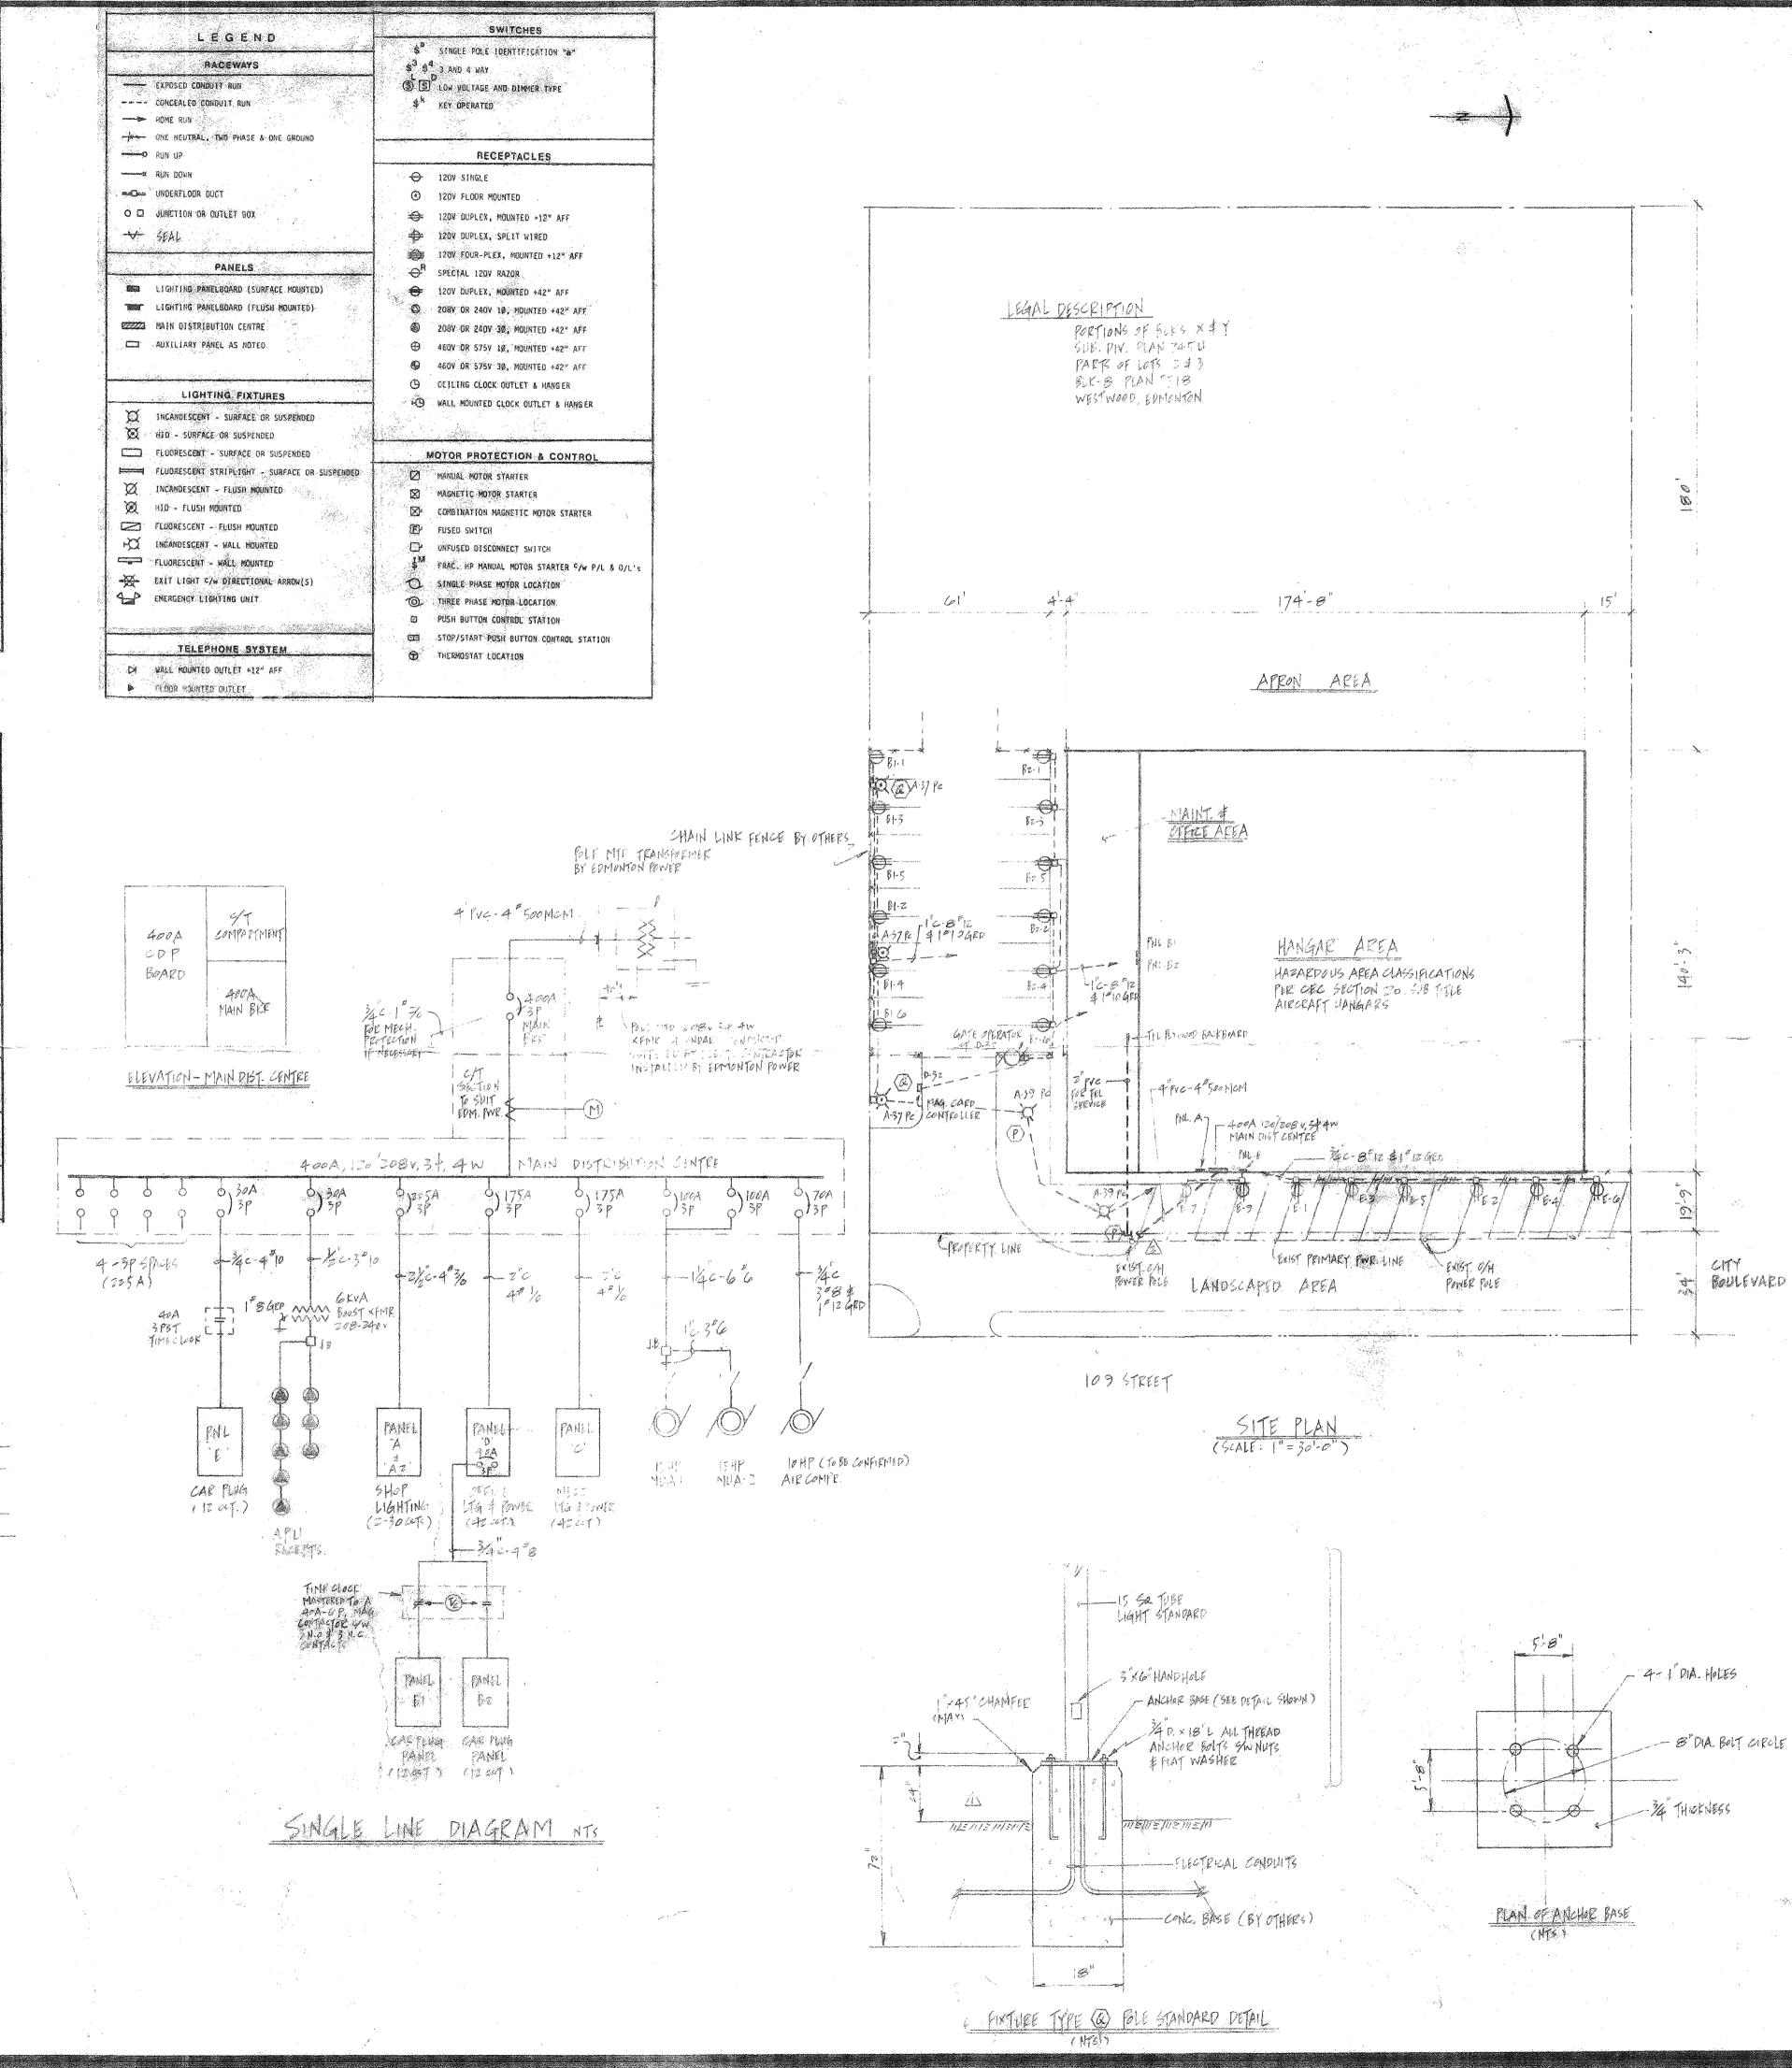

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