




A NORTH SIDE DETAIL A
SCALE 1:150

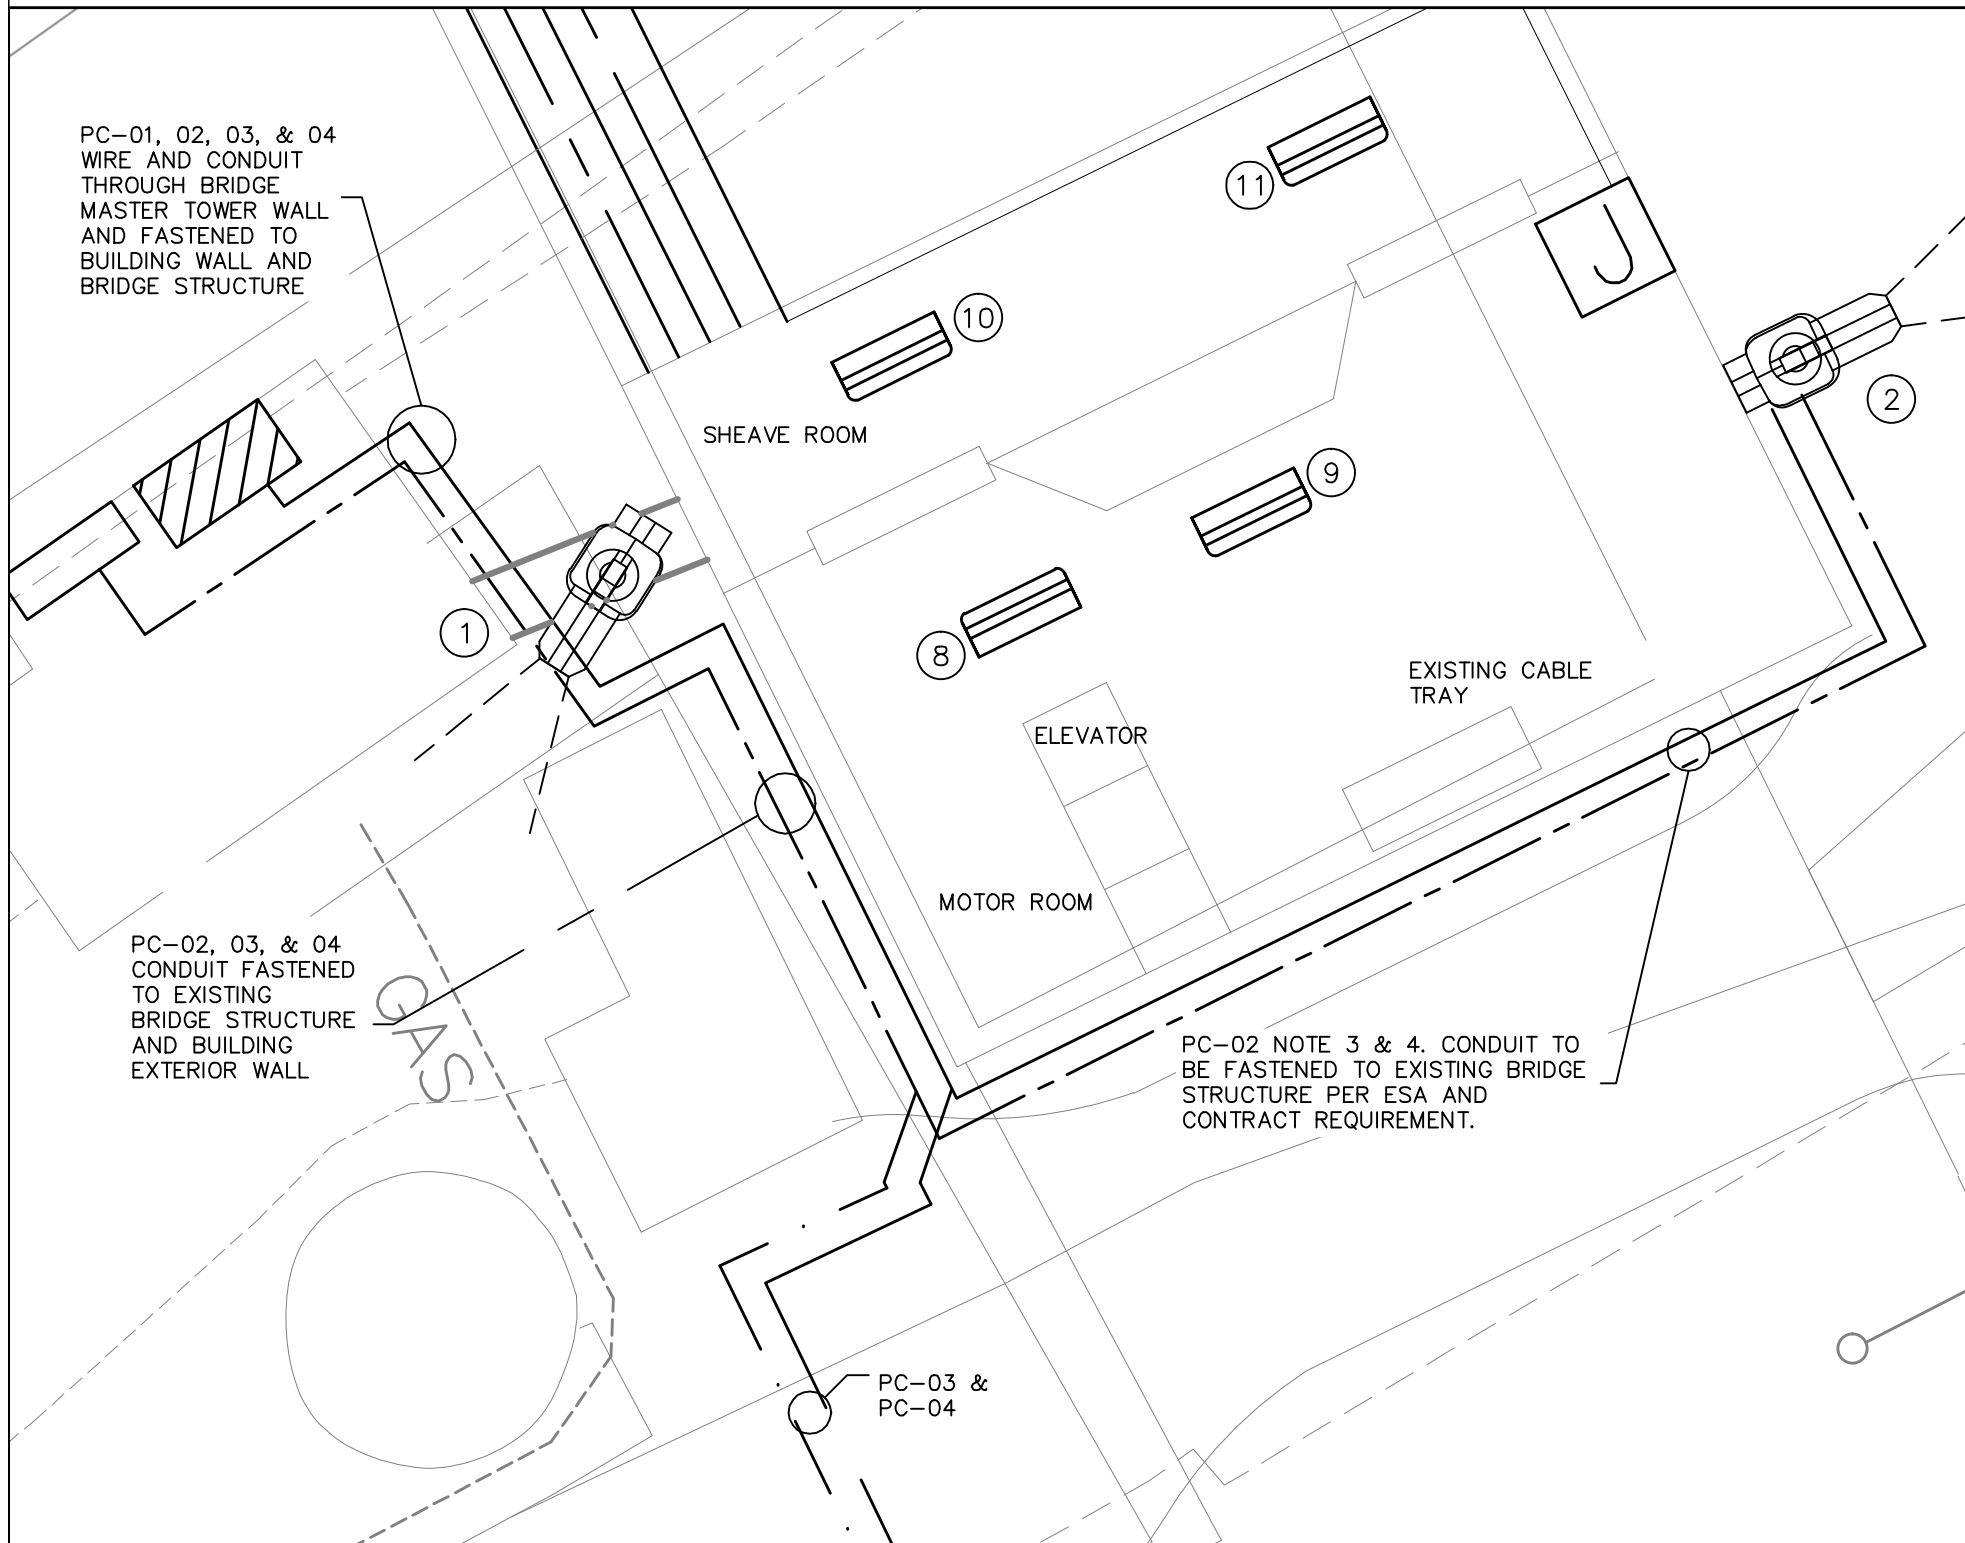

B SOUTH SIDE DETAIL B
SCALE 1:150

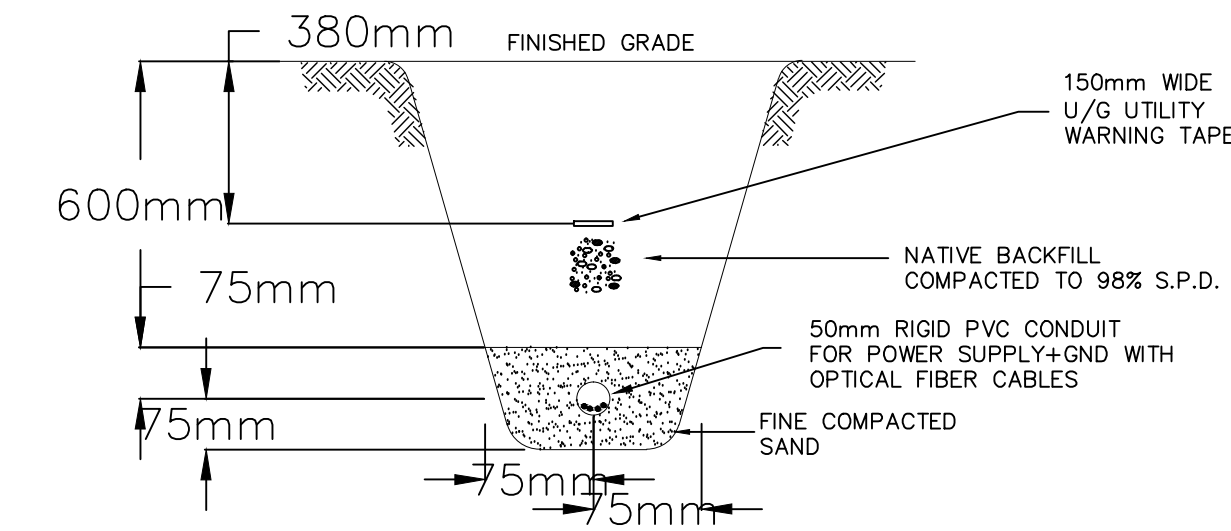

C TYPICAL TRENCH DETAIL CROSS SECTION
SCALE: N.T.S.

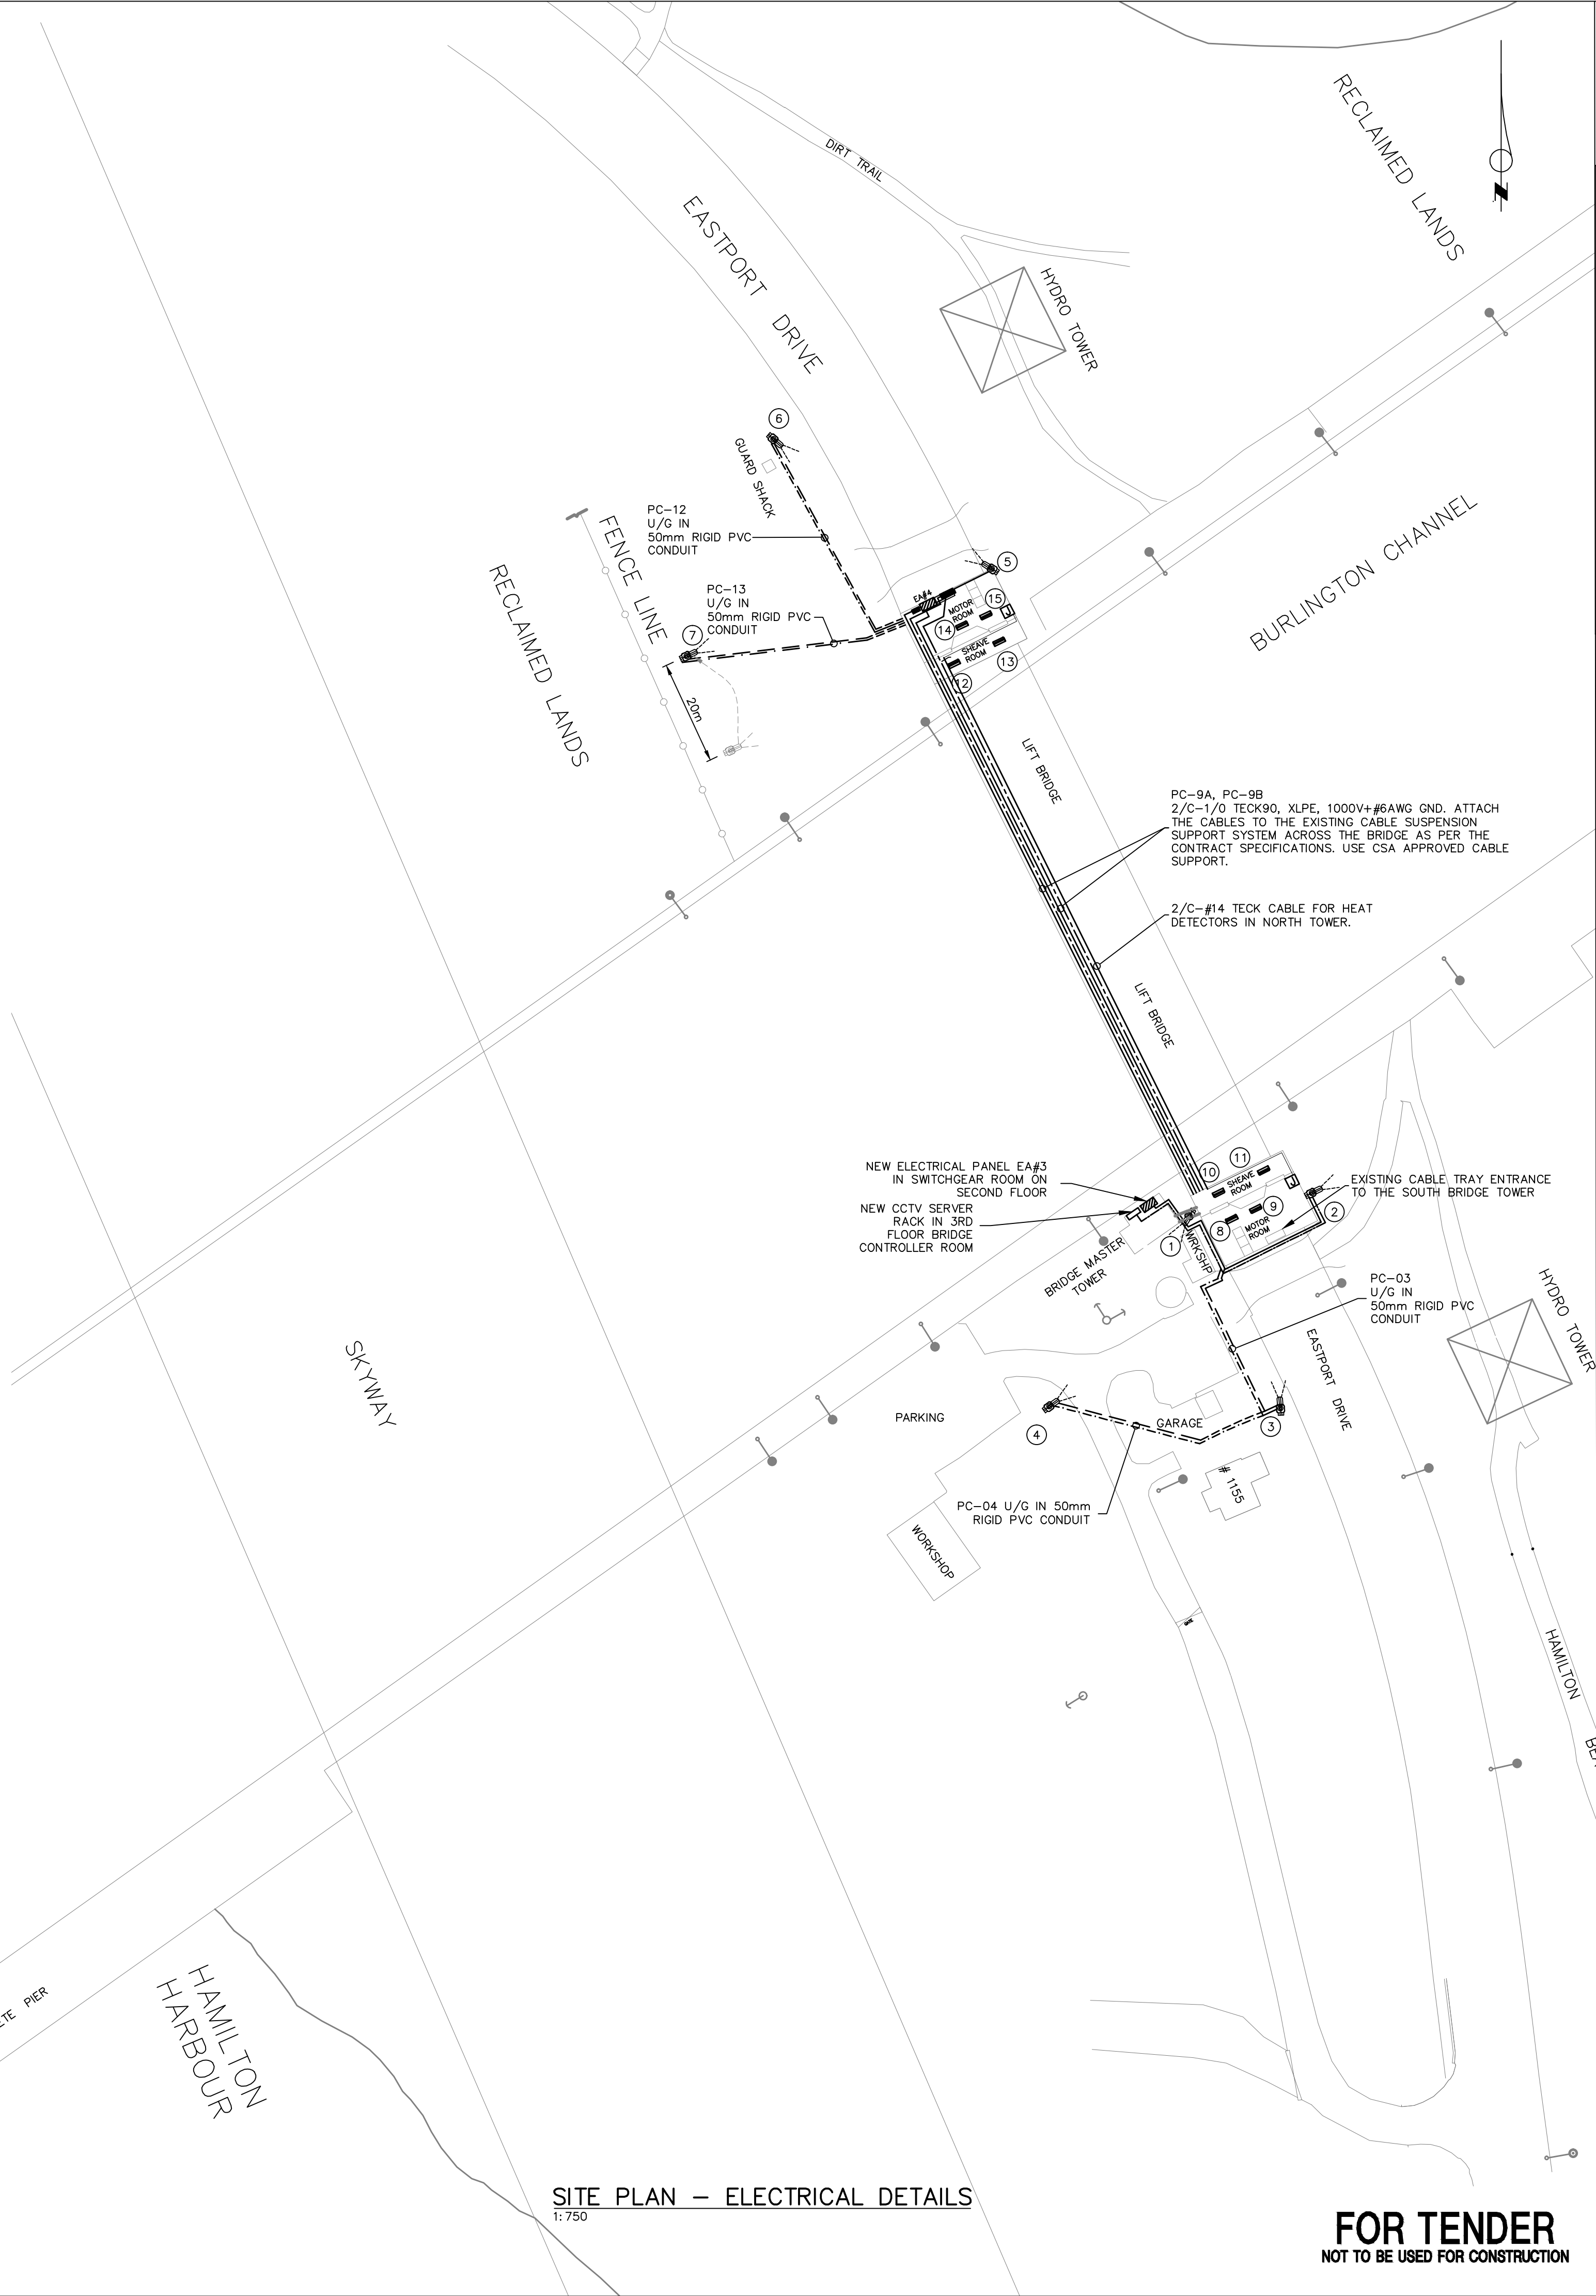

SITE PLAN – ELECTRICAL DETAILS
1:750

FOR TENDER
NOT TO BE USED FOR CONSTRUCTION



- LEGEND:
- PTZ CAMERA – BOX TYPE
 - HEAT DETECTOR
 - UNDERGROUND POWER CABLE
 - ABOVE GROUND POWER CABLE
 - UNDERGROUND OPTICAL FIBER CABLE
 - ABOVE GROUND OPTICAL FIBER CABLE
 - POWER PANEL
 - FIBRE OPTIC PATCH PANEL
 - CCTV SERVER (3RD FLOOR)

- NOTES:
- REFER TO DRAWING D-E5 SINGLE LINE DIAGRAM FOR CIRCUIT IDENTIFICATION
 - CONTRACTOR SHALL VERIFY THE LENGTH OF THE CONDUCTOR/CONDUIT AND THE LOCATION PRIOR TO INSTALLATION. THE FINAL LOCATION OF THE EQUIPMENT AND CABLE/CONDUIT SHALL BE APPROVED BY A DEPARTMENTAL REPRESENTATIVE AND OTHER AUTHORITIES HAVING JURISDICTION PRIOR TO PROCEEDING.
 - INSTALL FIBRE OPTIC COMMUNICATION CABLE AND CAMERA POWER SUPPLY CABLE IN COMMON CONDUIT.
 - INSTALLATION OF CAMERAS AND MOUNTING EQUIPMENT INCLUDING WIRING/CONDUIT SHALL NOT DISTURB THE STRUCTURE OR FOUNDATION OF THE BURLINGTON LIFT BRIDGE IN ANY WAY TO ACCOMMODATE THE INSTALLATION OF THE CCTV SYSTEM. ANY ACTIONS SUCH AS WELDING AND DRILLING SHALL RECEIVE STRUCTURAL ENGINEERING APPROVALS AND OWNERS APPROVAL PRIOR TO PROCEEDING. ALTERNATIVE MEANS SUCH AS CLAMPING IS REQUIRED.
 - FIBER OPTIC OPTIC CABLE SHALL BE DOUBLE JACKET, HEAVY DUTY, OUTDOOR RATED. THE FIBER OPTIC CABLE ACROSS THE BRIDGE SPAN SHALL BE DOUBLE JACKET, ARMoured, RATED FOR OUTDOOR USE WITH A MINIMUM OF 48 FIBERS.
 - CONTRACTOR SHALL TERMINATE THE ARMoured CABLES USING ESA APPROVED METHOD.

REVISIONS				
No.	By	Date	Approved	Revisions
1	BR	11.06.29	JW	ADD TRENCH DETAIL
2	BR	11.06.29	JW	EDITED TRENCH ROUTING
3	MD	12.03.27	JW	ISSUED FOR TENDER
4	JF	12.05.24	MV	PWGSC UPDATES
5	JF	12.06.20	MV	AS PER PWGSC COMMENTS

project title	BURLINGTON LIFT BRIDGE DESIGN/INSTALLATION OF CCTV SYSTEM BURLINGTON, ONTARIO			titre du project
drawing title	SITE PLAN – ELECTRICAL POWER, DATA COMMUNICATION			titre du design
scale	AS SHOWN			echelle
checked by:	MIKE VOLL	vérifié par	consultant	consultant
drawn by:	BR	project	STANTEC CONSULTING LTD.	project
S.G.C.	00-000	date	2012-06-20	date
C.G.T.	D-E2	sheet	00000 & 00000	feuille
Item no.	D-E2	project no.	R.012843.045	sheet
		sheet	1 of de 1	feuille