




SMALL CRAFT HARBOURS
CENTRAL AND ARCTIC REGION

NOTES:








- ELEVATIONS ARE GIVEN USING THE CANADIAN VERTICAL GEODETIC DATUM OF 1927 (CGVD27) OTHERWISE STATED
- DIMENSIONS ARE IN MILLIMETRES UNLESS OTHERWISE STATED
- VERTICAL FENDERS ARE TO BE INSTALLED EVERY SECOND IN-PAN OF THE STEEL SHEET PILE SLIPWAY AS INDICATED
- APPROXIMATELY 37 VERTICAL FENDERS REQUIRED TO BE INSTALLED ON THE WHARF EAST OF THE SUPPLY AND INSTALLATION CONTRACTOR TO VERIFY ON SITE AND NOTIFY ENGINEER OF ANY DISCREPANCIES
- ENGINEERING APPROVAL REQUIRED FOR SUBSTITUTIONS OF SPECIFIED MATERIAL

- SCOPE OF WORK
- THE WORK UNDER THIS CONTRACT COVERS:
- DEMOLITION AND REMOVAL OF EXISTING HORIZONTAL AND VERTICAL TIMBER FENDERS AND ATTACHMENT HARDWARE (WHERE INDICATED),
 - SUPPLY AND INSTALLATION OF NEW 254 x 254 HORIZONTAL AND 305 x 305 VERTICAL FENDERS, INCLUDING SUPPLY OF REQUIRED HARDWARE AND FASTENERS CONTRACTOR TO REPLACE DAMAGED CLIP ANGLES AS REQUIRED
 - SUPPLY AND INSTALLATION OF FOUR HUBBELL MARBER STAINLESS STEEL FLOOD GATE PANELS WITH STAINLESS STEEL BRACKETS PANEL # 409-438 (SEE ATTACHED SPEC SHEET TO COMPLETE THE WORK. THE LIGHTS SHALL BE INSTALLED AND CONNECTED TO THE ELECTRICAL SERVICES LOCATED ON TWO EXISTING SERVICE POLES SHOWN ON DRAWING H-2.

SITE PLAN
SCALE: 1:300

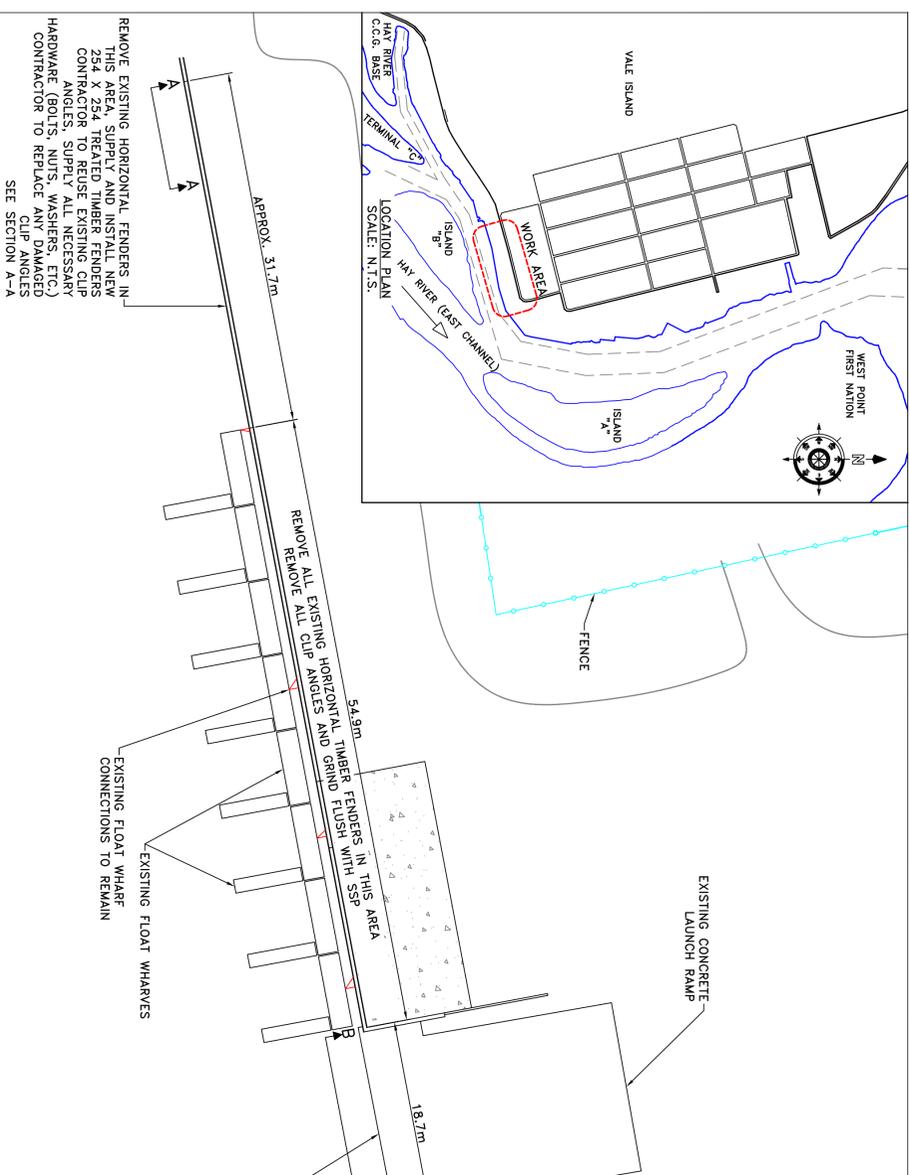

VERTICAL FENDER - PLAN (TYP.)
SCALE: 1:15

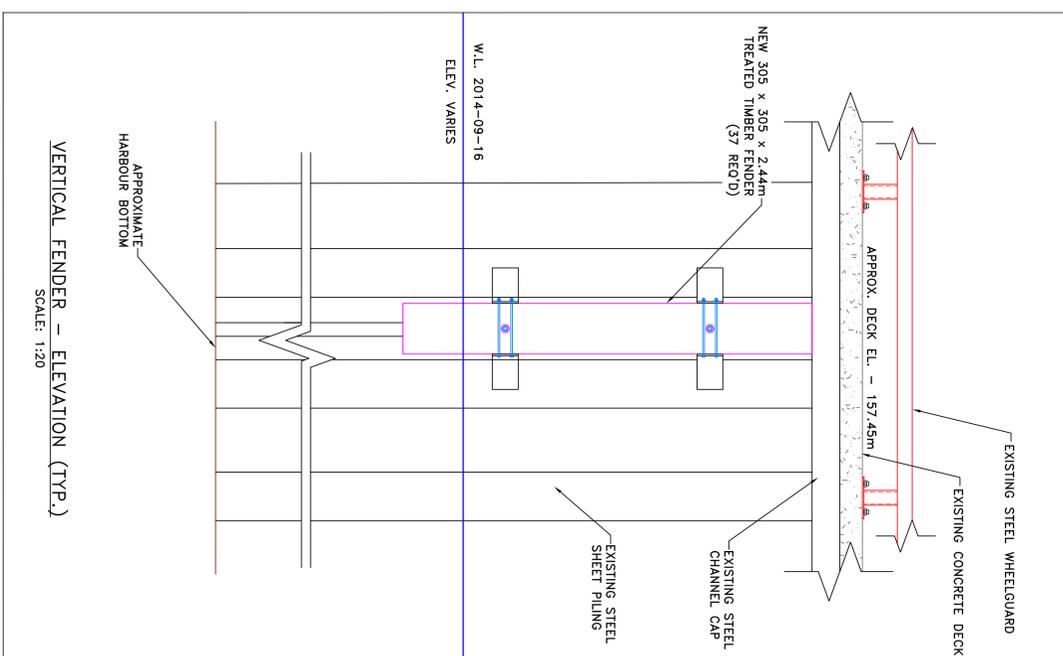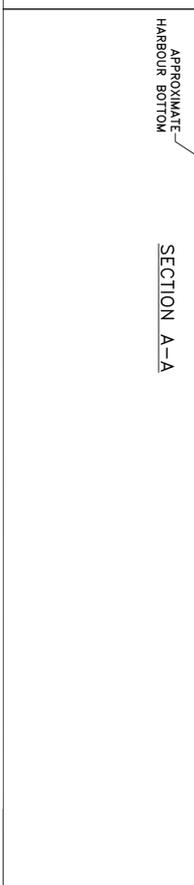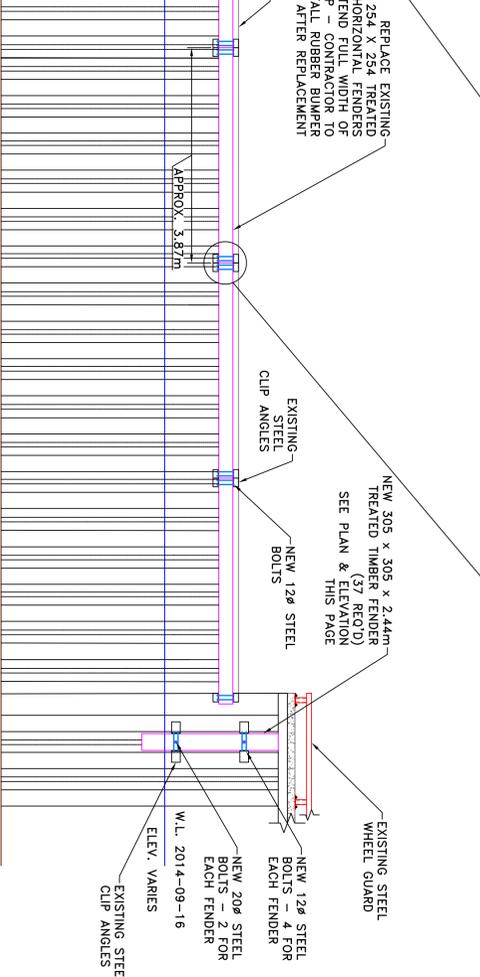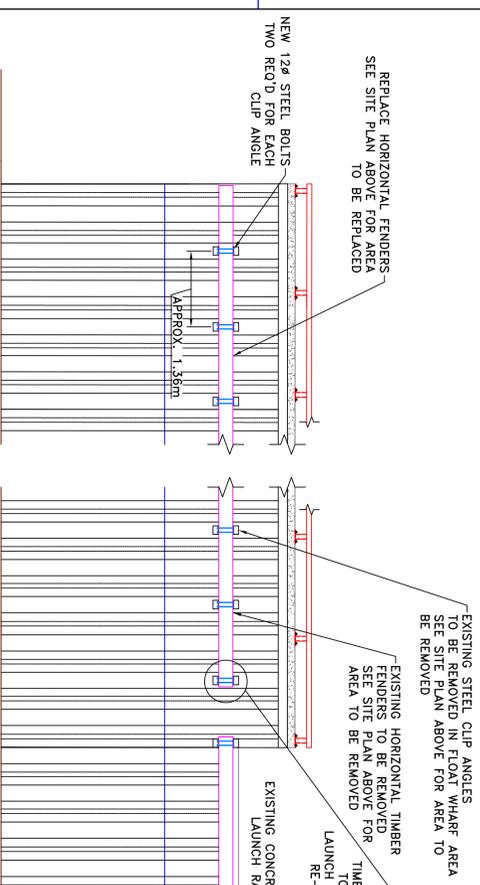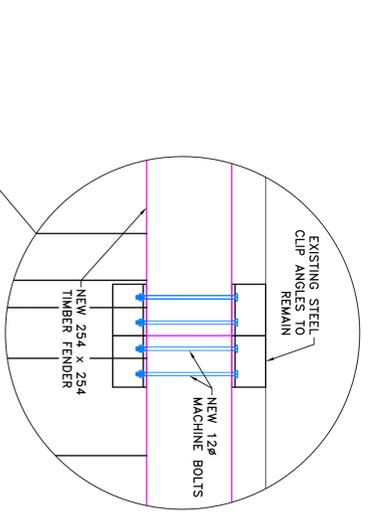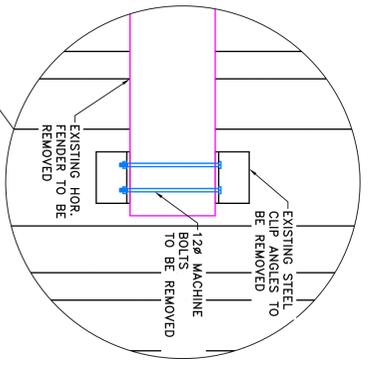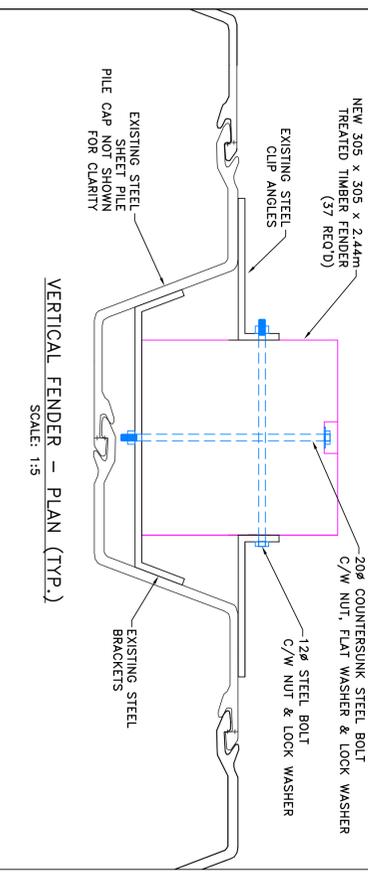

REVISIONS:	DATE:
0 ISSUED FOR TENDER	NOV. 28, 2014
AS SHOWN	
SCALE:	CLASS:
AS SHOWN	
PROJECT:	
HARBOUR IMPROVEMENTS	
DESCRIPTION:	
PLAN AND INSTALLATION DETAILS	
DRAWN:	APPROVED:
SCH	SCH
DATE:	DATE:
NOV. 2014	NOV. 2014
LOCATION:	
HAY RIVER - EAST CHANNEL, NT	
DRAWING NO.:	LOCATOR CODE:
H-1 OF 2	5976