

DRAWING NOTES


- 1 NON-CLIMBABLE CHAIN LINK FENCE AND GATE. REFER TO DETAILS 1/A300, 2/A300 AND 8/A300.
- 2 SLOPED CONCRETE SLAB C/W 50mm OF HIGH DENSITY RIGID INSULATION AND COMPACTED GRANULAR 'A' AND 'B'. EXCAVATE SOD AND TOPSOIL. REFER TO DETAIL 1/A300. REFER TO STRUCTURAL AND CIVIL. FINAL LOCATION AND SIZE OF SLAB TO BE VERIFIED WITH EMBRIDGE.
- 3 SLOPED CONCRETE SLAB W/ SLAB THICKENING AT PERIMETER C/W 50mm OF HIGH DENSITY RIGID INSULATION AND COMPACTED GRANULAR 'A' AND 'B'. EXCAVATE SOD AND TOPSOIL. REFER TO DETAIL 1/A300. REFER TO STRUCTURAL AND CIVIL.
- 4 PACKAGED BOILER PLANT. REFER TO MECHANICAL. PROVIDE MINIMUM 50mm HIGH CONTINUOUS CONCRETE CURBS AT BOILER BASE FRAME TO ENSURE LEVEL INSTALLATION. REFER TO STRUCTURAL FOR TYPICAL CURB DETAIL.
- 5 HATCH AREA INDICATES 150mm DEEP 20mm ROUGH DIA. RIVERSTONE C/W LANDSCAPE FILTER FABRIC AND 300mm DEEP COMPACTED GRANULAR 'A'. EXCAVATE EXISTING GRASS SURFACE AND TOPSOIL.
- 6 CORE THROUGH EXTERIOR WALL FOR MECHANICAL. BRICK TWO WYTHES C/W TERRA COTTA BLOCK AND INSULATION. REFER TO DETAIL 5/A300.
- 7 NEW GYPSUM BOARD BULKHEAD. PAINT. REFER TO DETAIL 3/A300. REMOVE EXISTING ACOUSTIC CEILING TILE SYSTEM.
- 8 REMOVE EXISTING SHRUB.
- 9 REMOVE EXISTING TREE.
- 10 DASH LINE INDICATES EXTENT OF ROOF REMOVAL: CONCRETE PAVEMENT, SAND, INSULATION AND VAPOUR BARRIER. SALVAGE ALL MATERIALS FOR REINSTALLATION. RETAIN 300mm OF VAPOUR BARRIER FOR POSITIVE OVERLAP. REFER TO DETAIL 4/A300.
- 11 MECHANICAL DOG HOUSE. REFER TO DETAIL 4/A300.
- 12 NEW EDGE OF EXISTING CONCRETE PAVERS.
- 13 REMOVE EXISTING RAISED PLANTING BED C/W CONCRETE CURB PERIMETER.
- 14 NEW 610x610mm FIRE RATED ACCESS HATCH C/W SPRING LATCH IN EXISTING PLASTER AND LATH CEILING FOR MECHANICAL. REFER TO MECH.
- 15 REMOVE EXISTING CONCRETE PAVERS.
- 16 EXISTING CONCRETE SIDEWALK TO REMAIN.
- 17 GAS REGULATOR. REFER TO MECHANICAL.
- 18 EXISTING CONCRETE PAVERS TO REMAIN.
- 19 FENCE POST TO BE FASTENED TO EXISTING WALL. REFER TO DETAIL 1/A300.
- 20 FENCE TO BE CUT TO ALLOW FOR MECHANICAL PENETRATION. REFER TO MECHANICAL.

DRAWING NOTES CON'T

- 21 FENCE POST DRILLED INTO CONCRETE AT 100mm Ø AND CAST IN PLACE. REFER TO DETAIL 8/A300.
- 22 NEW SOD AND TOPSOIL AT RAISED PLANTER REMOVAL.
- 23 EXISTING MANHOLE TO REMAIN. SAFEGUARD FROM DAMAGE.
- 24 MECHANICAL VENT. REFER TO MECHANICAL.
- 25 CORE THROUGH INTERIOR WALL: BRICK TWO WYTHES AND TERRA COTTA BLOCK.
- 26 EXISTING GYPSUM BOARD COLUMNS TO BE MODIFIED TO ALLOW FOR GYPSUM BULKHEAD. PAINT.
- 27 NEW 200mm THICK CONCRETE WALKWAY C/W 300mm COMPACTED GRANULAR 'A' FILL AND 300mm COMPACTED GRANULAR 'B' FILL. WALKWAY TO BE FLUSH WITH NEW CONCRETE PAD AND EXISTING PATH. REFER TO CIVIL. EXCAVATE TOPSOIL AND SOD.
- 28 DASH LINE INDICATES EXTENT OF CONSTRUCTION ZONE AND OUTLINE OF CONSTRUCTION HOARDING.
- 29 EXISTING PAD MOUNTED ELECTRICAL UNIT. VERIFY EXACT LOCATION ON SITE.
- 30 PLANTING BED: 75mm SHREDDED MULCH, 350mm PLANTING SOIL. SCARIFY BOTTOM OF PLANTING PIT 50mm DEPTH TYPICAL.
- 31 SOD TO BE REINSTATED.
- 32 REMOVE TERRAZZO FLOOR FINISH AND 150mm HIGH TERRAZZO CURB SHOWER BASE. FLOOR TO BE LEVEL AFTER REMOVALS. REFER TO MECH.
- 33 CORE THROUGH CONCRETE FOUNDATION WALL FOR BELOW GRADE MECHANICAL. REPAIR ALL DAMP PROOFING DAMAGE. INJECT FOAM INSULATION AROUND OPENING PRIOR TO SEALING. PROVIDE 300mm DAMP PROOFING OVERLAP ON NEW PIPE AND EXISTING FOUNDATION. SEAL AROUND PIPE AND DAMP PROOFING.
- 34 300mm THICK CONCRETE UPSTAND CURB. REFER TO STRUCTURE. REFER TO CIVIL.
- 35 CONCRETE PIER FOR FENCE POST. REFER TO DETAIL 2/A300.


PLANT SCHEDULE

CODE	QTY.	BOTANICAL NAME	COMMON NAME	SIZE	O/C DIST.	COND.
PQ	146	Parthenocissus quinquefolia	VIRGINIA CREEPER	N/A	450mm	2 YR. POT
AR	2	Acer rubrum	RED MAPLE	70mm CAL.	N/A	B+B SINGLE STEM
PO	19	Physocarpus opulifolius	COMMON NINEBARK	600mm HT	900mm	POT
CA	3	Cornus alternifolia	PAGODA DOGWOOD	600mm HT	1250mm	POT

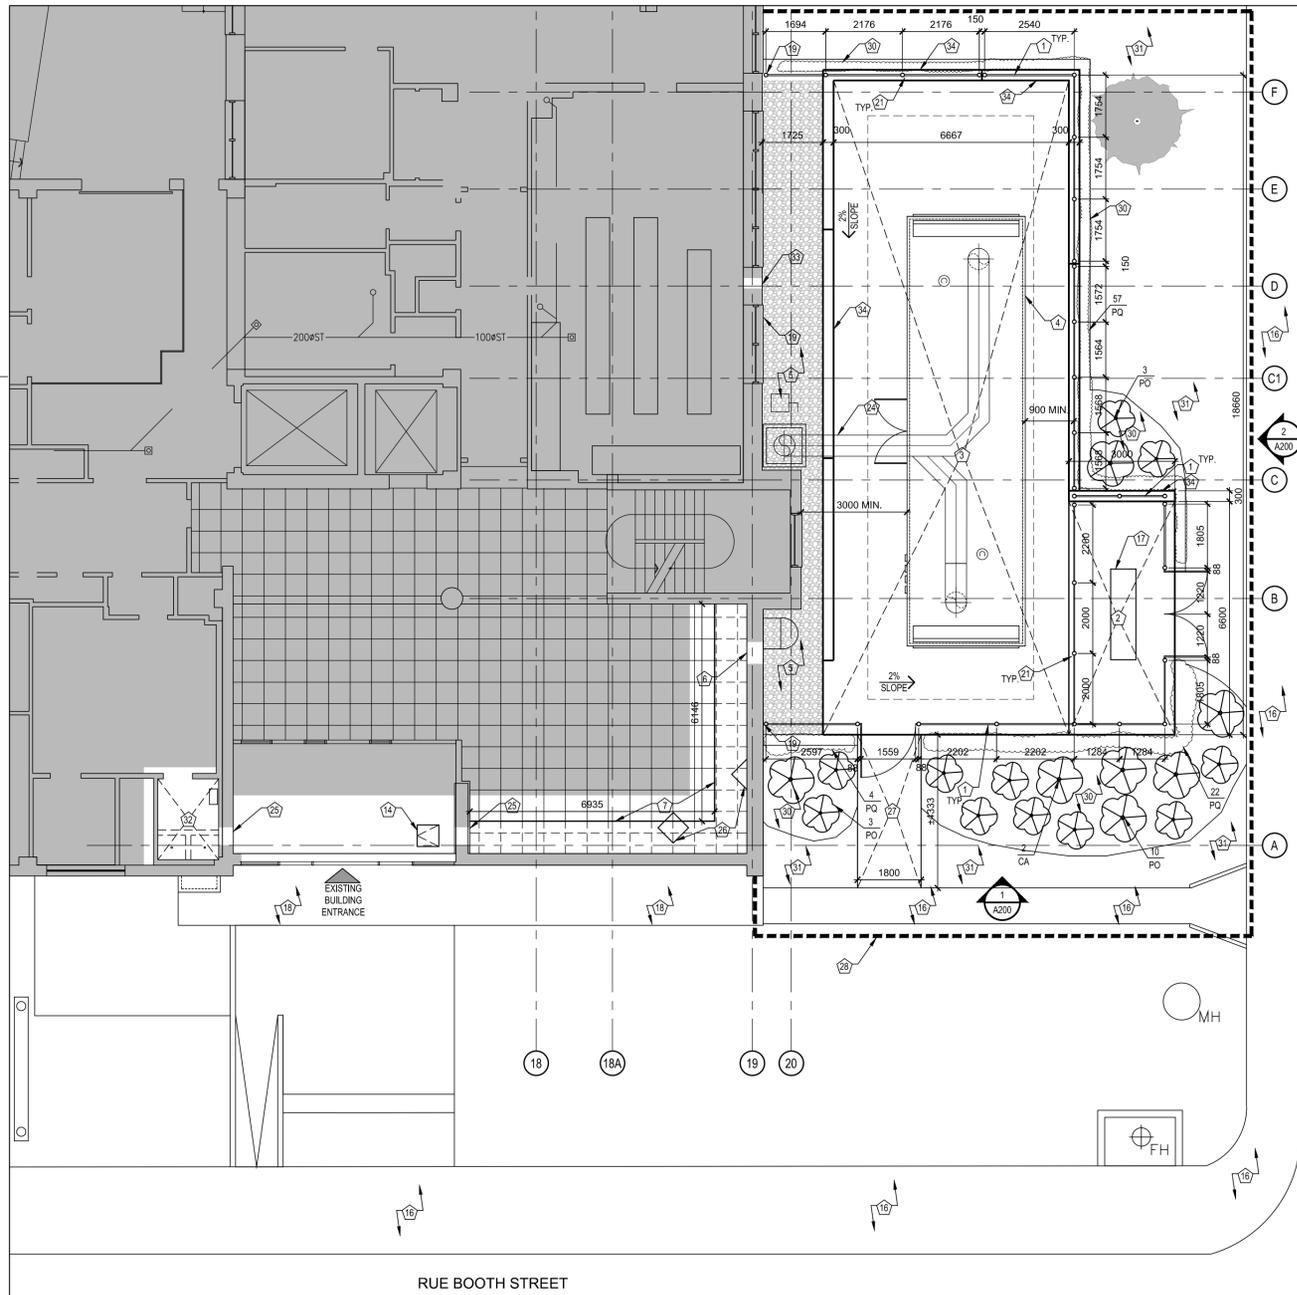

1 555 AND 601 BOOTH STREET PLAN

SCALE 1:100

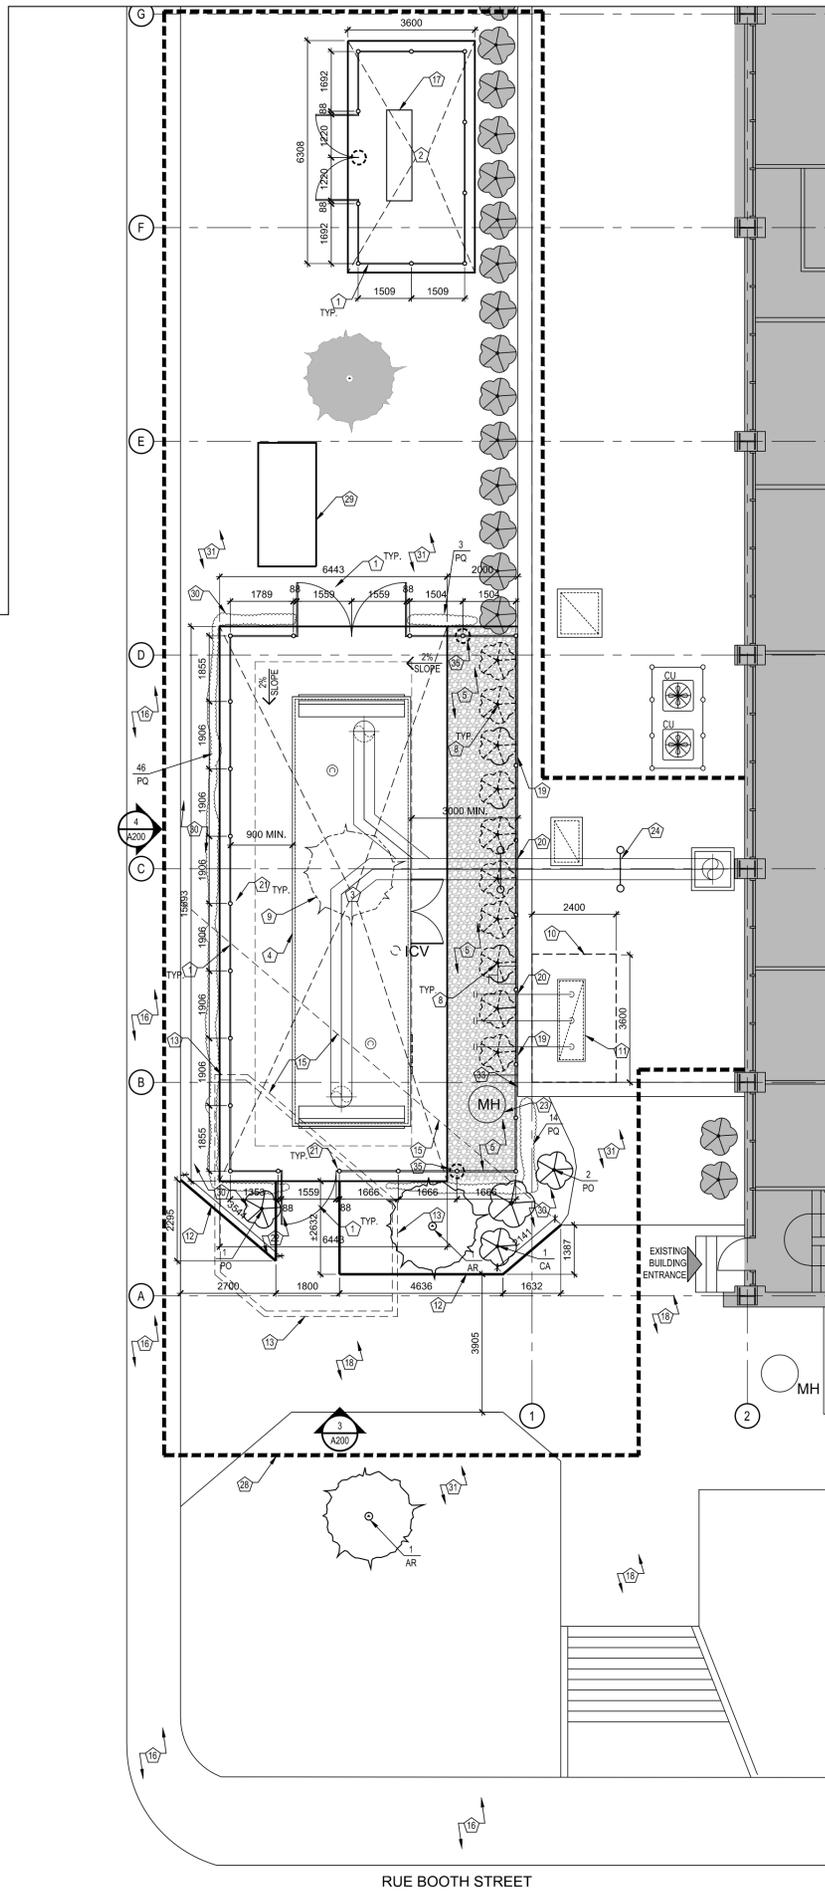

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KEY PLAN PLAN-REPÈRE

revision	description	date
O4	ISSUED FOR TENDER	2014/12/10
O3	ISSUED FOR TRANSLATION	2014/11/18
O2	ISSUED FOR 99% REVIEW	2014/07/14
O1	ISSUED FOR 66% REVIEW	2014/05/30

A detail no. / no. du détail
B location drawing no. / no. de localisation
C drawing no. / no. du dessin

project / projet

555/601 BOOTH STAND ALONE HEATING PLANT

drawing / dessin

555/601 BOOTH STREET PLANS

designed / conçu

date / date

drawn / dessiné

date / date

revised / révisé

approved / approuvé

date / date

tender / soumission

PWC Project Manager / Administrateur de projets TPC

project no. / no. du projet

R.060128.002

drawing no. / no. du dessin

A100