




1 555 BOOTH STREET SECTIONAL ELEVATION
SCALE 1:100

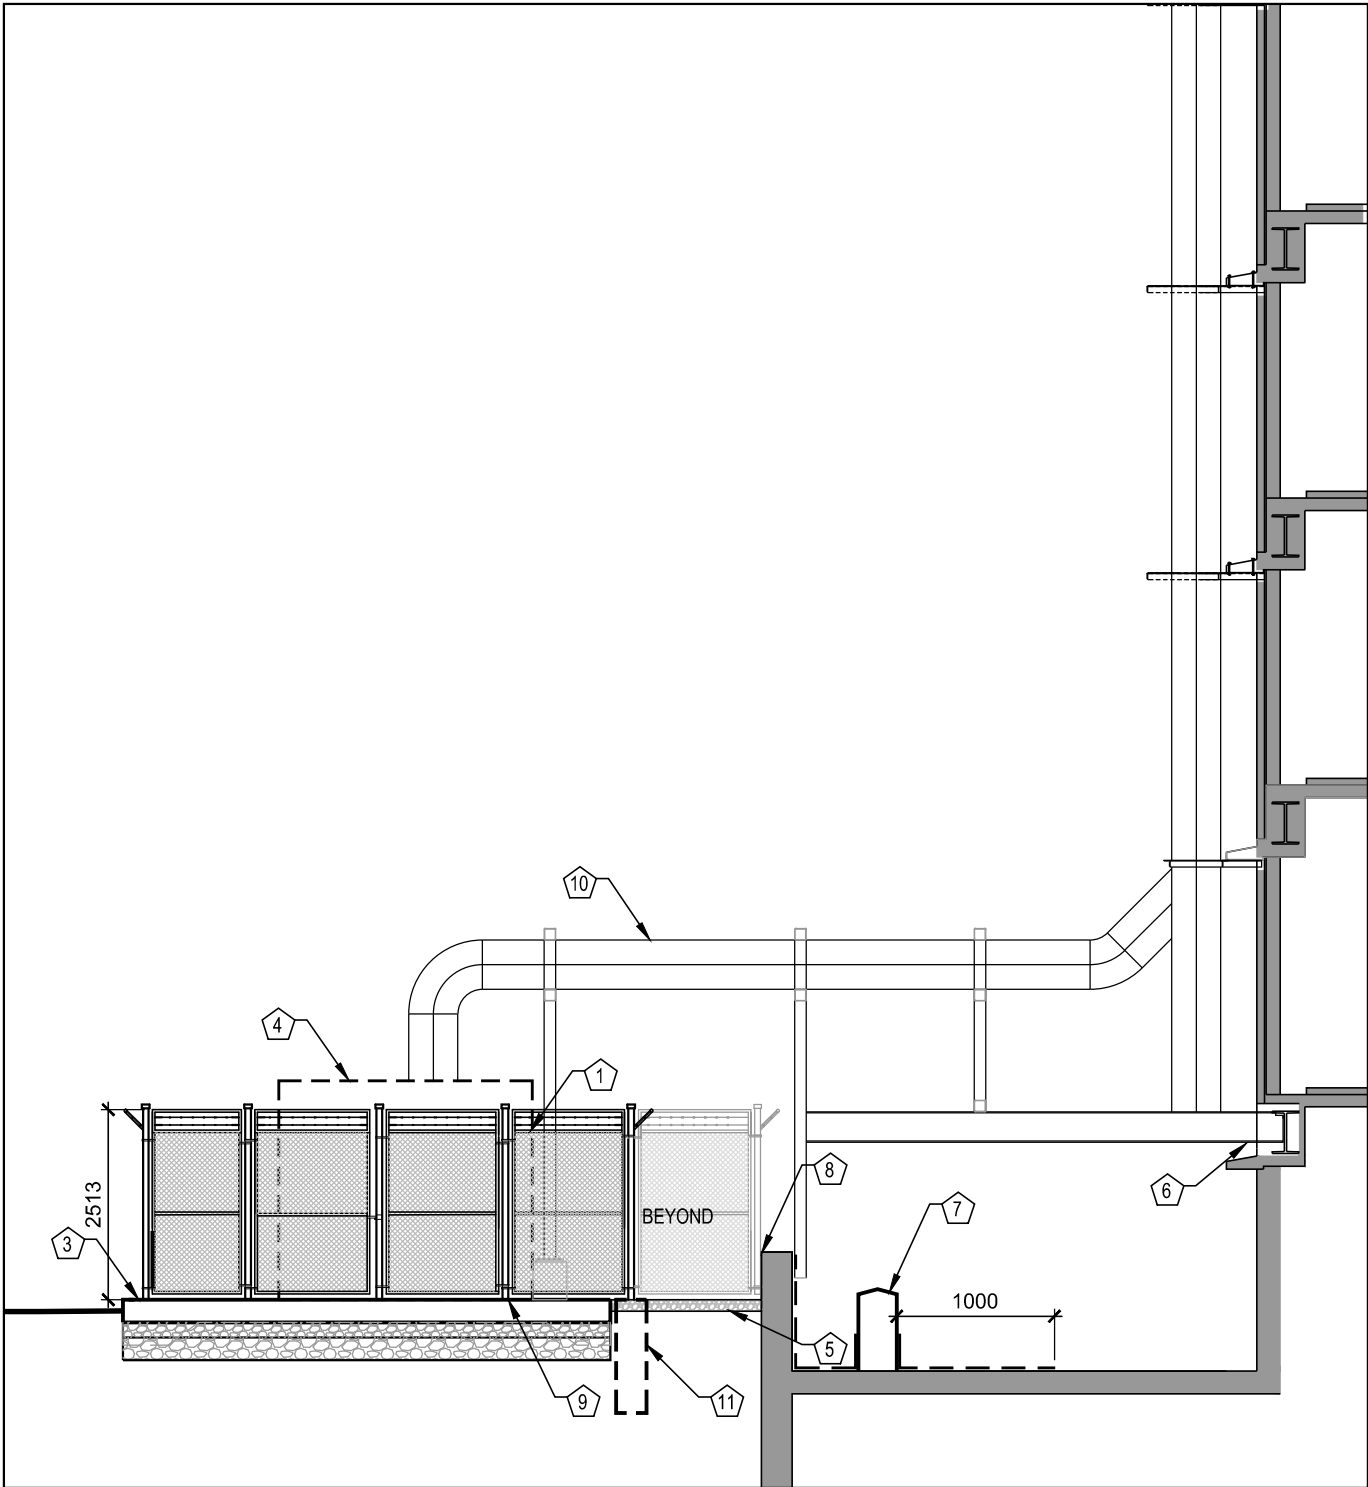

3 601 BOOTH STREET SECTIONAL ELEVATION
SCALE 1:100

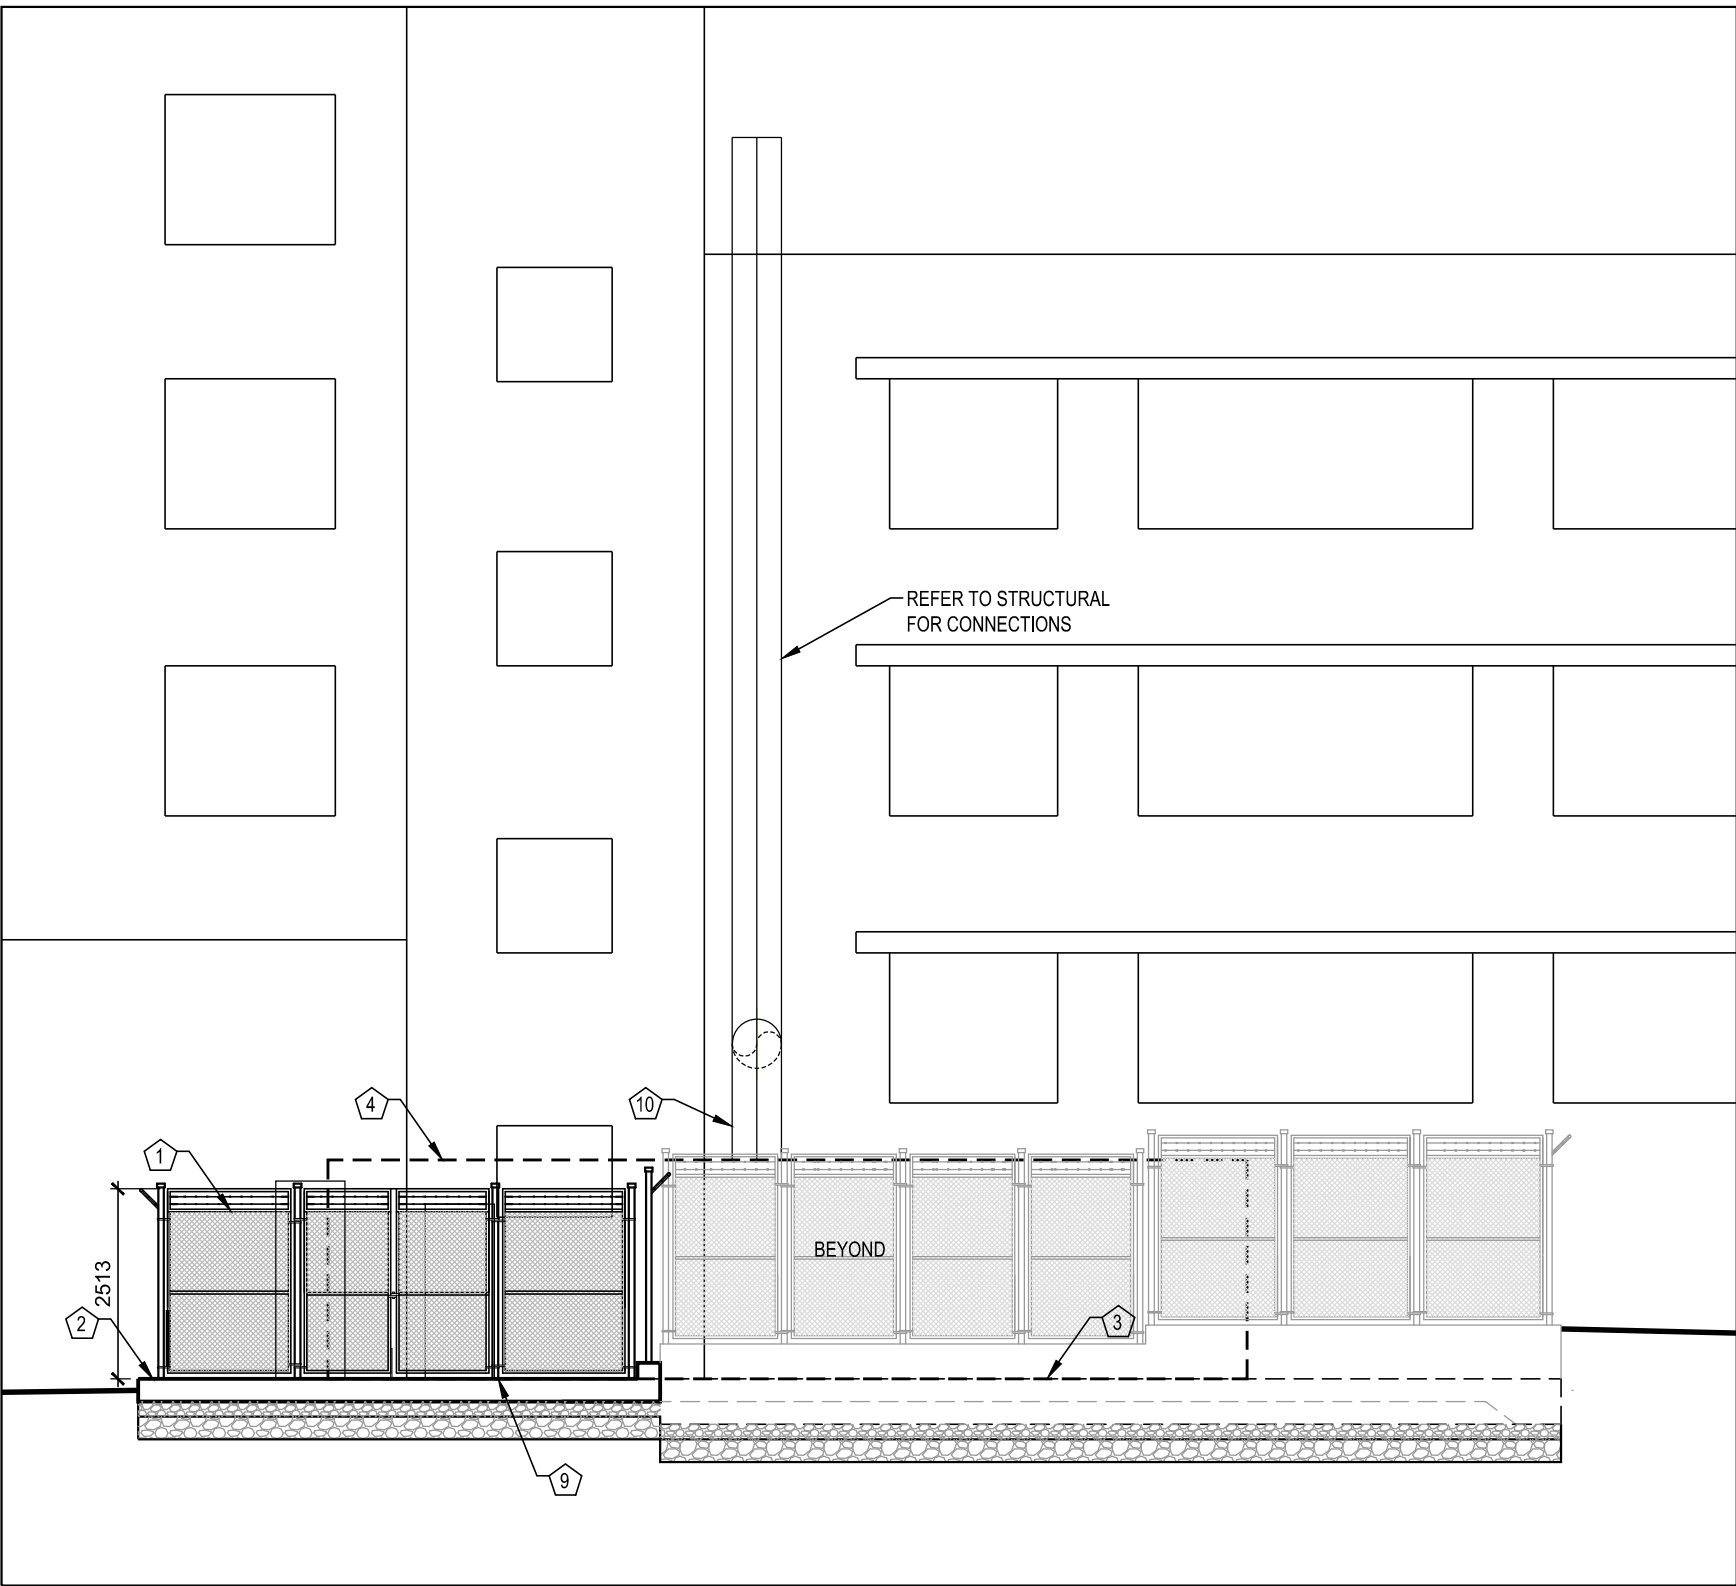


2 555 BOOTH STREET SECTIONAL ELEVATION
SCALE 1:100

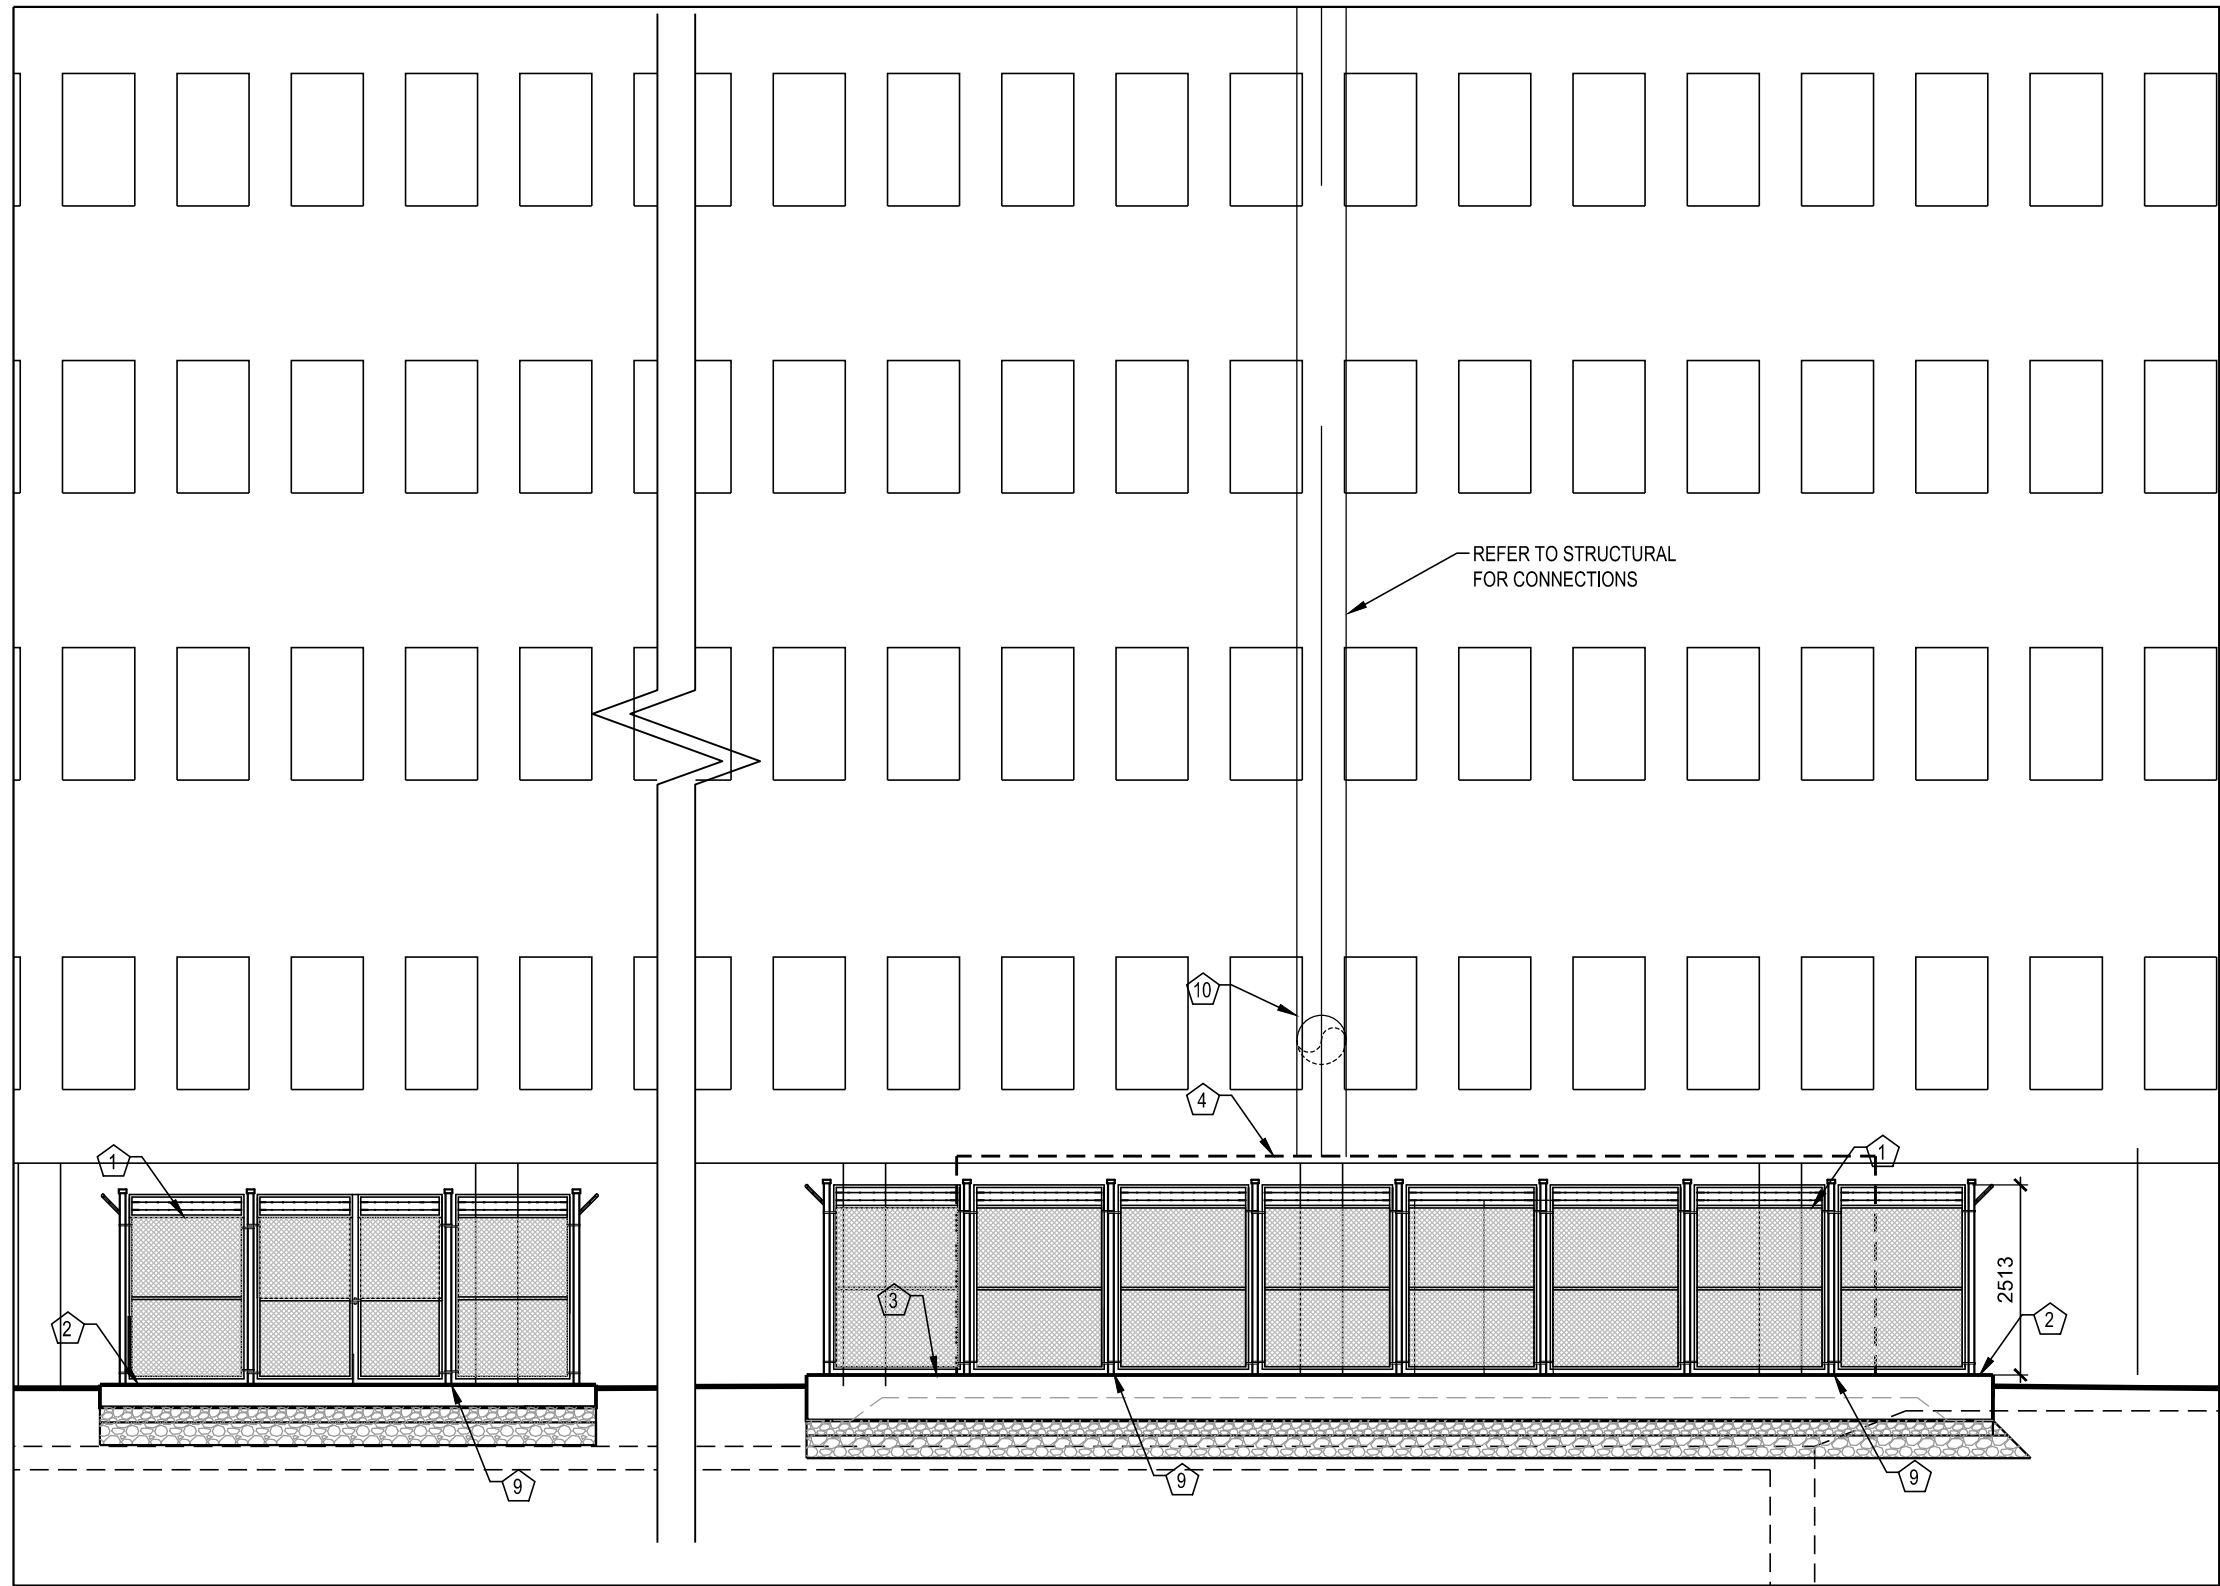

4 601 BOOTH STREET SECTIONAL ELEVATION
SCALE 1:100

DRAWING NOTES

- 1 NON-CLIMABLE CHAIN LINK FENCE AND GATE. REFER TO DETAILS 1/A300 AND 2/A300.
- 2 SLOPED CONCRETE SLAB C/W 50mm OF HIGH DENSITY RIGID INSULATION AND COMPACTED GRANULAR 'A' AND 'B'. EXCAVATE SOD AND TOPSOIL. REFER TO DETAIL 1/A300. REFER TO STRUCTURAL AND CIVIL. FINAL LOCATION AND SIZE OF SLAB TO BE VERIFIED WITH ENBRIDGE.
- 3 CONCRETE SLAB W/ SLAB THICKENING AT PERIMETER C/W 50mm OF HIGH DENSITY RIGID INSULATION AND COMPACTED GRANULAR 'A' AND 'B'. EXCAVATE SOD AND TOPSOIL. REFER TO DETAIL 1/A300.
- 4 RENTAL BOILER. REFER TO MECHANICAL.
- 5 150mm DEEP 20mm ROUGH DIA. RIVERSTONE C/W LANDSCAPE FILTER FABRIC AND 300mm DEEP COMPACTED GRANULAR 'A'. EXCAVATE EXISTING SOD AND TOPSOIL.
- 6 REMOVE AND SALVAGE EXISTING BRICK 1200mm x 1200mm TO ALLOW FOR STRUCTURAL INSTALLATION. REINSTALL BRICK AND SEAL AROUND STRUCTURAL PENETRATIONS. REFER TO MECHANICAL AND STRUCTURAL FOR LOCATIONS. REFER TO DETAIL 7/A300 AND 8/A300
- 7 MECHANICAL DOG HOUSE. REFER TO DETAIL 4/A300.
- 8 FENCE POST TO BE FASTENED TO EXISTING WALL. REFER TO DETAIL 1/A300.
- 9 FENCE POST DRILLED INTO CONCRETE AT 100mm Ø AND CAST IN PLACE. REFER TO DETAIL 2/A300.
- 10 MECHANICAL VENT. REFER TO MECHANICAL. REFER TO STRUCTURAL FOR WALL CONNECTORS.
- 11 CONCRETE PIER FOR FENCE POST. REFER TO DETAIL 2/A300.

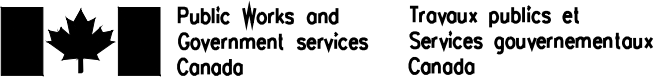

National Centre of Expertise
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Direction générale des services immobiliers

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DESIGN BUILD · PROJECT MANAGEMENT



KEY PLAN
PLAN—REPÈRE

04	ISSUED FOR TENDER	2014/12/10
03	ISSUED FOR TRANSLATION	2014/11/18
02	ISSUED FOR 99% REVIEW	2014/07/14
01	ISSUED FOR 66% REVIEW	2014/05/30

revision		date
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A	A detail no. no. du détail	A
C	B location drawing no. no. de localisation	BC
	C drawing no. no. du dessin	

project project

555/601 BOOTH
STAND ALONE
HEATING PLANT

drawing dessin

555/601
BOOTH STREET
ELEVATIONS

designed conçu

V.ALCAIDE

date dessiné

drawn N.CROSS

date

revised N.CROSS

date révisé

approved V.ALCAIDE

date approuvé

tender soumission

PWC Project Manager C. CAMPBELL

Administrateur de projets TPC

project no. no. du projet

R.060128.002

drawing no. no. du dessin

A200

