




1 555 BOOTH STREET SECTIONAL ELEVATION
SCALE 1:100

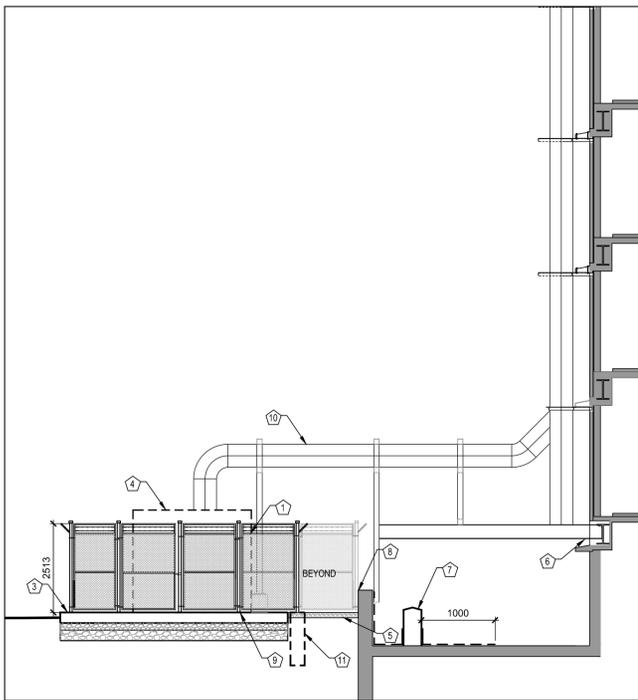

3 601 BOOTH STREET SECTIONAL ELEVATION
SCALE 1:100

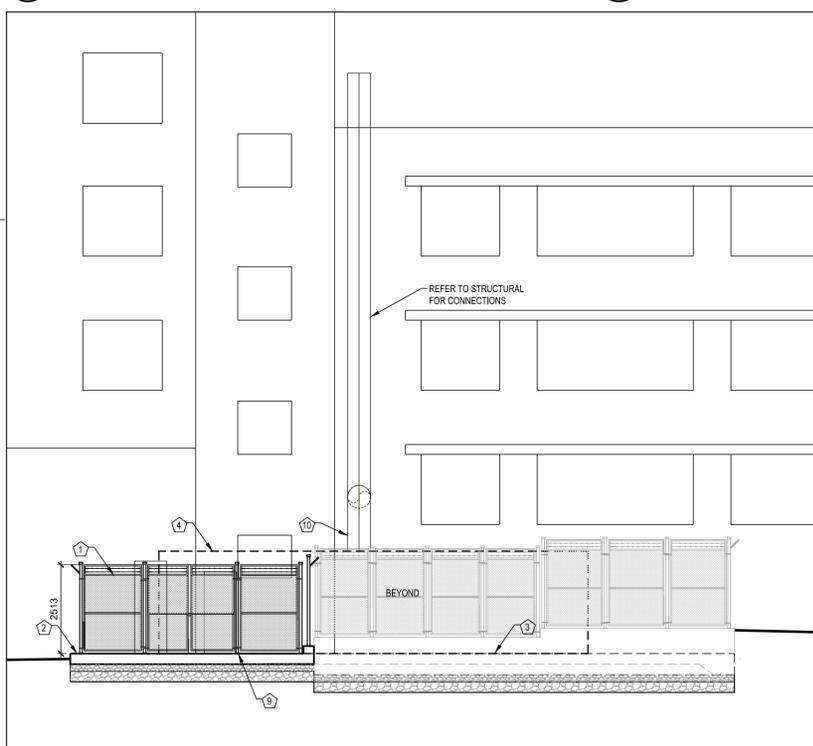

2 555 BOOTH STREET SECTIONAL ELEVATION
SCALE 1:100

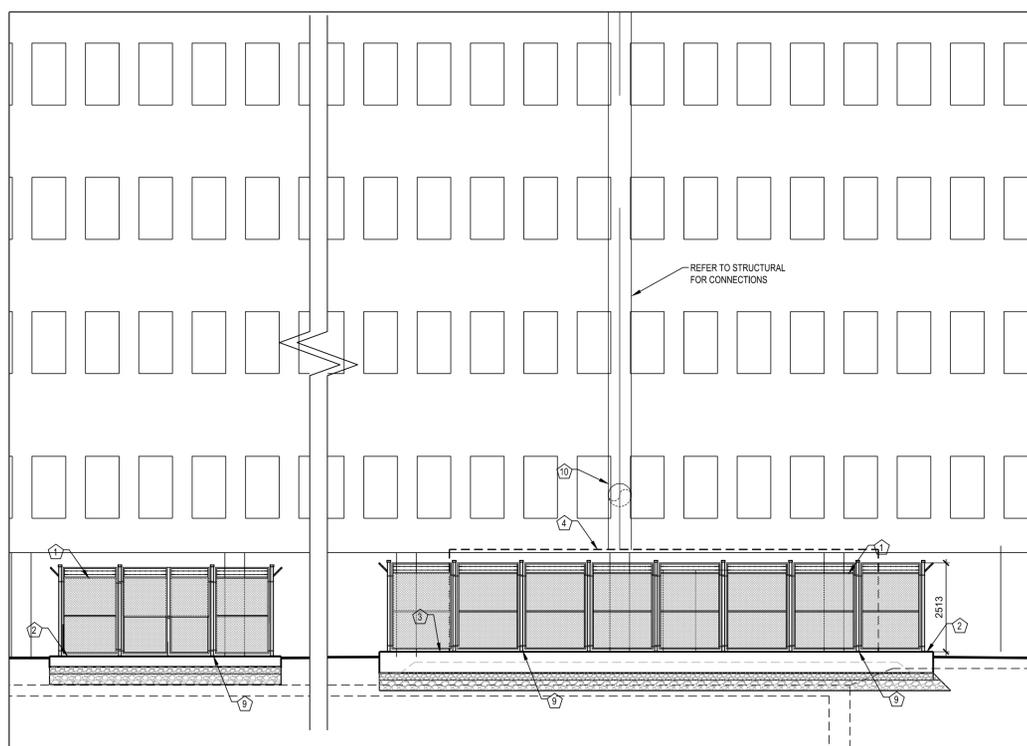

4 601 BOOTH STREET SECTIONAL ELEVATION
SCALE 1:100

- ### DRAWING NOTES
- 1 NON-CLIMBABLE CHAIN LINK FENCE AND GATE. REFER TO DETAILS 1/A300 AND 2/A300.
 - 2 SLOPED CONCRETE SLAB C/W 50mm OF HIGH DENSITY RIGID INSULATION AND COMPACTED GRANULAR 'A' AND 'B'. EXCAVATE SOD AND TOPSOIL. REFER TO DETAIL 1/A300. REFER TO STRUCTURAL AND CIVIL. FINAL LOCATION AND SIZE OF SLAB TO BE VERIFIED WITH ENBRIDGE.
 - 3 CONCRETE SLAB W/ SLAB THICKENING AT PERIMETER C/W 50mm OF HIGH DENSITY RIGID INSULATION AND COMPACTED GRANULAR 'A' AND 'B'. EXCAVATE SOD AND TOPSOIL. REFER TO DETAIL 1/A300.
 - 4 RENTAL BOILER. REFER TO MECHANICAL.
 - 5 150mm DEEP 20mm ROUGH DIA. RIVERSTONE C/W LANDSCAPE FILTER FABRIC AND 300mm DEEP COMPACTED GRANULAR 'A'. EXCAVATE EXISTING SOD AND TOPSOIL.
 - 6 REMOVE AND SALVAGE EXISTING BRICK 1200mm x 1200mm TO ALLOW FOR STRUCTURAL INSTALLATION. REINSTALL BRICK AND SEAL AROUND STRUCTURAL PENETRATIONS. REFER TO MECHANICAL AND STRUCTURAL FOR LOCATIONS. REFER TO DETAIL 7/A300 AND 8/A300.
 - 7 MECHANICAL DOG HOUSE. REFER TO DETAIL 4/A300.
 - 8 FENCE POST TO BE FASTENED TO EXISTING WALL. REFER TO DETAIL 1/A300.
 - 9 FENCE POST DRILLED INTO CONCRETE AT 100mm Ø AND CAST IN PLACE. REFER TO DETAIL 2/A300.
 - 10 MECHANICAL VENT. REFER TO MECHANICAL. REFER TO STRUCTURAL FOR WALL CONNECTORS.
 - 11 CONCRETE PIER FOR FENCE POST. REFER TO DETAIL 2/A300.

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KEY PLAN
PLAN-REPÈRE

O4	ISSUED FOR TENDER	2014/12/10
O3	ISSUED FOR TRANSLATION	2014/11/18
O2	ISSUED FOR 99% REVIEW	2014/07/14
O1	ISSUED FOR 66% REVIEW	2014/05/30
revision		date

A detail no. / no. du détail
B location drawing no. / no. de localisation
C drawing no. / no. du dessin

project / projet

555/601 BOOTH STAND ALONE HEATING PLANT

drawing / dessin

555/601 BOOTH STREET ELEVATIONS

designed / conçu

V.ALCAIDE

date / dessin

N.CROSS

date / révisé

N.CROSS

approved / approuvé

V.ALCAIDE

date / soumission

C. CAMPBELL

PWC Project Manager / Administrateur de projets TPC

project no. / no. du projet

R.060128.002

drawing no. / no. du dessin

A200