




SCHEDULE															
DOOR NO.	FROM	TO	DOOR						FRAME			HAND	FIRE RATING (HR)	HARD-WARE	REMARKS
			TYPE	WIDTH	HEIGHT	THICK	MATERIAL	FINISH	TYPE	MATERIAL	FINISH				
D100.1	1W 104	1W 100	4	914	2134	45	WOOD	W1	B	HM	P6	LH		H1	
D101.1	1W 104	1W 101	4	914	2134	45	WOOD	W1	B	HM	P6	RH		H1	
D103.1	1W 104	1W 103	4	914	2134	45	WOOD	W1	A	HM	P6	LH		H2	DOOR FRAME ASSEMBLY TO BE STC 52
D104.1	1W 108	1W 104	4	914	2134	45	WOOD	W1	B	HM	P6	RH		H3	
D106.1	1W 108	1W 106	1	914	2134	45	WOOD	W1	A	HM	P6	LH		H14	
D107.1	1W 107	1W 108	3	914	2134	45	METAL	P6	A	PS	P6	RHR	1.5 HR	H13	
D107.2	1W 120	1W 107	3	914	2134	45	METAL	P9	A	PS	P9	RH	1.5 HR	H6	
D107.3	1W 107	1W 107	3	914	2134	45	METAL	P9	A	PS	P9	RH	1.5 HR	H6	
D109.1	1W 108	1W 109	4	914	2134	45	WOOD	W1	B	HM	P6	LH		H1	
D110.1	1W 108	1W 110	4	914	2134	45	WOOD	W1	B	HM	P6	LH		H1	
D111.1	1W 108	1W 111	4	914	2134	45	WOOD	W1	B	HM	P6	RH		H1	
D112.1	1W 108	1W 112	4	914	2134	45	WOOD	W1	B	HM	P6	LH		H1	
D113.1	1W 108	1W 113	4	914	2134	45	WOOD	W1	B	HM	P6	RH		H1	
D114.1	1W 108	1W 114	1	914	2134	45	WOOD	W1	A	HM	P6	LH		H4	
D117.1	1W 120	1W 117A	4	914	2134	45	WOOD	W1	B	HM	P6	LH		H7	
D117.2	1W 120	1W 117B	4	914	2134	45	WOOD	W1	B	HM	P6	RH		H7	
D118.1	1W 120	1W 118	4	914	2134	45	WOOD	W1	A	HM	P6	RH		H14	
D119.1	1W 108	1W 119	4	914	2134	45	WOOD	W1	B	HM	P6	RH		H7	
D120.1	1W 120	1W 108	2	914	2134	45	METAL	P9	A	HM	P6	RHR		H5	
D121.1	1W 120	1W 121	3	1115	2134	45	METAL	P9	A	PS	P6	RH	1.5 HR	H6	
D122.1	1W 120	1W 122	5	914	2134	45	GLASS		D	ALUM		RH		H9	KITCHEN
D123.1	1W 129	1W 123	4	914	2134	45	WOOD	W1	B	HM	P6	RH		H1	
D124.1	1W 129	1W 124	1	914	2134	45	WOOD	W1	A	HM	P6	RH		H4	
D125.1	1W 129	1W 125	1	914	2134	45	WOOD	W1	A	HM	P6	LH		H4	
D126.1	1W 120	1W 126	3	914	2134	45	METAL	P6	A	PS	P6	LH	1.5 HR	H8	
D127.1	1W 132	1W 127	4	914	2134	45	WOOD	W1	B	HM	P6	LH		H7	
D128.1	1W 132	1W 128	4	914	2134	45	WOOD	W1	B	HM	P6	RH		H1	
D130.1	1W 132	1W 130	4	914	2134	45	WOOD	W1	E	HM	P6	LH		H7	
D132.1	1W 120	1W 132	2	914	2134	45	METAL	P6	A	HM	P6	LHR		H5	
D133.1	1W 132	1W 133	4	914	2134	45	WOOD	W1	B	HM	P6	RH		H1	
D134.1	1W 132	1W 134	4	914	2134	45	WOOD	W1	B	HM	P6	LH		H14	
D135.1	1W 132	1W 135	4	914	2134	45	WOOD	W1	B	HM	P6	RH		H7	
D136.1	1W 132	1W 136	4	914	2134	45	WOOD	W1	B	HM	P6	LH		H1	
D137.1	1W 132	1W 137	4	914	2134	45	WOOD	W1	B	HM	P6	RH		H1	
D138.1	1W 132	1W 138	4	914	2134	45	WOOD	W1	B	HM	P6	LH		H1	
D139.1	1W 132	1W 139	4	914	2134	45	WOOD	W1	B	HM	P6	RH		H1	
D141.1	1W 120	1W 143	2	914	2134	45	METAL	W1	A	HM	P6	RHR		H5	
D142.1	1W 143	1W 142	4	914	2134	45	WOOD	W1	B	HM	P6	RH		H7	
D143.1	1W 143	1W 146	4	914	2134	45	METAL	P6	A	PS	P6	RH		H11	
D144.1	1W 146	1W 144	4	914	2134	45	WOOD	P6	B	HM	P6	LH		H1	
D145.1	1W 146	1W 145	4	914	2134	45	METAL	W1	A	HM	P6	LH		H10	
D146.1	1W 147	1W 146	2	914	2134	45	WOOD	W1	A	HM	P6	RHR		H3	
D147.1	1W 148	1W 147	3	914	2134	45	METAL	P6	A	PS	P6	LHR	1.5 HR	H15	
D148.1	1W 120	1W 148	4	1066	2134	45	METAL	P6	C	PS	P9	LH	1.5 HR	H12	
D149.1	1W 129	1W 120	4	914	2134	45	METAL	P6	A	PS	P6	RH		H11	
D150.1	1W 149	1W 150	1	914	2134	45	WOOD	W1	A	HM	P6	RH		H4	
D151.1	1W 120	1W 151	4	914	2134	45	WOOD	W1	B	HM	P6	RH		H7	
D153.1	1W 149	1W 153	4	914	2134	45	WOOD	W1	B	HM	P6	RH		H1	
D154.1	1W 149	1W 154	4	914	2134	45	WOOD	W1	B	HM	P6	RH		H7	
D155.1	1W 149	1W 155	4	914	2134	45	WOOD	W1	B	HM	P6	LH		H1	
D156.1	1W 149	1W 156	4	914	2134	45	WOOD	W1	B	HM	P6	RH		H14	
D157.1	1W 149	1W 120	4	914	2134	45	METAL	P6	A	PS	P6	RH		H11	
D158.1	1W 120	1W 121	4	914	2134	45	METAL	P6	A	PS	P6	RH	1.5 HR	H6	
D159.0	NOT IN USE														
E160.1	127	STAIR			EXISTING			P9	EXISTING		P8	EXISTING			
E161.1	121	ELEC			EXISTING			P9	EXISTING		P9	EXISTING			
E162.1	121	STAIR			EXISTING			P9	EXISTING		P9	EXISTING			
E163.1	121	OTHER TENANT			EXISTING			P9	EXISTING		P9	EXISTING			
E164.1	120	MECH.			EXISTING			P9	EXISTING		P9	EXISTING			
E165.1	120	MECH.			EXISTING			P9	EXISTING		P9	EXISTING			
E166.1	149	ATRIUM			EXISTING			P8	EXISTING		P8	EXISTING			DOOR, FRAME & MULLIONS ALL P8
E167.1	120	WOMEN WASH.			EXISTING			P9	EXISTING		P9	EXISTING			

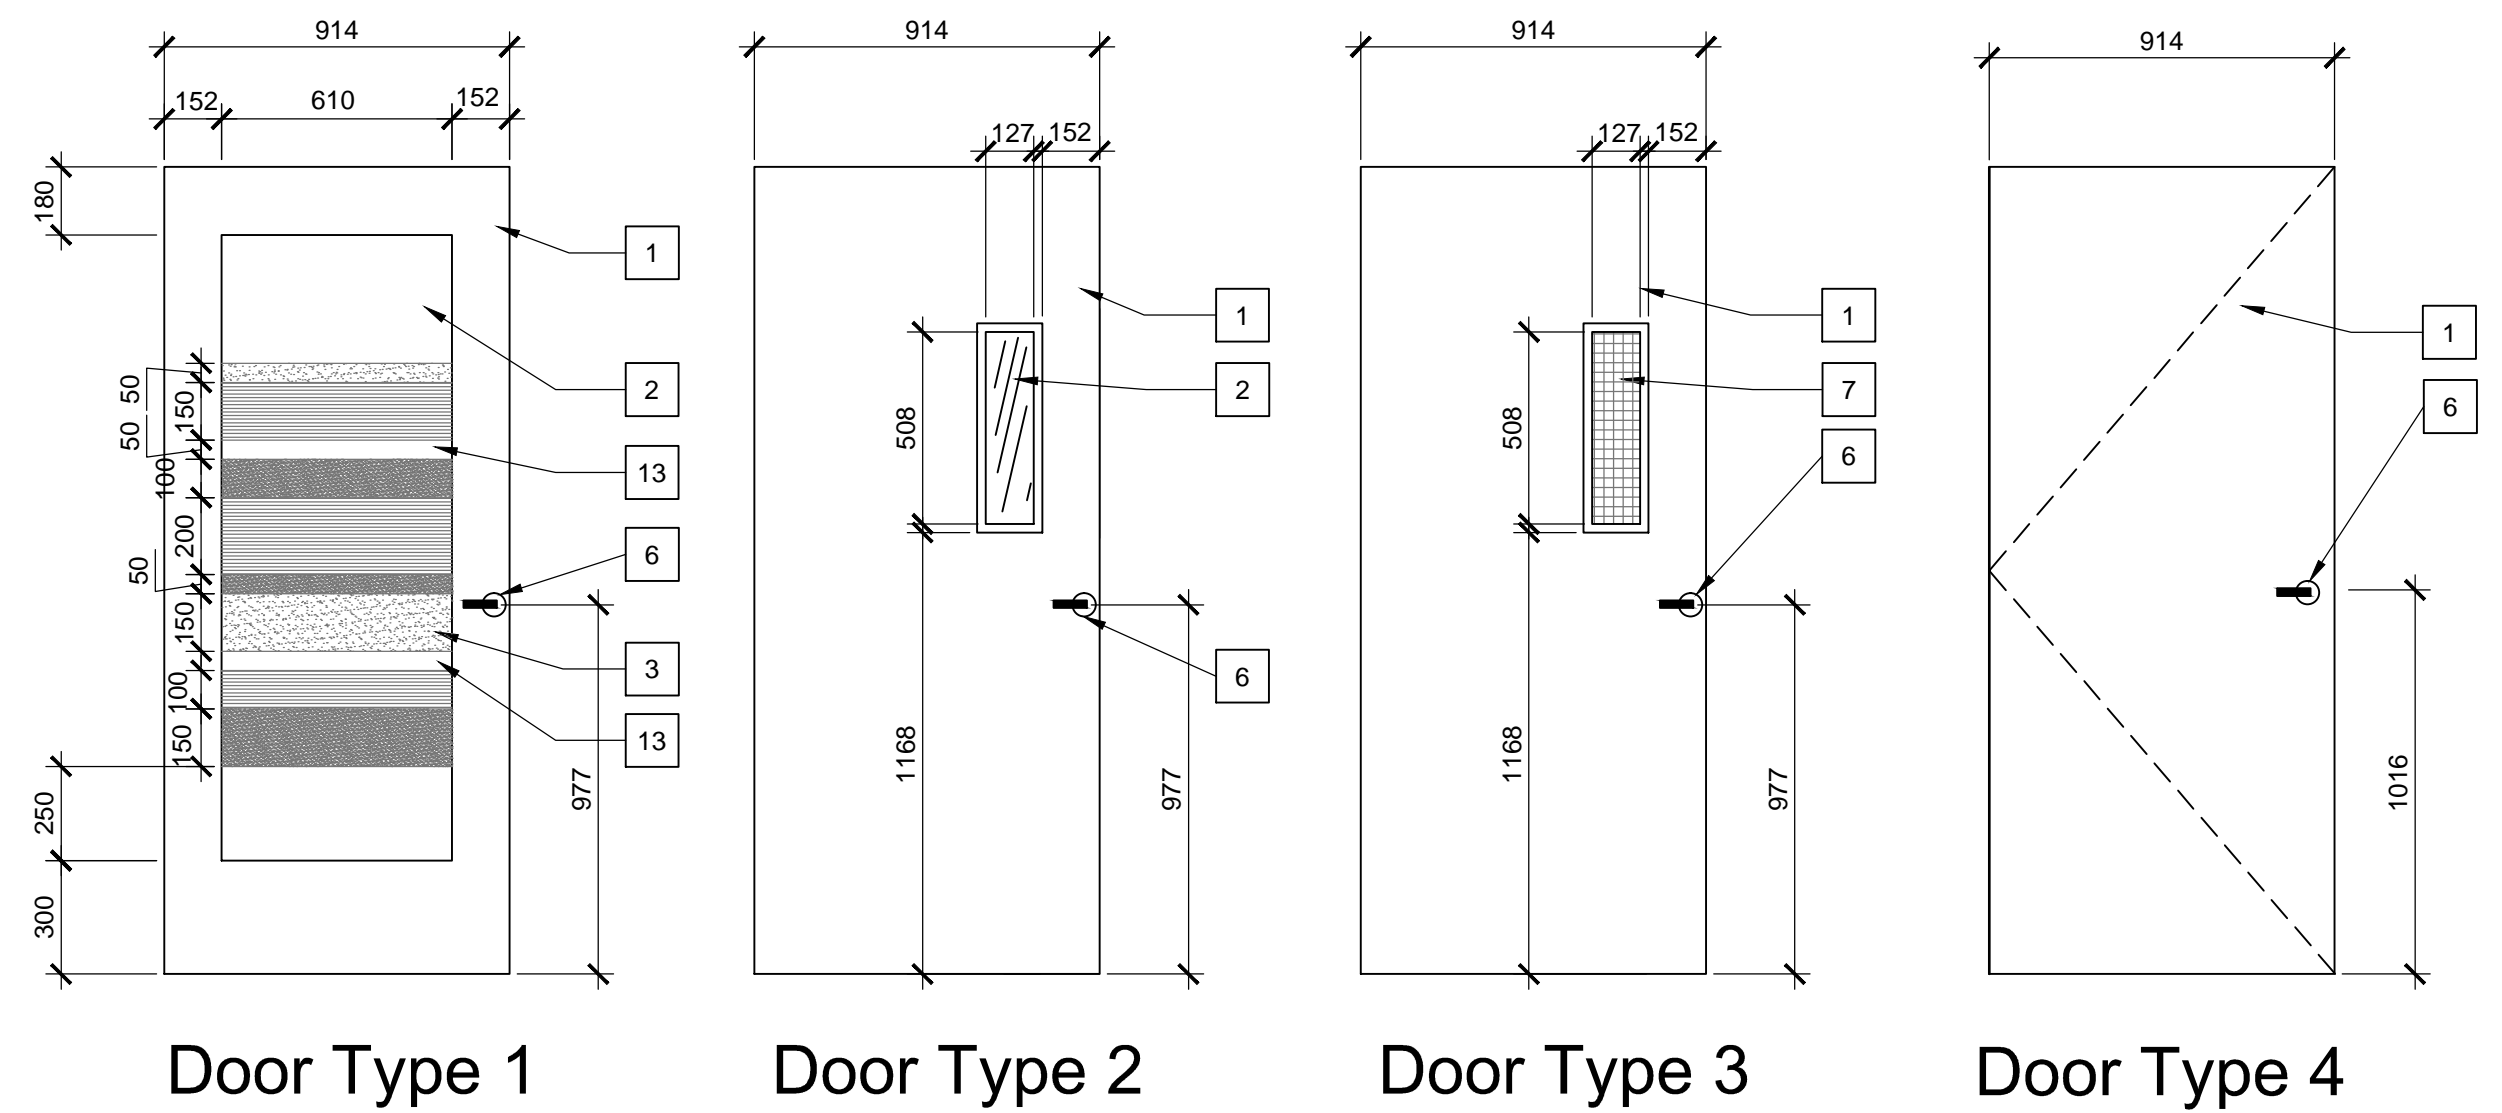

1
A505
TYPICAL DOOR TYPE ELEVATIONS
(REF. DOOR SCHEDULE)
SCALE 1:20

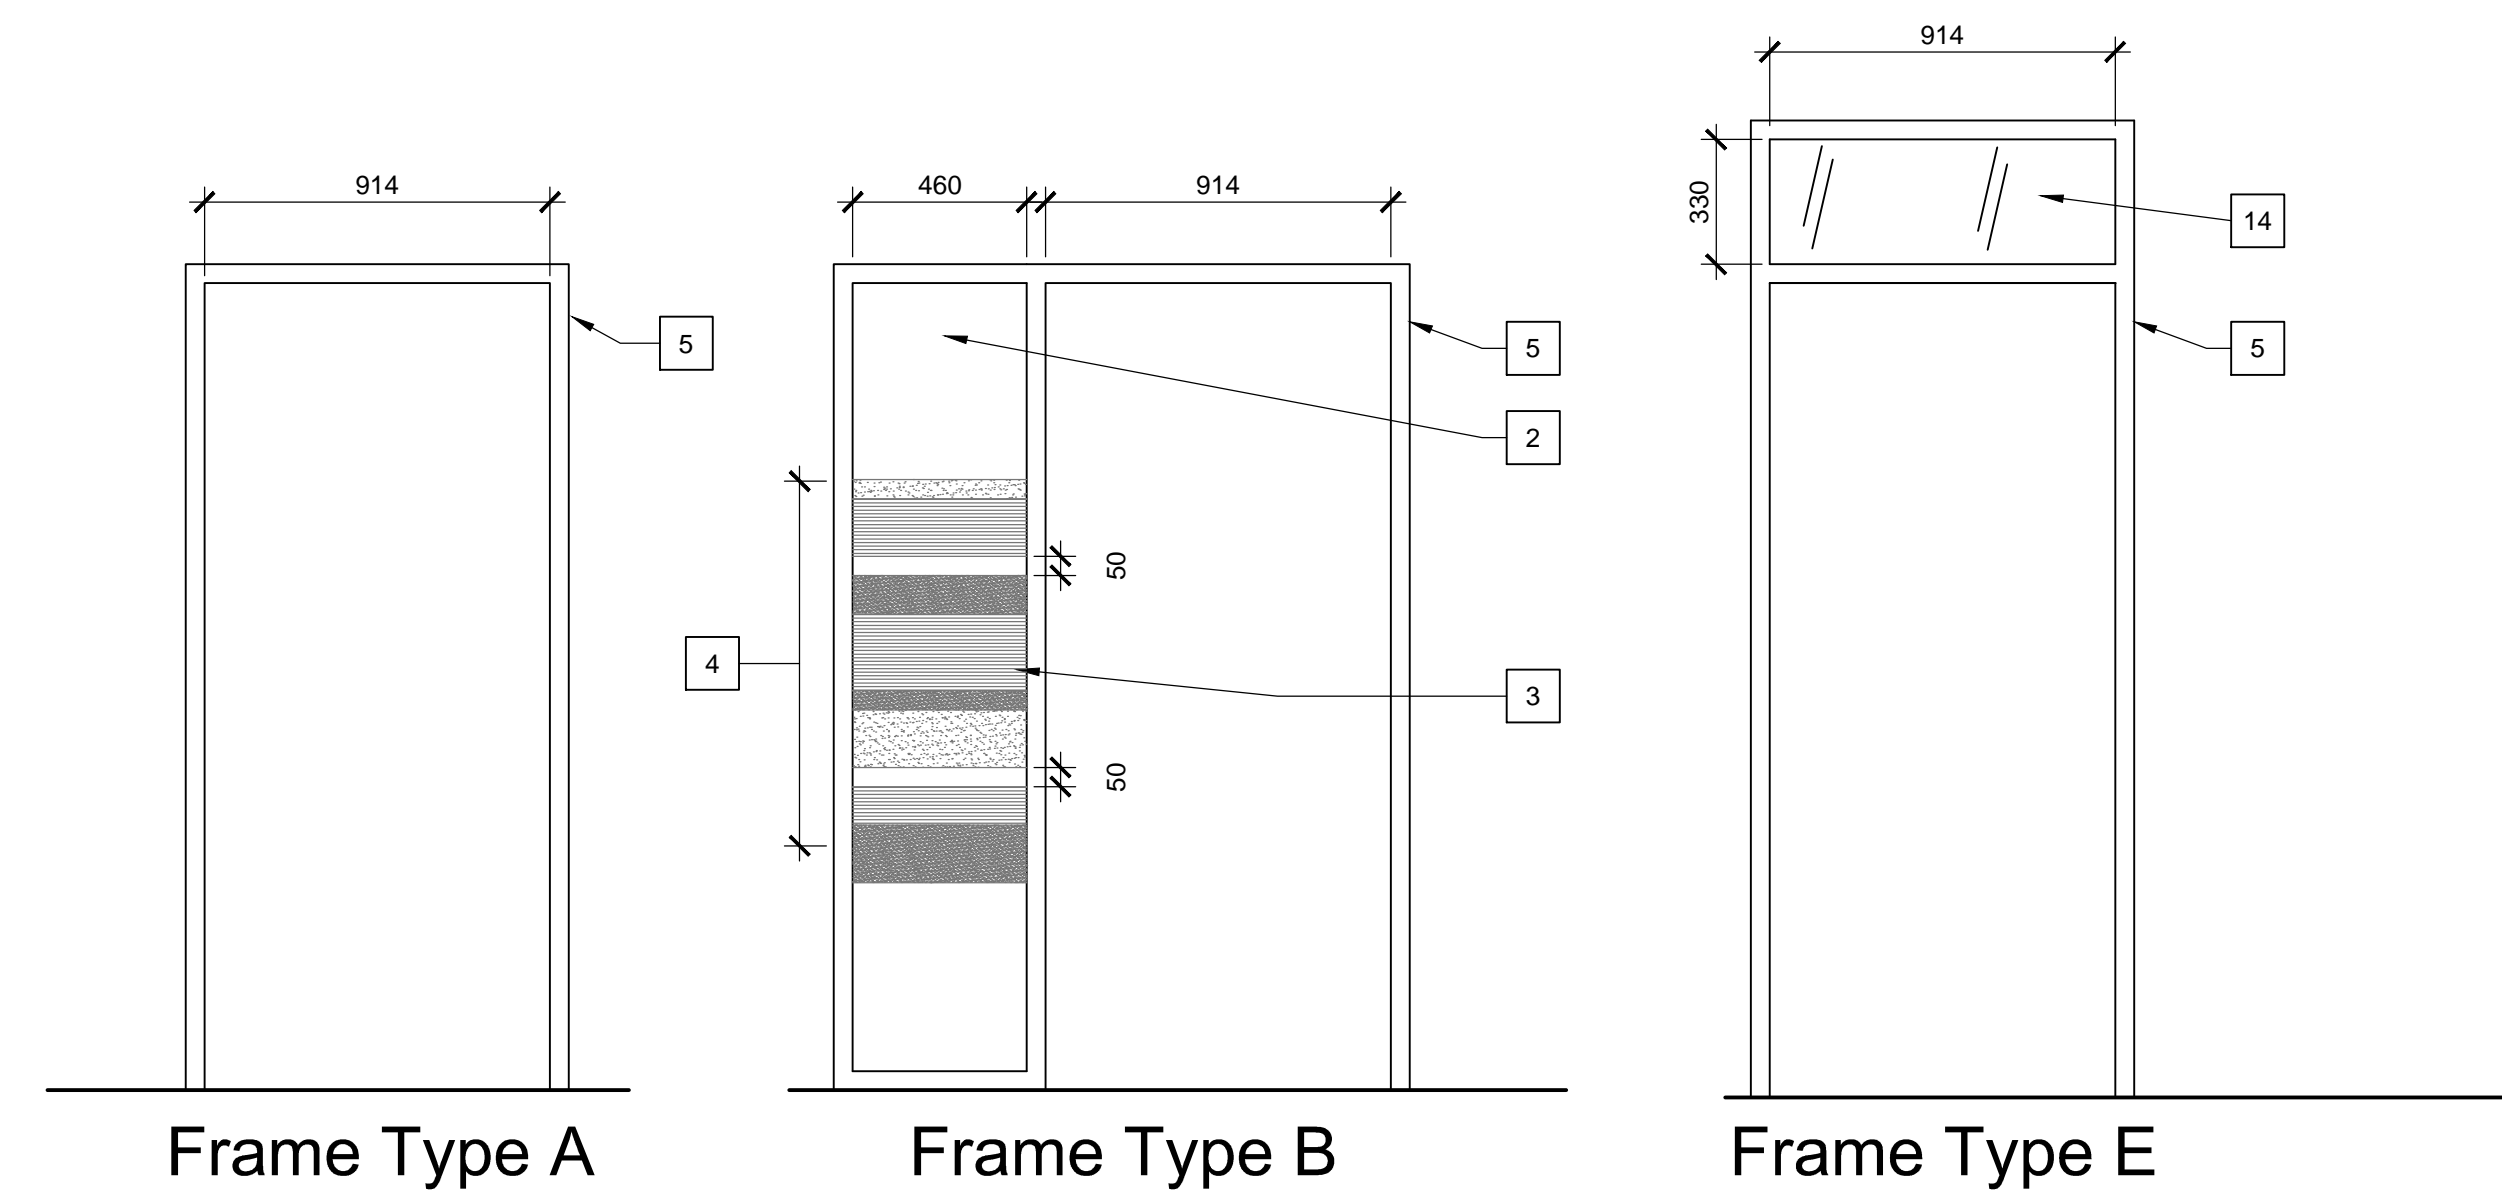

3
A505
TYPICAL DOOR FRAME ELEVATIONS
(REF. DOOR SCHEDULE)
SCALE 1:20

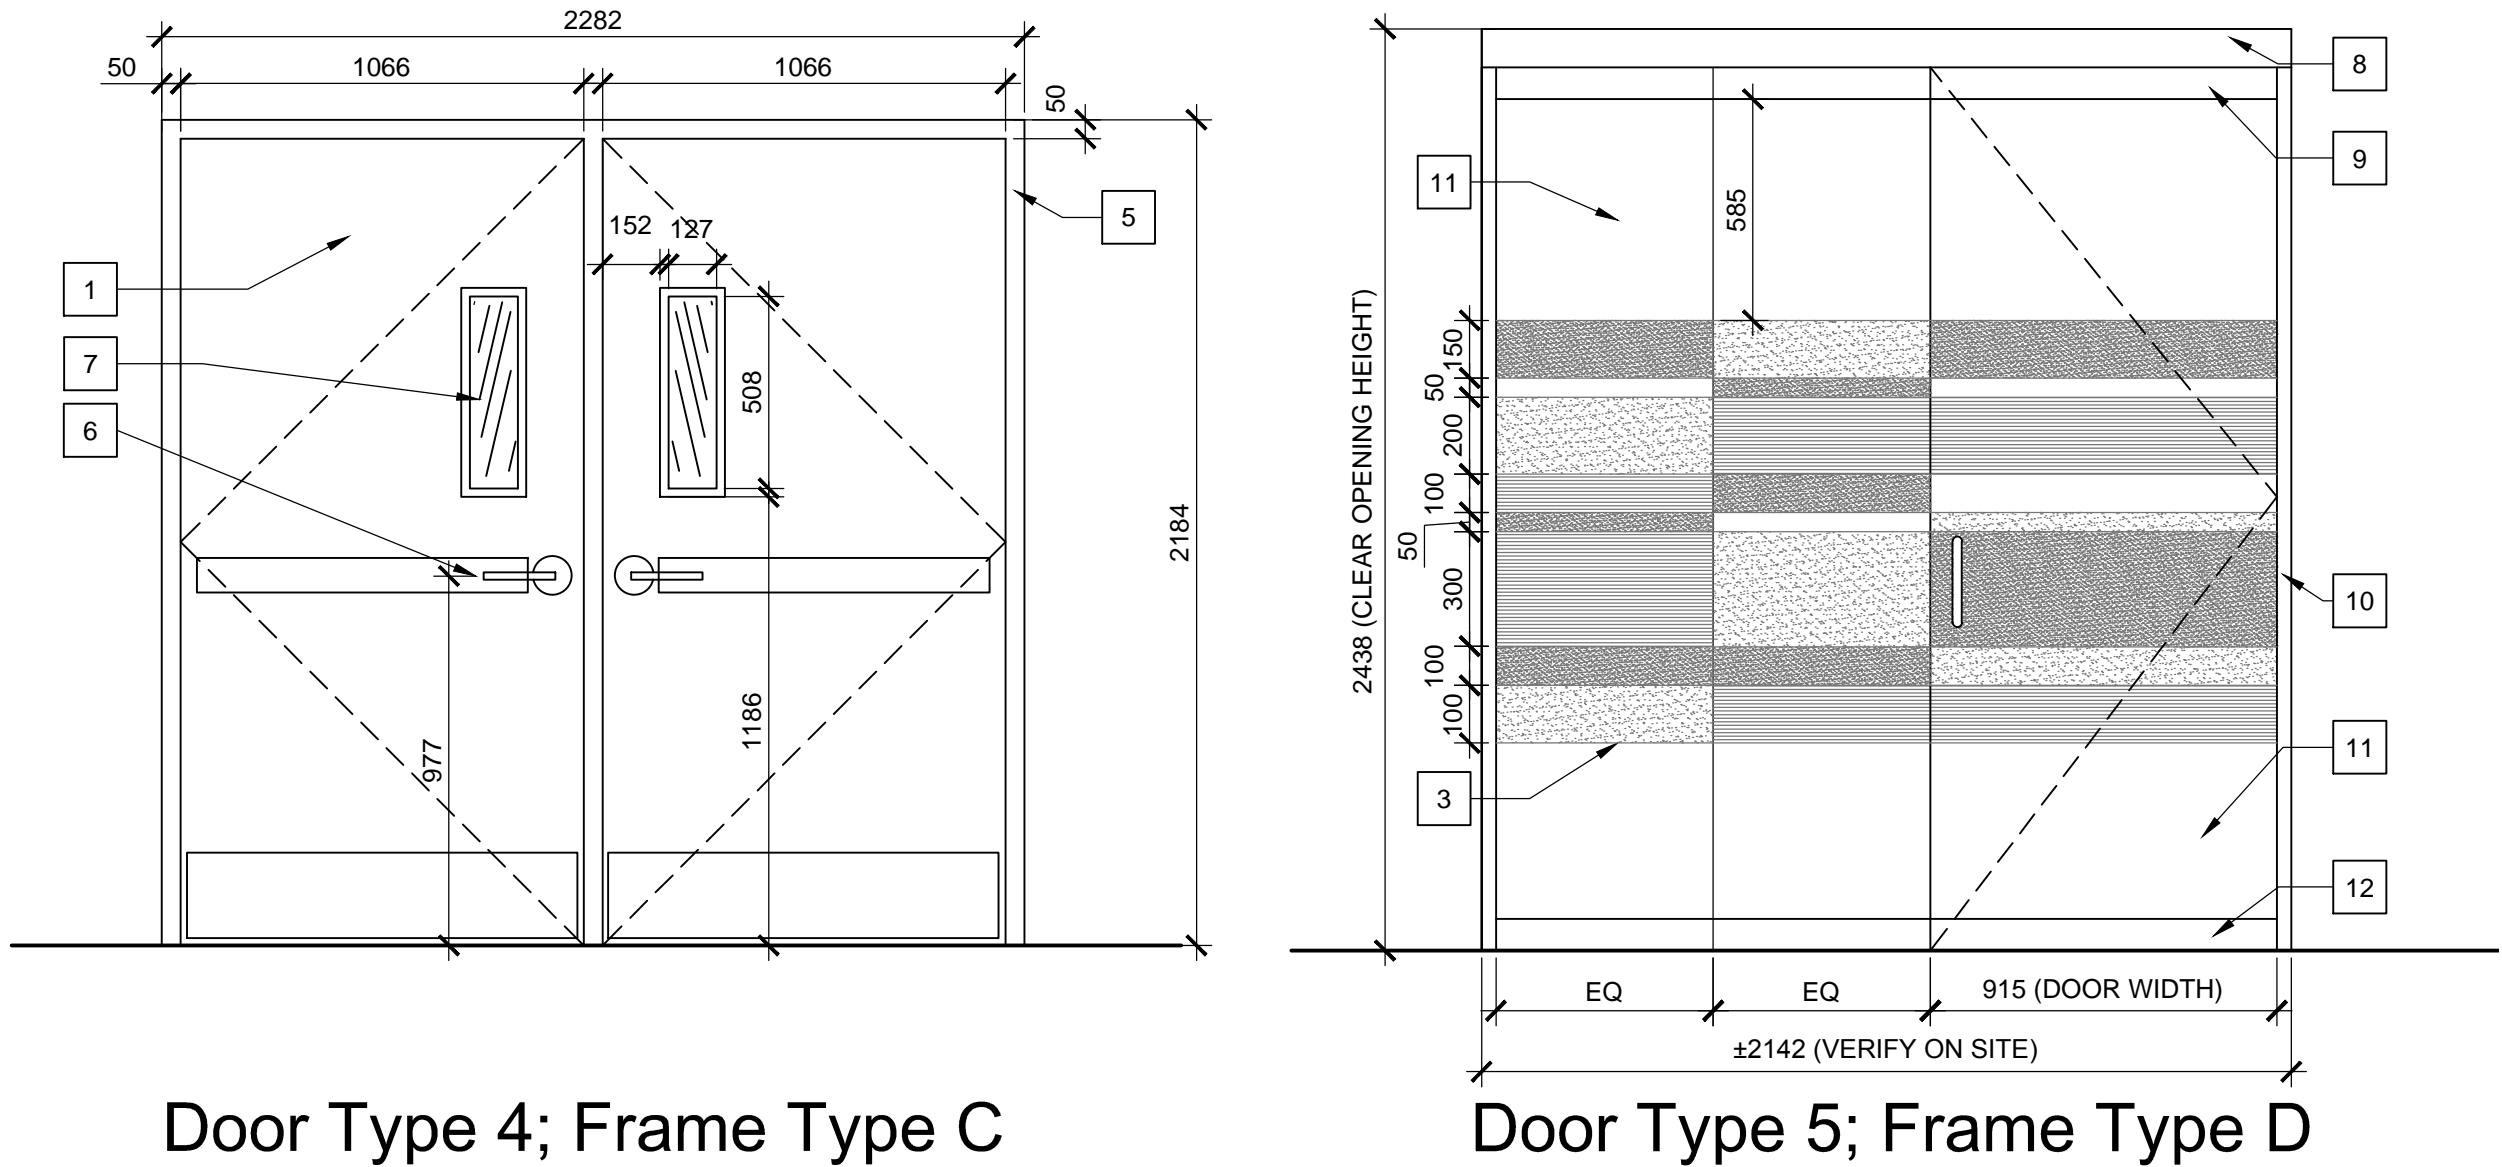

2
A505
DOOR & FRAME ELEVATIONS
(REF. DOOR SCHEDULE)
SCALE 1:20

E168.1	120	MENS WASH.	←	EXISTING	→	P9	←	EXISTING	→	P9	←	EXISTING	→	
E169.1	120	ELEC.	←	EXISTING	→	P9	←	EXISTING	→	P9	←	EXISTING	→	
E170.1	148	FREIGHT LOBBY	←	EXISTING	→	P9	←	EXISTING	→	P9	←	EXISTING	→	
E171.1	1 EAST	1W148	←	EXISTING	→	P9	←	EXISTING	→	P9	←	EXISTING	→	

DRAWING NOTES, A505

- DOOR: REFER TO DOOR SCHEDULE FOR DIMENSIONS AND MATERIAL.
- 6mm CLEAR TEMPERED GLAZING IN FRAME OR DOOR AS INDICATED
- TRANSLUCENT FILM
- ALIGN TOP AND BOTTOM OF FILM WITH FILM ON DOORS.
- DOOR FRAME: REFER TO INDIVIDUAL DOOR SCHEDULES FOR DIMENSIONS AND MATERIAL.
- DOOR HARDWARE: REFER TO SPECIFICATIONS.
- GEORGIAN WIRED GLASS PANEL
- HEAD FRAME, STRUCTURALLY REINFORCED, CLEAR ANODIZED ALUMINUM FINISH.
- CONTINUOUS TOP RAIL.
- SIDE FRAMES, STRUCTURALLY REINFORCED, CLEAR ANODIZED ALUMINUM FINISH.
- TEMPERED GLASS DOOR & SIDELITE.
- CONTINUOUS BOTTOM RAIL.
- DISTANCE BETWEEN TRANSLUCENT FILM: 50mm.
- TRANSOM PANEL

DOOR & FRAME LEGEND:

PS PRESSED STEEL
HM HOLLOW METAL
ALUM ALUMINUM

DOOR FINISH LEGEND:

P PAINT (REFER TO WALL FINISHES DWG)
W1 WOOD VENEER - CLEAR MAPLE TO MATCH DESIGNER'S SAMPLE

DOOR GLAZING LEGEND:

F1 DECORATIVE FILM LIGHT FROST
F2 DECORATIVE FILM HEAVY FROST
F3 DECORATIVE FILM LINEAR PATTERN

GENERAL NOTES, A505

A. FLOOR TO SLAB HEIGHT: 3302± SITE CONFIRM.

Canada

PETER J. KINDREE
ARCHITECT

79 Hinton Avenue N.
Ottawa K1Y 0Z7
(613) 860-1530



L'ENTREPRENEUR DEVRA VÉRIFIER TOUTES LES DIMENSIONS ET LES CONDITIONS SUR LE CHANTIER ET AVISER SANS DÉLAI LE REPRÉSENTANT DU MINISTÈRE DE TOUTE ANOMALIE.
Contractor to verify all dimensions and conditions on site and immediately notify the departmental representative of all discrepancies.

6	ISSUED FOR ADDENDA NO. 1	2015/01/07
5	RE-ISSUE FOR TENDER	2014/11/04
4	ISSUED FOR TENDER	2014/10/20
3	ISSUED FOR 100% REVIEW	2014/10/02
2	ISSUED FOR 99% REVIEW	2014/08/15
1	ISSUED FOR 66% REVIEW	2014/7/9
revisions	description	date

A C	A detail no. no. du détail B location drawing no. sur dessin no. C drawing no. dessin no.	A B C
--------	--	-------------

project	project
1W FIT-UP & M&E UPGRADE	
OTTAWA, ONTARIO	
drawing	dessin
DOOR SCHEDULE, DOOR ELEVATIONS	
Designed By Date JUN./14	Conçu par (yyyy/mm/dd)
Drawn By Date JUL./14	Dessiné par (yyyy/mm/dd)
Reviewed By Date OCT./14	Examiné par (yyyy/mm/dd)
Approved By Date OCT./14	Approuvé par (yyyy/mm/dd)
Tender	Soumission
Project Manager Project no.	Administrateur de projets No. du projet
R.064703.002	
Drawing no.	No. du dessin
A505	