

PARTIAL BLDG. SITE MAP
N.T.S.

0	ISSUED FOR TENDER	JAN. 16 2015	date
revisions			

project
**ARGO BUILDING
BEDFORD INSTITUTE OF
OCEANOGRAPHY
DARTMOUTH, NS**


design
**DEMOLITION
EXISTING PLUMBING
AND SPRINKLER
FLOOR PLANS**

designed	F.A.M.	conçu
date	2015-01	
drawn	F.A.M.	dessiné
date	2015-01	
approved		approuvé
date		

Titulaire	Source
Project Manager	Administrateur de projet (PASC)
Project number	no. du projet
R.069793.001	
drawing no.	no. du dessin
H1 OF 2	

STORM DRAIN
NO. 2

4" FLOWS TO
HARBOUR

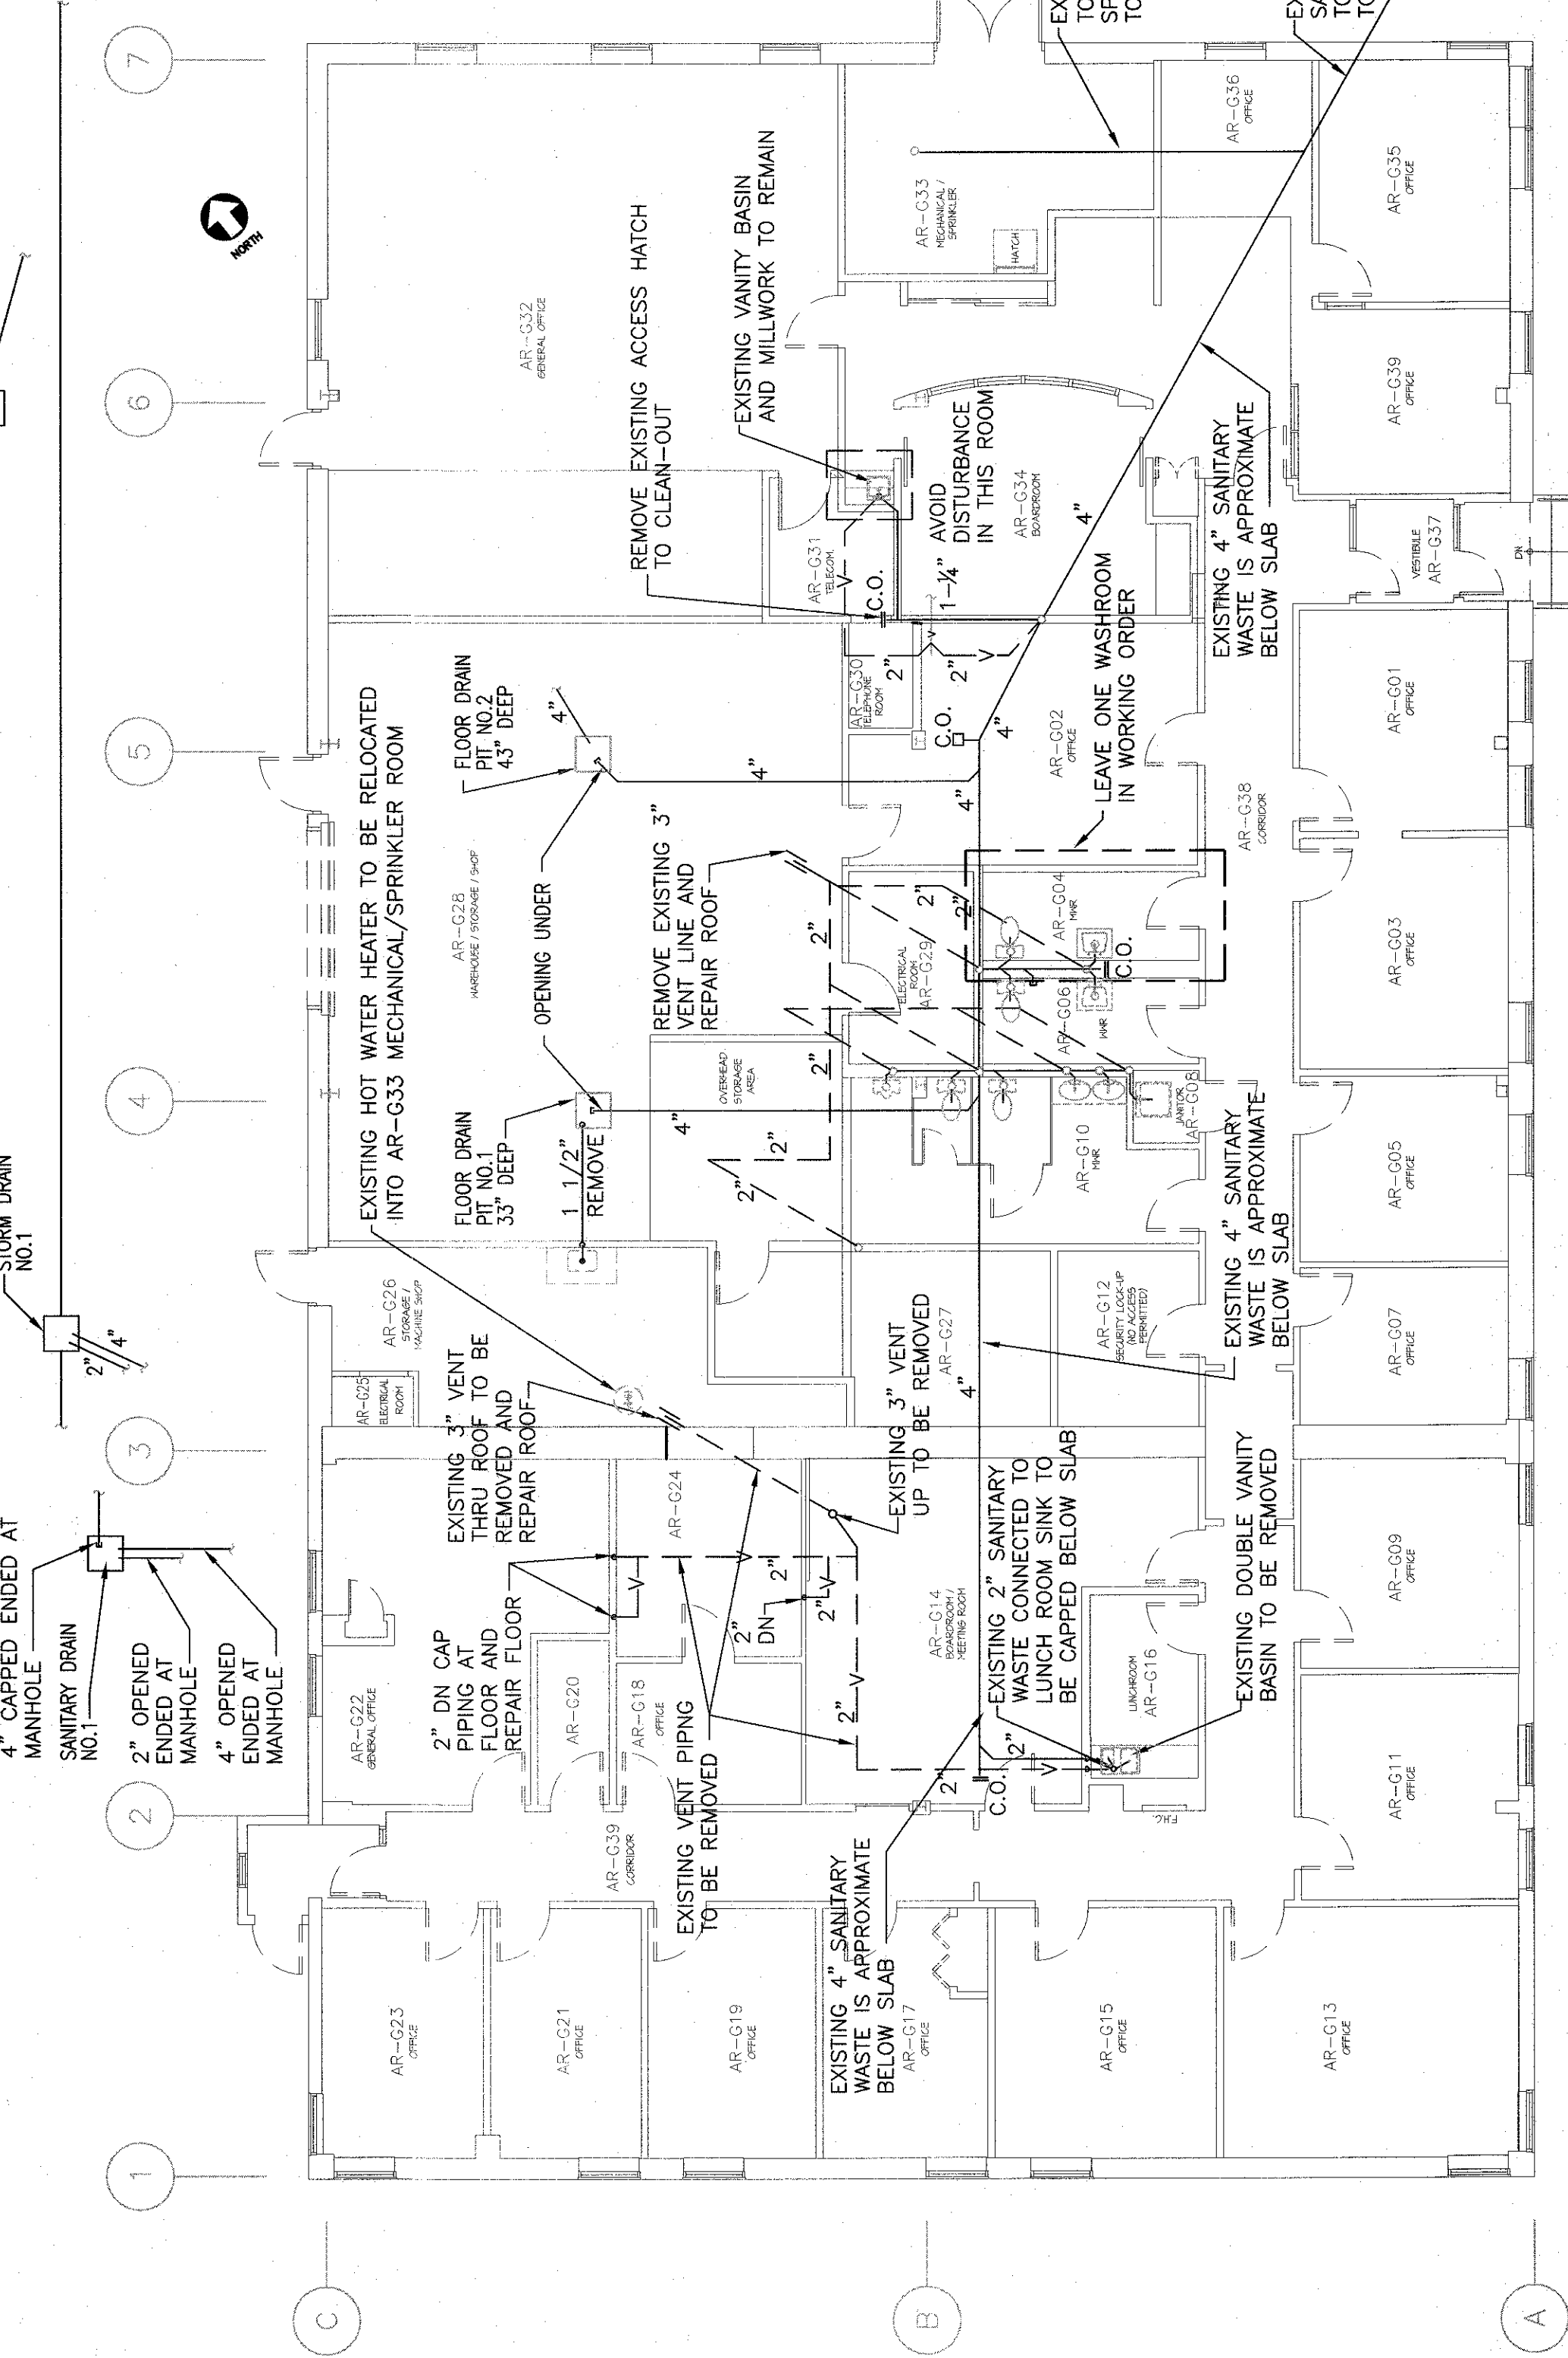

ARGO BUILDING GROUND LEVEL EXISTING PLUMBING

SCALE : 1:100
0m 1m 2m 3m 4m 5m 6m 7m 8m 9m 10m

PLUMBING WASTE NOTES:

- NOTE:
1. EXISTING SANITARY WASTE ROUTING LOCATION IN THE BUILDING IS APPROXIMATE.
 2. ALL EXISTING PLUMBING FIXTURES WASTES TO BE REMOVED AND CAPPED.

ARGO BUILDING GROUND LEVEL EXISTING WATER LINES

SCALE : 1:100
0m 1m 2m 3m 4m 5m 6m 7m 8m 9m 10m

PLUMBING HOT AND COLD WATER PIPING NOTES:


1. ALL EXISTING HOT AND COLD WATER PIPING WATER LINES ABOVE SLAB TO BE REMOVED. BACK TO MAIN MECHANICAL ROOM. EXCEPT THE MAIN WATER LINE THAT IS CONNECTED TO OFFICE BUNGLOW.
1. ALL EXISTING PLUMBING FIXTURES HOT AND COLD WATER PIPING TO BE REMOVED.

SPRINKLER LEGEND:

- EXISTING PENDENT TYPE SPRINKLER
- EXISTING PENDENT UPRIGHT TYPE SPRINKLER

SPRINKLER LEGEND:

1. ALL EXISTING SPRINKLER PING AND SPRINKLER HEADS TO REMAIN.
2. REMOVE ALL EXISTING PIPING TO FIRE HOSE CABINETS.

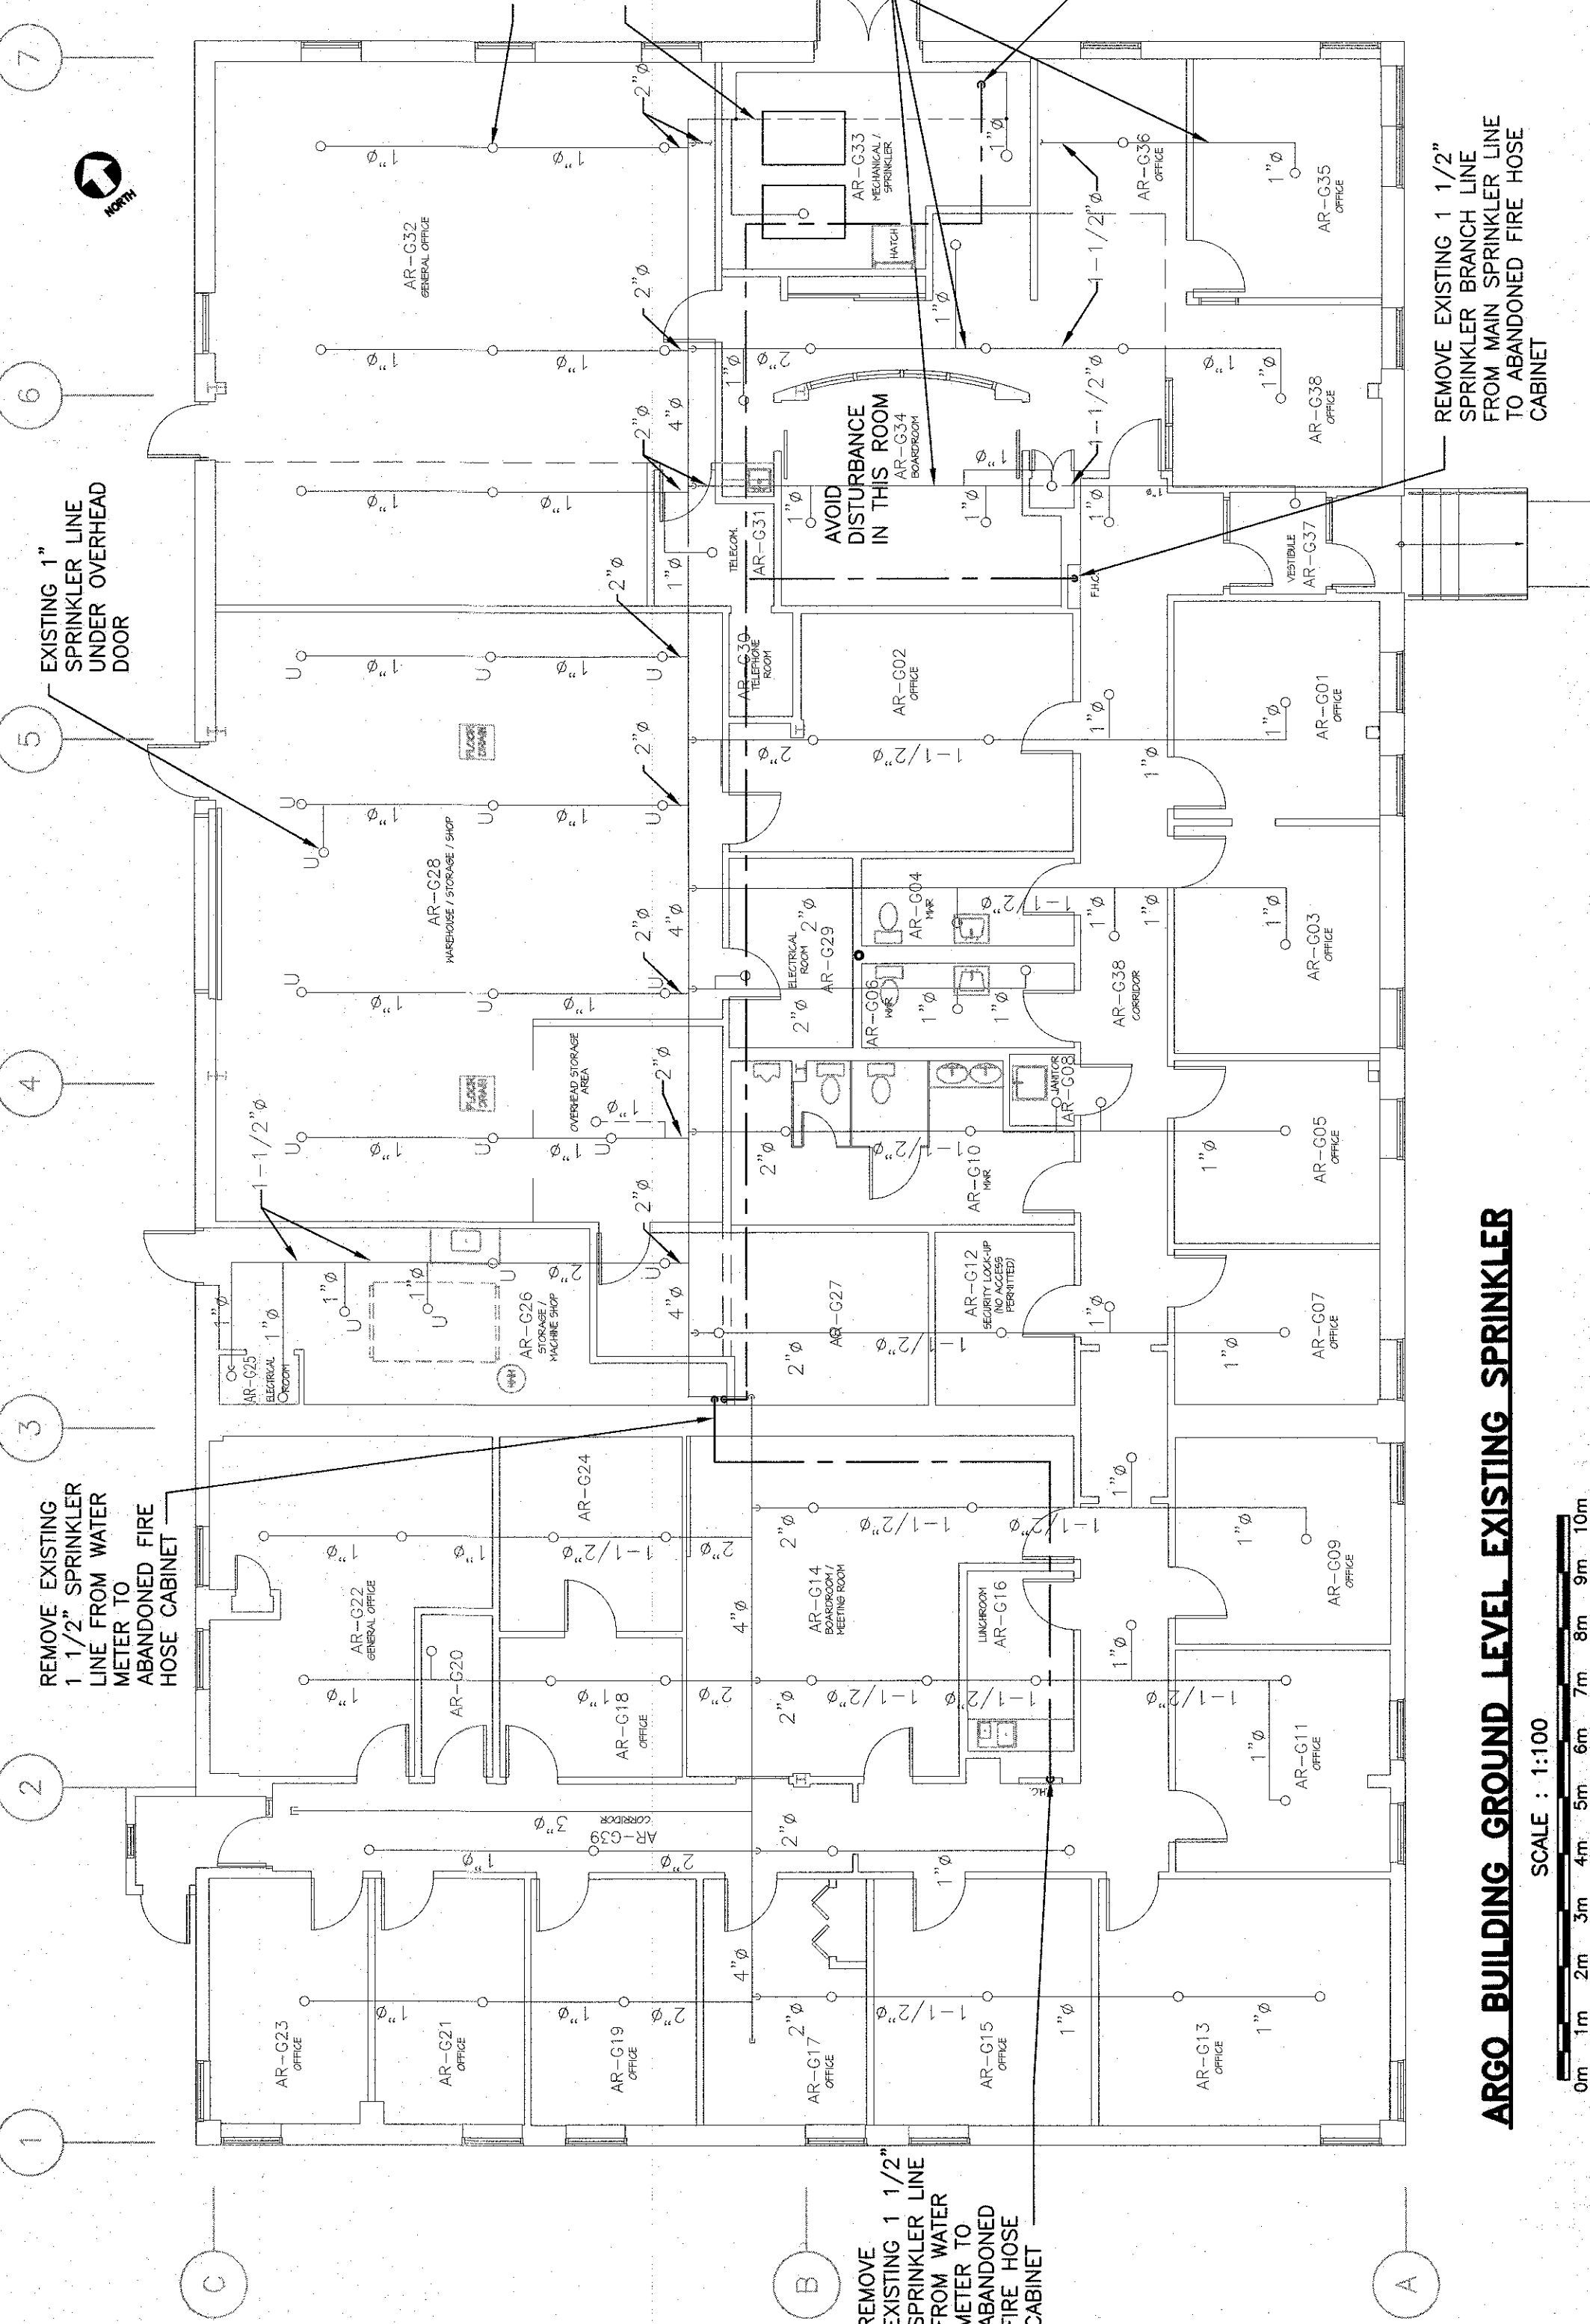

ARGO BUILDING GROUND LEVEL EXISTING SPRINKLER

SCALE : 1:100
0m 1m 2m 3m 4m 5m 6m 7m 8m 9m 10m

EXISTING SPRINKLER CONNECTION

ALARM VALVE DETAIL

N.T.S.