# SALT SHED EXPANSION PROJECT

TERRA NOVA NATIONAL PARK, NL

## LIST OF DRAWINGS:

PROJECT NO. TNNP 2008-08-100

A1 - SITE PLAN

A2 - FOUNDATION


A3 - ELEVATIONS

A4 - DETAILS

A5 - DETAILS(2)

A6 - ANCHOR BOLT LAYOUT/TEMPLATES



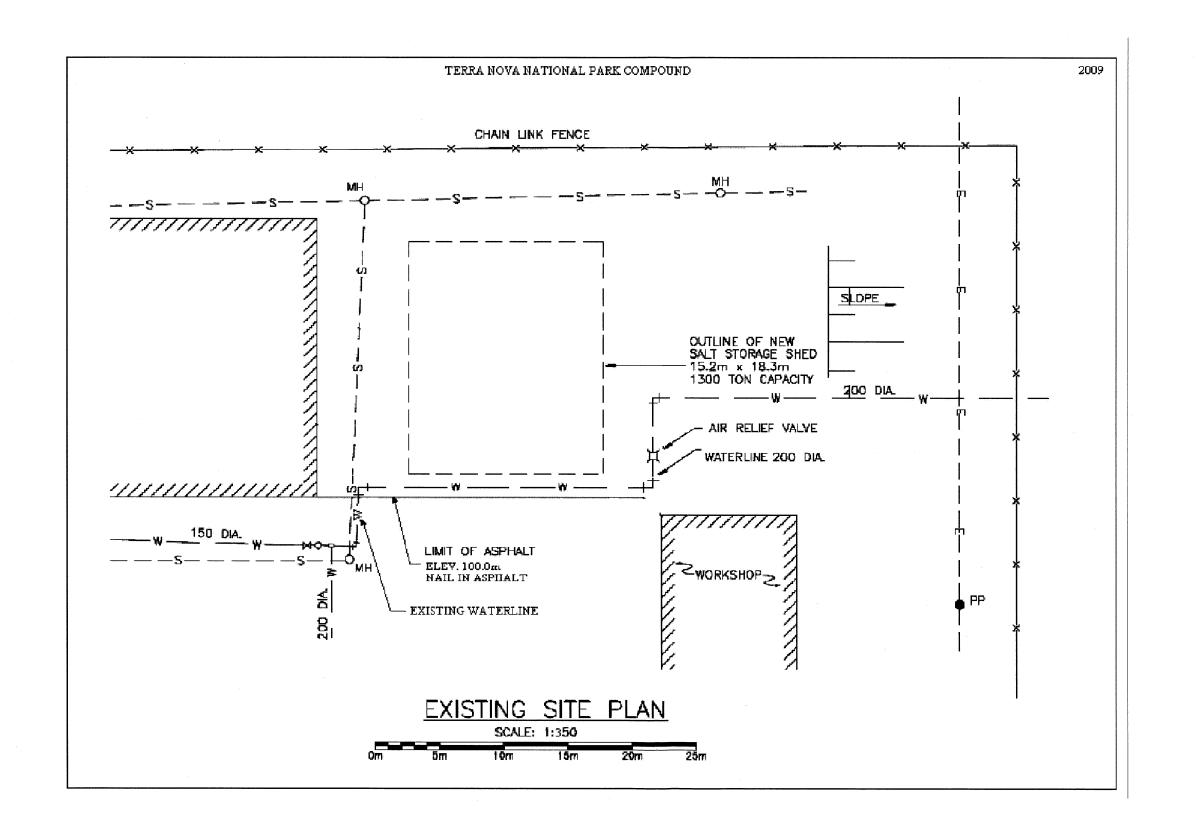

GENERAL DELIVERY GLOVERTOWN, NL AOG 2L0 Tel: (709) 533-3136

- BEFORE PROJECTION ARE IN FT./IN. UNLESS OTHERWISE SPECIFIED.

  3. DO NOT SCALE DRAWINGS.

  4. ALL CONCRETE WORK (INCLUDING DESIGN AND TESTING) TO CONFORM TO THE MOST RECENT EDITIONS OF THE CAS STANDARDS CAN3-A23.3, CAN3-A23.2, &CAN3-A23.1.
- CANS-AZ3.3, CANS-AZ3.2, &CANS-AZ3.3, CANS-AZ3.3, CANS-AZ3.3, CANS-AZ3.1, CANS-
- 7. FOOTING TO REST ON UNDISTURBED SOIL.
- ALL WORK IN ACCORDANCE TO THE FIRE SAFETY, ELECTRICAL, PLUMBING, LOCAL AND NATIONAL BUILDING CODES OF CANADA
   SEE GENERAL NOTES AND SPECIFICATIONS




SALT-SHED TERRA NOVA NATIONAL PARK

SITE PLAN

DRAWN BY:	APPROVED BY:
G.WELLS	S.BURBRIDGE
SCALE:	DATE:
NTS	AUG'09

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TNNP-2009-08-100 Α1

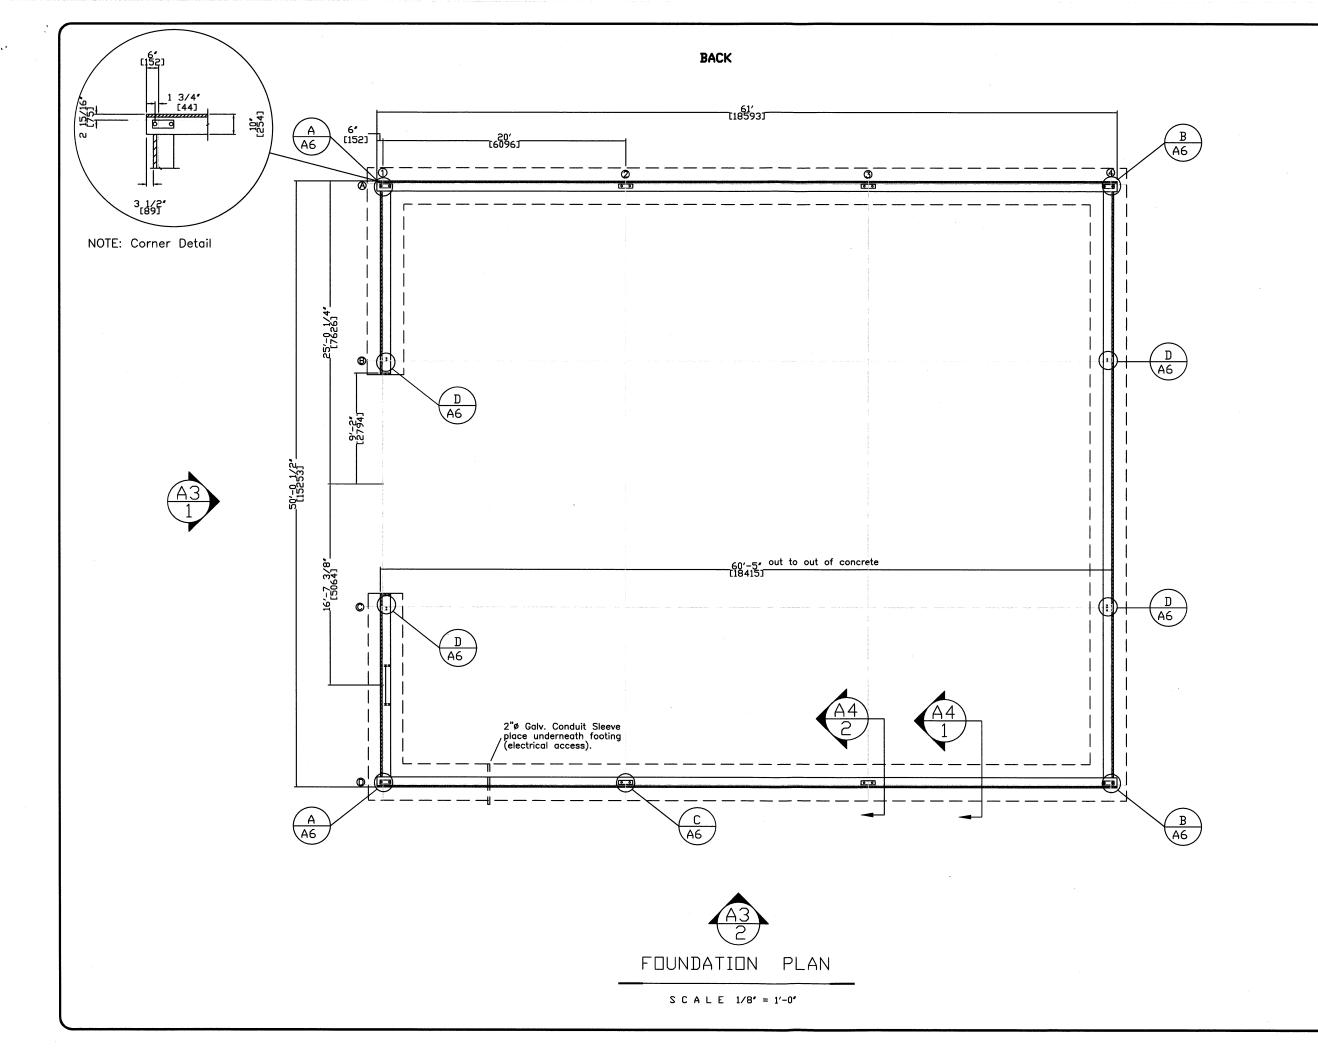

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CONTRACTOR MUST VERIFY DIMENSIONS BEFORE PROCEEDING WITH THIS WORK.

- 2. ALL DIMENSIONS ARE IN FT./IN. UNLESS OTHERWISE SPECIFIED.


- OTHERWISE SPECIFIED.

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  4. ALL CONCRETE WORK (INCLUDING DESIGN AND TESTING) TO CONFORM TO THE MOST RECENT EDITIONS OF THE CSS ATANDARDS CAN3—A23.3, CAN3—A23.2, &CAN3—A23.1.

  5. ALL CONCRETE SHALL ATTAIN MIN. 28—DAY COMPRESSIVE STRENGTH OF 35 MPQ. EXPOSURE CLASSIFICATION C1. W/C/ 0.4 CEMENT TYPE 105F, CURE USING WET BURLAP FOR MIN. 7 DAYS MIN. 5—8% ARI INTRAINMENT BY VOLUME.
- 7. FOOTING TO REST ON UNDISTURBED SOIL.
- ALL WORK IN ACCORDANCE TO THE FIRE SAFETY, ELECTRICAL, PLUMBING, LOCAL AND NATIONAL BUILDING CODES OF CANADA
   SEE GENERAL NOTES AND SPECIFICATIONS

	ISSUED FOR CONSTRUCTION 12/08/2009	
NO	REVISION/ISSUE	DATE

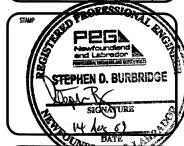

SALT-SHED TERRA NOVA NATIONAL PARK


MLE:

FOUNDATION


DRAWN BY:	APPROVED BY:	
G.WELLS	S.BURBRIDGE	
SCALE:	DATE:	
1/8"=1'0"	AUG'09	

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PROJECT NO:	TNNP-2009-08-100	
SHEET: A.	2 REVISION:	



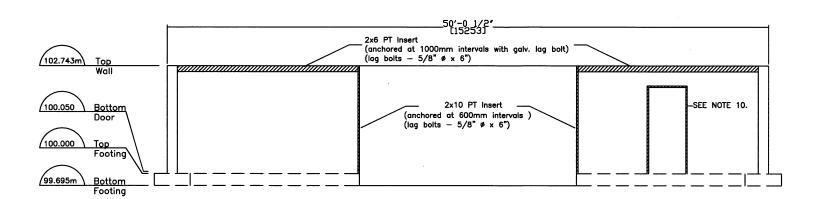



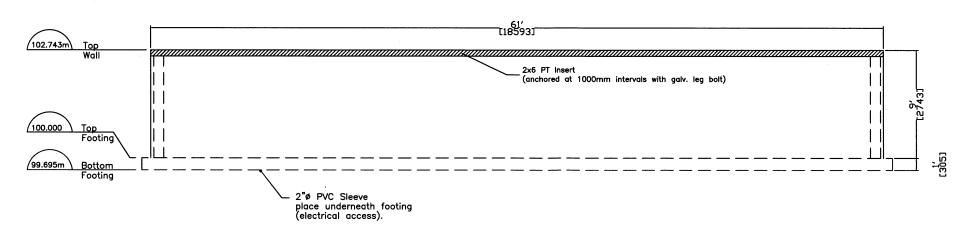

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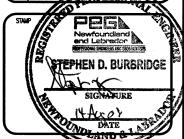
  5. ALL CONCRETE SHALL ATTAIN MIN. 28-DAY COMPRESSIVE STRENGTH OF 35 MPG. EMPOSUBRE CLASSIFICATION C1. W/C/ 0.4 CEMENT TYPE 10SF. CURE USING WET BURLAP FOR MIN. 7 DAYS.

  6. ALL CONCRETE TO HAVE A MIN. 5-8% AIR INTRAINMENT BY VOLUME.

  7. FOOTING TO REST ON LINDISTURBED SOIL.
- 7. FOOTING TO REST ON UNDISTURBED SOIL.

- ALL WORK IN ACCORDANCE TO THE FIRE SAFETY, ELECTRICAL, PLUMBING, LOCAL AND NATIONAL BUILDING CODES OF CANADA 9. SEE GENERAL NOTES AND SPECIFICATIONS IO. CONTRACTOR SUPPLIES AND DETERMINES R.S.O. TO ACCEPT 36"X84" STEEL DOOR AND FRAME. DOOR SYSTEM TO BE GROUTED IN PLACE.

	ISSUED FOR CONSTRUCTION 12/08/2009	
10	ATT LSS TO	DATE
_		3.4



SALT-SHED TERRA NOVA NATIONAL PARK


TITLE:

**ELEVATIONS** 


DRAWN BY:	APPROVED BY:
G.WELLS	S.BURBRIDGE
SCALE:	DATE:
1/8"=1'0"	AUG'09

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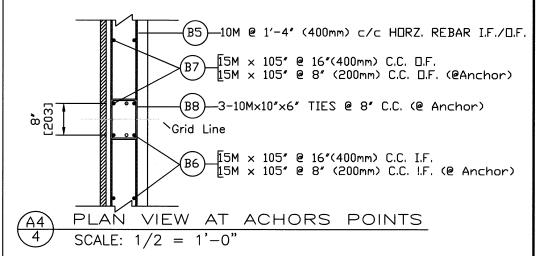
PROJECT NO:	TNNP-2009-08-100
SHEET: A.3	REVISION:

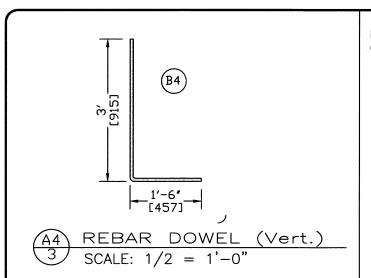



Note: B5 & B9 WILL BE CONTINUOUS AT CORNERS. USE 24"X24" CORNER BARS.

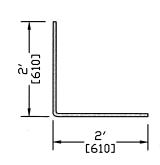

CORNER REBAR (Horiz.) SCALE: 1/2 = 1'-0"



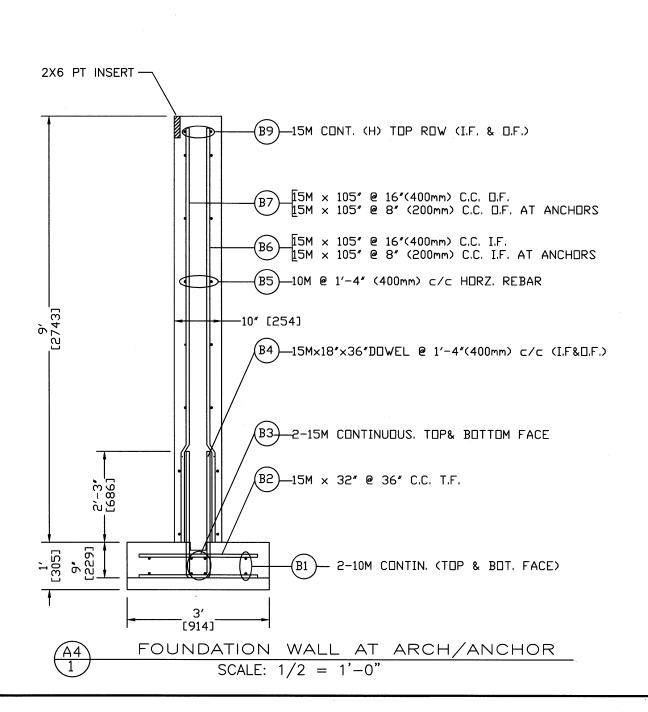

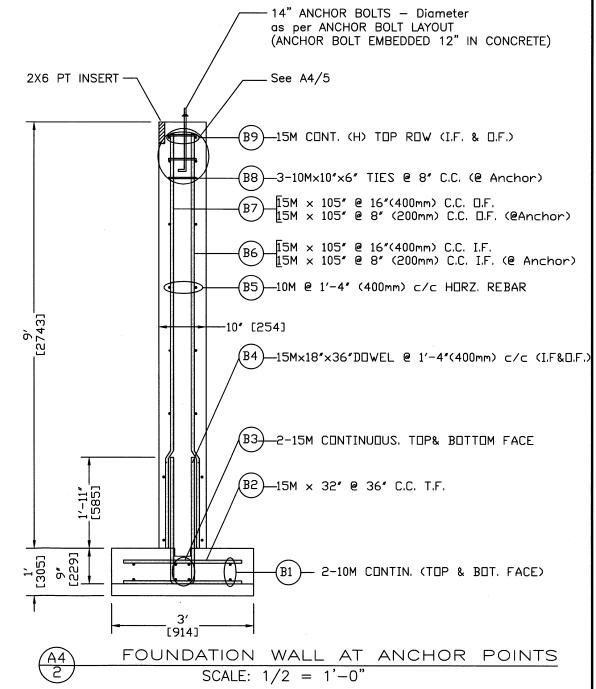


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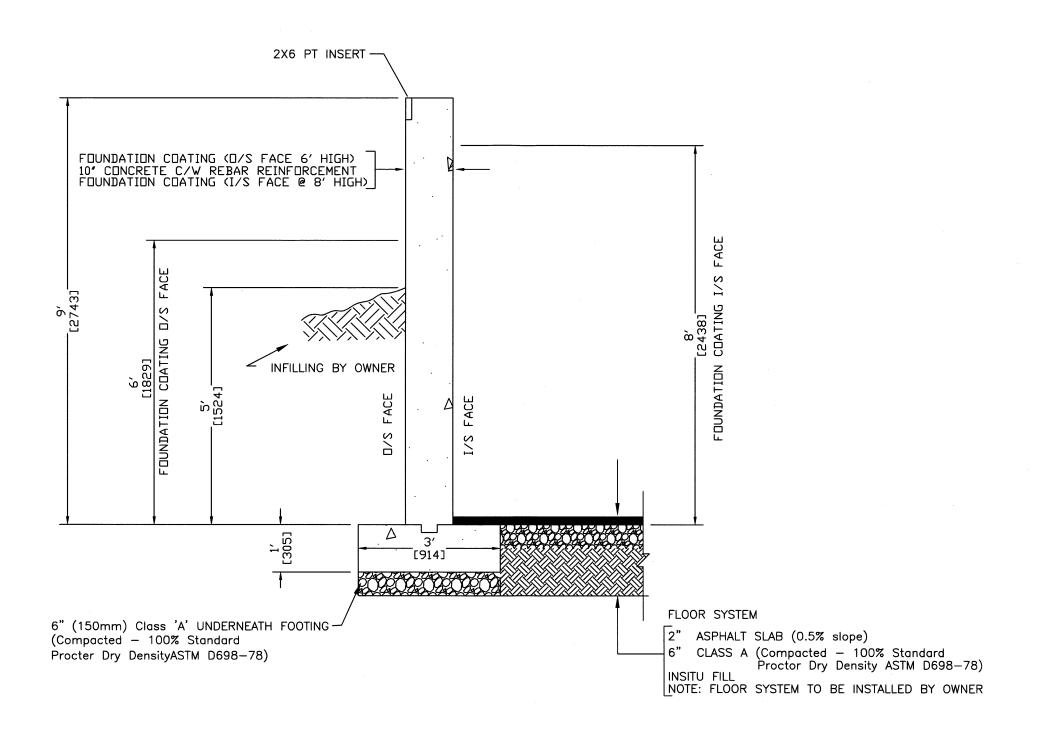
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- 6. ALL CONCRETE TO HAVE A MIN. 5-8% AIR INTRAINMENT BY VOLUME.
  - FOOTING TO REST ON UNDISTURBED SOIL.
- 8. SEE GENERAL NOTES AND SPECIFICATIONS.



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2

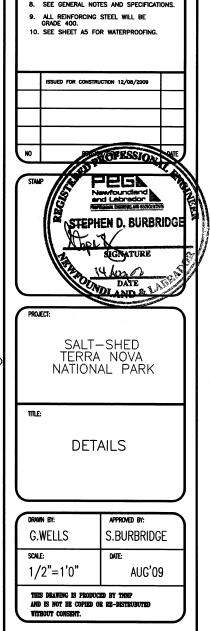

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9. ALL REINFORCING STEEL WILL BE GRADE 400.

WOFESSION STEPHEN D. BURBRIDGE

SALT-SHED TERRA NOVA NATIONAL PARK

DETAILS(2)


APPROVED BY:
S.BURBRIDGE
DATE:
AUG'09

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FOUNDATIION WALL/FOOTING DETAILS (2)


SCALE: 1/2 = 1'-0"



# ANCHOR BOLT TEMPLATE A6

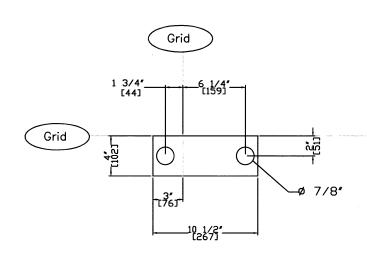
### NOTES:


- -CONTRACTOR TO SUPPLY/INSTALL ANCHOR BOLTS ONLY.
- -CONTRACTOR TO PROVIDE PLYWOOD TEMPLATES
- FOR ANCHOR BOLT PLACEMENT. -ANCHOR BOLT DIAMETER FOR
- RESPECTIVE LOCATIONS AS INDICATED BY TEMPLATE.

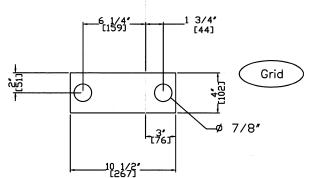


Grid

В ANCHOR BOLT TEMPLATE A6

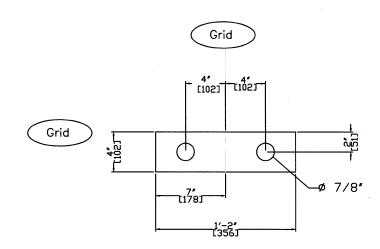

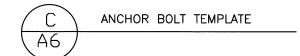



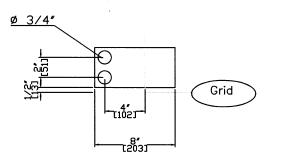




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   SEE GENERAL NOTES AND SPECIFICATIONS
   ANCHOR BOLTS EMBEDDED IN CONCRETE MIN. OF 12". PROJECTING OUT OF CONCRETE MIN. 3". ANCHOR BOLT PROJECTION BASE ON NO GROUT.
   CONTRACTOR TO SUPPLY/INSTALL ANCHOR BOLTS AND PLYMOOD TEMPLATES FOR ANCHOR BOLT SAND PLYMOOD TEMPLATES FOR ANCHOR BOLT AND PLYMOOD PLYMOOD PLANCES PLANCES PLYMOOD PLANCES PL

ISSUED FOR CONSTRUCTION 12/08/2009



SALT-SHED TERRA NOVA NATIONAL PARK

ANCHOR BOLT LAYOUT/TEMPLATE

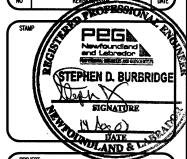DRAWN BY:	APPROVED BY:
G.WELLS	S.BURBRIDGE
SCALE:	DATE:
N.T.S.	AUG'09

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