




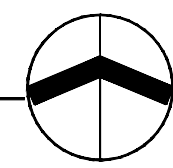

LOCATION PLAN
NTS



SHEET INDEX:

- L1 DEMOLITION PLAN
- L2 ARMOUR EXTENSION AND BERM GRADING
- L3 PATHWAY LAYOUT AND SITE FURNISHINGS
- L4 TOPSOIL AND SEEDING PLAN
- L5 PLANTING PLAN
- L6 PLANTING AND KIOSK DETAILS
- L7 RIPRAP BERM DETAILS
- L8 PARKING LOT AND LINE MARKINGS PLAN

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Western and Northern
Region

 Parcs Canada
Gestion des biens
Région de l'Ouest et du
Nord

Canada



HEALY CREEK PARKING LOT RESTORATION

ISSUED FOR CLIENT
REVIEW

MARCH 18, 2015

GENERAL NOTES:

1. REFER TO L1 DEMOLITION PLAN FOR LIST OF GENERAL NOTES.

EARTHWORK AND GRADING GENERAL NOTES:

1. EARTHWORK AND GRADING ON SITE ARE TO BE AROUND FUTURE PADDOCK LOCATION AND PARKING LOT. GRADING IN ALL OTHER AREAS OF THE SITE ARE TO REMAIN.
2. CONTRACTOR WILL BE RESPONSIBLE FOR ENSURING POSITIVE DRAINAGE OF THE SITE AS A WHOLE.
3. THERE SHALL BE NO GRADE CHANGES UNDER CANOPY OF PRESERVED TREES / PLANT MATERIAL.
4. CONTRACTOR SHALL MINE, LOAD, HAUL AND PLACE MATERIAL AS NECESSARY AND AS DIRECTED TO COMPLETE GRADING OPERATIONS.
5. CONTOURS ARE SHOWN AT 0.5m INTERVALS.
6. THE CONTRACTOR SHALL BE RESPONSIBLE FOR VERIFYING QUANTITIES AND FOR ENSURING THE PROJECT IS CONSTRUCTED IN ACCORDANCE WITH THE LAYOUT AND GRADING PLANS AND DIRECTIONS PROVIDED BY THE DEPARTMENTAL REPRESENTATIVE.
7. LOAD AND HAUL EXCAVATED MATERIALS FROM THE WORK AREAS AND ALL LOCALIZED CUTS, TO AREAS REQUIRING FILL AS DIRECTED. PLACE AND COMPACT FILL MATERIALS TO ACHIEVE DESIRED GRADES.
8. THE CONTRACTOR SHALL TAKE ALL PRECAUTIONS NECESSARY TO PREVENT DAMAGE TO EXISTING VEGETATION AND GRADES OUTSIDE OF THE DESIGNATED WORK AREA. REPAIR AND RESTORATION OF DAMAGED AREAS WILL BE THE RESPONSIBILITY OF THE CONTRACTOR.
9. THE DEPARTMENTAL REPRESENTATIVE RESERVES THE RIGHT TO ADJUST THE GRADES DURING EARTHWORK AND GRADING OPERATIONS TO MEET FIELD CONDITIONS OR TO ENHANCE THE CHARACTER LANDSCAPE AREAS AT NO ADDITIONAL COSTS.
10. SET SUB-GRADES TO PROPER ELEVATIONS SUCH THAT FOLLOWING PLACEMENT OF 150mm OF TOPSOIL, FINAL GRADES AND ELEVATIONS CAN BE ESTABLISHED WITHIN ±50mm OF THE FINISH GRADES SHOWN ON THE DRAWINGS.
11. APPROVAL OF SUB-GRADES SHALL BE OBTAINED FROM THE DEPARTMENTAL REPRESENTATIVE PRIOR TO TOPSOIL REPLACEMENT AND FINISHED GRADE.

SHAPING:

1. GRADING AND LAYOUT PLANS WILL BE SUPPLEMENTED BY ON-SITE DIRECTION PROVIDED BY THE DEPARTMENTAL REPRESENTATIVE DURING THE GRADING AND SHAPING PHASES OF CONSTRUCTION. ANY ADDITIONAL OR REMEDIAL SHAPING WORK REQUIRED BY THE DEPARTMENTAL REPRESENTATIVE SHALL BE CONSIDERED INCIDENTAL TO THE CONTRACT.
2. WHERE DEEMED APPROPRIATE BY THE DEPARTMENTAL REPRESENTATIVE, THE CONTRACTOR WILL UNDERTAKE MINOR SURFACE MODIFICATIONS AND RE-SHAPING OF AREAS WHERE THERE MAY OTHERWISE BE NO STIPULATION FOR EXCAVATION OR PLACEMENT OF FILL. SUCH WORK WILL BE UNDERTAKEN AT THE DIRECTION OF THE DEPARTMENTAL REPRESENTATIVE AND SHALL BE CONSIDERED INCIDENTAL TO THE WORK OF THE CONTRACT.

TEMPORARY DRAINAGE:

1. IF DURING THE COURSE OF THE WORK, IT BECOMES NECESSARY TO INTERRUPT THE NATURAL SURFACE DRAINAGE OF THE SITE OR THE FLOW OF CONSTRUCTED DITCHES OR SWALES, THE CONTRACTOR SHALL PROVIDE ADEQUATE TEMPORARY DRAINAGE FACILITIES THAT WILL BE SUFFICIENT TO PREVENT EROSION DAMAGE OR UNNECESSARY DELAY IN THE WORK. ORIGINAL DRAINAGE SHALL BE RESTORED OR PROPOSED DRAINAGE FACILITIES CONSTRUCTED AS SOON AS CONDITIONS PERMIT.
2. WHERE UNUSUAL SITE CONDITIONS SUCH AS SEEPS, NATURAL SPRINGS OR OTHER UNEXPECTED DRAINAGE PATTERNS ARE ENCOUNTERED THAT MAY REQUIRE PERMANENT TREATMENT, THE CONTRACTOR SHALL NOTIFY THE DEPARTMENTAL REPRESENTATIVE IMMEDIATELY OF THE CONDITION AND RECEIVE DIRECTION FOR TREATMENT.

UNSUITABLE MATERIALS:

1. WHERE EXCAVATION TO PROPER SUB-GRADE EXPOSES UNSTABLE OR UNSUITABLE SOILS OR OTHER UNSUITABLE CONDITIONS, THE CONTRACTOR SHALL NOTIFY THE DEPARTMENTAL REPRESENTATIVE OF SUCH CONDITIONS AND PROCEED WITH THE REMOVAL OR CORRECTION OF THE CONDITION AS DIRECTED BY THE DEPARTMENTAL REPRESENTATIVE.

EXISTING ARMOUR BERM SHAPING AND FINISHING:


1. CONTRACTOR TO REORGANIZE EXISTING ARMOUR ROCK TO FLATTEN AND WIDEN PEAK OF EXISTING BERM AS DIRECTED TO ACCOMMODATE NEW CONSTRUCTION PATHWAY. SALVAGED MATERIAL IS TO BE USED AS GRAVEL BLAST FILL FOR AMOUR BERM EXTENSION.
2. TRANSITION BETWEEN END OF GRAVEL AND EXISTING BERM IS TO BE FILLED WITH SUITABLE FINE-GRAIN MATERIALS SALVAGED FROM BREWSTER CREEK TRAIL CONTRACT OR SUITABLE MATERIAL EXCAVATED FROM ARMOUR BERM EXTENSION TO CREATE A GENTLE TRANSITION FOR PATHWAYS.
3. 300mm GRAVEL BLAST FILL TO BE EXTENDED OVER THE ENTIRE LENGTH OF THE EXISTING BERM. REFER TO (2/L7) RIPRAP BERM PLANTING SECTION DETAIL.
4. ALL FILLED AREAS SHALL BE SUFFICIENTLY COMPACTED TO PREVENT FUTURE SETTLEMENT. FILL MATERIAL SHALL BE PLACED IN LOOSE LAYERS NOT EXCEEDING 200 MM IN DEPTH AND COMPACTED IN PLACE.
5. COMPACTION OF FILL MATERIAL SHALL BE UNDERTAKEN BY ROLLERS, VIBRATORS, COMPACTORS OR OTHER MECHANICAL EQUIPMENT SUITED TO THE PURPOSE. COMPACTION BY DOZER TREADS SHALL NOT BE CONSIDERED SUITABLE FOR COMPACTION OF STRUCTURAL FILL.
6. 150mm DEPTH TOPSOIL IS TO BE APPLIED TO SURFACE OF BERM AND SEEDED - REFER TO L4 TOPSOIL AND SEEDING PLAN.
7. REFER TO L 5 PLANTING PLAN FOR LOCATIONS OF SHRUB PLANTING ALONG BERM.
8. TOPSOIL TO BE SALVAGED AND IMPORTED FROM BREWSTER CREEK TRAIL CONSTRUCTION
9. REFER TO L7 FOR NEW ARMOUR RIPRAP EXTENSION.

CLEAN-UP:


1. LEAVE SITE IN NEAT AND ACCEPTABLE CONDITION. REMOVE EXCESS MATERIALS FROM SITE.

LEGEND:

- EXISTING CONCRETE
- HEAVY DUTY ASPHALT
- LIMIT OF WORK
- EXISTING VEGETATION
- EXTENDED RIPRAP
- WOODEN POST
- EXISTING CONTOURS
- PROPOSED CONTOURS
- JERSEY BARRIER
- WOODEN FENCE
- NEW TRAIL CONSTRUCTION

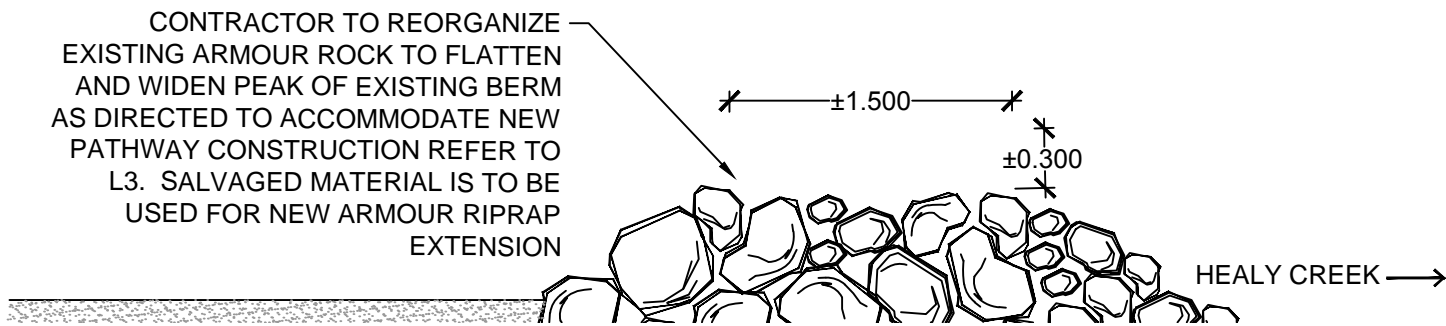

(2/L2) FLATTENING OF EXISTING BERM
SCALE - NTS

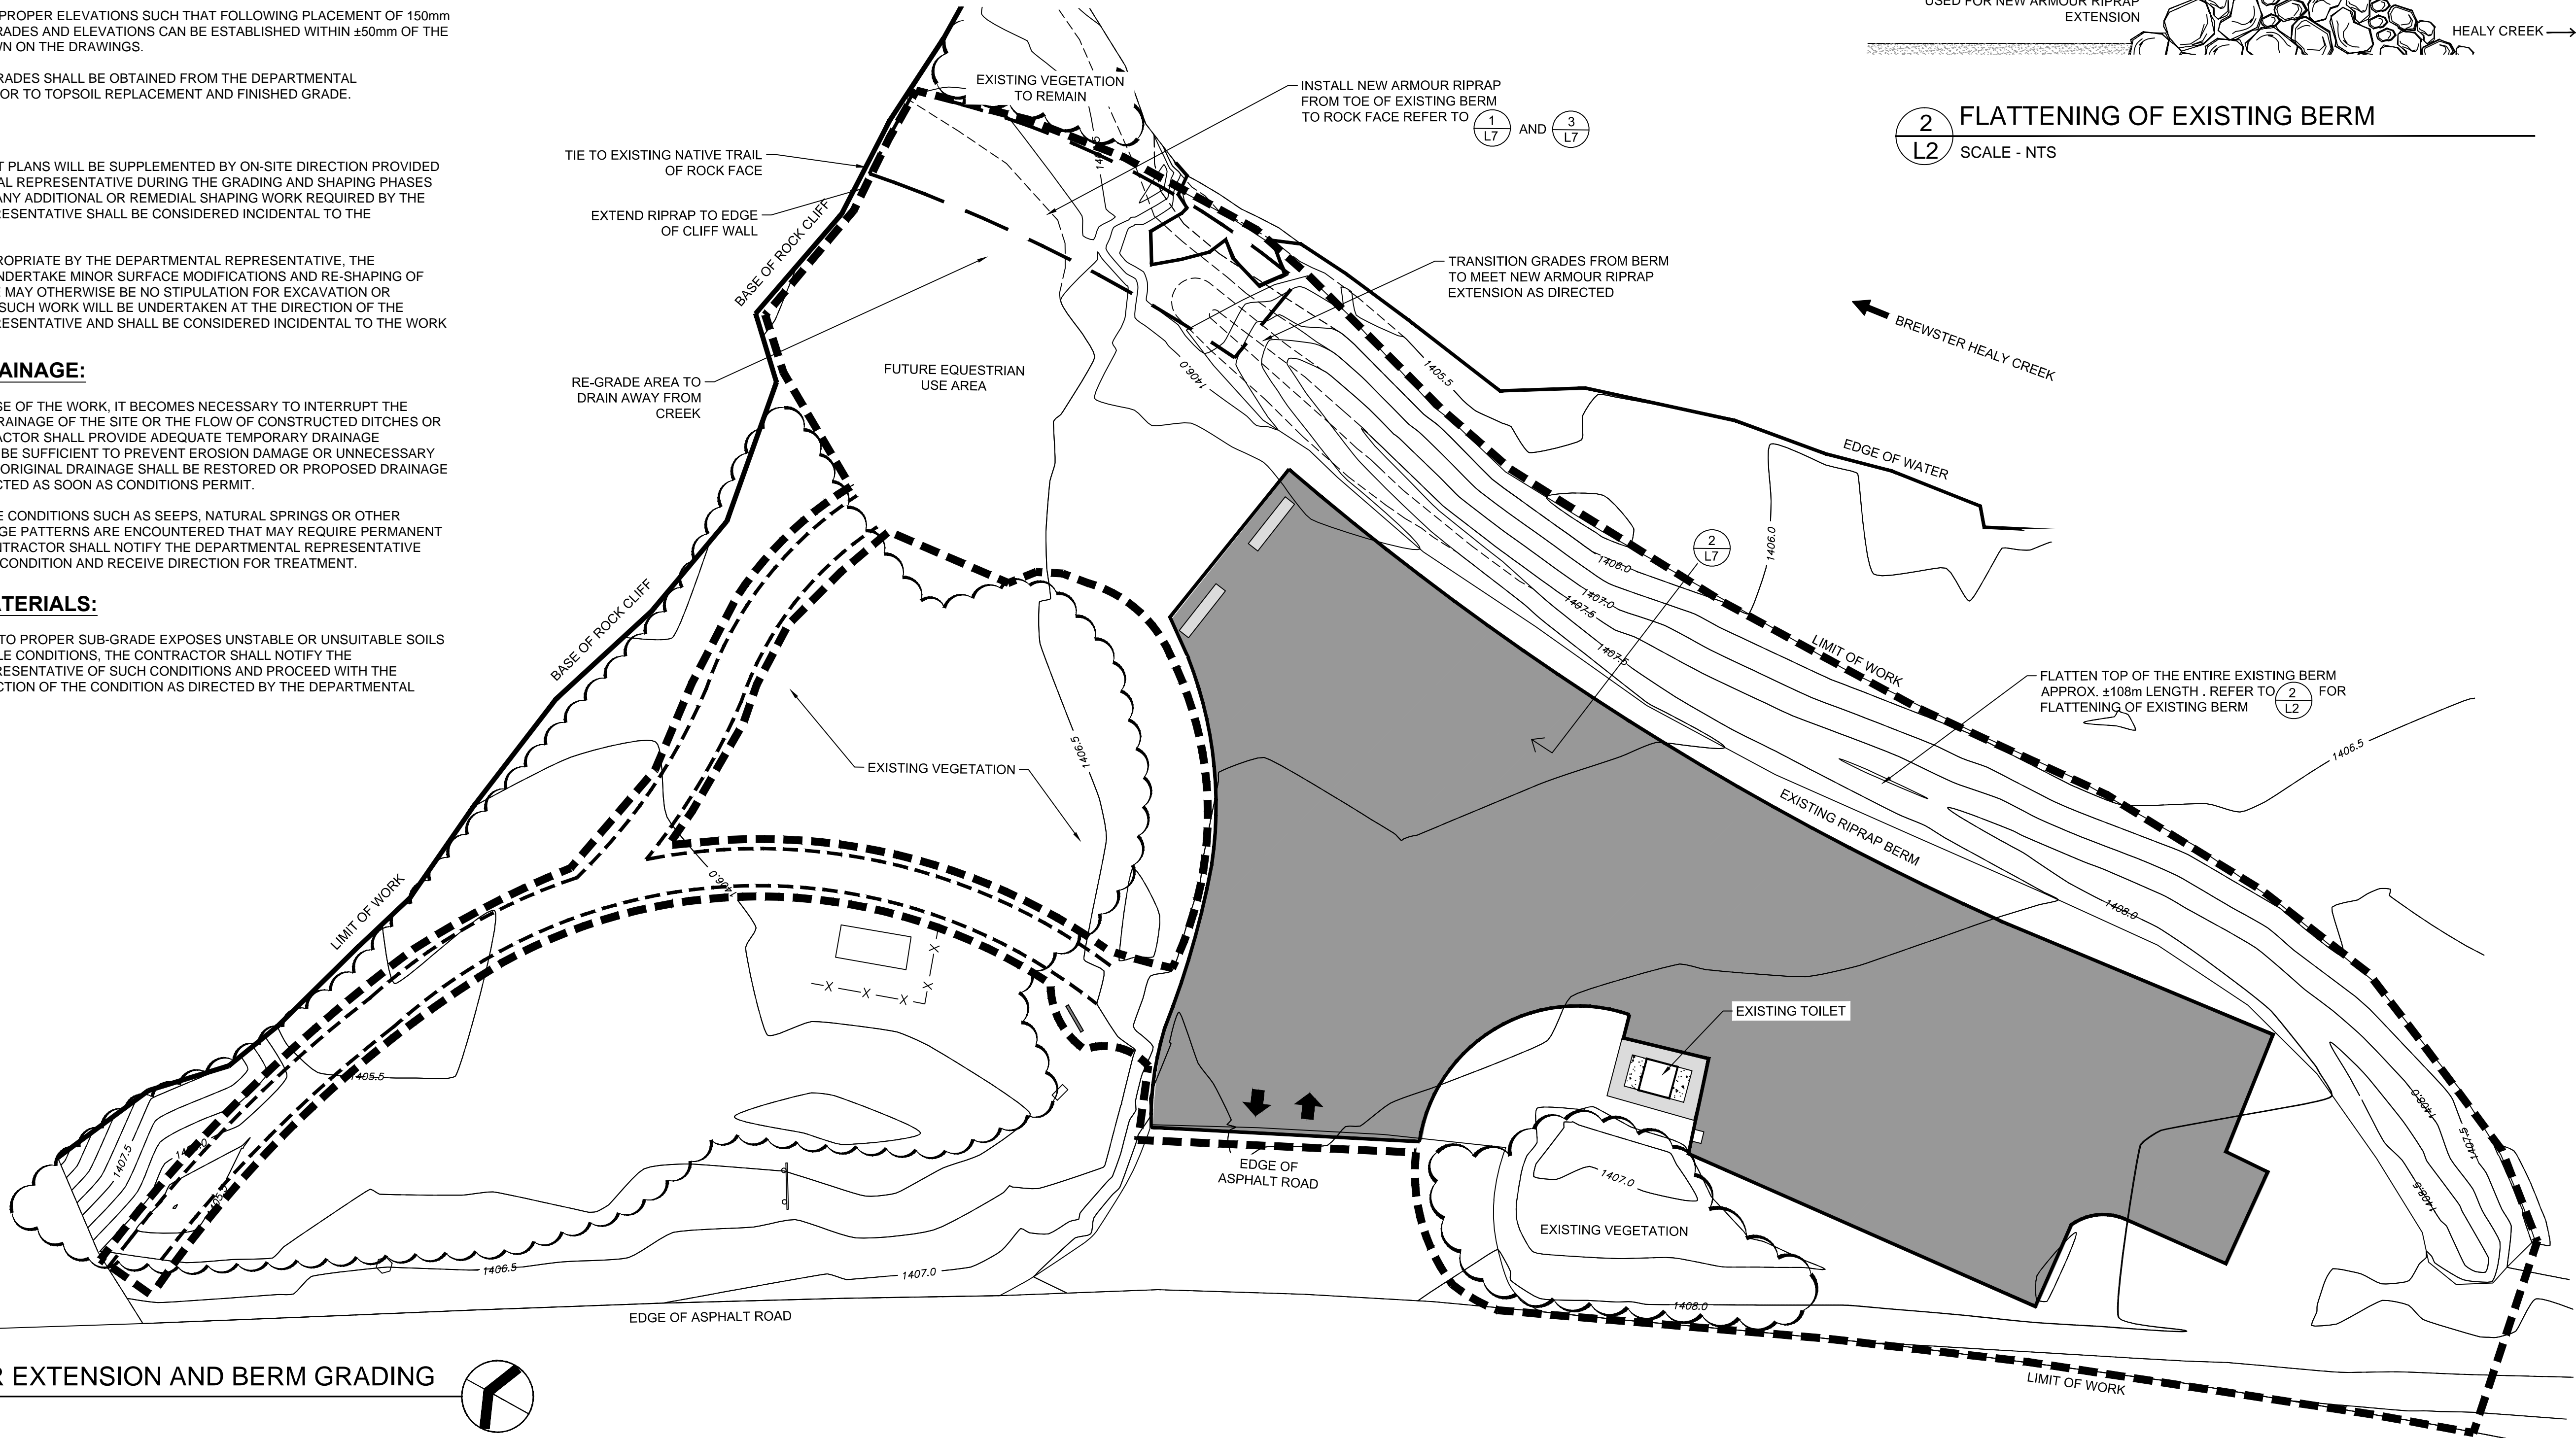

(1/L2) ARMOUR EXTENSION AND BERM GRADING
SCALE - 1:250

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6. FOR CLIENT REVIEW		AB	MAR 18, 2015
5. FOR CLIENT REVIEW		AB	MAR 4, 2015
4. FOR 95% REVIEW		AB	DEC, 2014
3. FOR CLIENT REVIEW		AB	NOV 10, 2014
2. FOR CLIENT REVIEW		AB	AUG 29, 2014
1. FOR CLIENT REVIEW		AB	AUG 25, 2014

CHECKED BY	DATE
APPROVED FOR:	BY DATE
TENDER	
CONSTRUCTION	

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DRAWN BY AB AUGUST 2014 DATE	DESIGN BY LOMBARD NORTH AUGUST 2014 DATE
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SCALE
As Shown

PROJECT TITLE

HEALY CREEK
PARKING LOT
RESTORATION

SHEET TITLE

ARMOUR
EXTENSION AND
BERM GRADING

SHEET NO. L2	FILE NO. 2014-09
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GENERAL NOTES:

1. REFER TO L1 DEMOLITION PLAN FOR LIST OF GENERAL NOTES.

PATHWAY LAYOUT NOTES:

1. GRAVEL PATHWAY IS TO BE 150mm DEPTH USING GRAVEL SALVAGED FROM SITE.
2. LAYOUT GRAVEL PATHWAY USING POINT TABLE COORDINATES.
3. LAYOUT OF BERM PATHWAY IS TO BE STAKED AND FIELD REVIEWED BY DEPARTMENTAL REPRESENTATIVE PRIOR TO CONSTRUCTION.
4. REFER TO GRAVEL PATHWAY DETAIL

4

L7

SITE FURNITURE:

1. REFER TO DETAIL

1


L6

 FOR 3 PANEL TRAIL HEAD KIOSK.
2. HAUL-ALL TRASH RECEPTACLE IS TO BE INSTALLED BY PARKS CANADA.
3. REINSTALL JERSEY BARRIERS AS DIRECTED BY DEPARTMENTAL REPRESENTATIVE.
4. WOODEN SIGNAGE AND ACCESSIBLE PARKING STALL POSTS TO BE 150 X 150mm PRESSURE TREATED TIMBER 3m HEIGHT.
5. CONFIRM LOCATION OF WOODEN SIGNAGE POSTS WITH DEPARTMENTAL REPRESENTATIVE.
6. REMOVE AND DISPOSE ANY EXCESS MATERIAL FROM SITE FURNITURE INSTALLATION AS DIRECTED BY THE DEPARTMENTAL REPRESENTATIVE AT NO ADDITIONAL COST TO CONTRACT.

LEGEND:


- 1m GRAVEL PATHWAY ON BERM
- EXISTING CONCRETE
- HEAVY DUTY ASPHALT
- LIMIT OF WORK
- CONTOURS
- EXISTING VEGETATION
- COORDINATE POINTS
- JERSEY BARRIER
- WOODEN POST
- HAUL-ALL TRASH RECEPTACLE
- NEW TRAIL CONSTRUCTION

BERM PATHWAY COORDINATE POINTS			
POINT	EASTING (X)	NORTHING (Y)	DESCRIPTION
1	591935.9136	5667797.3238	PATHWAY
2	591940.0001	5667788.9341	PATHWAY
3	591942.2547	5667778.9176	PATHWAY
4	591941.7045	5667768.7441	PATHWAY
5	591934.4616	5667761.8251	PATHWAY
6	591937.8554	5667761.8633	PATHWAY
7	591942.0757	5667758.7818	PATHWAY
8	591943.8863	5667749.2487	PATHWAY
9	591945.6683	5667739.1302	PATHWAY
10	591947.9222	5667729.3885	PATHWAY
11	591950.7825	5667719.8076	PATHWAY
12	591954.1584	5667710.3960	PATHWAY
13	591957.3573	5667700.9304	PATHWAY
14	591959.4431	5667691.9861	PATHWAY
15	591957.4502	5667689.2176	PATHWAY
16	591949.5985	5667708.7799	PATHWAY
17	591943.1660	5667728.2763	PATHWAY
18	591939.1517	5667748.5618	PATHWAY

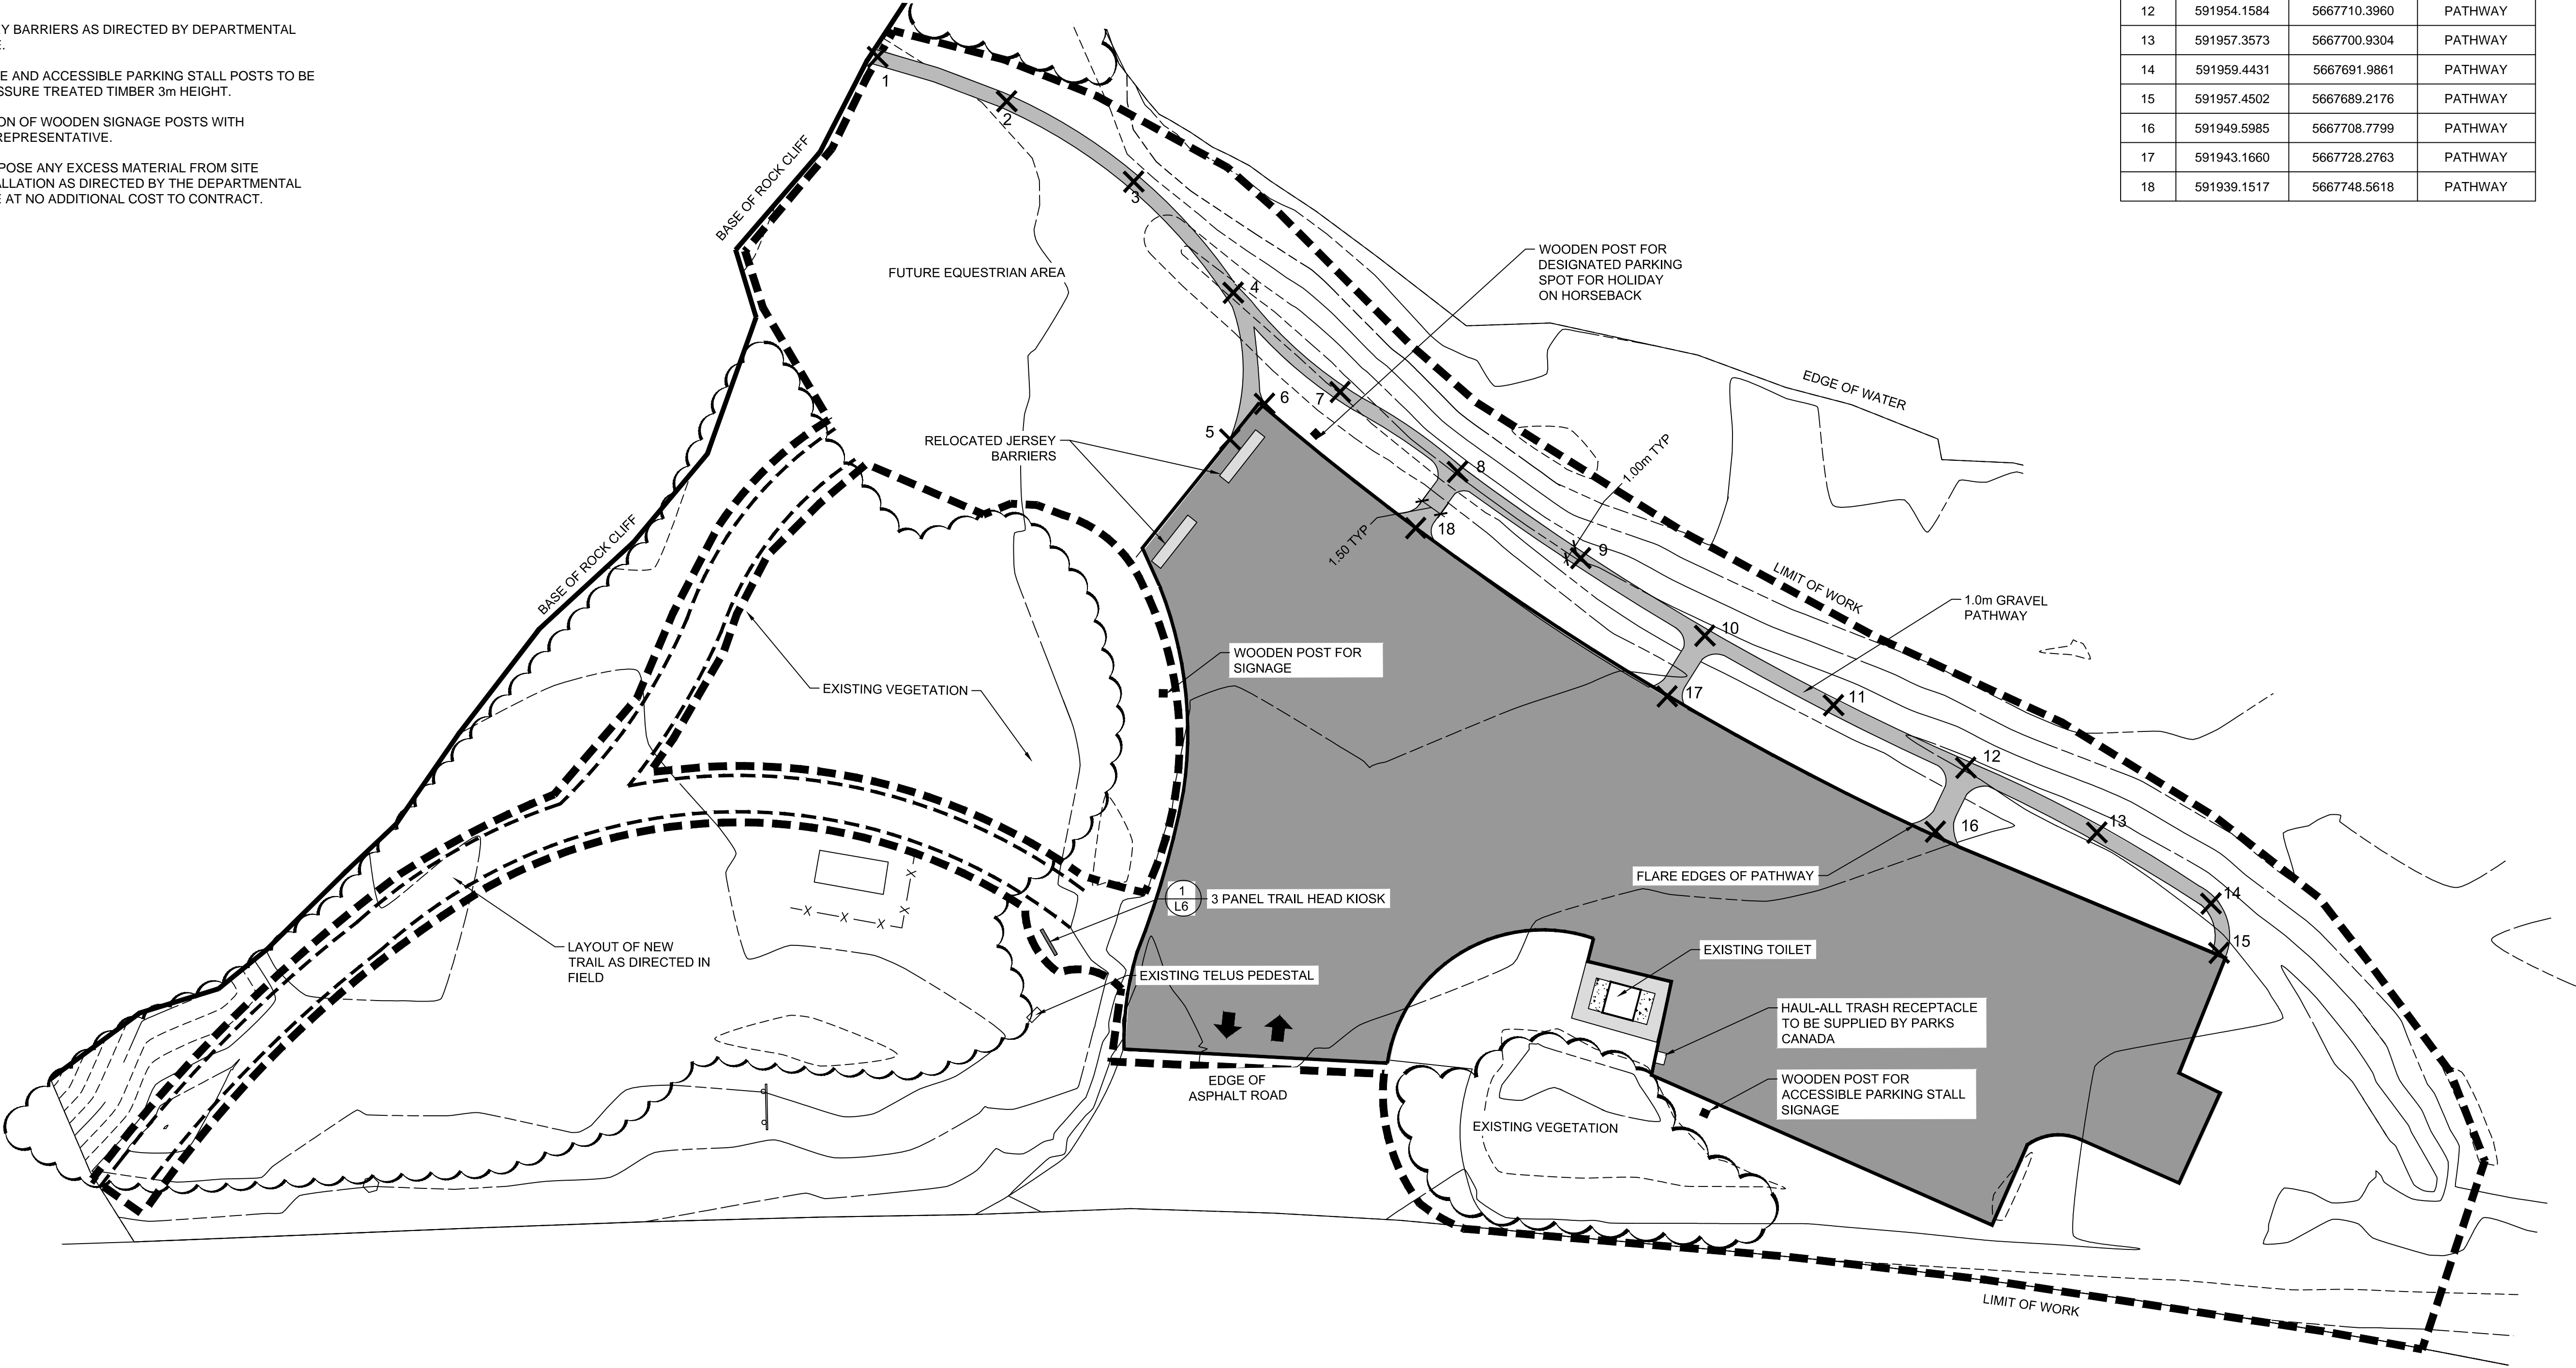

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2. FOR CLIENT REVIEW		AB	AUG 29, 2014
1. FOR CLIENT REVIEW		AB	AUG 25, 2014
CHECKED BY		DATE	
APPROVED FOR:		BY	DATE
TENDER			
CONSTRUCTION			

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Parcs Canada

Asset Management

Western and Northern Region

Gestion des biens

Région de l'Ouest et du Nord

Canada



DRAWN BY AB	DESIGN BY LOMBARD NORTH
AUGUST 2014	AUGUST 2014
DATE	DATE

SCALE As Shown

PROJECT TITLE

HEALY CREEK
PARKING LOT
RESTORATION

SHEET TITLE

PATHWAY AND
SITE FURNISHING
LAYOUT

SHEET NO. L3	FILE NO. 2014-09
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GENERAL NOTES:

1. REFER TO L1 DEMOLITION PLAN FOR LIST OF GENERAL NOTES.

TOPSOIL NOTES:


1. NATIVE TOPSOIL SHALL BE SALVAGED AND IMPORTED FROM THE NEW BREWSTER CREEK TRAIL CONSTRUCTION.
2. CONTRACTOR TO INSTALL TOPSOIL TO ALL LANDSCAPE AREAS INDICATED ON PLAN AND AS DIRECTED BY DEPARTMENTAL REPRESENTATIVE TO A DEPTH OF 150mm.
3. CONTRACTOR SHALL FINE GRADE ENTIRE TOPSOIL AREAS TO ELIMINATE ROUGH SPOTS AND LOW AREAS TO ENSURE POSITIVE DRAINAGE ON SITE AS A WHOLE.
4. ALL AREAS DISTURBED BY GRADING, PLANTING INSTALLATIONS OR DESIGNATED HAUL ROUTES SHALL BE SCARIFIED AS DIRECTED.

SEEDING:

1. ALL NEWLY TOPSOILED AREAS SHALL BE SEEDED USING THE PARKS CANADA SEED MIX COMPOSED OF THE FOLLOWING:
25% ALPINE BLUE GRASS
25% HAIRY WILDRYE
20% ROCKY MOUNTAIN FESCUE
20% FOWL BLUE GRASS
10% PINE GRASS
2. SEED SHALL CERTIFIED CANADA NO. 1 GRADE QUALITY SEED VARIETIES IN ACCORDANCE WITH THE CANADIAN SEEDS ACT AND REGULATIONS, AND HAVING A MINIMUM PURITY OF 97% AND GERMINATION OF 75%. SEED MIX IS FREE OF IMPURITIES AND DISEASE.
3. SEED IS TO BE APPLIED AT 75kg/ha.
4. APPLY SEED IN CONFORMANCE WITH MANUFACTURERS STANDARD SPECIFICATIONS.
5. SOW DURING CALM WEATHER, WHEN SOIL MOISTURE CONTENT IS ADEQUATE FOR GERMINATION.
6. SOW 50% OF SEED WITH "BRILLION" SEEDER.
7. SOW REMAINING 50% OF SEED AT RIGHT ANGLES TO FIRST SEEDING PATTERN, USING SAME BROADCASTING METHOD.
8. AFTER SEEDING, APPLY HYDRO MULCH TO ALL SEEDED AREAS AT A RATE OF 1120 KG/HA. DO NOT APPLY SEED WITH HYDRO MULCH.
9. WATER ENTIRE AREA WITH FINE SPRAY IMMEDIATELY AFTER EACH AREA HAS BEEN SOWN.
10. APPLY ENOUGH WATER TO ENSURE PENETRATION OF AT LEAST 50mm, AVOID WASHING OUT SEEDS.
11. LEAVE SITE IN NEAT AND ACCEPTABLE CONDITION. REMOVE EXCESS MATERIALS FROM SITE.

LEGEND:

- SEED OVER 150mm DEPTH TOPSOIL
- 1m GRAVEL PATHWAY ON BERM
- EXISTING CONCRETE
- HEAVY DUTY ASPHALT
- LIMIT OF WORK
- CONTOURS
- EXISTING VEGETATION
- JERSEY BARRIER
- WOODEN POST
- NEW TRAIL CONSTRUCTION

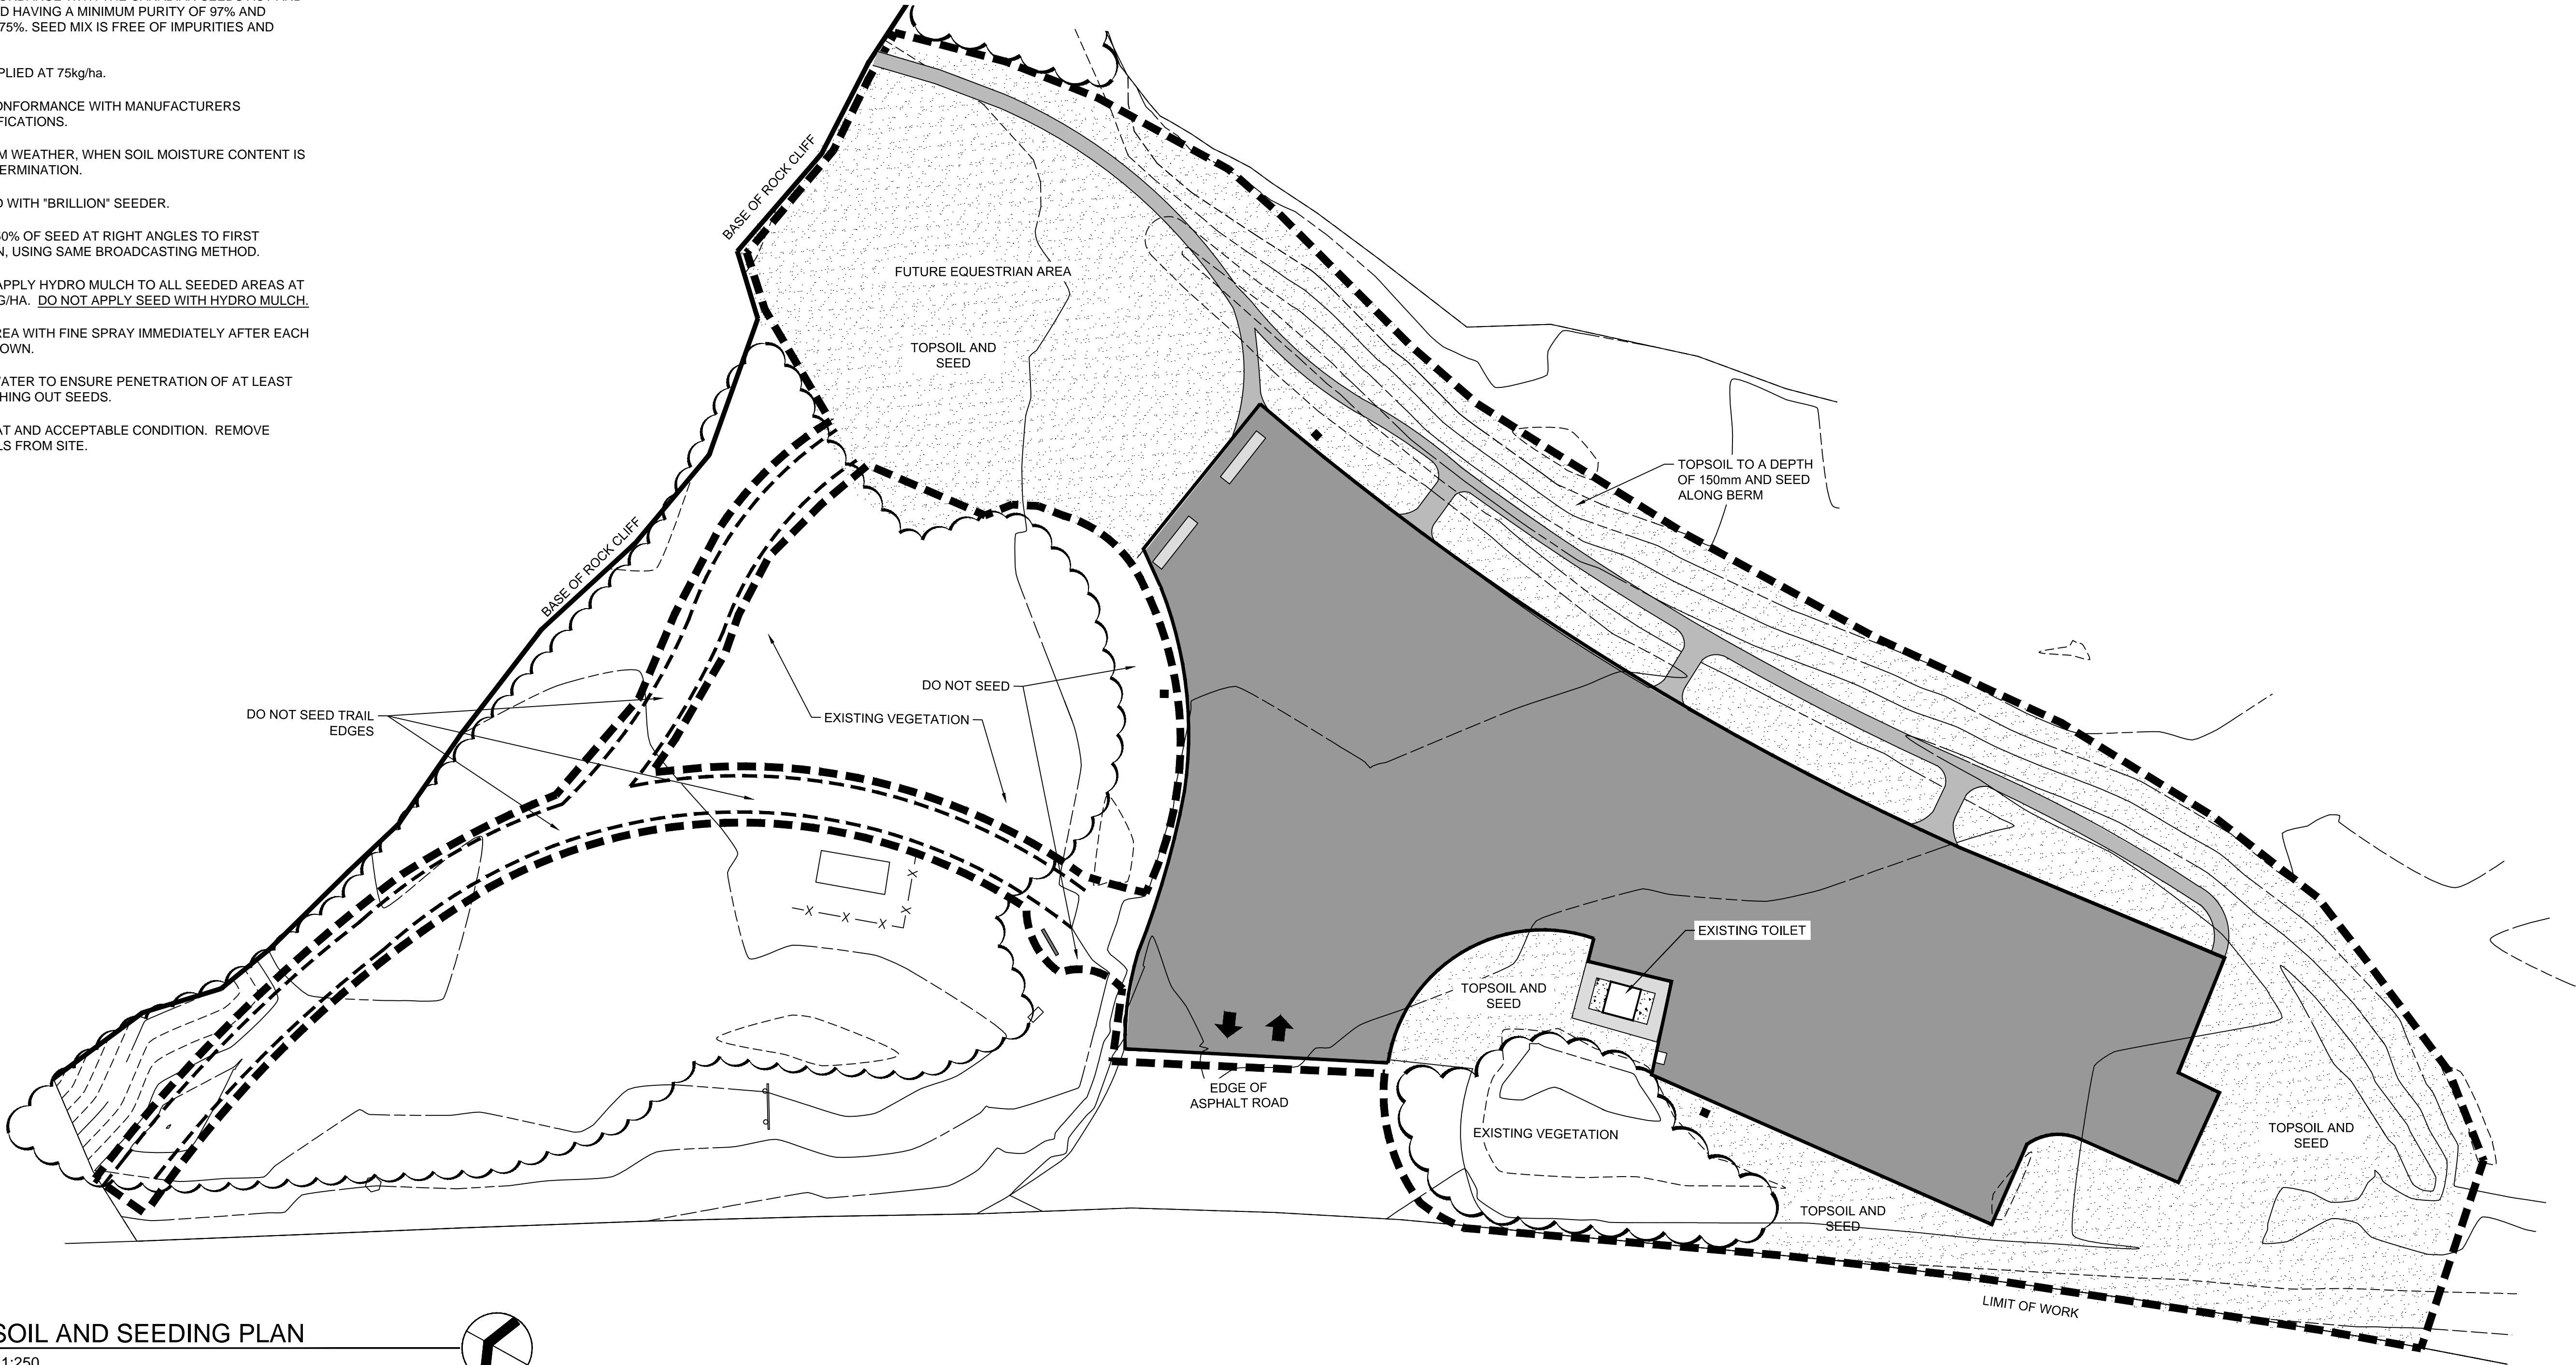

1 TOPSOIL AND SEEDING PLAN
L4 SCALE - 1:250

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SCALE
As Shown

PROJECT TITLE

HEALY CREEK
PARKING LOT
RESTORATION




SHEET TITLE
TOPSOIL AND
SEEDING PLAN

SHEET NO.
L4
FILE NO.
2014-09







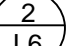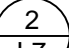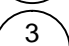



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


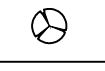
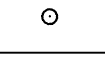
1. REFER TO L1 DEMOLITION PLAN FOR LIST OF GENERAL NOTES.


PLANTING NOTES:

1. ALL PLANT MATERIAL SHALL BE LOCALLY GROWN NURSERY STOCK. CONDITIONED FOR GROWTH IN ALBERTA.
2. ALL PLANT MATERIAL TO BE DISEASE FREE AND TRUE TO FORM, SPECIMEN GRADE SINGLE STEM STOCK - UNLESS OTHERWISE SPECIFIED.
3. PARKS CANADA RESERVES THE RIGHT TO REJECT ANY AND ALL PLANT MATERIAL THAT DOES NOT MEET THESE REQUIREMENTS.
4. CONTRACTOR SHALL STAKE ALL TREES AND SHRUB LOCATIONS ON SITE TO BE INSPECTED AND APPROVED BY DEPARTMENTAL REPRESENTATIVE PRIOR TO THE COMMENCEMENT OF ANY WORK.
5. ALL EXCAVATED MATERIAL SHALL BE DISPOSED OFFSITE OR IN LOCATION AS DESIGNATED BY DEPARTMENTAL REPRESENTATIVE.
6. TREE LOCATIONS TO BE ADJUSTED ON SITE WITH REGARD TO MINIMUM TREE SETBACKS FROM ABOVE AND BELOW GROUND UTILITIES.
7. THE CONTRACTOR SHALL REPORT ANY DISCREPANCIES BETWEEN SITE CONDITIONS AS SHOWN ON THIS DRAWING TO THOSE EXISTING AT TIME OF CONSTRUCTION.
8. FOR TREE PLANTING DETAILS REFER TO 
9. REFER TO DETAIL  FOR PLANTING ON RIPRAP BERM
10. REFER TO DETAIL  FOR LIVE WILLOW STAKES PLANTING DETAIL


LEGEND:

-  PLANTING
-  1m GRAVEL PATHWAY ON BERM
-  EXISTING CONCRETE
-  HEAVY DUTY ASPHALT
-  LIMIT OF WORK
-  CONTOURS
-  EXISTING VEGETATION
-  JERSEY BARRIER
-  WOODEN POST
-  NEW TRAIL CONSTRUCTION

PLANT LIST				
SYMBOL	BOTANICAL NAME	COMMON NAME	SIZE	QUANTITY
TREES				
	LODGEPOLE PINE	PINUS CONTORTA 'LATIFOLIA'	1m HT. MIN.	15
	WHITE SPRUCE	PICEA ABIES 'PENDULA'	2.5m HT. MIN.	10
TOTAL TREES :				25
SHRUBS				
	WOLF WILLOW	ELAEAGNUS COMMUTATA	#2. MINIMUM 300mm SPREAD OR HEIGHT	15
	RED OSIER DOGWOOD	CORNUS SERICEA	#2. MINIMUM 300mm SPREAD OR HEIGHT	25
	LIVE WILLOW STAKES	SALIX SPP.	1.5m WILLOW STAKES	40
TOTAL SHRUBS :				80

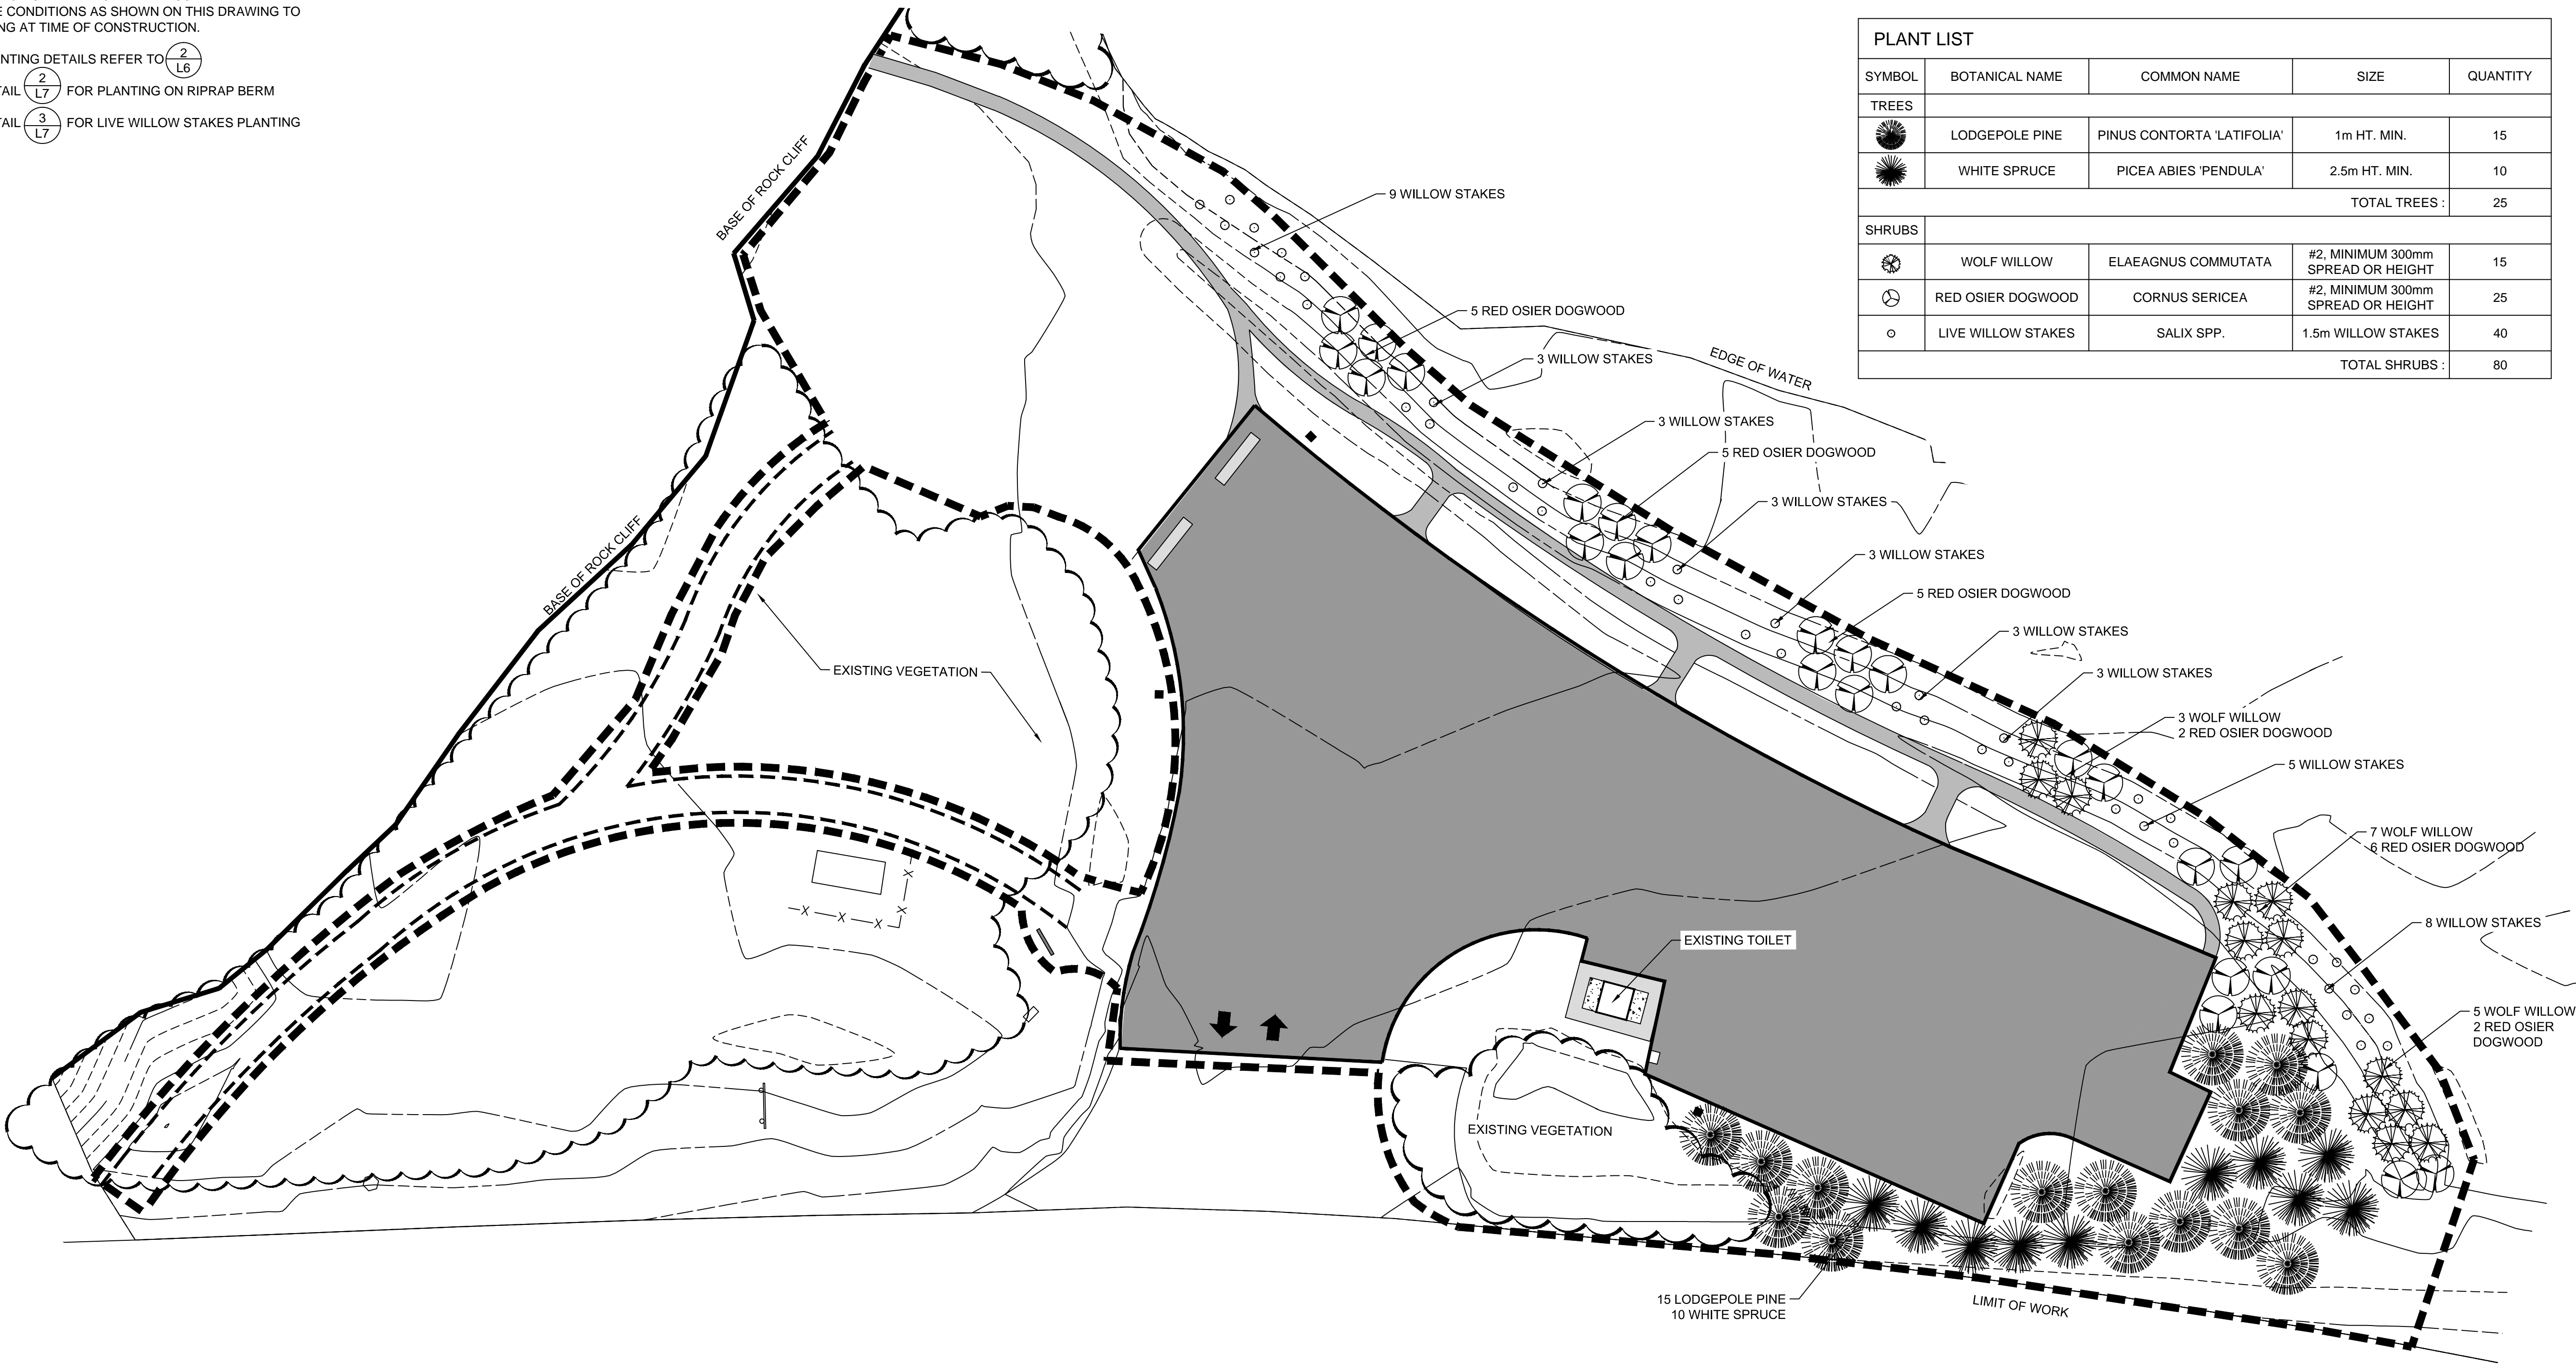


1 PLANTING PLAN
L5 SCALE - 1:250

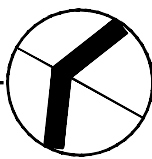

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6. FOR CLIENT REVIEW		AB	MAR 18, 2015
5. FOR CLIENT REVIEW		AB	MAR 4, 2015
4. FOR 95% REVIEW		AB	DEC, 2014
3. FOR CLIENT REVIEW		AB	NOV 10, 2014
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1. FOR CLIENT REVIEW		AB	AUG 25, 2014

CHECKED BY	DATE	
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TENDER		
CONSTRUCTION		

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SCALE
As Shown


PROJECT TITLE

HEALY CREEK
PARKING LOT
RESTORATION


SHEET TITLE
PLANTING PLAN

SHEET NO.
L5


FILE NO.
2014-09

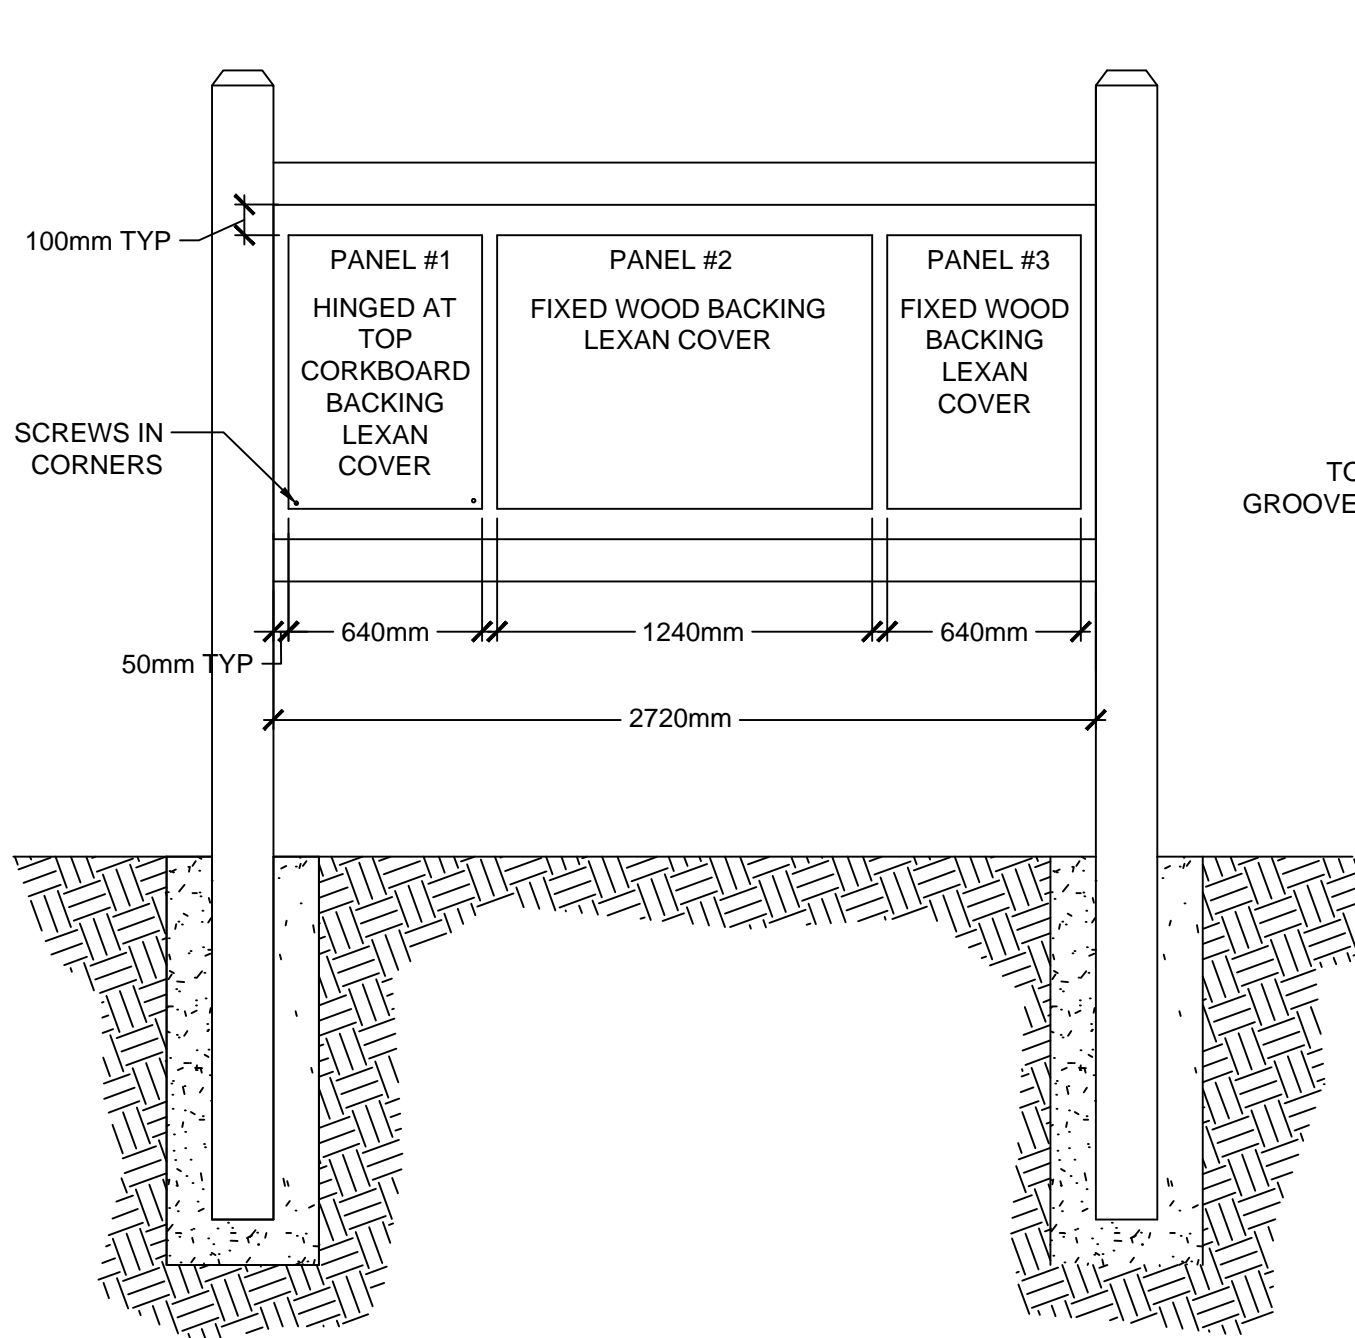


FRONT ELEVATION

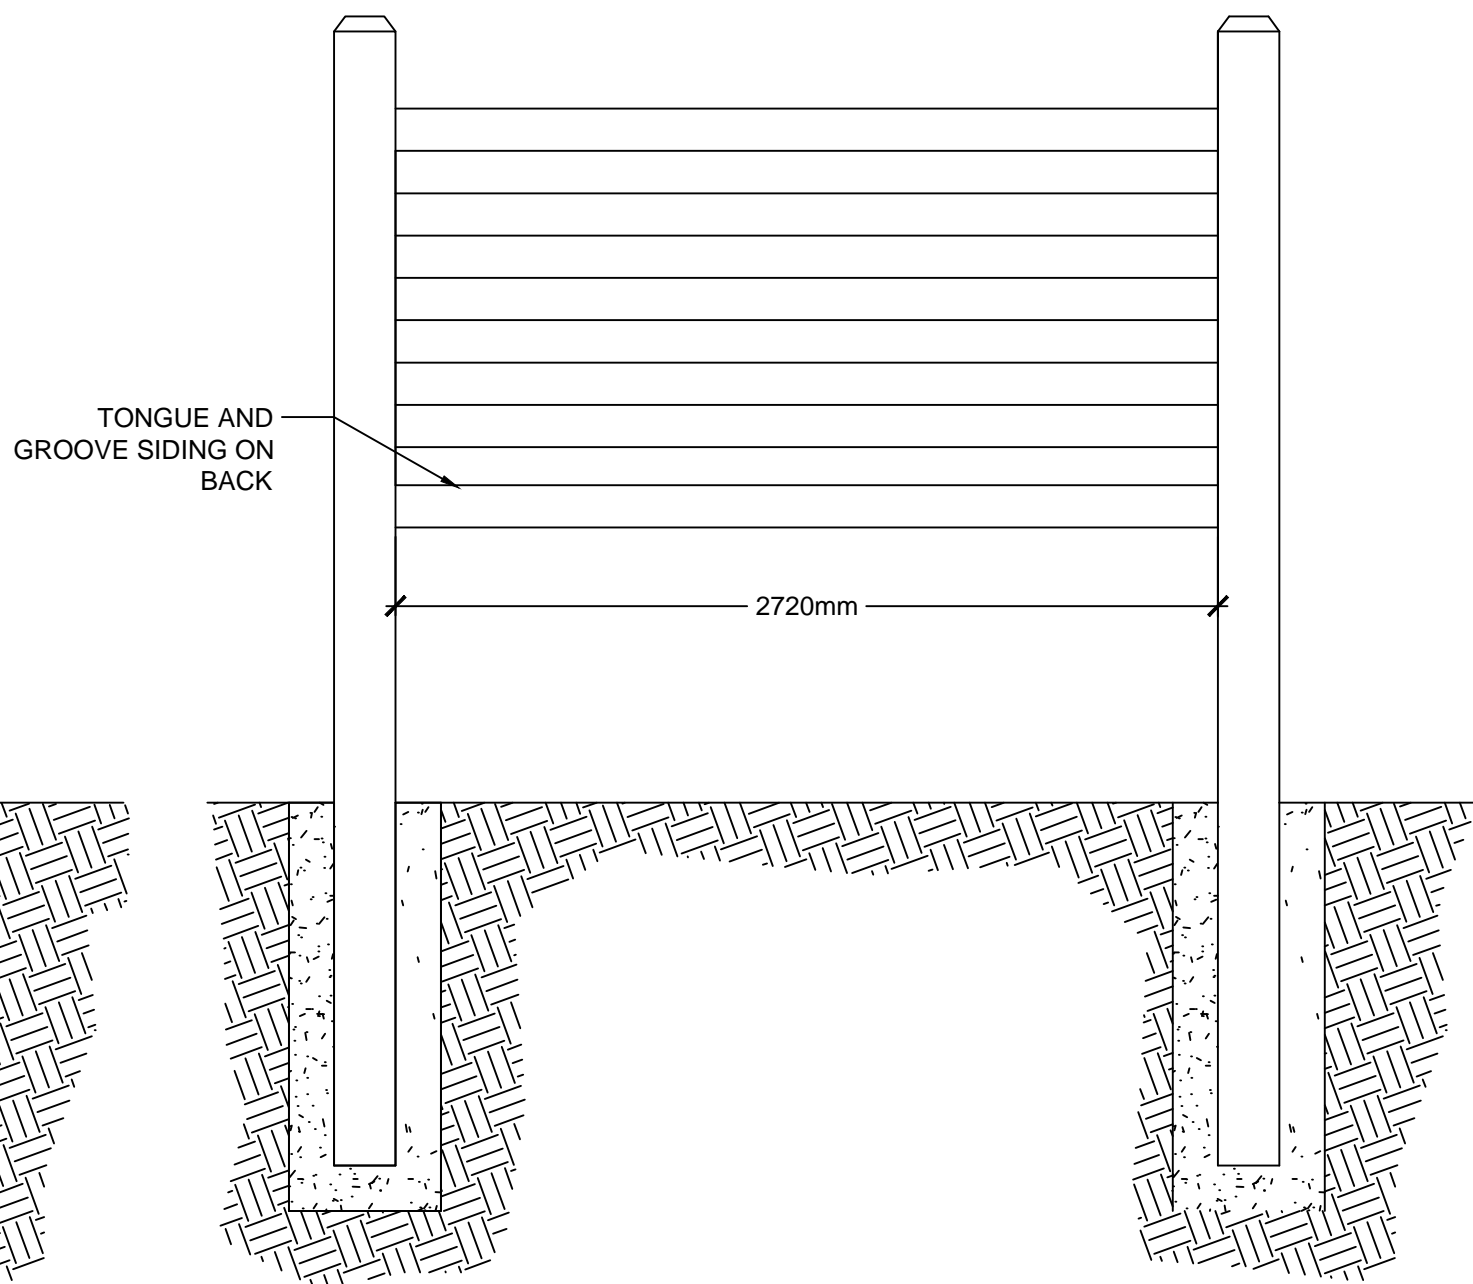


BACK ELEVATION

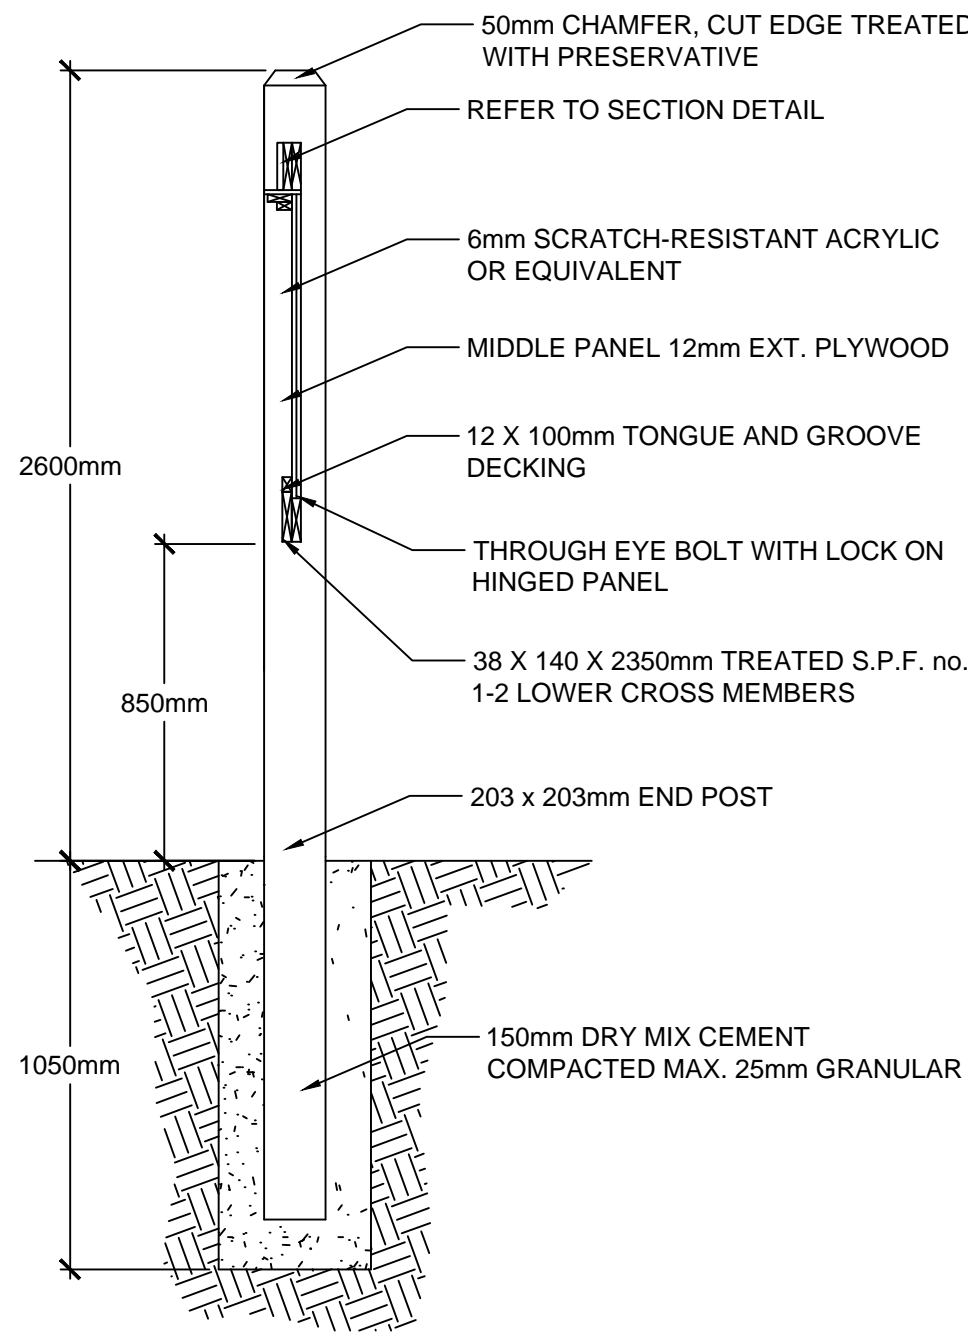

SIDE ELEVATION

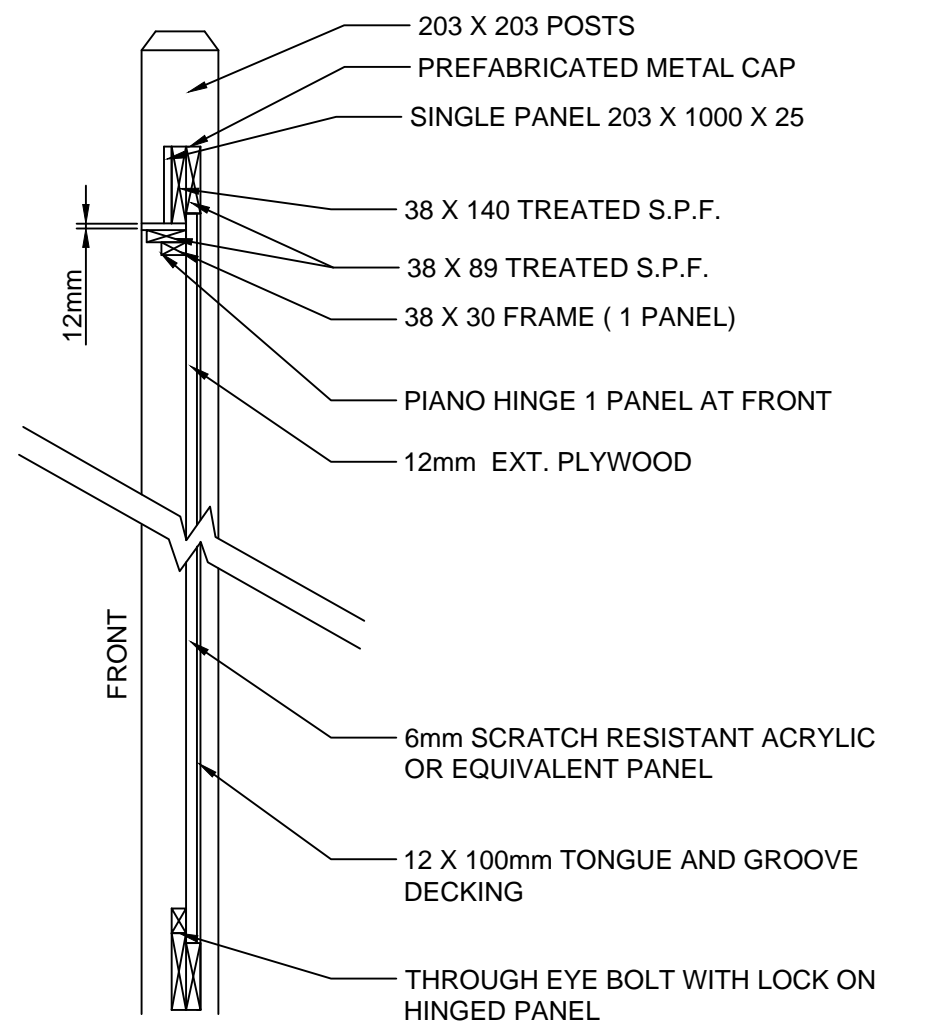

CAP FORMED WITH 16 GAUGE STEEL (POWDER COATED) OVER LAMINATED 52 X 152 TIMBER BEAM. TO BE FORMED IN SHOP USING STANDARD SEAM EQUIPMENT PRIOR TO FIELD WORK.


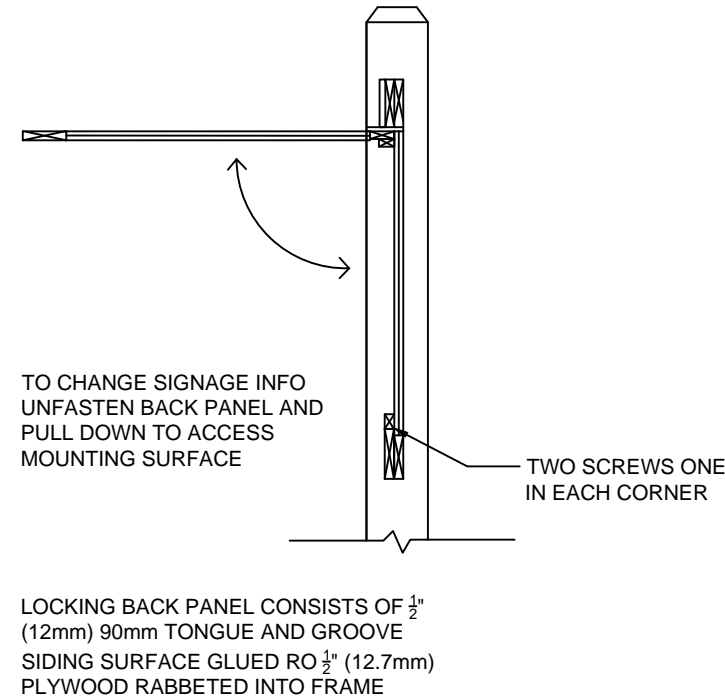


3 PANEL TRIAL HEAD KIOSK NOTES:

1. ALL TIMBERS ARE TO BE SPF TREATED.
2. ALL TIMBERS ARE TO BE SECURED WITH GALVANIZED, BRASS, OR STAINLESS STEEL SCREWS.
3. FIXED PANELS TO BE FASTENED WITH TAMPER PROOF SCREWS.

NOTE:

INSTALL LIVE WILLOW ONLY ON BREWSTER CREEK SIDE OF BERM.

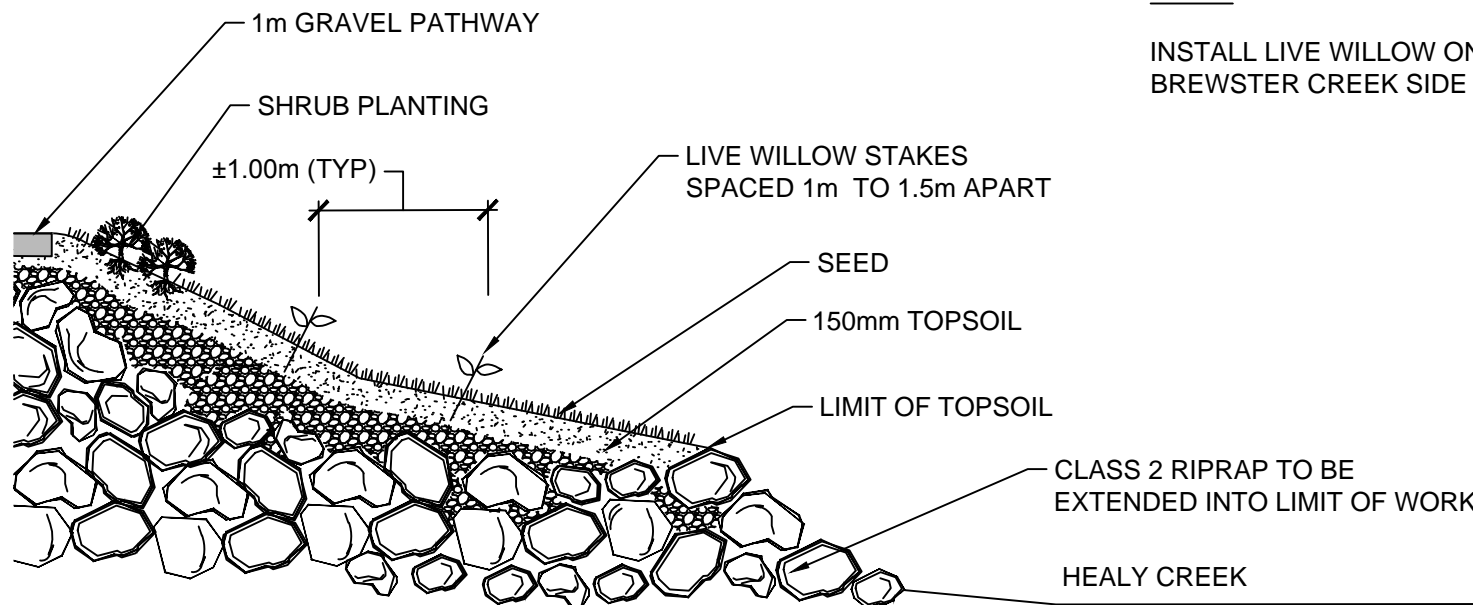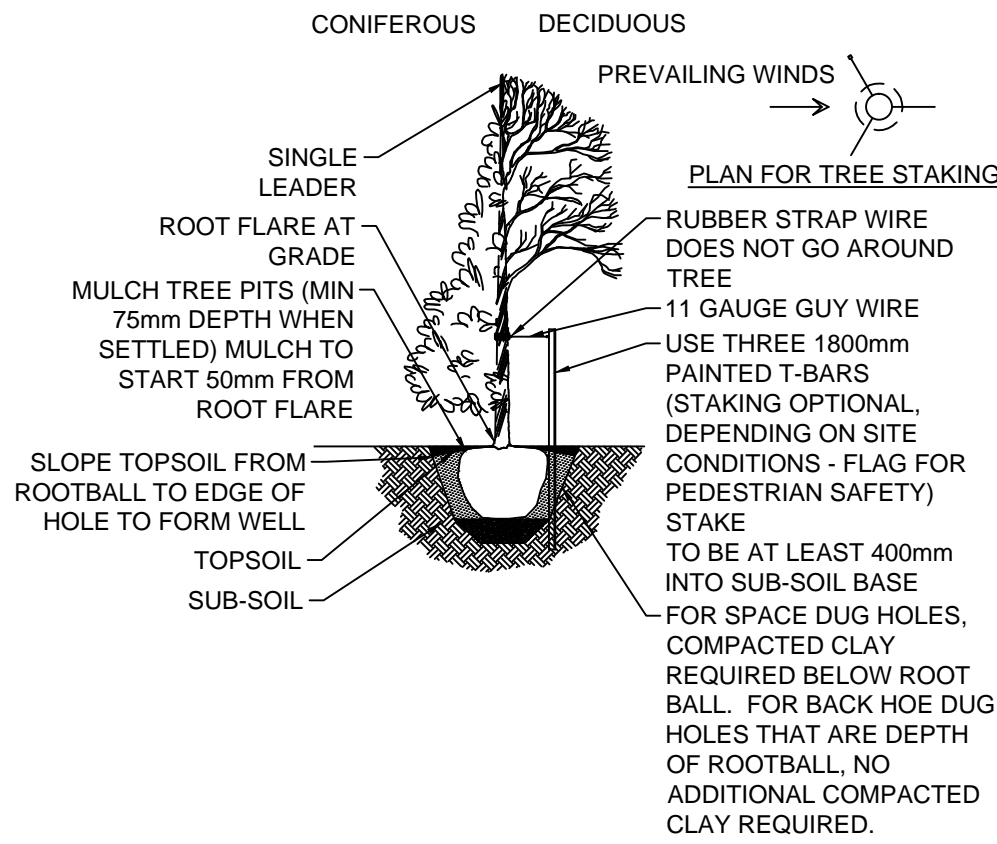

1 3 PANEL TRAIL HEAD KIOSK DETAIL
L6 SCALE - 1:25

2 TREE PLANTING DETAIL
L6 NTS

3 LIVE WILLOW STAKES PLANTING DETAIL
L6 SCALE - 1:50

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SCALE
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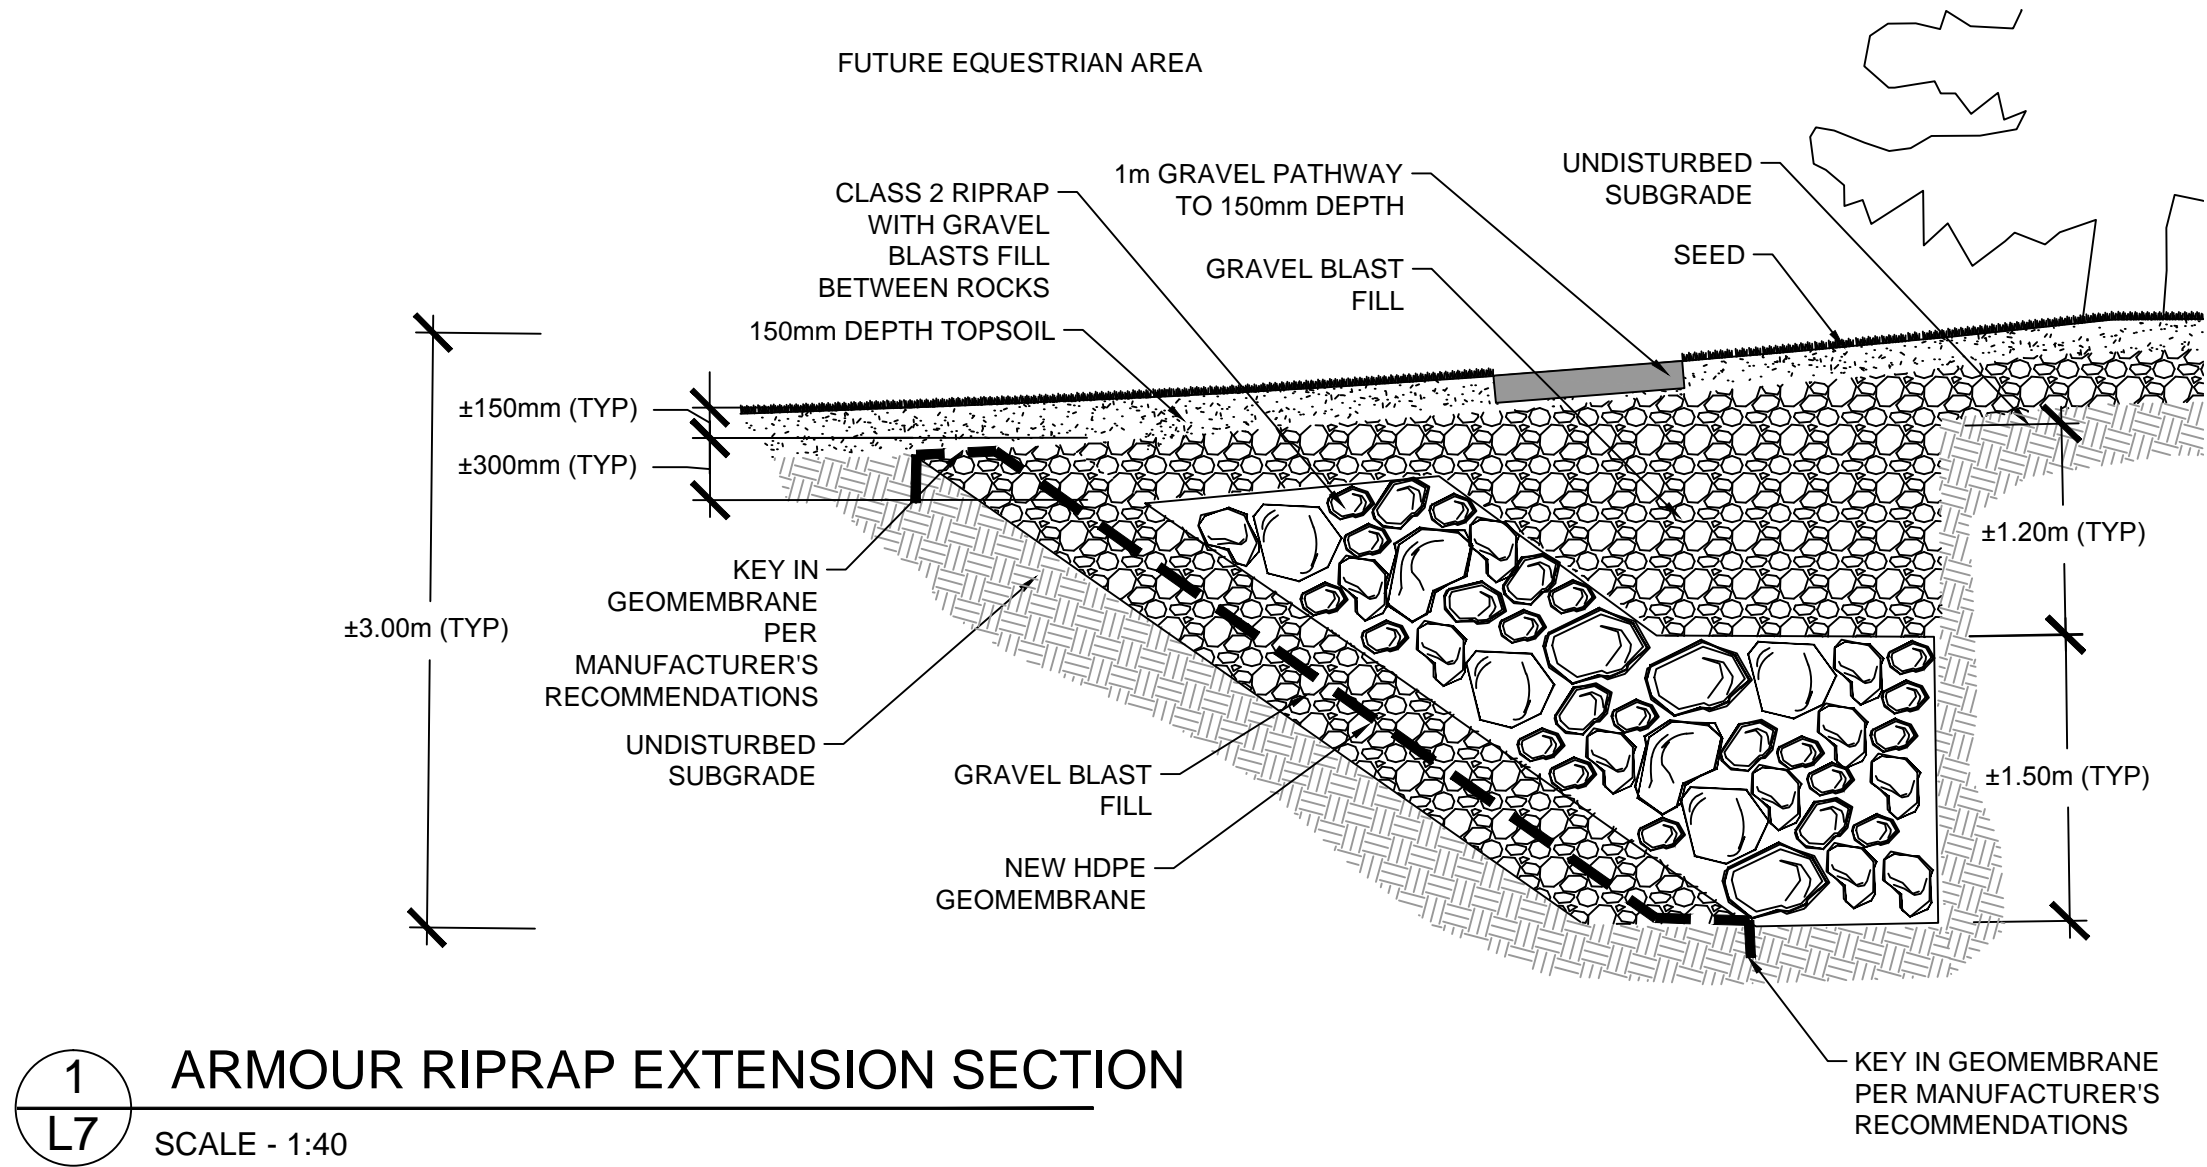
PROJECT TITLE

HEALY CREEK
PARKING LOT
RESTORATION


SHEET TITLE

PLANTING AND
KIOSK DETAILS


SHEET NO. L6	FILE NO. 2014-09
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1
L7 **ARMOUR RIPRAP EXTENSION SECTION**
SCALE - 1:40



2
L7 **RIPRAP BERM PLANTING SECTION**
SCALE - 1:40

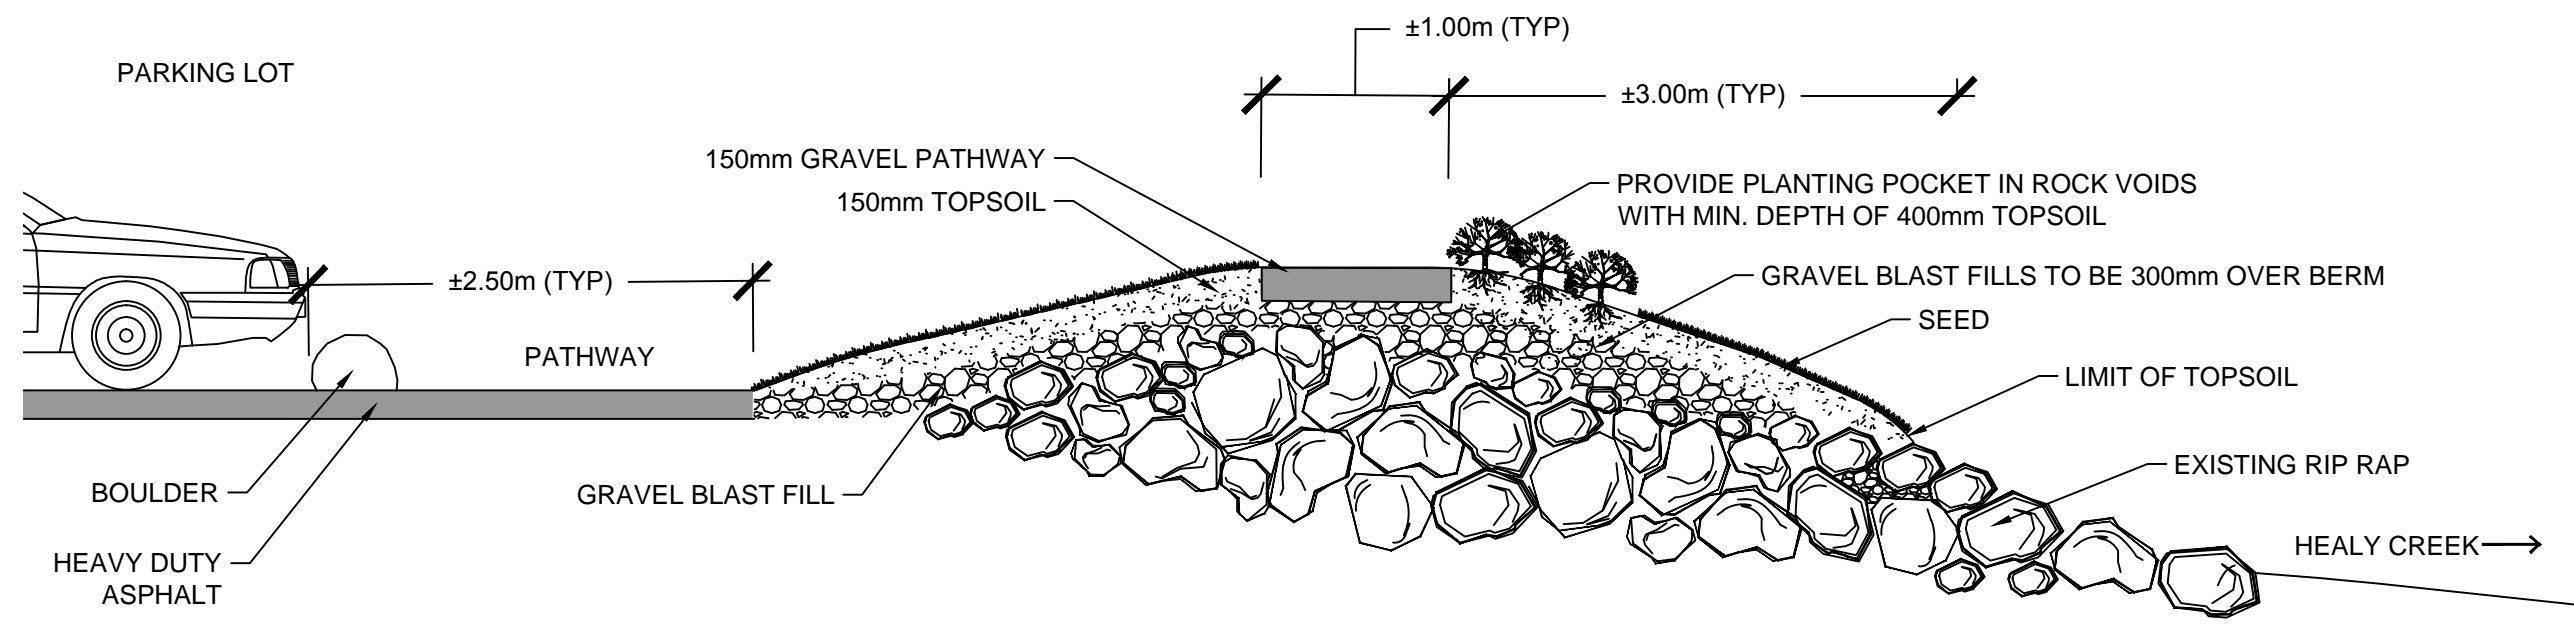

3
L7 **ARMOURED RIPRAP EXTENSION PLAN**
SCALE - 1:125

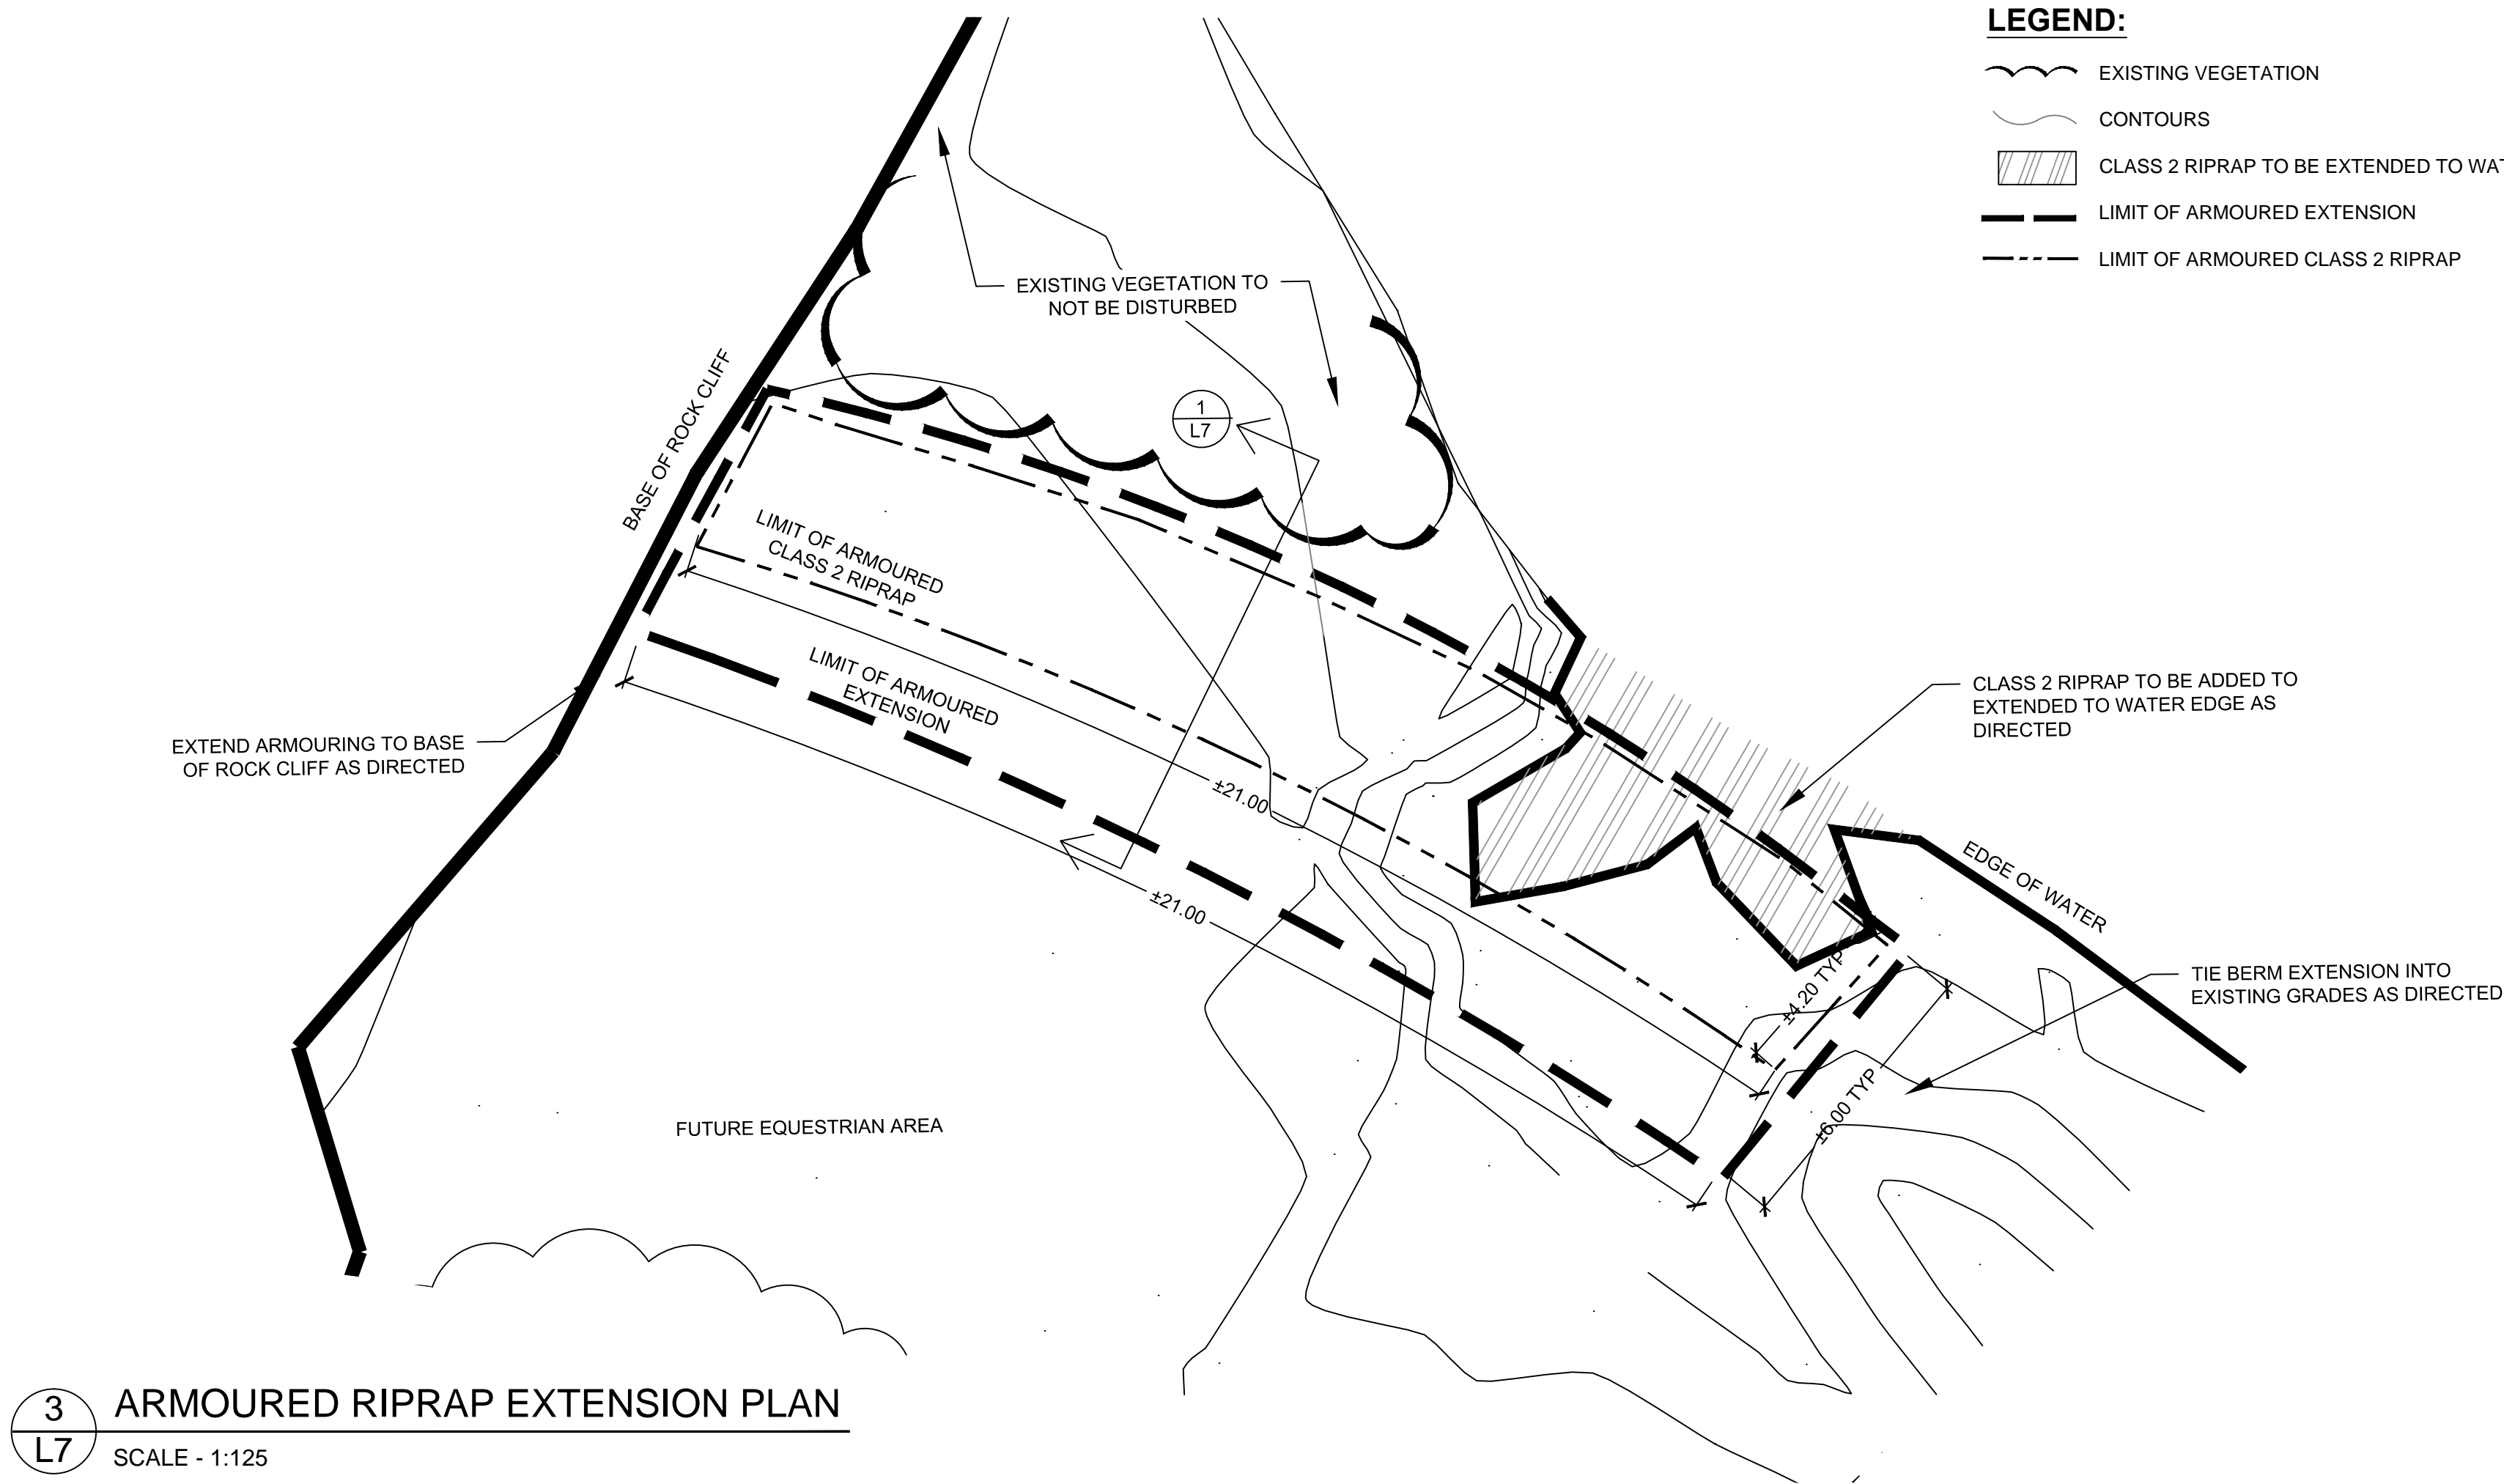LEGEND:

- EXISTING VEGETATION
- CONTOURS
- CLASS 2 RIPRAP TO BE EXTENDED TO WATER
- LIMIT OF ARMOURED EXTENSION
- LIMIT OF ARMOURED CLASS 2 RIPRAP

NEW ARMOURED RIPRAP EXTENSION:

- CONTRACTOR TO EXCAVATE AND REMOVE ALL EXISTING MATERIAL IN AREA IDENTIFIED ON PLAN TO A DEPTH OF APPROX. 1.8m AND DISPOSE OFFSITE AS DIRECTED BY DEPARTMENTAL REPRESENTATIVE.
- REFER TO RIPRAP EXTENSION DETAIL **1/L7**
- RIPRAP EXTENSION IS TO BE CONSTRUCTED OUT OF CLASS 2 RIPRAP OR SIMILAR APPROVED MATERIAL.
- SUITABLE FINE-GRAIN MATERIALS SALVAGED FROM BREWSTER CREEK TRAIL CONTRACT OR SUITABLE MATERIAL EXCAVATED FROM ARMOURED RIPRAP EXTENSION ARE TO BE USED TO FILL IN VOIDS IN THE CLASS 2 RIPRAP.
- 150mm DEPTH TOPSOIL IS TO BE APPLIED TO SURFACE OF THE RIPRAP EXTENSION AND SEEDED - REFER TO L4 TOPSOIL AND SEEDING PLAN.
- REFER TO L 5 PLANTING PLAN FOR LOCATIONS OF SHRUB PLANTING ALONG ARMOURED RIPRAP EXTENSION.

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PROJECT TITLE
**HEALY CREEK
PARKING LOT
RESTORATION**

SHEET TITLE
**RIPRAP BERM
DETAILS**

SHEET NO.
L7
FILE NO.
2014-09

GENERAL NOTES:


1. REFER TO L1 DEMOLITION PLAN FOR LIST OF GENERAL NOTES.

PARKING LOT AND PARKING LINES NOTES:

1. ALL PARKING LINES ARE TO BE PAINTED WHITE 50mm WIDE.
2. DESIGNATED PARKING AREAS PARKING LINES ARE TO BE PAINTED 0.5m APART ON A 45° ANGLE.
3. HEAVY DUTY ASPHALT TO BE 100mm THICK.
4. REFER TO L3 PATHWAY AND SITE FURNISHINGS LAYOUT FOR WOODEN SIGNAGE NOTES.
5. SUPPLY, LOAD, HAUL AND PLACE ±1m BLAST ROCK, LIMESTONE OR SIMILAR APPROVED PARKING BOULDERS TO LOCATIONS AS INDICATED ON PLAN OR BY DEPARTMENTAL REPRESENTATIVE.
6. ENSURE BOULDERS ARE SET IN SECURE MANNER AND WILL NOT MOVE OR TIP OVER.
7. SCHEDULE INSTALLATION OF BOULDERS AFTER PAINTING OF LINE MARKERS.

LEGEND:


- LIMIT OF WORK
- ~ EXISTING VEGETATION
- EXISTING CONCRETE
- JERSEY BARRIER
- CONTOURS
- HEAVY DUTY ASPHALT
- DESIGNATED PARKING AREAS
- WOODEN POST
- HAUL-ALL TRASH RECEPTACLE
- BOULDER
- NEW TRAIL CONSTRUCTION

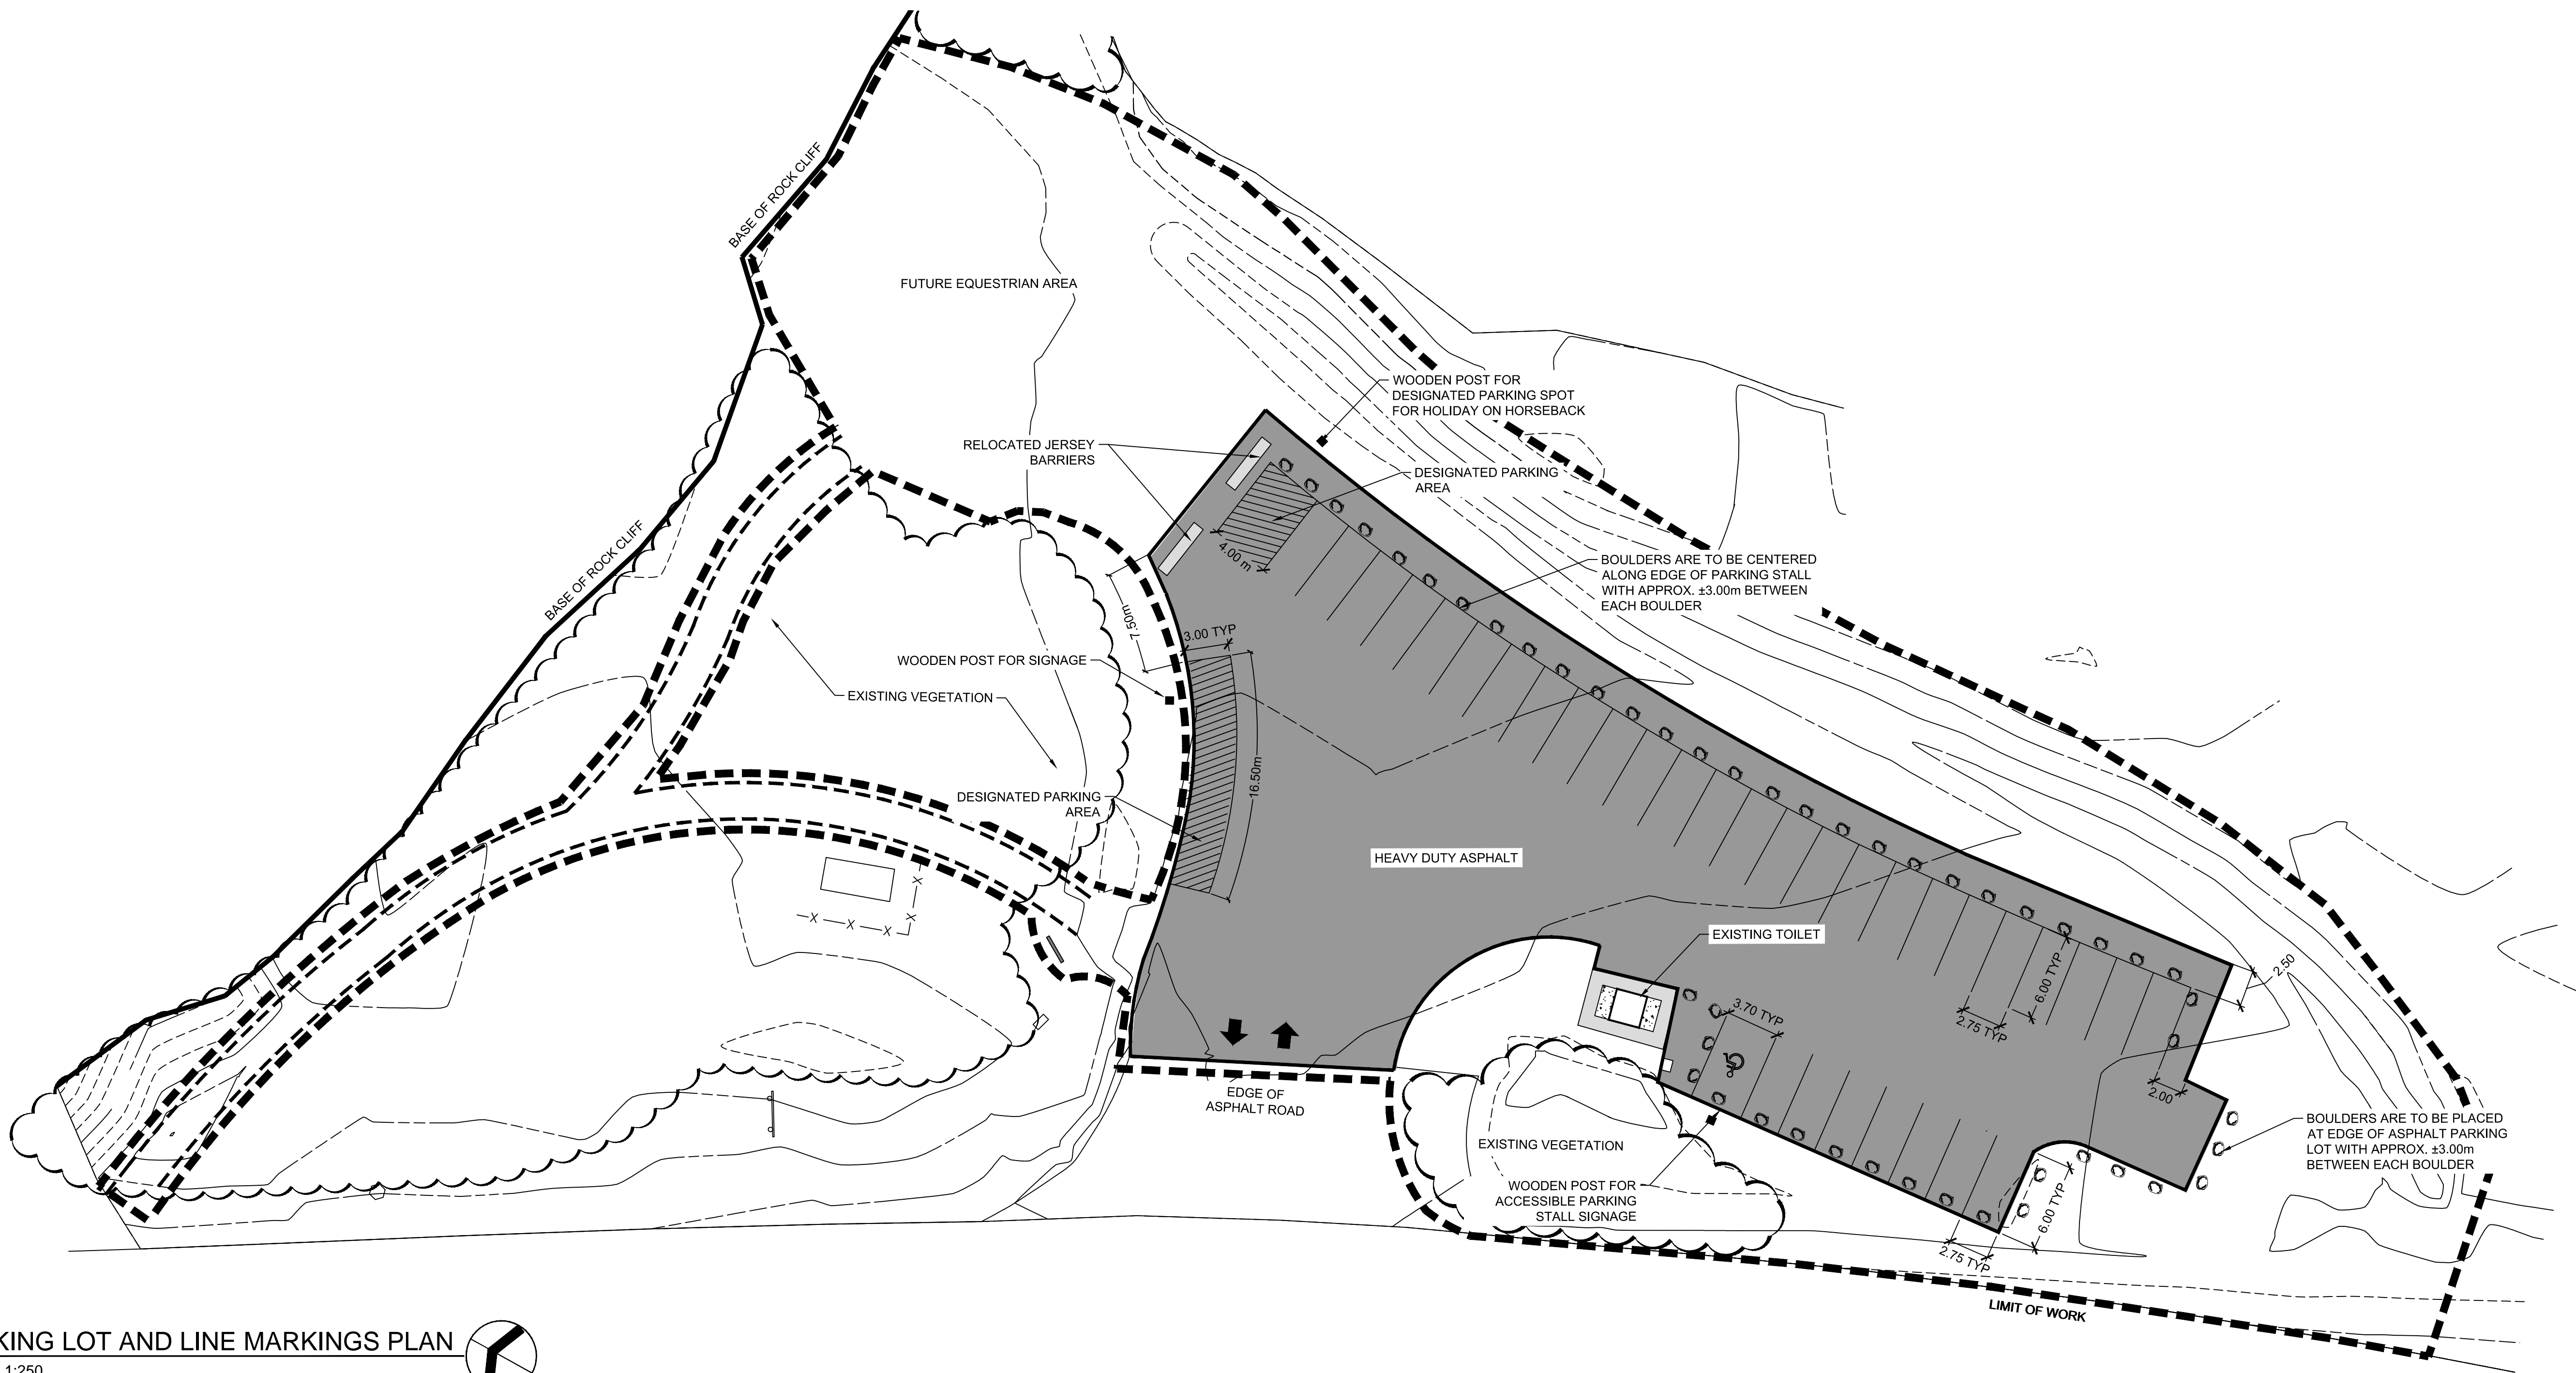


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
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
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PROJECT TITLE

HEALY CREEK
PARKING LOT
RESTORATION

SHEET TITLE

PARKING LOT AND
LINE MARKING
PLAN

SHEET NO. L8	FILE NO. 2014-09
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