



LEGEND - WALL CONSTRUCTION
SEE PARTITION SCHEDULE FOR TYPE
SEE FLOOR PLAN FOR LOCATION
NOTE : ALL NEW WALLS TO
UNDERSIDE OF STEEL DECK ABOVE.
EXISTING CONSTRUCTION TO REMAIN

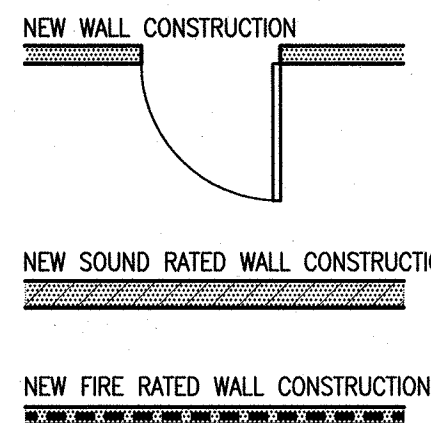


NORTH

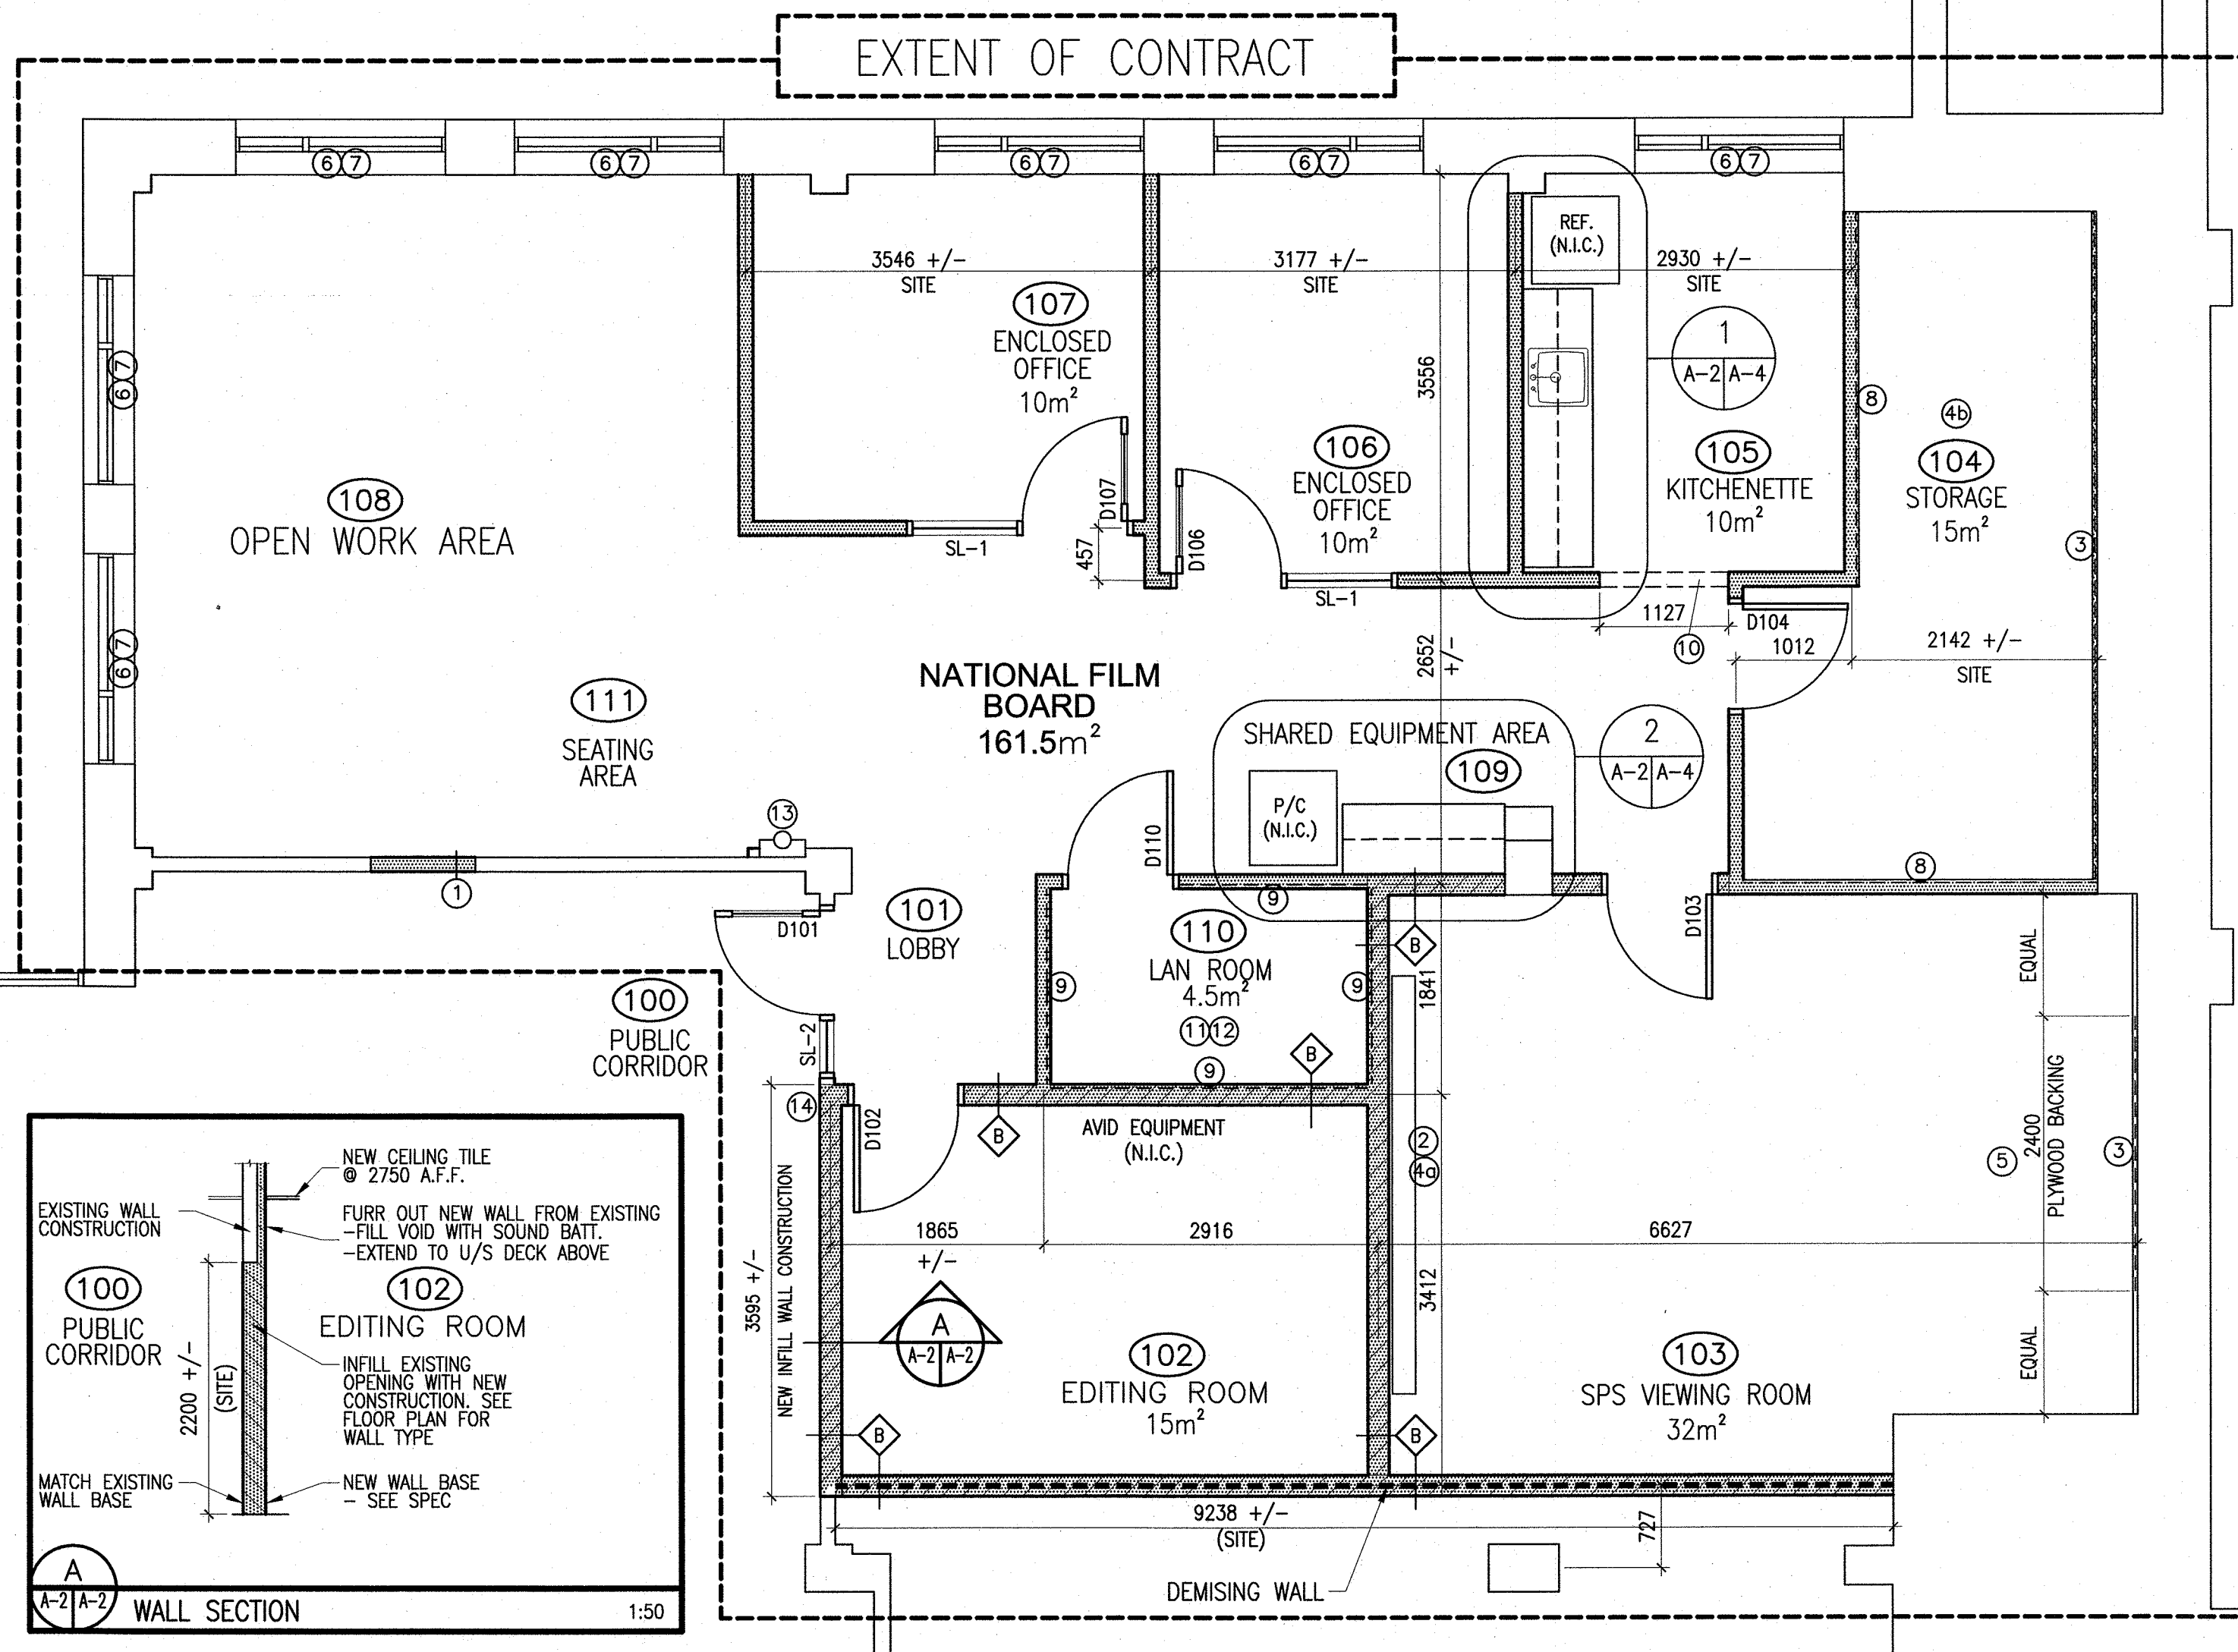

PARTITION SCHEDULE

NOTE : ALL NEW WALLS TO UNDERSIDE OF STEEL DECK ABOVE.

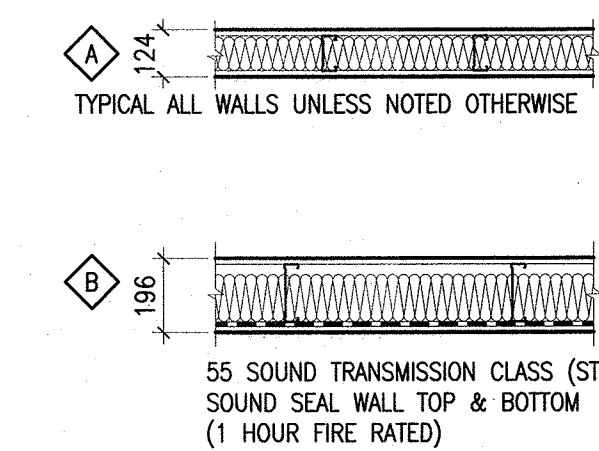

NEW WALL CONSTRUCTION
- 16mm GYPSUM BOARD PAINTED
- 92mm METAL STUD @ 400mm ON CENTER (o.c.)
- 89mm ABSORPTIVE MATERIAL
- 16mm GYPSUM BOARD PAINTED

NEW SOUND RATED WALL CONSTRUCTION
- 16mm TYPE X GYPSUM BOARD PAINTED
- 152mm x .08mm METAL STUD (20ga.) @ 610mm o.c.
- 125mm SOUND ABSORPTIVE MATERIAL
- 13mm RESILIENT CHANNEL @ 610mm o.c. HORIZONTAL
- 16mm TYPE X GYPSUM BOARD PAINTED

NOTES


- INFILL EXISTING DOOR OPENINGS WITH NEW METAL STUD @ 400mm o.c. NEW GYPSUM BOARD TO MATCH EXISTING TYPE/THICKNESS AND PAINT. MAKE GOOD ALL SURFACES.
- PROJECTION SCREEN (N.I.C.) - PROVIDE BLOCKING IN WALL TO SECURE PROJECTION SCREEN.
- PROVIDE AND INSTALL 19mm PLYWOOD SUPPORT ON EXISTING WALL FROM FLOOR TO 2400mm HIGH AND COVER IN 16mm TYPE 'X' GYPSUM BOARD PAINTED.
- REMOVE DRAPERY FROM EXISTING LOCATION (HERITAGE COURT, 95 FOUNDRY STREET, MONCTON, NB) AND REINSTALL AT NEW LOCATION. ALTER DRAPERY AS NECESSARY TO SUIT. PROVIDE BLOCKING AT WALL TO SECURE DRAPERY ROD.
- SEE SHEET A-5 - FURNITURE PLAN - FOR RELOCATED STORAGE CABINETS
- PROVIDE AND INSTALL MOUNTING BRACKET (SEE ELECTRICAL FOR POWER AND VIDEO LINE FOR CEILING MOUNTED PROJECTOR) - LOCATION AS PER CLIENT INSTRUCTION. PROJECTOR SUPPLIED BY CLIENT.
- REMOVE EXISTING LAMINATE AT WINDOW SILL AND SKIRT, MAKE GOOD ALL SURFACES TO ACCEPT NEW. PROVIDE AND INSTALL NEW PLASTIC LAMINATE AT EXISTING WINDOW SILL AND SKIRT. -SEE A-4 CASEWORK NOTES FOR TYPE
- PROVIDE AND INSTALL NEW ROLLER BLIND AT EXISTING WINDOW. -WOVEN SUNSCREEN 3% (SEE SPECIFICATION)
- PROVIDE AND INSTALL 19mm PLYWOOD SUPPORT IN WALL FROM FLOOR TO 2400mm HIGH.
- PROVIDE AND INSTALL FIRE RATED 19mm PLYWOOD SUPPORT IN WALL FROM FLOOR TO 2400mm HIGH.
- DOOR OPENING IS TO BE FROM FINISHED FLOOR TO 2100mm A.F.F.
- SERVER - SEE ELECTRICAL FOR SIZE AND LOCATION - 1000mm CLEARANCE AT ACCESS
- ELECTRICAL PANEL - SEE ELECTRICAL FOR SIZE AND LOCATION - 1000mm CLEARANCE AT ACCESS
- FIRE EXTINGUISHER C/W SEMI-RECESSED CABINET
- WALL MOUNTED PHONE - SEE ELECTRICAL

Public Works and Government Services Canada
Travaux Publics et Services gouvernementaux Canada

DESIGN STUDIO COMMERCIAL INTERIOR DESIGN PROJECT MANAGEMENT

BEVERLY BARRETT
REGISTERED INTERIOR DESIGNER
ARIDNB, IDC
P.O.Box 1803 MONCTON NB BRUNSWICK E1C 9X6
PH 857-9003 design@beverlybarrett.ca
www.beverlybarrett.ca

EQ. (N.I.C.) U.N.O. REF. LAN TYP. C/W
EQUAL NOT IN CONTRACT UNLESS NOTED OTHERWISE REFRIGERATOR (N.I.C.) PHOTOCOPIER (N.I.C.) LOCAL AREA NETWORK TYPICAL COMPLETE WITH

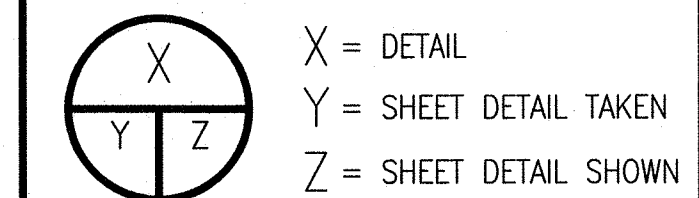

FLOOR PLAN


DOOR SCHEDULE

	NO.		LOCATION			DOOR								FRAME					REMARKS	
REVISION	DOOR	FROM	TO	DIRECTION (SWING)	SIZE			TYPE	MATERIAL	ULC RATING (MINUTES)	STC RATING	GLASS	HARDWARE SET	DETAILS					<u>LEGEND</u> HM - HOLLOW METAL WD - WOOD PS - PRESSED STEEL TG - TEMPERED GLASS	
					HEIGHT	WIDTH	THICKNESS							TYPE FRAME	TYPE WALL	DETAIL FRAME	MATERIAL	NOTES		
	D101	100	101	LHR	2134	914	45	B	WD	--	--	TG	#1	HM-4	A	NOTE 2	PS	--	CLOSURE / ELECTRIC STRIKE PLATE	
	D102	101	102	RH	2134	914	NOTE 1	C	WD	--	--	--	#2	HM-3	B	--	PS	--	STC RATING OF 53	
	D103	109	103	LH	2134	914	NOTE 1	C	WD	--	--	--	#2	HM-3	B	--	PS	--	STC RATING OF 53	
	D104	109	104	LH	2134	914	45	A	WD	--	--	--	#3	HM-1	A	--	PS	--	--	
	D106	109	106	LH	2134	914	45	A	WD	--	--	TG	#4	HM-2	A	--	PS	--	--	
	D107	109	107	RH	2134	914	45	A	WD	--	--	TG	#4	HM-2	A	--	PS	--	--	
	D110	109	110	LHR	2134	914	45	A	WD	--	--	--	#5	HM-1	A	--	PS	--	--	


NOTE 1 : DOOR THICKNESS AS PER MANUFACTURE SPECIFICATION TO ACHIEVE NOTED STC RATING.
NOTE 2 : ELECTRIC STRIKE PLATE AS PER DOOR HARDWARE SCHEDULE
HARDWARE AS PER SPECIFICATION

DOOR SCHEDULE


SCALE : N.T.S.

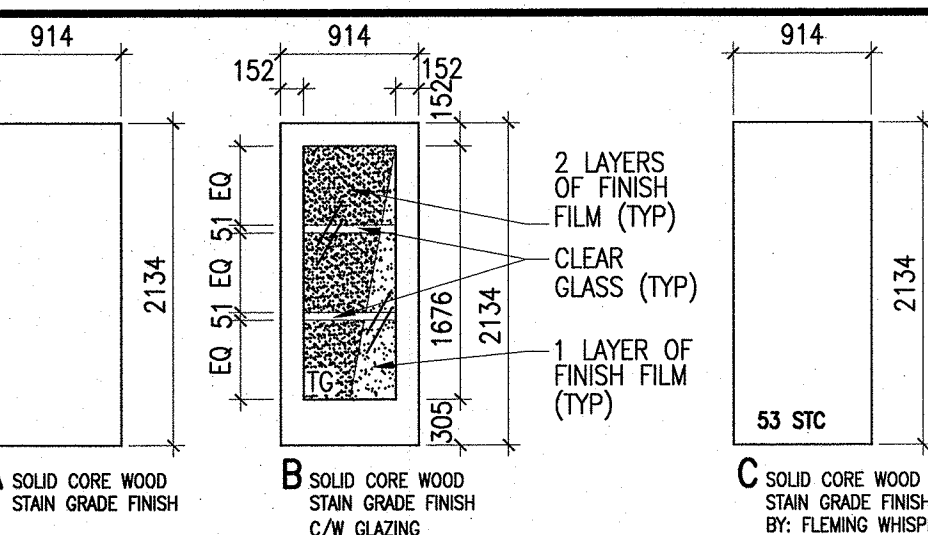

DOOR TYPE ELEVATIONS

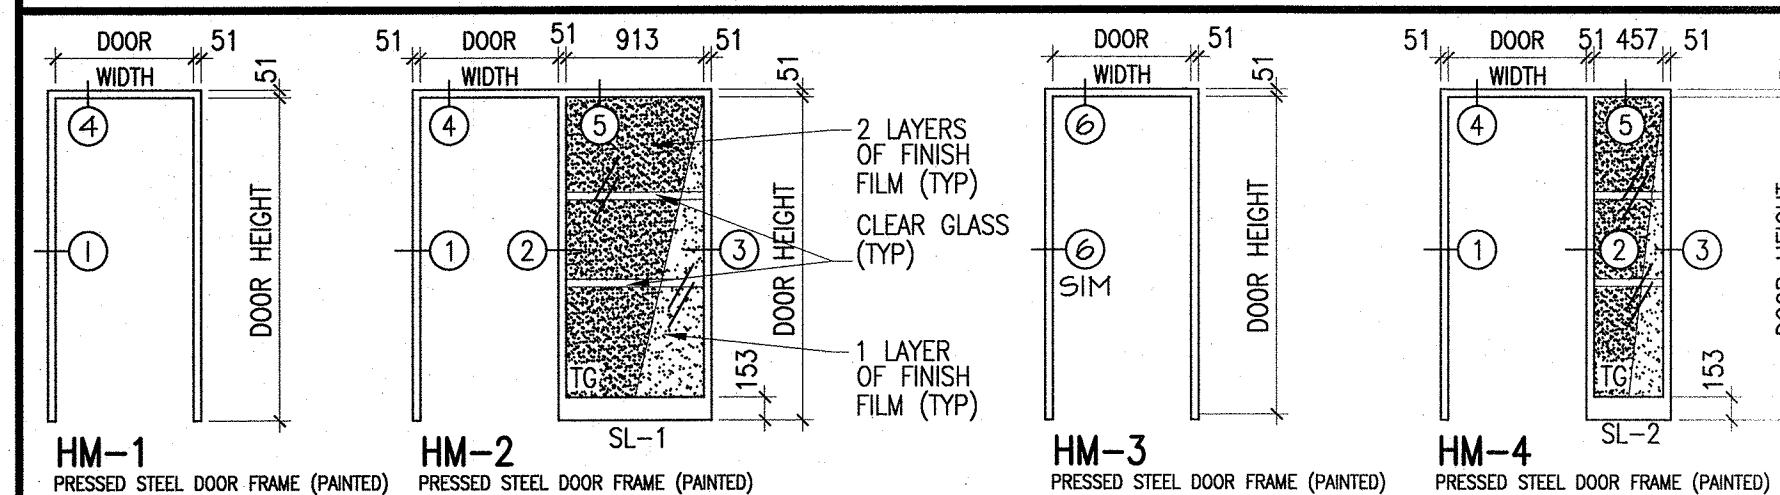

FRAME ELEVATIONS

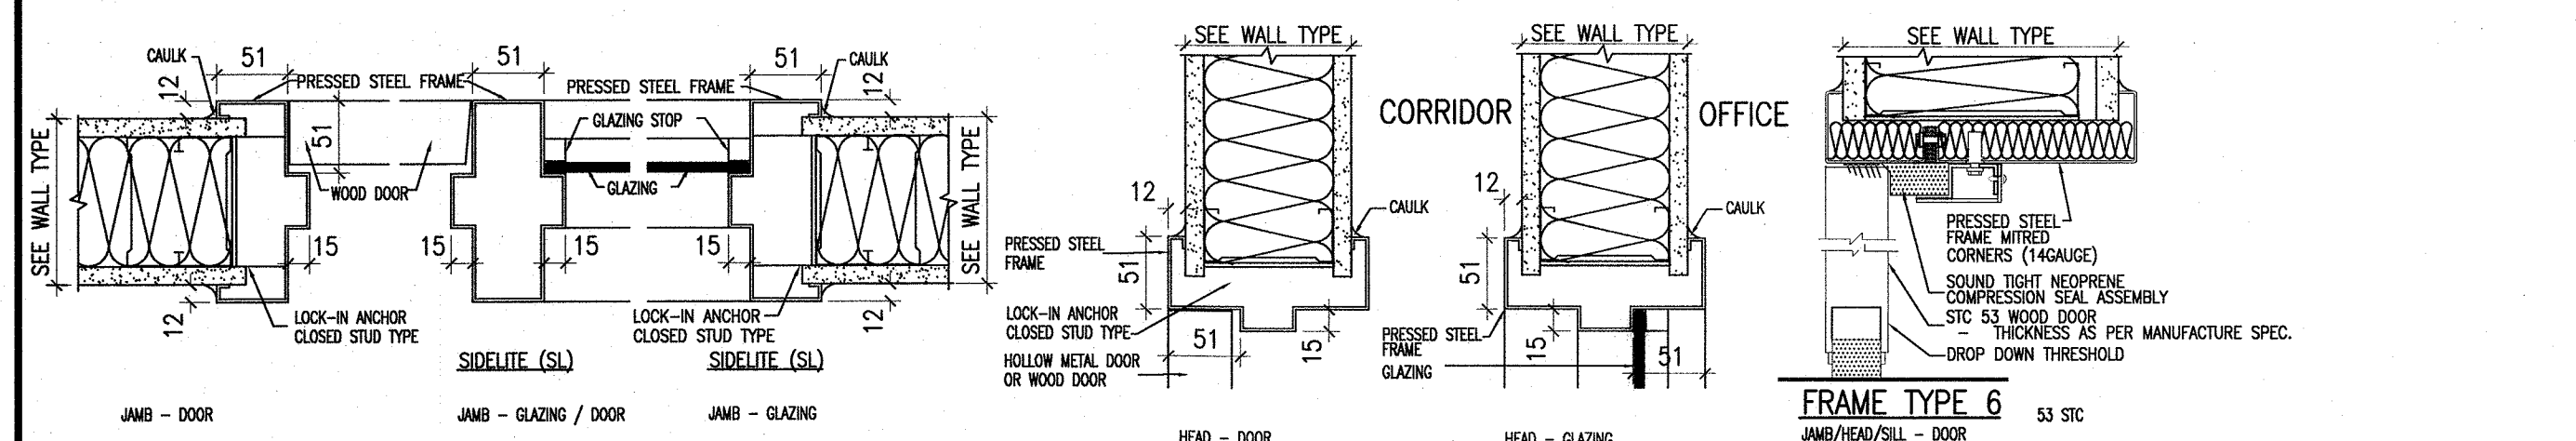

FRAME DETAILS

SCALE: 1:5

ISSUED FOR TENDER	06/11/15
ISSUED FOR 100%	03/03/15
revisions	date
project	project

NATIONAL FILM BOARD
FIT-UP
GOCB MONCTON
1081 MAIN STREET
MONCTON, NB

FLOOR PLAN DOOR SCHEDULE PARTITION SCHEDULE

designed BB	conçu
date	
drawn FK	dessiné
date March 03, 2015	
approved	approuvé
date	
Tender	Soumission
PWGSC Project Manager	Administrateur de projets TPSCG
project number	no. du projet
R.064333.001	
drawing no.	no. du dessin
A-2	