



2015/Apr/15

G:\2013\8013\8013-019\BPA\Elect\4-Tender\8013-019-E1-E6\_R01.dwg

0 10 20mm 40 60 80 100 120 140 160 180 200mm

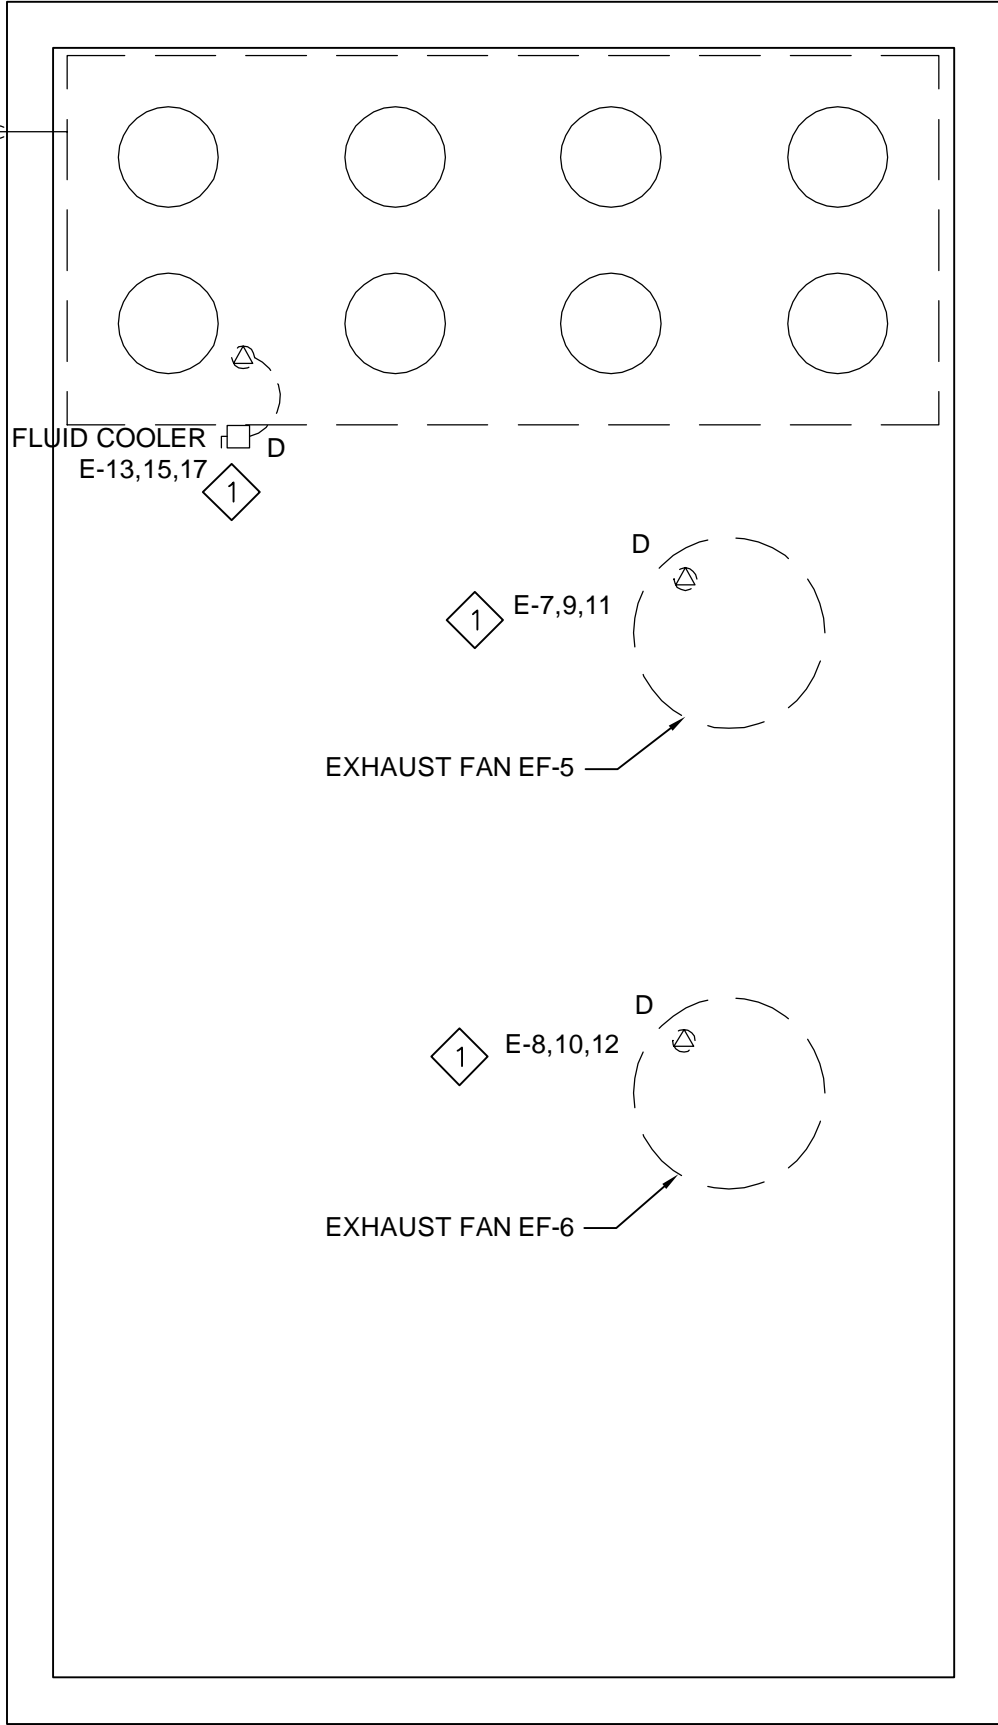

1 HYDRAULIC BUILDING - ROOF DEMOLITION  
E2  
SCALE 1:50

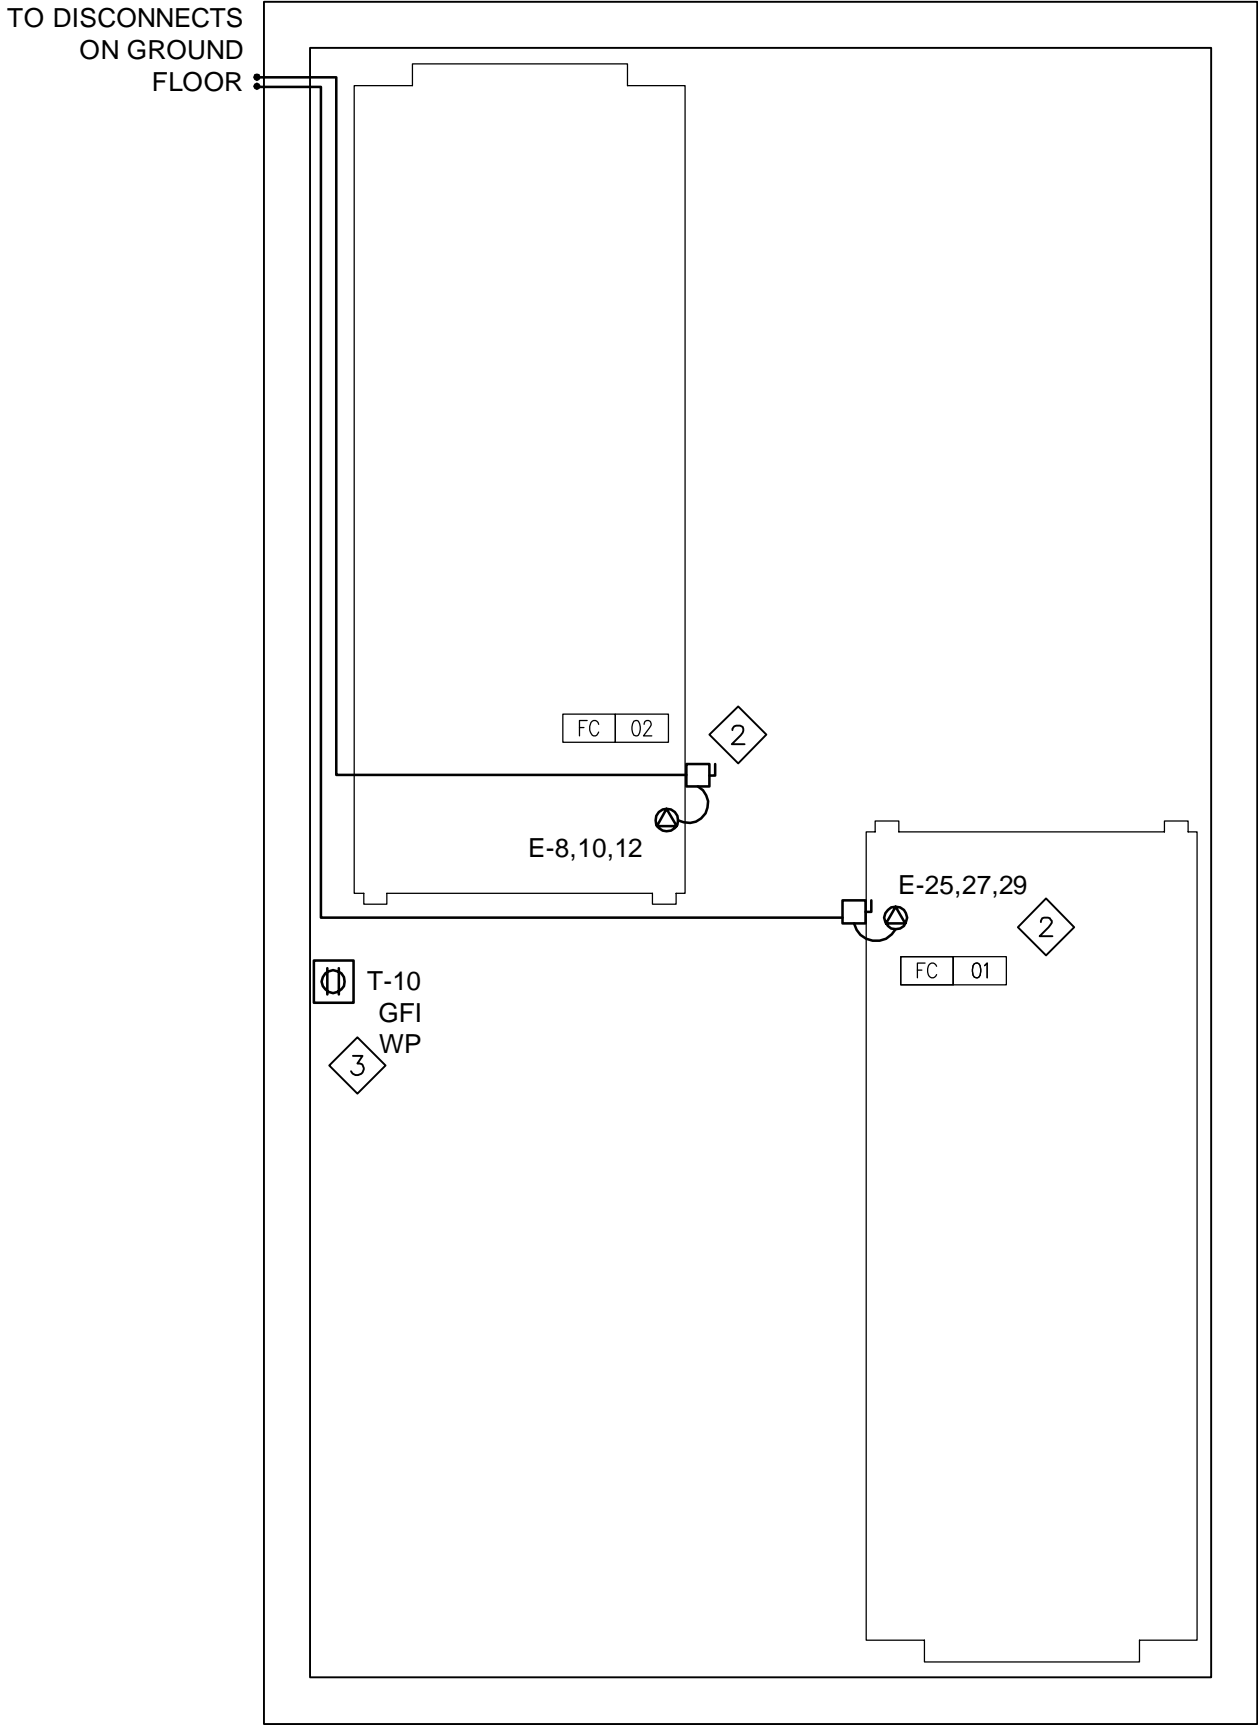

2 HYDRAULIC BUILDING - ROOF NEW  
E2  
SCALE 1:50

NOTES:

- 1 UPON CONNECTION AND START-UP OF THE TEMPORARY CHILLER, DISCONNECT EXISTING EQUIPMENT, AND ALL ASSOCIATED STARTER OR DISCONNECT. REMOVE WIRING AND CONDUIT BACK TO SOURCE.
- 2 PROVIDE DISCONNECTS, WIRING AND CONDUIT FOR FLUID COOLERS FC-01 AND FC-02. CONNECT FLUID COOLERS AS INDICATED. REFER TO THE SINGLE LINE DIAGRAM FOR CONNECTION DETAILS.
- 3 PROVIDE WEATHER-PROOF, 20A GFI DUPLEX RECEPTACLE, CONFIGURATION CSA 5-20R. MOUNT RECEPTACLE ON THE ROOF-TOP UNIT AT 750mm FROM FINISHED ROOF. PROVIDE 20A-1P BREAKER, WIRE AND CONDUIT AND CONNECT TO CIRCUITS AS INDICATED.


Canada

100-1960 Robertson Road, Suite 100  
Ottawa (Ontario) K2H 5B9  
(613) 596-6454  
(613) 596-3346 Fax  
www.bpa.ca




1960, chemin Robertson, bureau 100  
Ottawa (Ontario) K2H 5B9  
(613) 596-6454  
(613) 596-3346 - télécopieur  
www.bpa.ca

mechanical | electrical | energy | telecommunications  
mécanique | électricité | efficacité énergétique | télécommunications

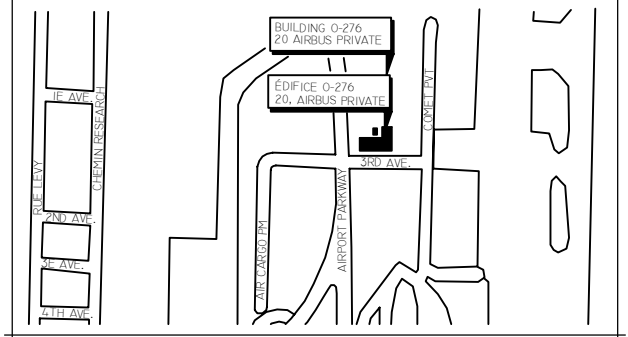

KEY PLAN  
PLAN-REPÈRE  
PROJECT NORTH  
N.T.S.  
PAS À L'ÉCHELLE  
NORD DU PROJET

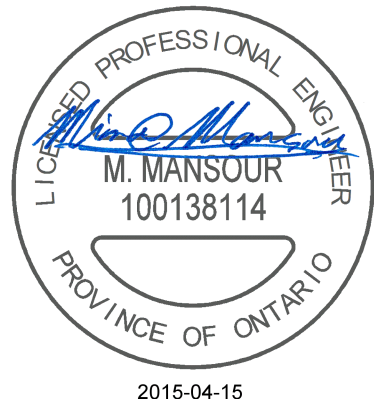

4	ISSUED FOR TENDER	2015-04-15
3	ISSUED FOR 100% REVIEW - TENDER	2015-01-30
2	ISSUED FOR 99% REVIEW	2014-10-23
1	ISSUED FOR 66% REVIEW	2014-09-09

revisions	description	date
A	A detail no. no du détail	A
C	B location drawing no. no du dessin de localisation C drawing no. no du dessin	B C

project  
CHILLER REPLACEMENT  
FOR TRANSPORT CANADA  
TRAINING CENTRE  
(BUILDING O-276)  
project

drawing  
HYDRAULIC BUILDING  
ROOF  
DEMOLITION AND NEW  
POWER LAYOUT  
dessin

Designed By	M.E.M.	Conçu par
Date	2014-10-17	(yyyy/mm/dd)
Drawn By	T.C.	Dessiné par
Date	2014-10-17	(yyyy/mm/dd)
Reviewed By	C.M.	Examiné par
Date	2014-10-21	(yyyy/mm/dd)
Approved By	M.E.M.	Approuvé par
Date	2014-10-21	(yyyy/mm/dd)
Tender		Soumission
Project Manager	K. DUNN	Administrateur de projet
Project no.		no du projet
	R.060139.002	
Drawing no.		no du dessin
	E2	