

# ISSUED FOR TENDER

## 21/05/2015



Parks Canada  
Asset Management  
Western and Northern Region

Parcs Canada  
Gestion des biens  
Région de l'Ouest et du Nord

# ACCESS AND EMBANKMENT REHABILITATION GREENBURN LAKE

GULF ISLAND NATIONAL PARK, South Pender Island, British Columbia

Canada

Parcs Canada / Parc Canada  
Asset Management / Gestion des biens  
Western and Northern Region / Région de l'Ouest et du Nord




May 21, 2015

Contractor to verify all dimensions & conditions on site and immediately notify the engineer of all discrepancies.  
L'entrepreneur doit vérifier toutes les dimensions et conditions sur le site et aviser immédiatement l'ingénieur de toute divergence.

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revisions	description	date
A	A detail no. no. du détail	A
B	B location drawing no. sur dessin no.	B
C	C drawing no. dessin no.	C

Consultants Name / Nom de l'expert - conseil

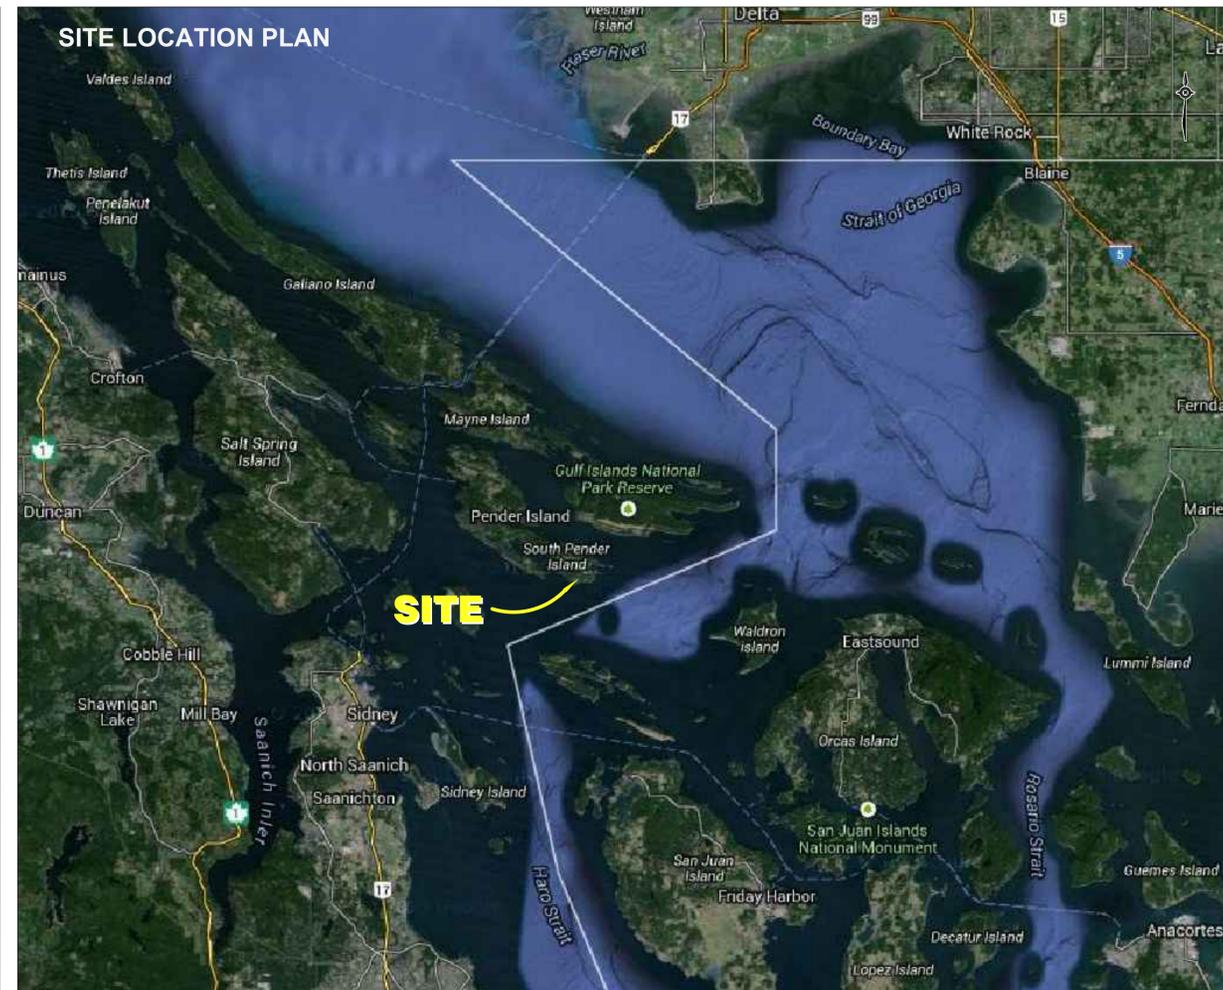**TETRA TECH EBA  
ENGINEERING PRACTICE**  
150, 1715 Dickson Ave.  
Kelowna, BC

project / projet  
**GREENBURN LAKE DAM  
REHABILITATION**  
GULF ISLAND NATIONAL PARK, BC  
K13103348-01-001

drawing / dessin  
**COVER PAGE**

Designed By	R. HALLEY	Conçu par
Date	2015/03/28	(yyyy/mm/dd)
Drawn By	R. HALLEY	Dessiné par
Date	2015/03/28	(yyyy/mm/dd)
Reviewed By	B. PATRICK	Examiné par
Date	2015/03/30	(yyyy/mm/dd)
Approved By		Approuvé par
Date		(yyyy/mm/dd)
Tender		Soumission


Project Manager / Administrateur de projets  
Project no. / No. du projet  
**5P420-14-5097/A**

Drawing no. / No. du dessin  
**C-3348-01**






May 27, 2015

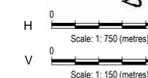


Contractor to verify all dimensions & conditions on site and immediately notify the engineer of all discrepancies.

L'entrepreneur doit vérifier toutes les dimensions et conditions sur le site et aviser immédiatement l'ingénieur de toute divergence.

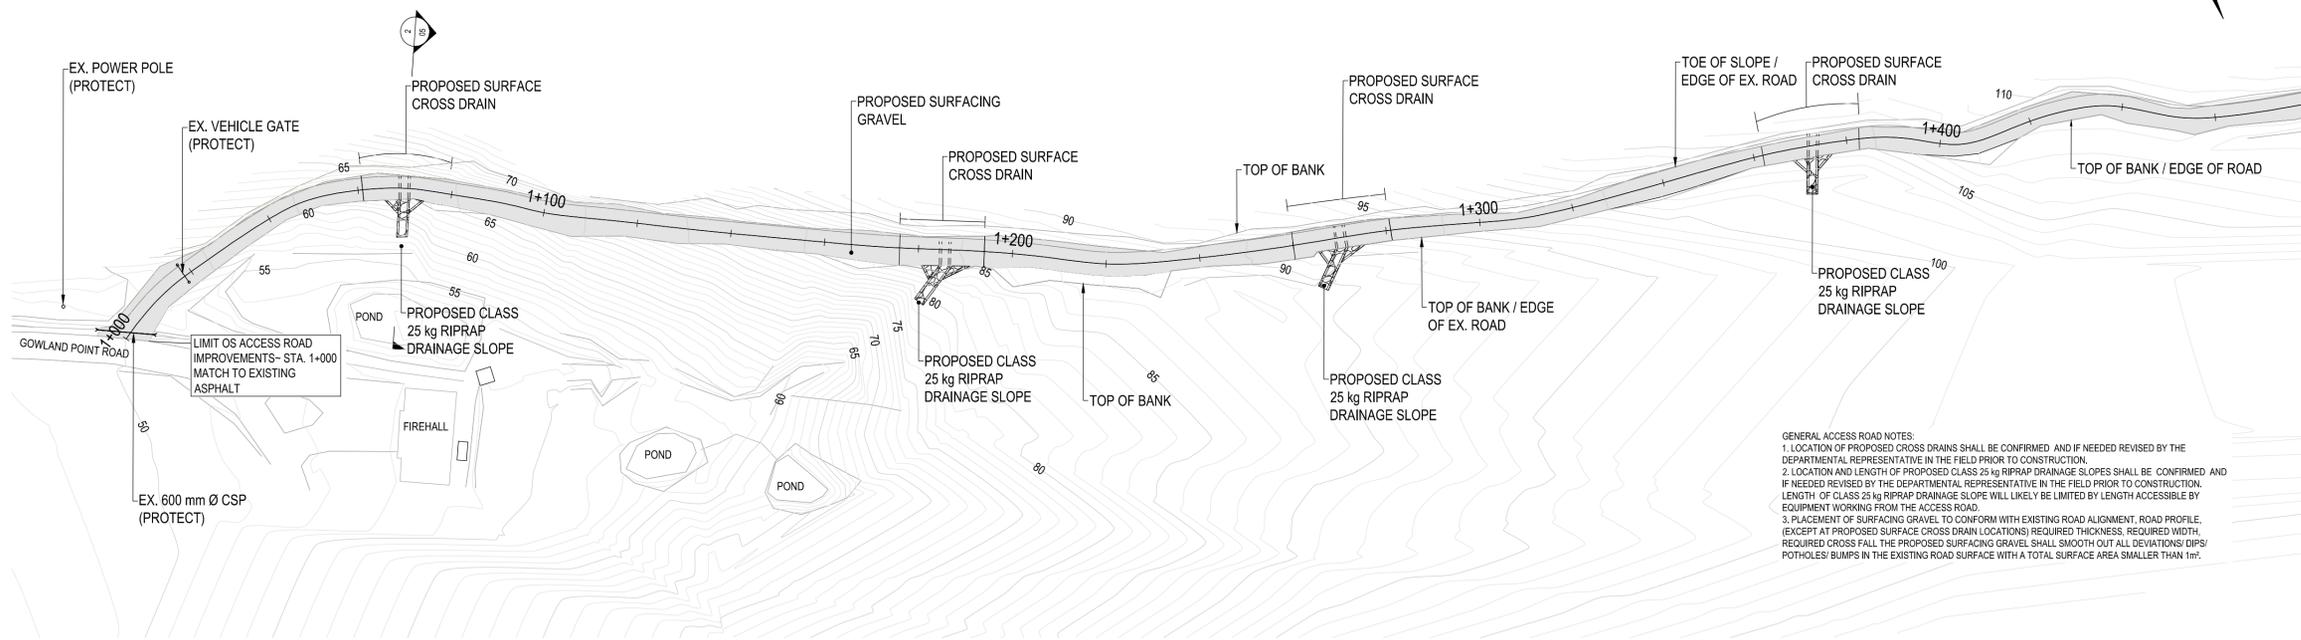

GENERAL ACCESS ROAD NOTES:  
 1. LOCATION OF PROPOSED CROSS DRAINS SHALL BE CONFIRMED AND IF NEEDED REVISED BY THE DEPARTMENTAL REPRESENTATIVE IN THE FIELD PRIOR TO CONSTRUCTION.  
 2. LOCATION AND LENGTH OF PROPOSED CLASS 25 kg RIPRAP DRAINAGE SLOPES SHALL BE CONFIRMED AND IF NEEDED REVISED BY THE DEPARTMENTAL REPRESENTATIVE IN THE FIELD PRIOR TO CONSTRUCTION. LENGTH OF CLASS 25 kg RIPRAP DRAINAGE SLOPE WILL LIKELY BE LIMITED BY LENGTH ACCESSIBLE BY EQUIPMENT WORKING FROM THE ACCESS ROAD.  
 3. PLACEMENT OF SURFACING GRAVEL TO CONFORM WITH EXISTING ROAD ALIGNMENT, ROAD PROFILE (EXCEPT AT PROPOSED SURFACE CROSS DRAIN LOCATIONS) REQUIRED THICKNESS, REQUIRED WIDTH, REQUIRED CROSS FALL THE PROPOSED SURFACING GRAVEL SHALL SMOOTH OUT ALL DEVIATIONS/ DIPS/ POTHOLES/ BUMPS IN THE EXISTING ROAD SURFACE WITH A TOTAL SURFACE AREA SMALLER THAN 1m<sup>2</sup>.

MATCH LINE - REFER TO SHEET C-3348-05

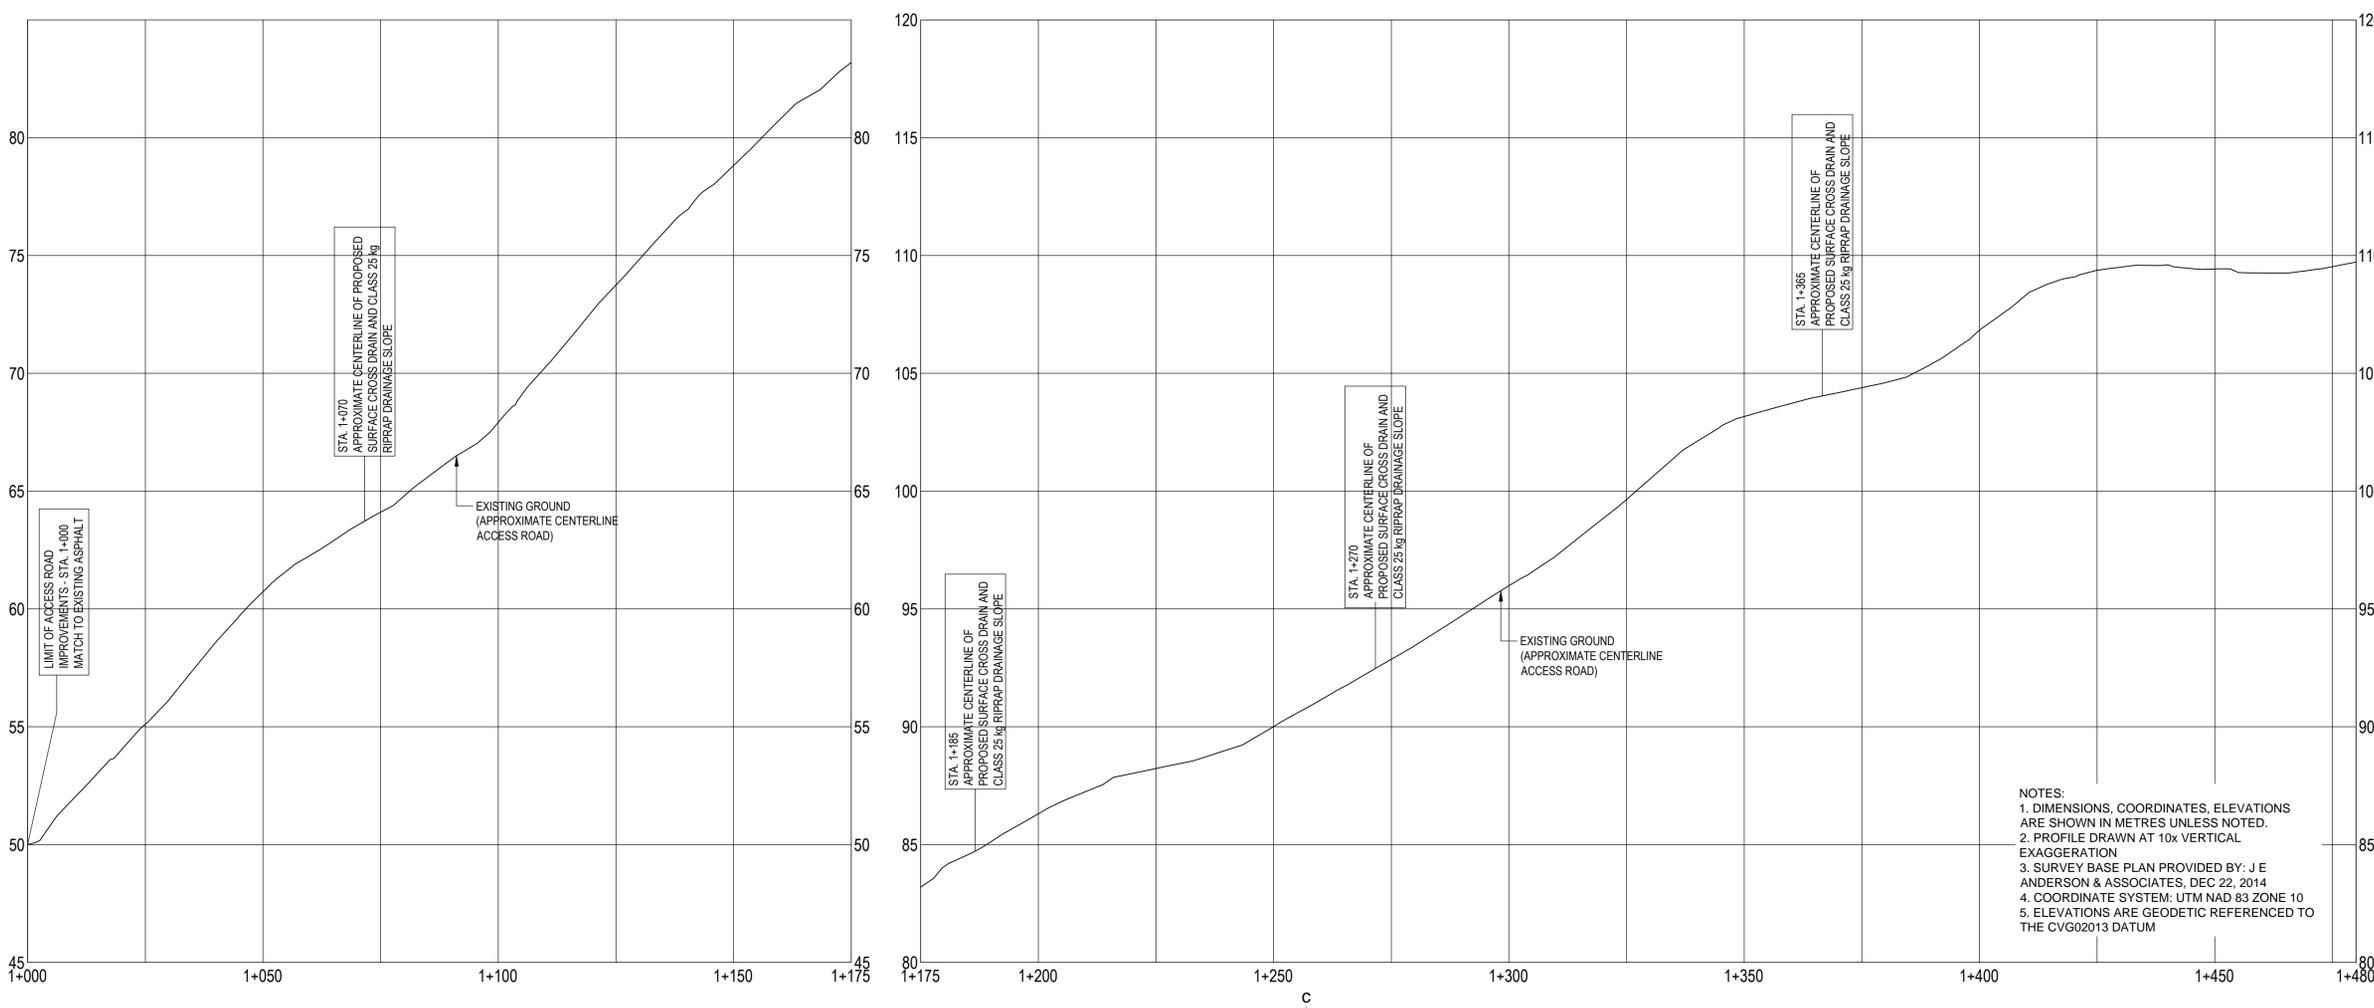

NOTES:  
 1. DIMENSIONS, COORDINATES, ELEVATIONS ARE SHOWN IN METRES UNLESS NOTED.  
 2. PROFILE DRAWN AT 10x VERTICAL EXAGGERATION.  
 3. SURVEY BASE PLAN PROVIDED BY: J E ANDERSON & ASSOCIATES, DEC 22, 2014  
 4. COORDINATE SYSTEM: UTM NAD 83 ZONE 10  
 5. ELEVATIONS ARE GEODETIC REFERENCED TO THE CVG02013 DATUM

A	ISSUED FOR REVIEW	2015/03/20
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revisions	description	date
A	detail no. no. du detail	A
B	location drawing no. sur dessin no.	B C
C	drawing no. dessin no.	

Consultants Name: Nom de l'expert - conseil

**TETRA TECH EBA ENGINEERING PRACTICE**  
 150, 1715 Dickson Ave.  
 Kelowna, BC

project / projet  
**GREENBURN LAKE DAM REHABILITATION**  
 GULF ISLAND NATIONAL PARK, BC  
 K13103348-01-001

drawing / dessin  
**ACCESS ROAD PLAN & PROFILE (STA 1+000 - STA 1+480)**


Designed By	A.HORWOOD	Conçu par
Date	2015/04/23	(yyyy/mm/dd)
Drawn By	A.HORWOOD / Y.TABATA	Dessiné par
Date	2015/04/23	(yyyy/mm/dd)
Reviewed By	R. LIU	Examiné par
Date	2015/04/23	(yyyy/mm/dd)
Approved By		Approuvé par
Date		(yyyy/mm/dd)
Tender		Soumission

Project Manager / Administrateur de projets  
 Project no. / No. du projet  
**5P420-14-5097/A**

Drawing no. / No. du dessin  
**C-3348-03**



May 27, 2015

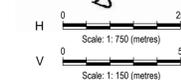

Contractor to verify all dimensions & conditions on site and immediately notify the engineer of all discrepancies.

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revisions	description	date
A	ISSUED FOR REVIEW	2015/03/20

A	A
C	B C

Consultants Name / Nom de l'expert - conseil

**TETRA TECH EBA ENGINEERING PRACTICE**  
 150, 1715 Dickson Ave.  
 Kelowna, BC

project / projet  
**GREENBURN LAKE DAM REHABILITATION**  
 GULF ISLAND NATIONAL PARK, BC  
 K13103348-01-001

drawing / dessin  
**ACCESS ROAD PLAN & PROFILE**  
 (STA 1+480 - STA 1+775)


Designed By	A. HORWOOD	Conçu par
Date	2015/04/23	(yyyy/mm/dd)
Drawn By	A. HORWOOD / Y. TABATA	Dessiné par
Date	2015/04/23	(yyyy/mm/dd)
Reviewed By	R. LIU	Examiné par
Date	2015/04/23	(yyyy/mm/dd)
Approved By		Approuvé par
Date		(yyyy/mm/dd)
Tender		Soumission

Project Manager / Administrateur de projets


Project no. / No. du projet  
**5P420-14-5097/A**

Drawing no. / No. du dessin


**C-3348-04**

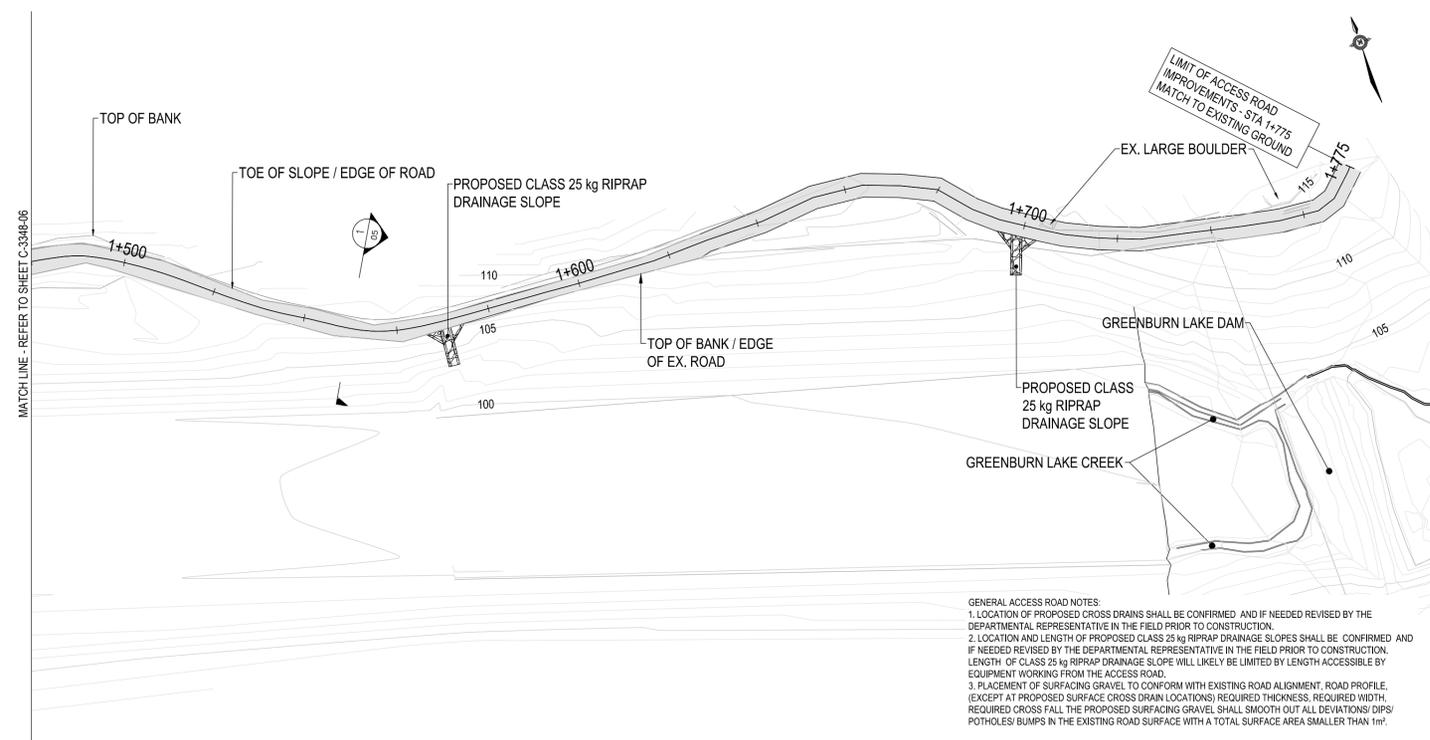

GENERAL ACCESS ROAD NOTES:  
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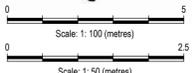


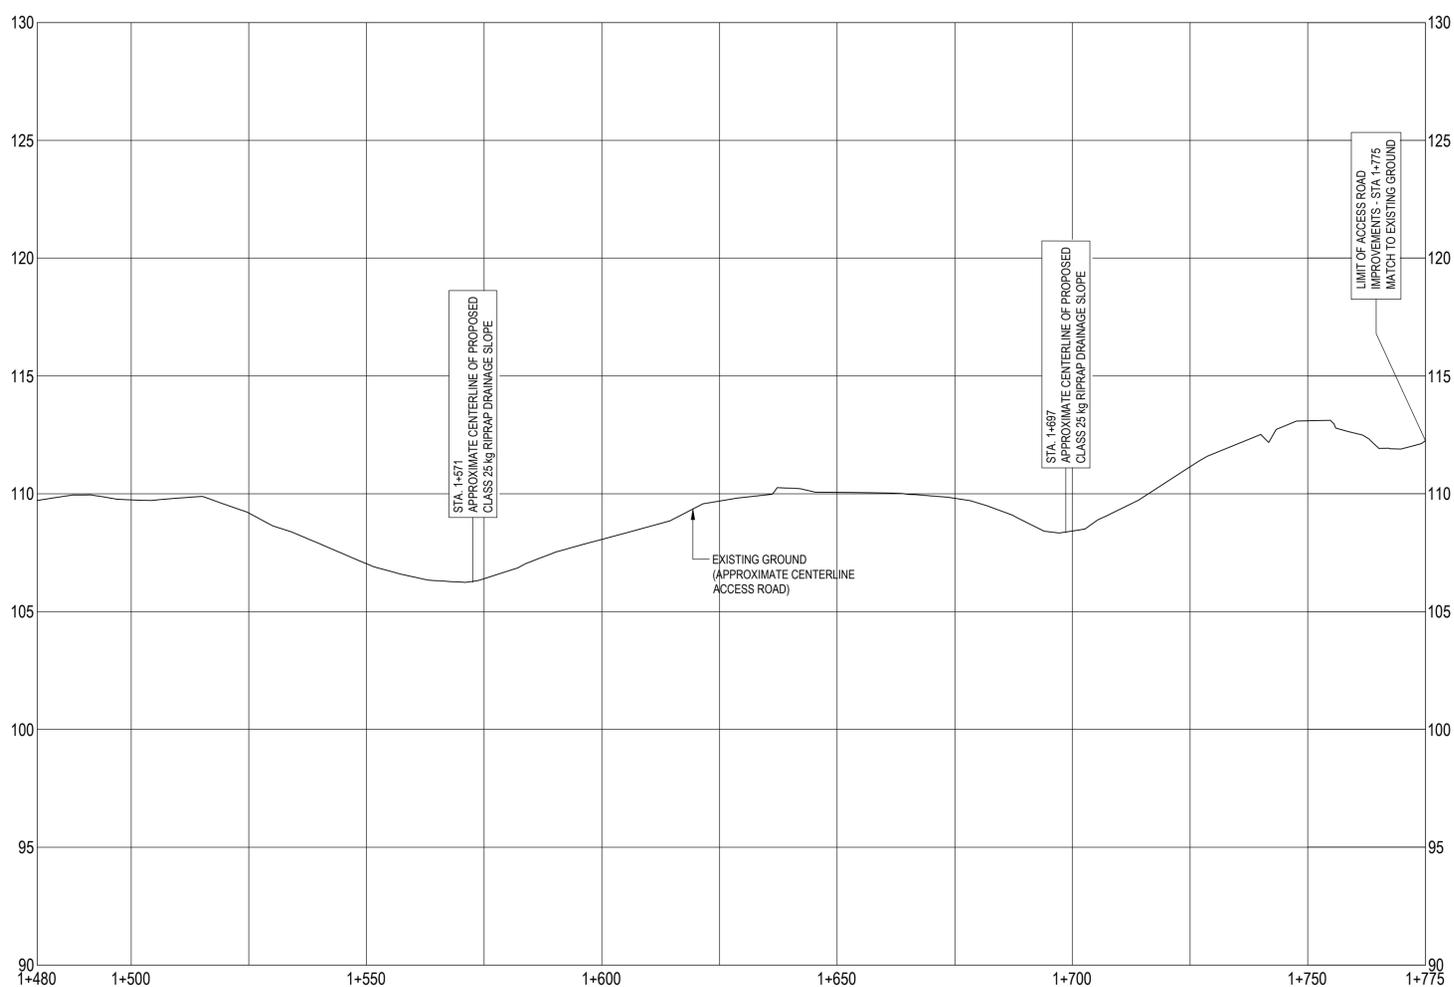NOTES:  
 1. DIMENSIONS, COORDINATES, ELEVATIONS ARE SHOWN IN METRES UNLESS NOTED.  
 2. PROFILE DRAWN AT 10x VERTICAL EXAGGERATION  
 3. SURVEY BASE PLAN PROVIDED BY: J E ANDERSON & ASSOCIATES, DEC 22, 2014  
 4. COORDINATE SYSTEM: UTM NAD 83 ZONE 10  
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A	B	C
A detail no. / no. du détail	A	C
B location drawing no. / sur dessin no.	B	C
C drawing no. / dessin no.		

Consultants Name / Nom de l'expert - conseil

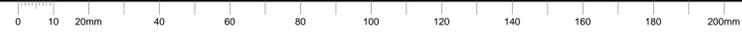**TETRA TECH EBA ENGINEERING PRACTICE**

150, 1715 Dickson Ave.  
Kelowna, BC

project / projet

**GREEN BURNLAKE DAM REHABILITATION**

GULF ISLAND NATIONAL PARK, BC  
K13103348-01-001

drawing / dessin

**ACCESS ROAD TYPICAL SECTIONS (SHEET 1 OF 2)**

Designed By / Conçu par: A. HORWOOD / 2015/04/23

Drawn By / Dessiné par: A. HORWOOD / Y. TABATA / 2015/04/23

Reviewed By / Examiné par: R. LIU / 2015/04/23


Approved By / Approuvé par: (Signature) / (Date)

Tender / Soumission

Project Manager / Administrateur de projets

Project no. / No. du projet: 5P420-14-5097/A


Drawing no. / No. du dessin: C-3348-05

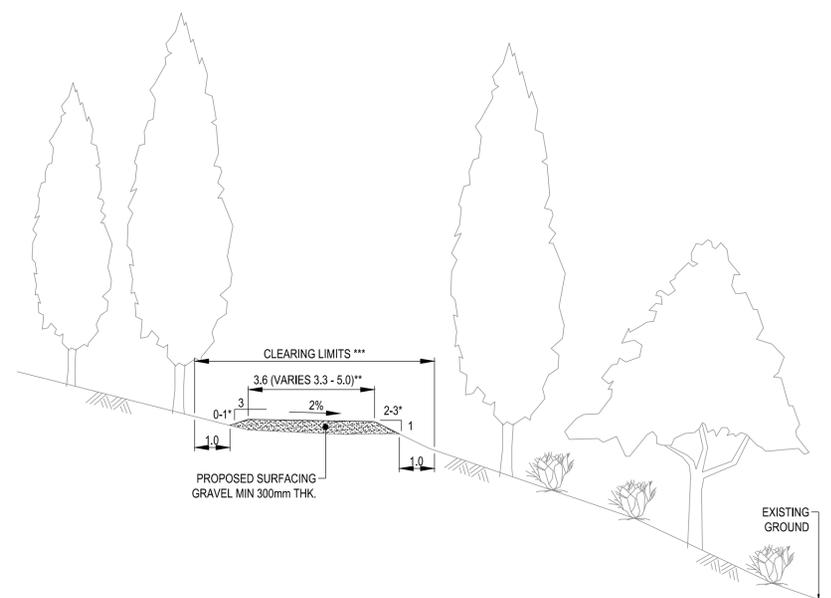

SECTION 1 TYPICAL SECTION PROPOSED SURFACING GRAVEL  
 SECTION TYPICAL STA. 1+000 TO STA. 1+775 (EXCLUDING SECTION 2 AND SECTION 3 AREAS)  
 SCALE: 1:100 SECTION DRAWN AT STA. 1+550

- \* SLOPE OF SURFACING GRAVEL TO CONFORM TO FIELD CONDITIONS AND AS DIRECTED BY THE DEPARTMENTAL REPRESENTATIVE.
- \*\* 5.9m to 7.0m FROM STA. 1+000 - STA. 1+020.
- \*\*\* CLEAR ALL SHRUBS, BRUSH, AND TREES (WITH DIAMETER AT BASE < 100 mm) WITHIN CLEARING LIMITS (STA. 1+000 - STA. 1+775).


- NOTES:
1. DIMENSIONS, COORDINATES, ELEVATIONS ARE SHOWN IN METRES UNLESS NOTED.
  2. PROFILE DRAWN AT 10x VERTICAL EXAGGERATION
  3. SURVEY BASE PLAN PROVIDED BY: J. E. ANDERSON & ASSOCIATES, DEC 22, 2014
  4. COORDINATE SYSTEM: UTM NAD 83 ZONE 10
  5. ELEVATIONS ARE GEODETIC REFERENCED TO THE CVG02013 DATUM

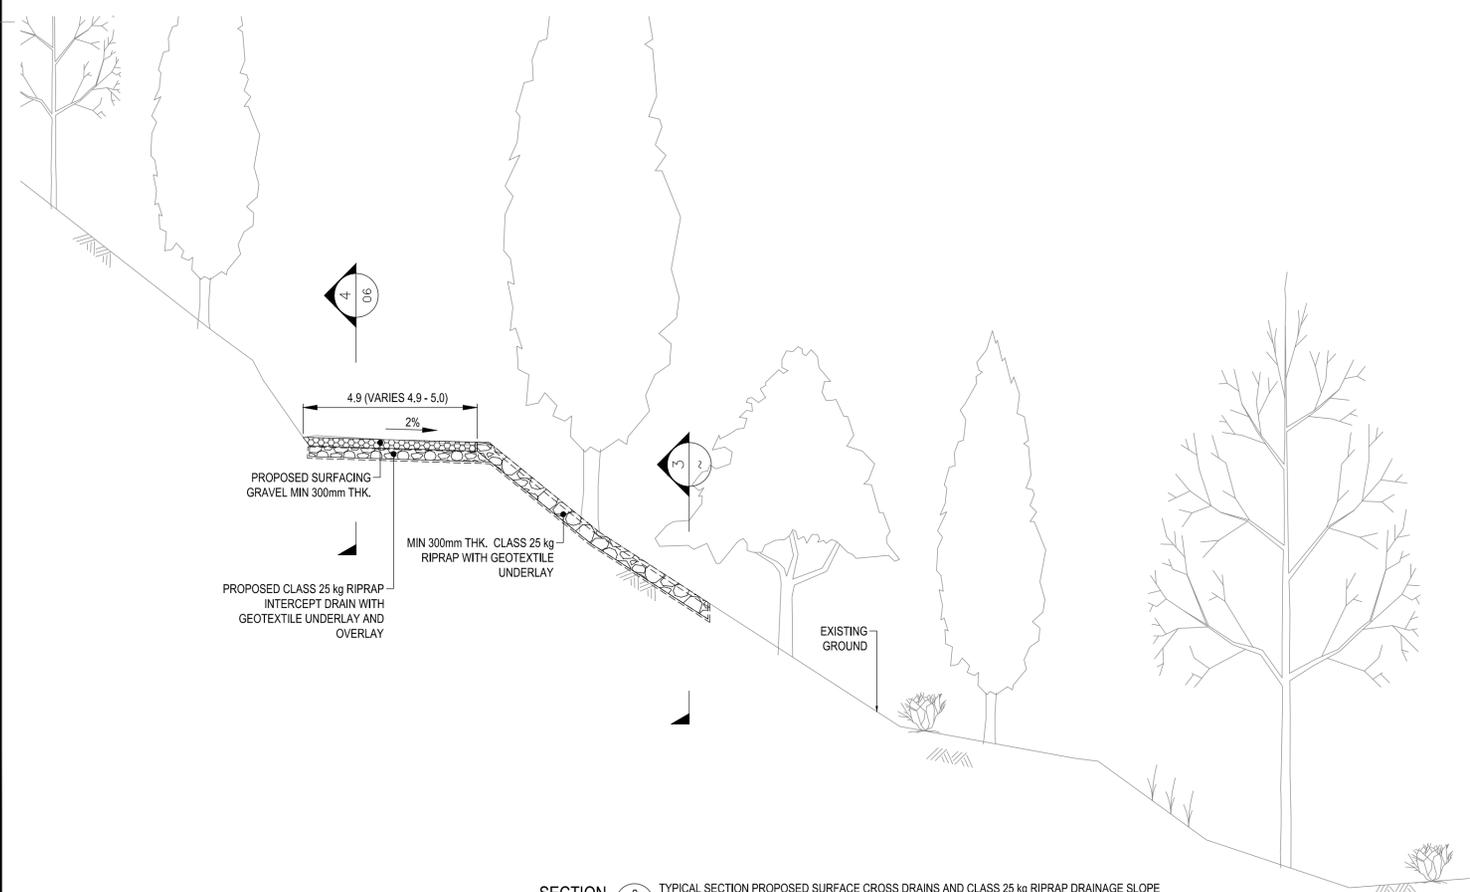

SECTION 2 TYPICAL SECTION PROPOSED SURFACE CROSS DRAINS AND CLASS 25 kg RIPRAP DRAINAGE SLOPE  
 SECTION TYPICAL STA. 1+070, STA 1+185, STA. 1+270, STA. 1+365  
 SCALE: 1:100 SECTION DRAWN AT STA. 1+070




SECTION 3 TYPICAL SECTION PROPOSED CLASS 25 kg RIPRAP DRAINAGE SLOPE  
 SCALE: 1:50

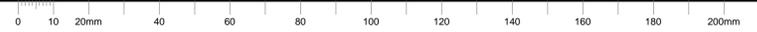



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A	ISSUED FOR REVIEW	2015/03/20

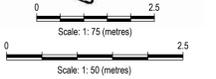A	A detail no. / no. du détail	A
C	B location drawing no. / sur dessin no.	B C
	C drawing no. / dessin no.	

Consultants Name / Nom de l'expert - conseil

**TETRA TECH EBA ENGINEERING PRACTICE**

150, 1715 Dickson Ave.  
Kelowna, BC

project / projet

**GREEN BURNLAKE DAM REHABILITATION**

**GULF ISLAND NATIONAL PARK, BC  
K13103348-01-001**

drawing / dessin

**ACCESS ROAD  
TYPICAL SECTIONS  
(SHEET 2 OF 2)**

Designed By / Conçu par  
A. HORWOOD / 2015/04/23 / (yyyy/mm/dd)

Drawn By / Dessiné par  
A. HORWOOD / Y. TABATA / 2015/04/23 / (yyyy/mm/dd)

Reviewed By / Examiné par  
R. LIU / 2015/04/23 / (yyyy/mm/dd)

Approved By / Approuvé par  
/ (yyyy/mm/dd)

Tender / Soumission


Project Manager / Administrateur de projets

Project no. / No. du projet

**5P420-14-5097/A**

Drawing no. / No. du dessin

**C-3348-06**

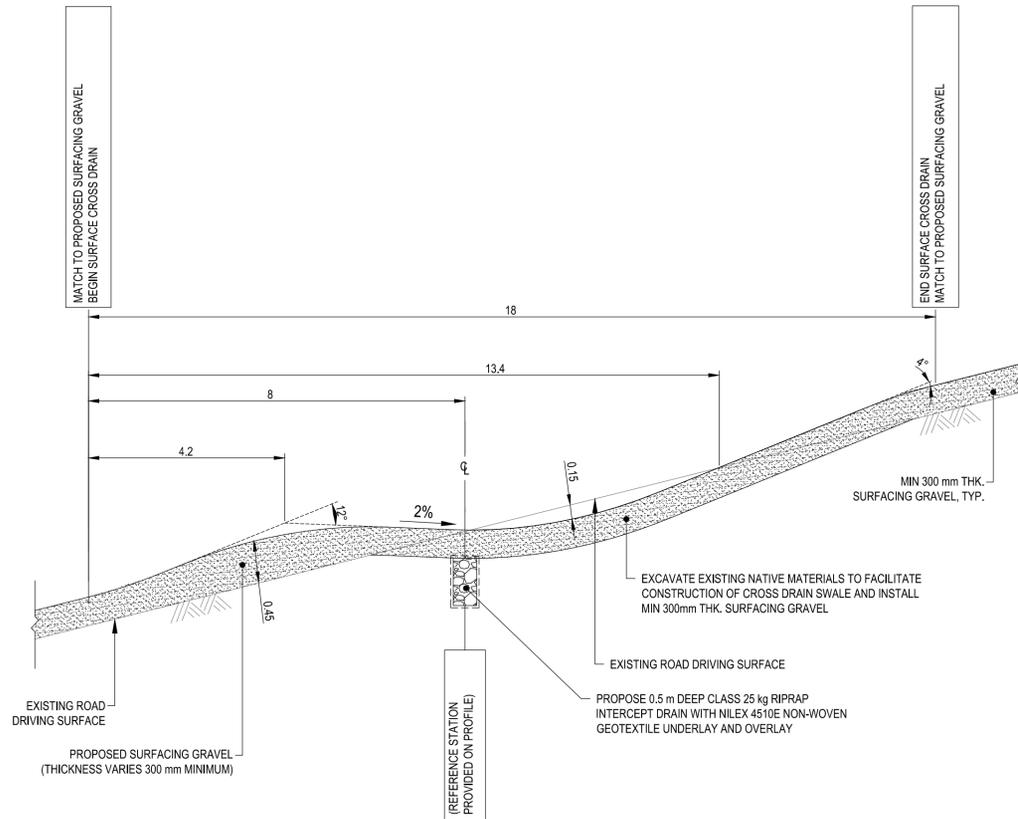


**SECTION**

SCALE: H: 1:75  
V: 2 x EXAGGERATION

4  
03

TYPICAL SECTION PROPOSED SURFACE CROSS DRAIN  
SECTION TYPICAL OF CROSS DRAINS STA. 1+070, STA. 1+185, STA. 1+270, STA. 1+365  
SECTION DRAWN AT STA. 1+065 TO STA. 1+079

\* 8° AT PROPOSED SURFACE CROSS DRAIN STA. 1+365.

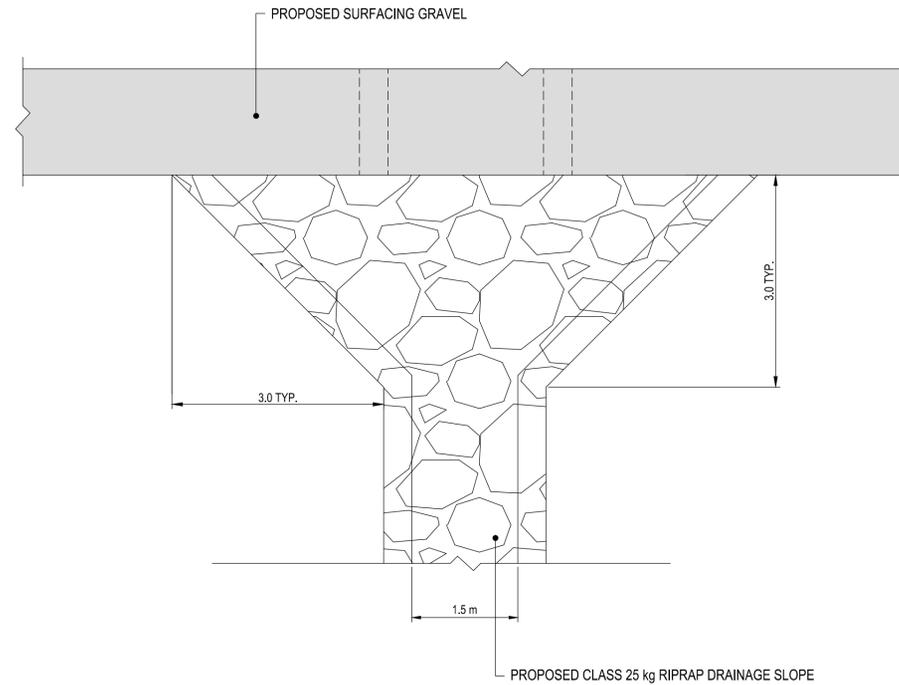

**DETAIL**

SCALE: 1:50

1  
03

TYPICAL DETAIL OF RIPRAP DRAINAGE  
SLOPE ADJACENT TO ACCESS ROAD

- NOTES:
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  3. SURVEY BASE PLAN PROVIDED BY: J E ANDERSON & ASSOCIATES, DEC 22, 2014
  4. COORDINATE SYSTEM: UTM NAD 83 ZONE 10
  5. ELEVATIONS ARE GEODETIC REFERENCED TO THE CVG02013 DATUM





May 27, 2015

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revisions	description	date
A	A detail no. no. du detail	A
B	B location drawing no. sur dessin no.	B
C	C drawing no. dessin no.	C

Consultants Name / Nom de l'expert - conseil

**TETRA TECH EBA  
 ENGINEERING PRACTICE**  
 150, 1715 Dickson Ave.  
 Kelowna, BC

project / projet

**GREENBURN LAKE DAM  
 REHABILITATION**  
 GULF ISLAND NATIONAL PARK, BC  
 K13103348-01-001

drawing / dessin

**DIVERSION CHANNEL  
 PROPOSED SITE PLAN**

Designed By	EL	Conçu par
Date	2015/03/20	(yyyy/mm/dd)
Drawn By	JDM	Dessiné par
Date	2015/03/20	(yyyy/mm/dd)
Reviewed By	EL/DNM	Examiné par
Date	2015/03/23	(yyyy/mm/dd)
Approved By		Approuvé par
Date		(yyyy/mm/dd)
Tender		Soumission

Project Manager / Administrateur de projets  
 Project no. / No. du projet

5P420-14-5097/A

Drawing no. / No. du dessin

C-3348-08

- LEGEND**
- MAJOR CONTOURS (5 m)
  - MINOR CONTOURS (1 m)
  - LEGAL
  - EDGE OF ROAD
  - SURVEYED TREE
  - EXISTING DITCH
  - EXISTING WATERCOURSE
  - WELL
  - HYDRANT
  - WATER VALVE
  - UTILITY POLE ANCHOR
  - UTILITY POLE
  - COMMON FILL AREA
  - CUT AREA
  - BLEND TO EXISTING GROUND & MAINTAIN POSITIVE DRAINAGE
  - ARMOR FLEX CHANNEL
  - BERM CREST (3 m WIDE)
  - TOE OF CHANNEL
  - APPROXIMATE GRADING LIMITS



**CHANNEL CENTRELINE**

Number	Radius	Length	Line/Chord Direction
L1		14.71	N28° 10' 11.72"W
C1	12.71	7.16	N12° 01' 36.95"W
L2		0.02	N4° 06' 57.81"E
C2	8.33	6.41	N17° 56' 21.89"W
L3		11.64	N39° 59' 41.59"W
C3	12.77	6.19	N51° 51' 28.72"W
L4		4.55	N62° 14' 41.61"W
L5		15.18	N63° 44' 52.04"W
C4	75.00	22.08	N72° 10' 58.89"W
L6		24.50	N80° 37' 05.74"W


**CHANNEL CENTRELINE LAYOUT TABLE**

Point #	Elevation	Northing	Easting	Description
192	56.56	5401236.95	484067.79	CL
193	54.88	5401249.92	484060.85	CL
194	54.19	5401256.83	484059.38	CL
195	53.89	5401262.80	484057.45	CL
196	53.59	5401271.72	484049.97	CL
197	53.44	5401275.51	484045.15	CL
198	52.94	5401284.34	484027.51	CL
199	51.88	5401291.07	484006.56	CL
200	50.00	5401295.06	483982.39	CL

**NOTES**  
 1. Coordinates are referenced to CVGD 2013.

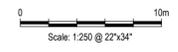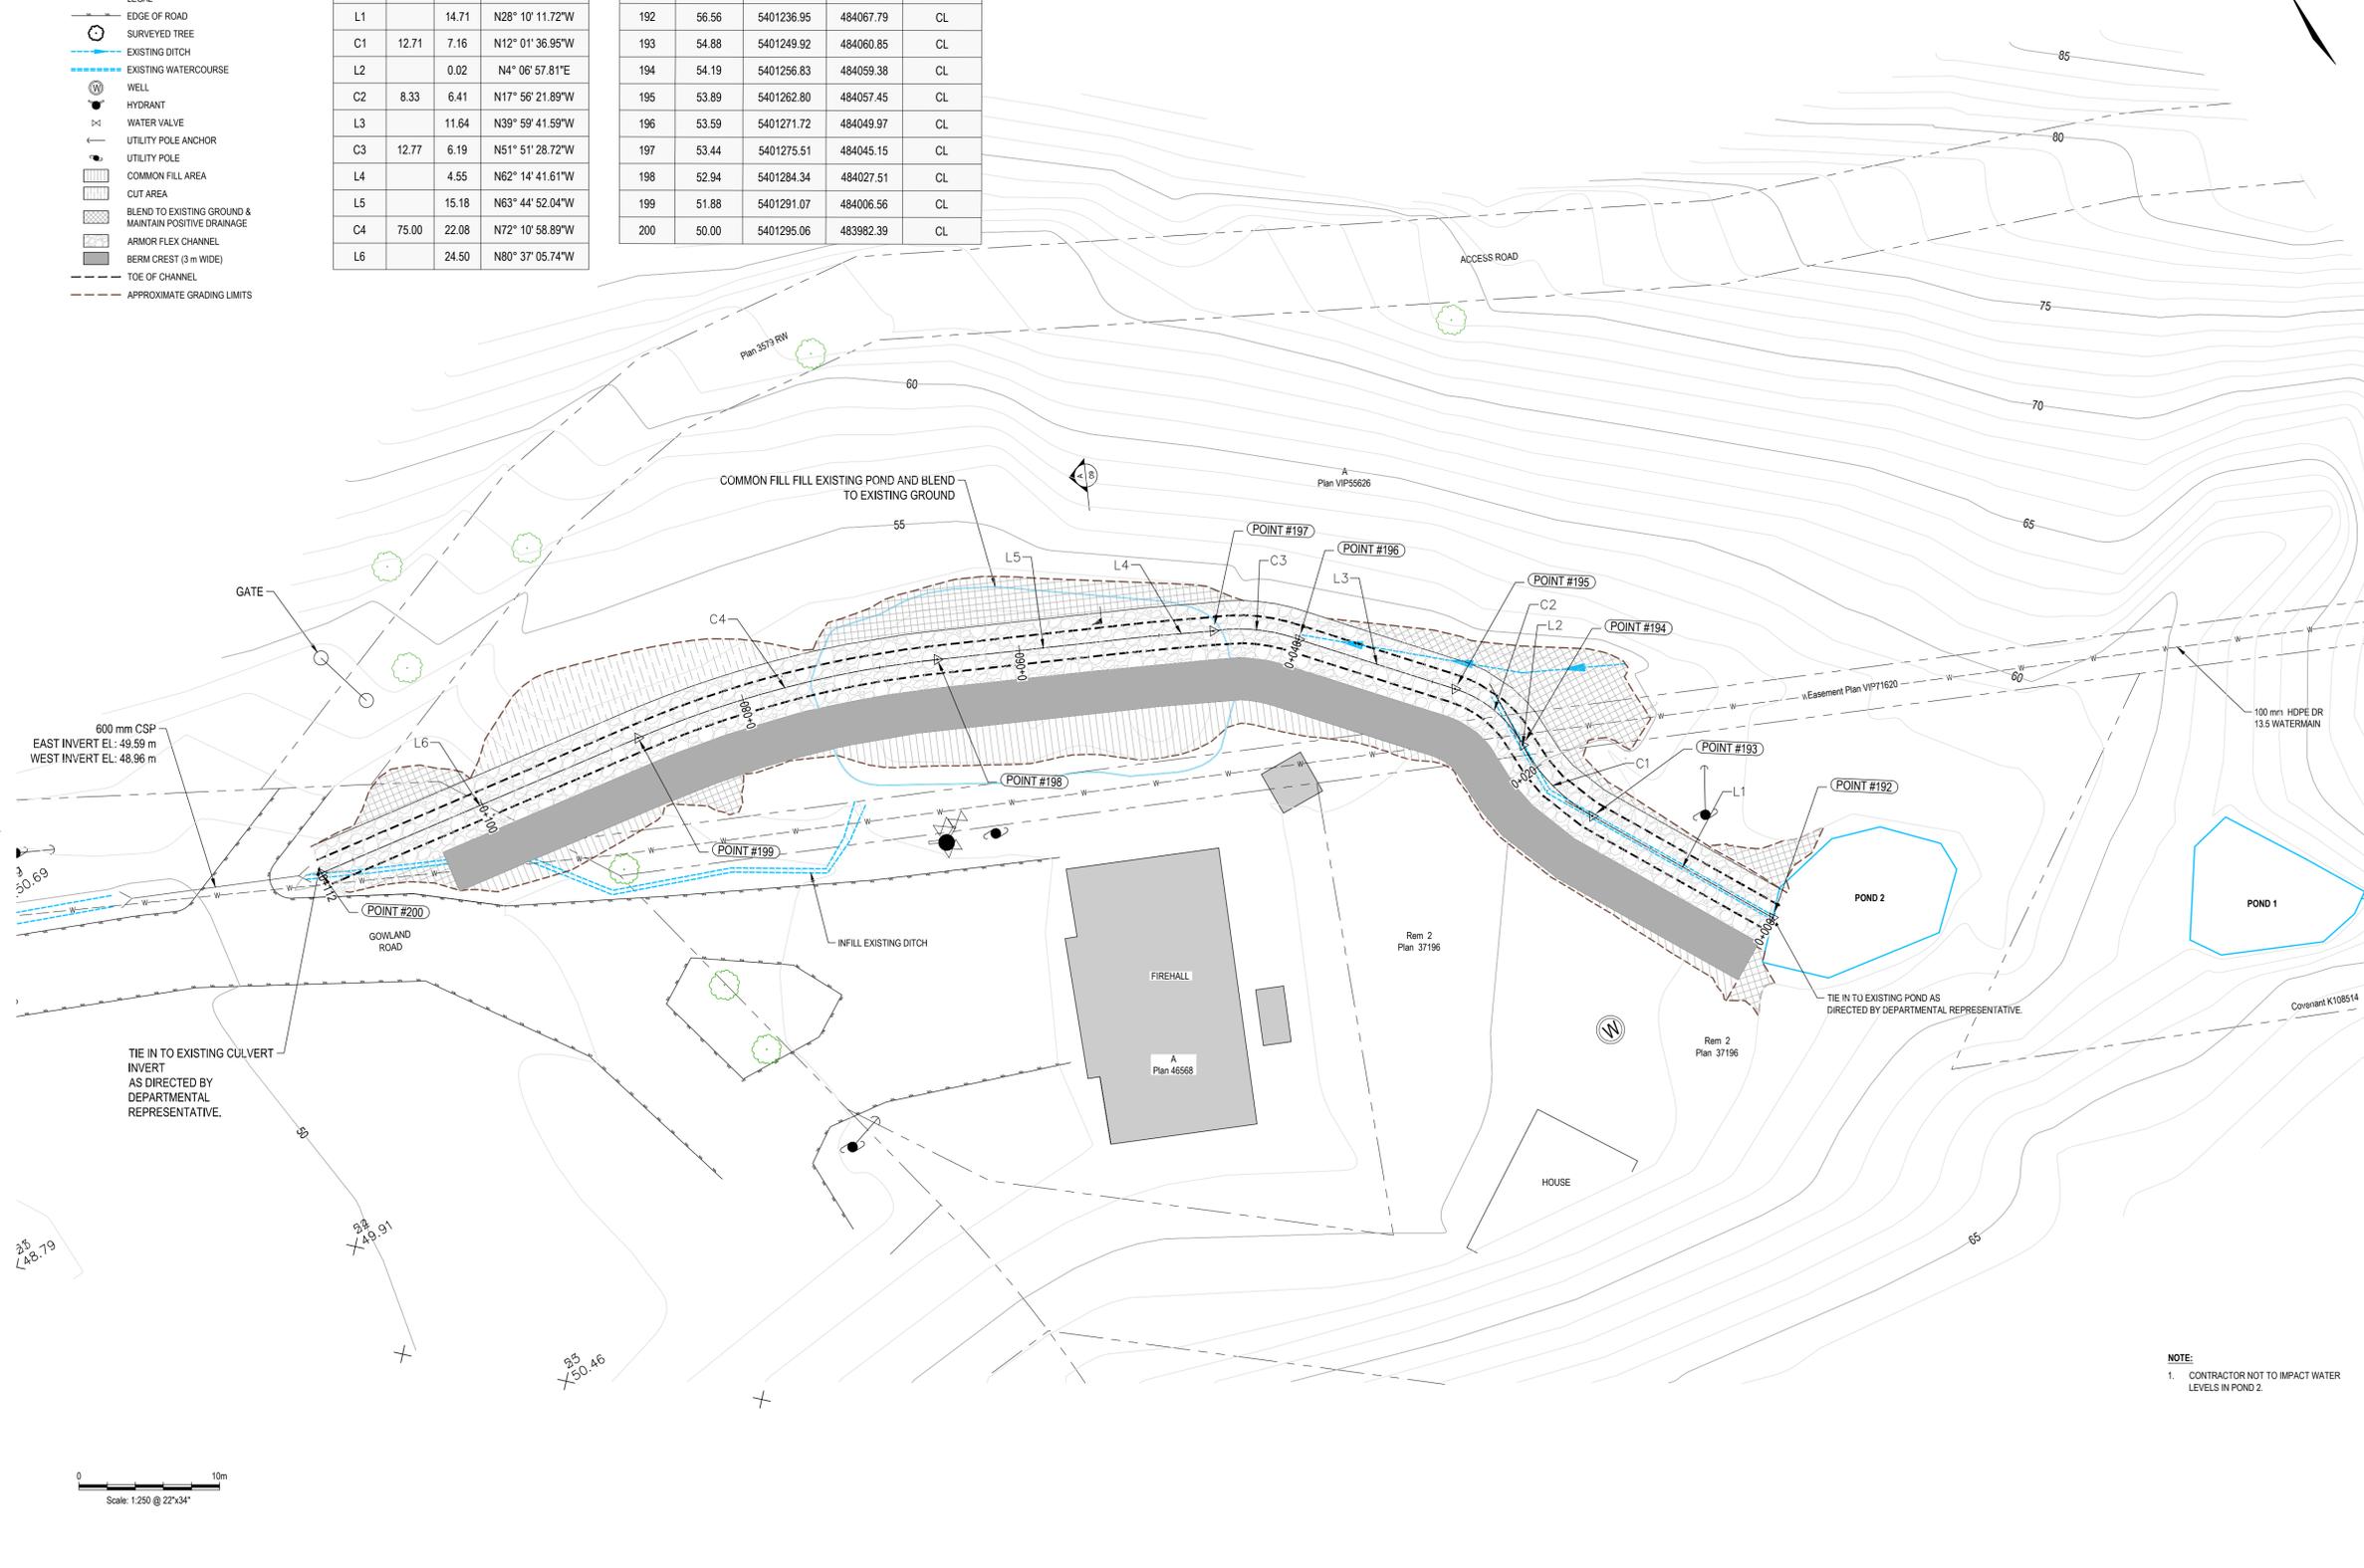

**NOTE:**  
 1. CONTRACTOR NOT TO IMPACT WATER LEVELS IN POND 2.

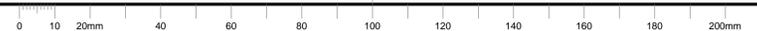




May 27, 2015


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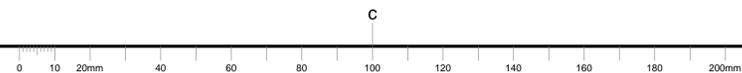
1 PROPOSED BYPASS CHANNEL PROFILE  
 C.2 SCALE: 1:500 HORIZ. 1:50 VERT.

NOTES  
 1. Profile view is exaggerated by 5 times vertically.

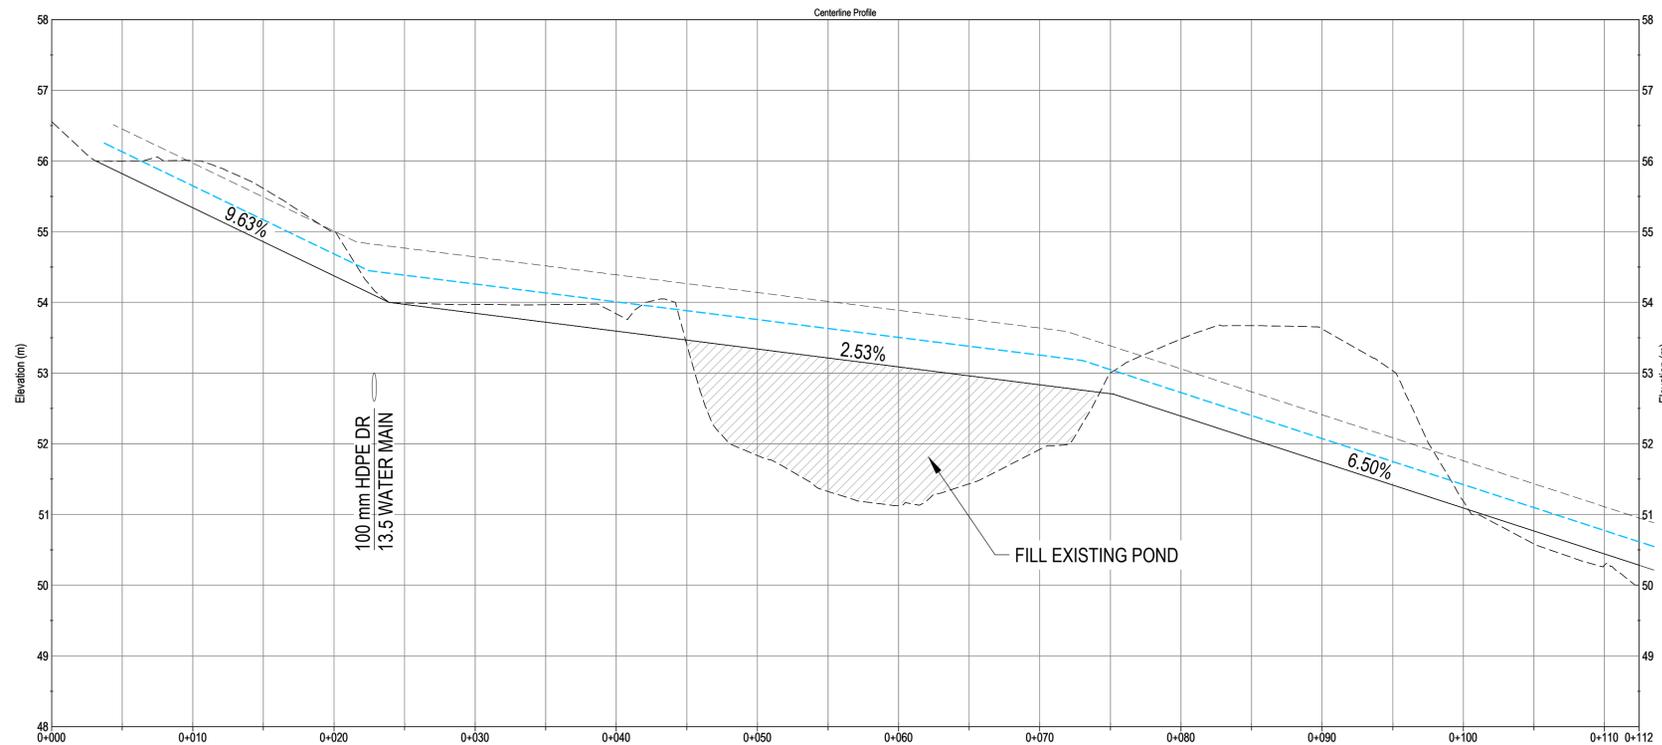

A TYPICAL SECTION  
 C.2 SCALE: 1:50

- LEGEND
- - - - - EXISTING GROUND
  - PROPOSED CHANNEL CENTERLINE PROFILE
  - - - - - INFLOW DESIGN FLOOD LEVEL
  - — — — 200 YEAR FLOOD LEVEL

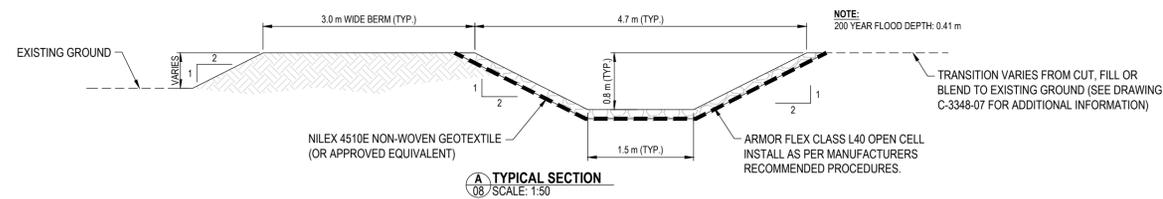

revisions	description	date
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project / projet  
**GREENBURN LAKE DAM**  
**REHABILITATION**  
 GULF ISLAND NATIONAL PARK, BC  
 K13103348-01-001

drawing / dessin  
**DIVERSION CHANNEL**  
**CENTERLINE PROFILE**  
**AND**  
**TYPICAL SECTION**

Designed By	EL	Conçu par	
Date	2015/03/20	(yyyy/mm/dd)	
Drawn By	JDM	Dessiné par	
Date	2015/03/20	(yyyy/mm/dd)	
Reviewed By	EL/DNM	Examiné par	
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Project Manager / Administrateur de projets  
 Project no. / No. du projet

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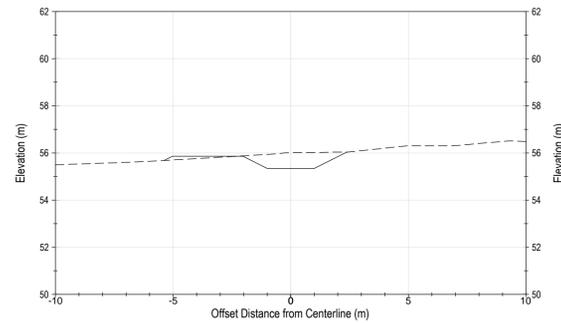
Drawing no. / No. du dessin

C-3348-09




May 27, 2015


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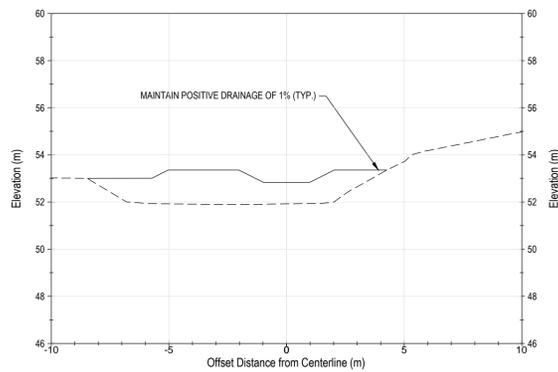
SECTION VIEW - STA. 0+010  
 SCALE: 1:150




SECTION @ STA. 0+030  
 SCALE: 1:150

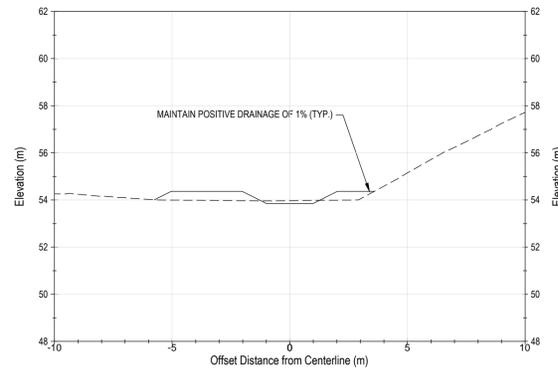


SECTION @ STA. 0+050  
 SCALE: 1:150

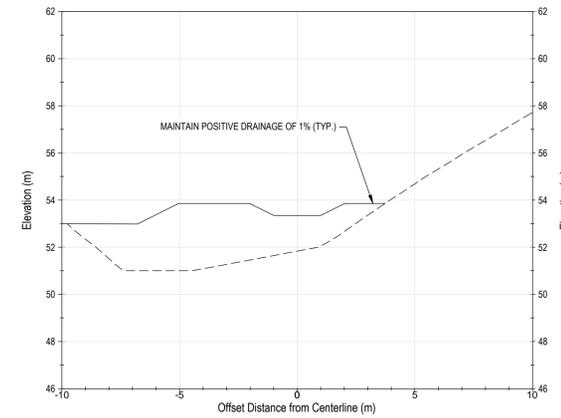

SECTION @ STA. 0+060  
 SCALE: 1:150

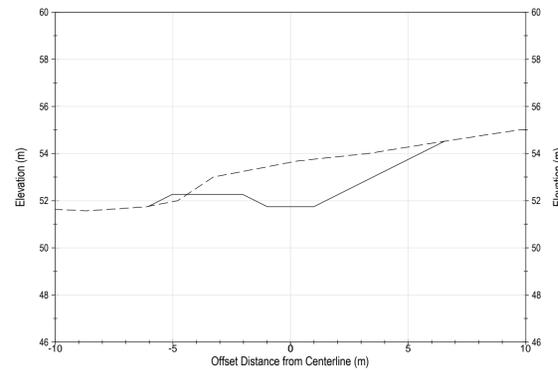

SECTION @ STA. 0+080  
 SCALE: 1:150

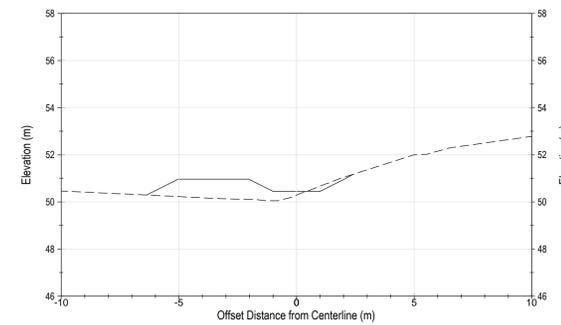

SECTION @ STA. 0+100  
 SCALE: 1:150

LEGEND  
 - - - Existing Ground  
 — Design Channel

revisions	description	date
A	A detail no. no. du détail	A
B	B location drawing no. sur dessin no.	B C
C	C drawing no. dessin no.	

Consultants Name / Nom de l'expert - conseil

**TETRA TECH EBA  
 ENGINEERING PRACTICE**  
 150, 1715 Dickson Ave.  
 Kelowna, BC

project / projet

**GREENBURN LAKE DAM  
 REHABILITATION**  
 GULF ISLAND NATIONAL PARK, BC  
 K13103348-01-001

drawing / dessin

**DIVERSION CHANNEL  
 20 METER  
 CROSS SECTIONS**

Designed By	EL	Conçu par
Date	2015/03/20	(yyyy/mm/dd)
Drawn By	JDM	Dessiné par
Date	2015/03/20	(yyyy/mm/dd)
Reviewed By	EL/DNM	Examiné par
Date	2015/03/23	(yyyy/mm/dd)
Approved By		Approuvé par
Date		(yyyy/mm/dd)
Tender		Soumission

Project Manager / Administrateur de projets


Project no. / No. du projet

5P420-14-5097/A


Drawing no. / No. du dessin

C-3348-10

C


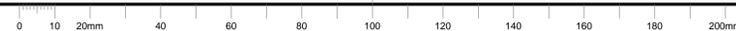




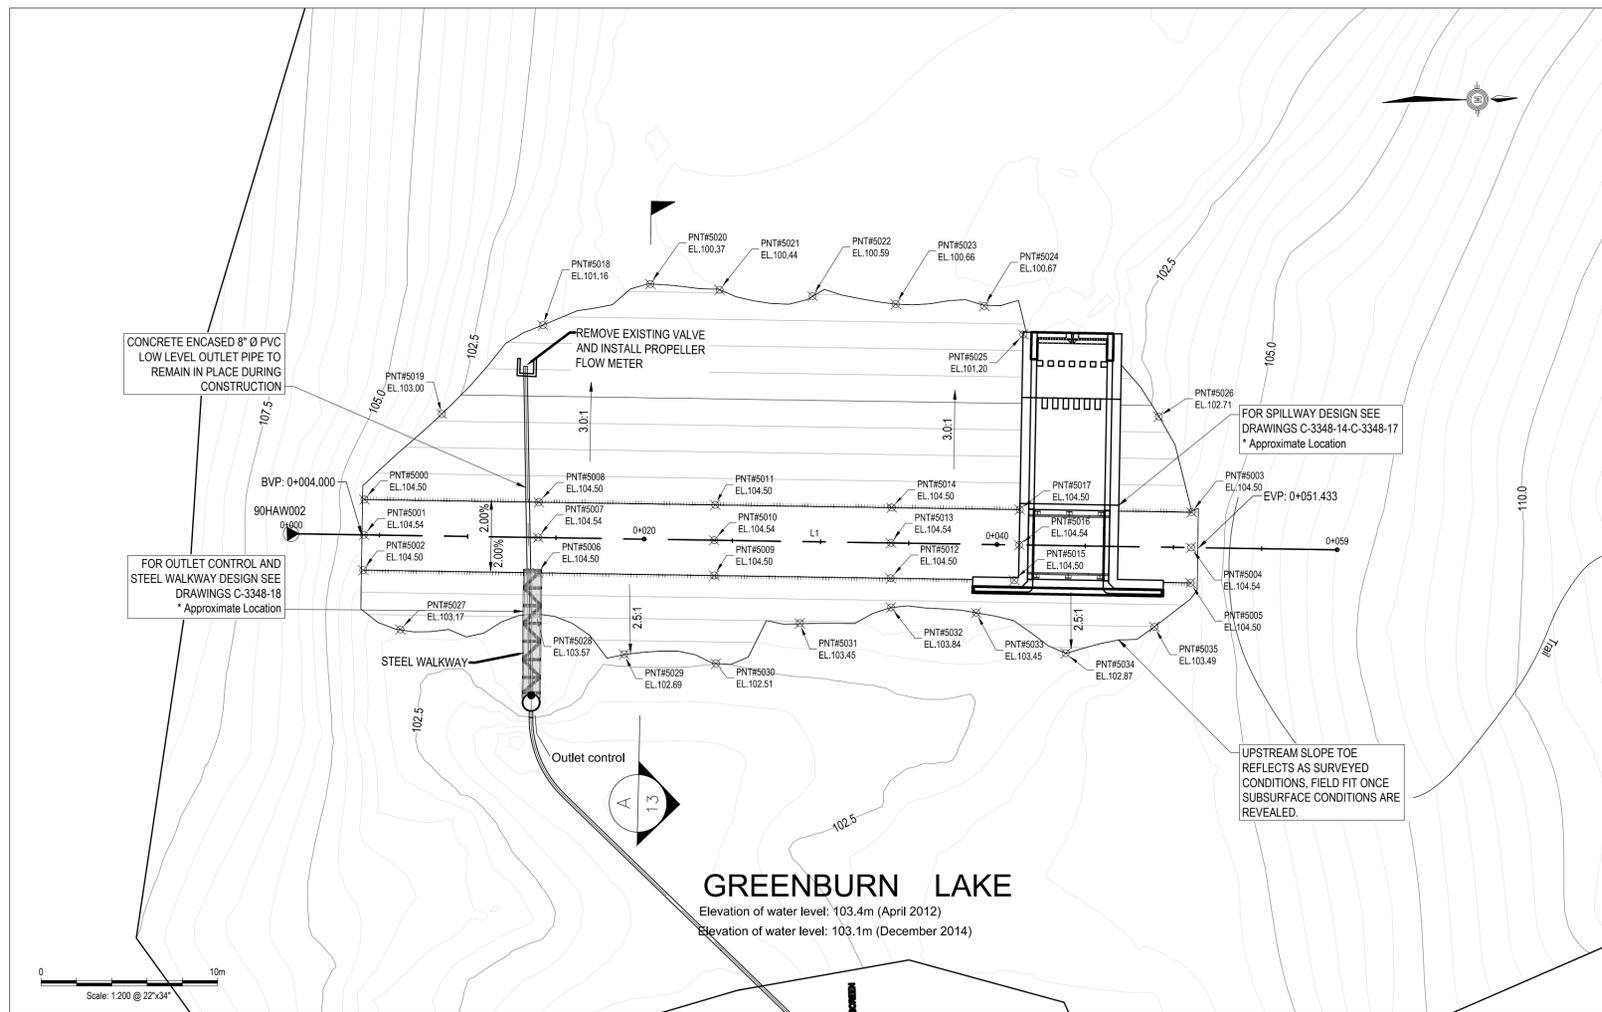

GREENBURN DAM CENTERLINE				
Number	Length	Radius	Line/Chord Direction	A Value
L1	59.281		N2° 52' 52.75"E	

EMBANKMENT LAYOUT POINTS				EMBANKMENT LAYOUT POINTS					
POINT #	NORTHING	EASTING	ELEVATION	DESCRIPTION	POINT #	NORTHING	EASTING	ELEVATION	DESCRIPTION
5000	5398854.077	484482.050	104.500	CREST	5018	5398864.525	484470.551	101.162	TOE
5001	5398853.976	484482.051	104.540	CL	5019	5398868.628	484475.365	103.000	TOE
5002	5398853.876	484484.045	104.500	CREST	5020	5398870.690	484468.432	100.371	TOE
5003	5398900.902	484482.406	104.500	CREST	5021	5398874.601	484468.899	100.444	TOE
5004	5398900.802	484484.403	104.540	CL	5022	5398879.856	484469.443	100.588	TOE
5005	5398900.701	484486.401	104.500	CREST	5023	5398884.553	484470.053	100.661	TOE
5006	5398863.748	484484.542	104.500	CREST	5024	5398889.559	484470.339	100.673	TOE
5007	5398863.845	484482.543	104.540	CL	5025	5398891.724	484472.032	101.200	TOE
5008	5398863.949	484480.547	104.500	CREST	5026	5398899.224	484476.939	102.708	TOE
5009	5398873.736	484485.044	104.500	CREST	5027	5398855.858	484487.471	103.171	TOE
5010	5398873.801	484483.044	104.540	CL	5028	5398863.581	484486.875	103.570	TOE
5011	5398873.937	484481.049	104.500	CREST	5029	5398868.481	484489.315	102.688	TOE
5012	5398883.723	484485.547	104.500	CREST	5030	5398873.663	484490.022	102.510	TOE
5013	5398883.810	484483.548	104.540	CL	5031	5398878.493	484487.911	103.450	TOE
5014	5398883.924	484481.552	104.500	CREST	5032	5398883.689	484487.197	103.840	TOE
5015	5398890.714	484485.698	104.500	CREST	5033	5398888.498	484487.670	103.447	TOE
5016	5398891.074	484483.921	104.540	CL	5034	5398893.490	484490.129	102.865	TOE
5017	5398891.169	484481.916	104.500	CREST	5035	5398898.567	484488.813	103.493	TOE

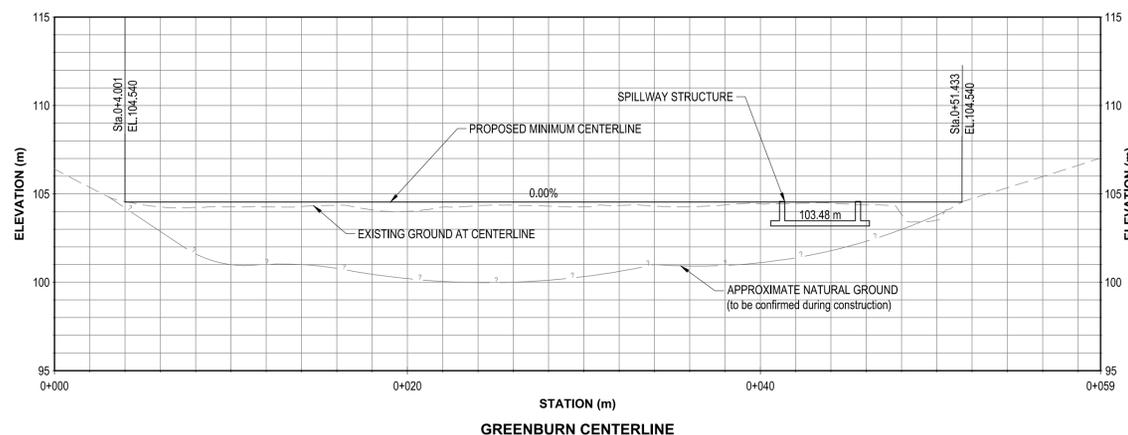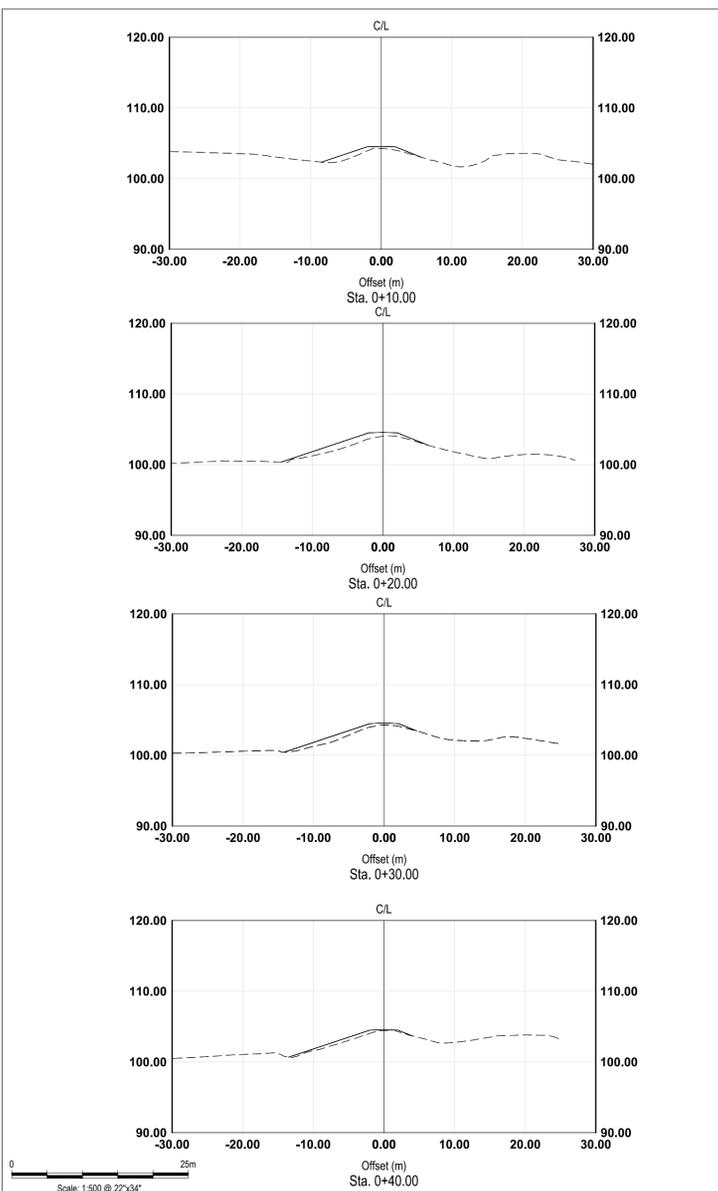

Canada

Parks Canada Parc Canada  
 Asset Management Western and Northern Region Gestion des biens Région de l'Ouest et du Nord

COORDINATE SYSTEM REFERENCED TO:  
 UTM with NAD83 datum, Zone 12, Meter,  
 Central Meridian 111d W



May 27, 2015

Contractor to verify all dimensions & conditions on site and immediately notify the engineer of all discrepancies.

L'entrepreneur doit vérifier toutes les dimensions et conditions sur le site et aviser immédiatement l'ingénieur de toute divergence.

revisions description date

A	A detail no. no. du détail	A
B	B location drawing no. sur dessin no.	B C
C	C drawing no. dessin no.	

Consultants Name Nom de l'expert - conseil

**TETRA TECH EBA ENGINEERING PRACTICE**  
 150, 1715 Dickson Ave.  
 Kelowna, BC

project projet

**GREENBURN LAKE DAM REHABILITATION**

GULF ISLAND NATIONAL PARK, BC  
 K13103348-01-001

drawing dessin

**EMBANKMENT GEOMETRY PLAN & PROFILE CROSS SECTIONS**

Designed By M. LAWS Conçu par  
 Date 2015/02/03 (yyyy/mm/dd)

Drawn By R. HALLEY Dessiné par  
 Date 2015/03/19 (yyyy/mm/dd)

Reviewed By B. PATRICK Examiné par  
 Date 2015/03/30 (yyyy/mm/dd)

Approved By Approved par  
 Date (yyyy/mm/dd)

Tender Soumission

Project Manager Administrateur de projets

Project no. No. du projet

**5P420-14-5097/A**

Drawing no. No. du dessin

**C-3348-12**




May 27, 2015


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\*EXISTING CONDITIONS ADOPTED FROM AS-CONSTRUCTED DRAWINGS DATED OCT./75 AND HISTORICAL INFORMATION PROVIDED BY CLIENT.

EXISTING CONDITIONS

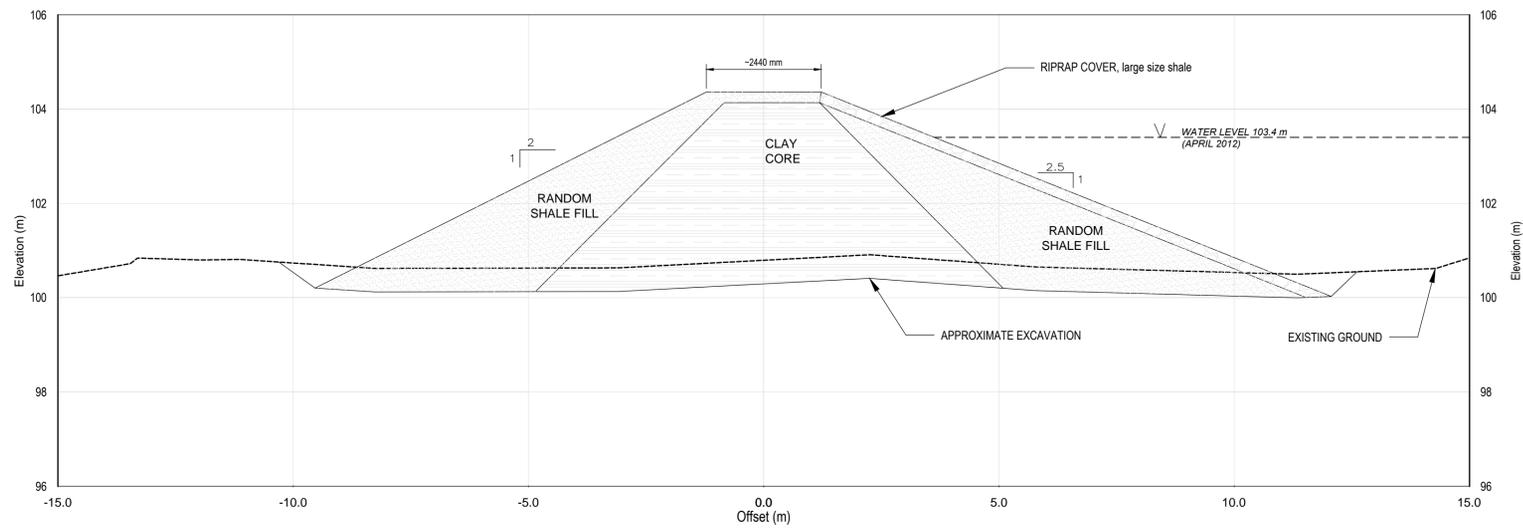


A  
12  
EXISTING CONDITION - SECTION  
SCALE: 1:75 HORIZ. 1:75 VERT.

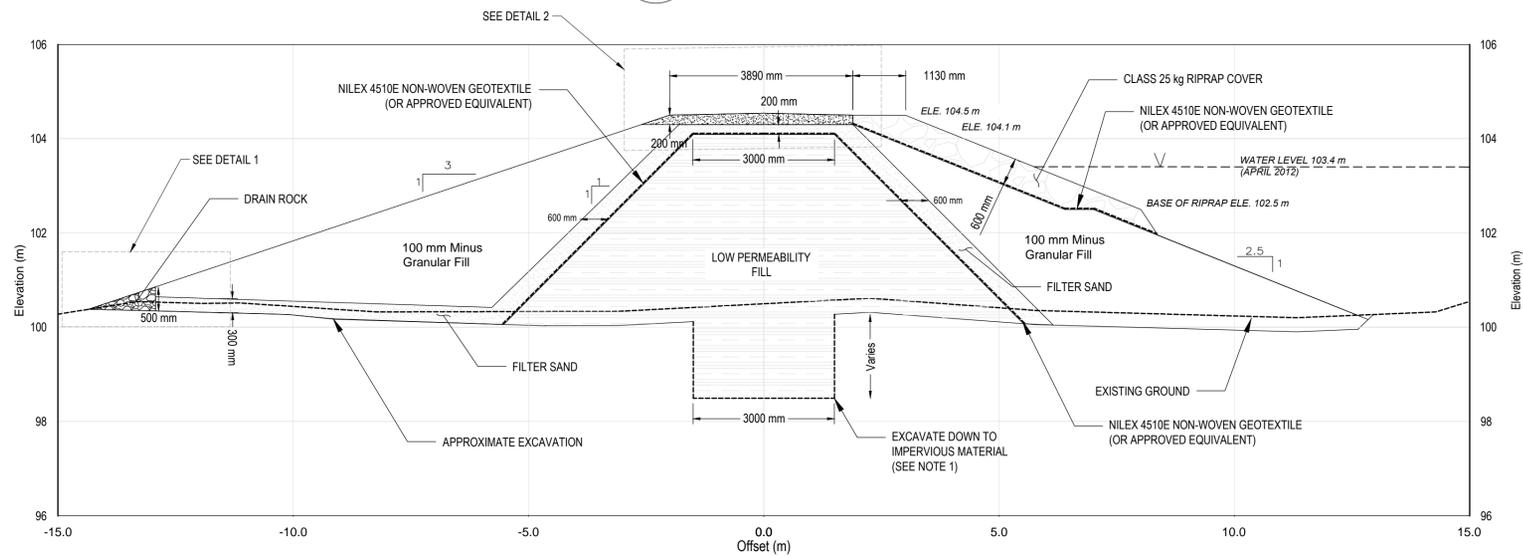


A  
12  
TYPICAL SECTION  
SCALE: 1:75 HORIZ. 1:75 VERT.

NOTES:  
 1. LOW PERMEABILITY CORE TO BE KEED INTO FOUNDATION SOILS. TO BE FIELD FIT ONCE SUBSURFACE CONDITIONS ARE REVEALED.

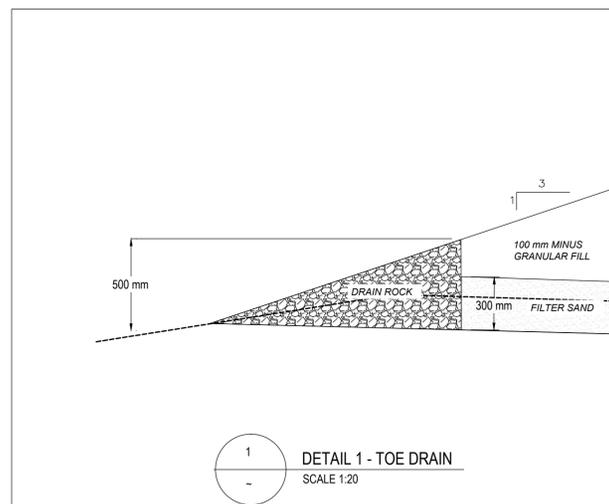

1  
-  
DETAIL 1 - TOE DRAIN  
SCALE 1:20

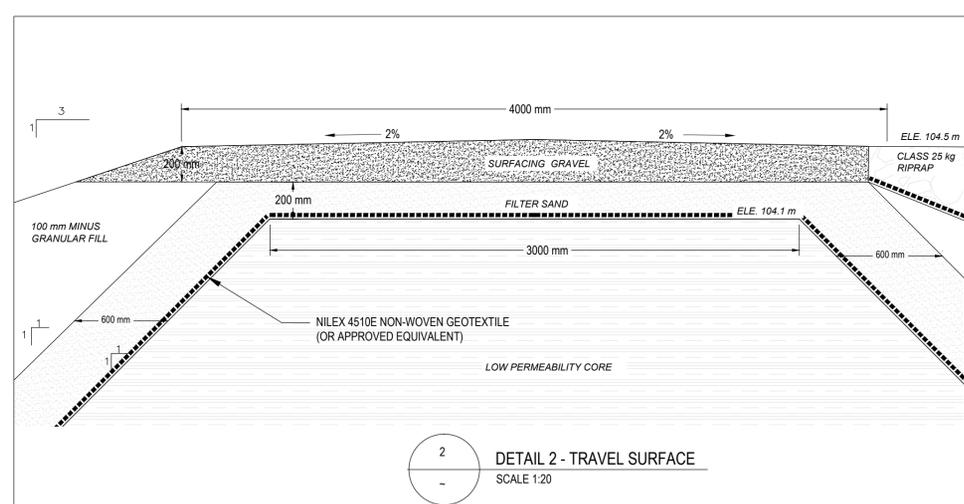

2  
-  
DETAIL 2 - TRAVEL SURFACE  
SCALE 1:20

revisions	description	date
A	A detail no. no. du detail	A
B	B location drawing no. sur dessin no.	B
C	C drawing no. dessin no.	C

Consultants Name / Nom de l'expert - conseil

**TETRA TECH EBA ENGINEERING PRACTICE**  
 150, 1715 Dickson Ave.  
 Kelowna, BC

project / projet  
**GREENBURN LAKE DAM REHABILITATION**  
 GULF ISLAND NATIONAL PARK, BC  
 K13103348-01-001

drawing / dessin  
**EMBANKMENT TYPICAL SECTION & CONSTRUCTION DETAILS**


Designed By	B. PATRICK	Conçu par
Date	2015/03/27	(yyyy/mm/dd)
Drawn By	R. HALLEY	Dessiné par
Date	2015/04/23	(yyyy/mm/dd)
Reviewed By	B. PATRICK	Examiné par
Date	2015/03/30	(yyyy/mm/dd)
Approved By		Approuvé par
Date		(yyyy/mm/dd)
Tender		Soumission
Project Manager		Administrateur de projets
Project no.		No. du projet
		<b>5P420-14-5097/A</b>
Drawing no.		No. du dessin
		<b>C-3348-13</b>



May 27, 2015

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Drawn PSQ/MK	Scale hor: As Noted vert: As Noted	Greenburne Lake Dam Details	c.w. bullock B associates ltd. civil engineers. land development. 3020 foul bay road victoria. b.c. phone 592 2911.	Bedwell Harbour Resorts DRAWING NO: 19301 A Sheet 2 of 2 R2
Checked PSQ	Date Oct. / 79			
2 AS constructed	Jan 9 81			
1 correct pipe end fittings show trench & concrete	Nov 6 79			
Revision	Date			

revisions	description	date
A	A detail no. no. du detail	A
B	B location drawing no. sur dessin no.	B
C	C drawing no. dessin no.	C

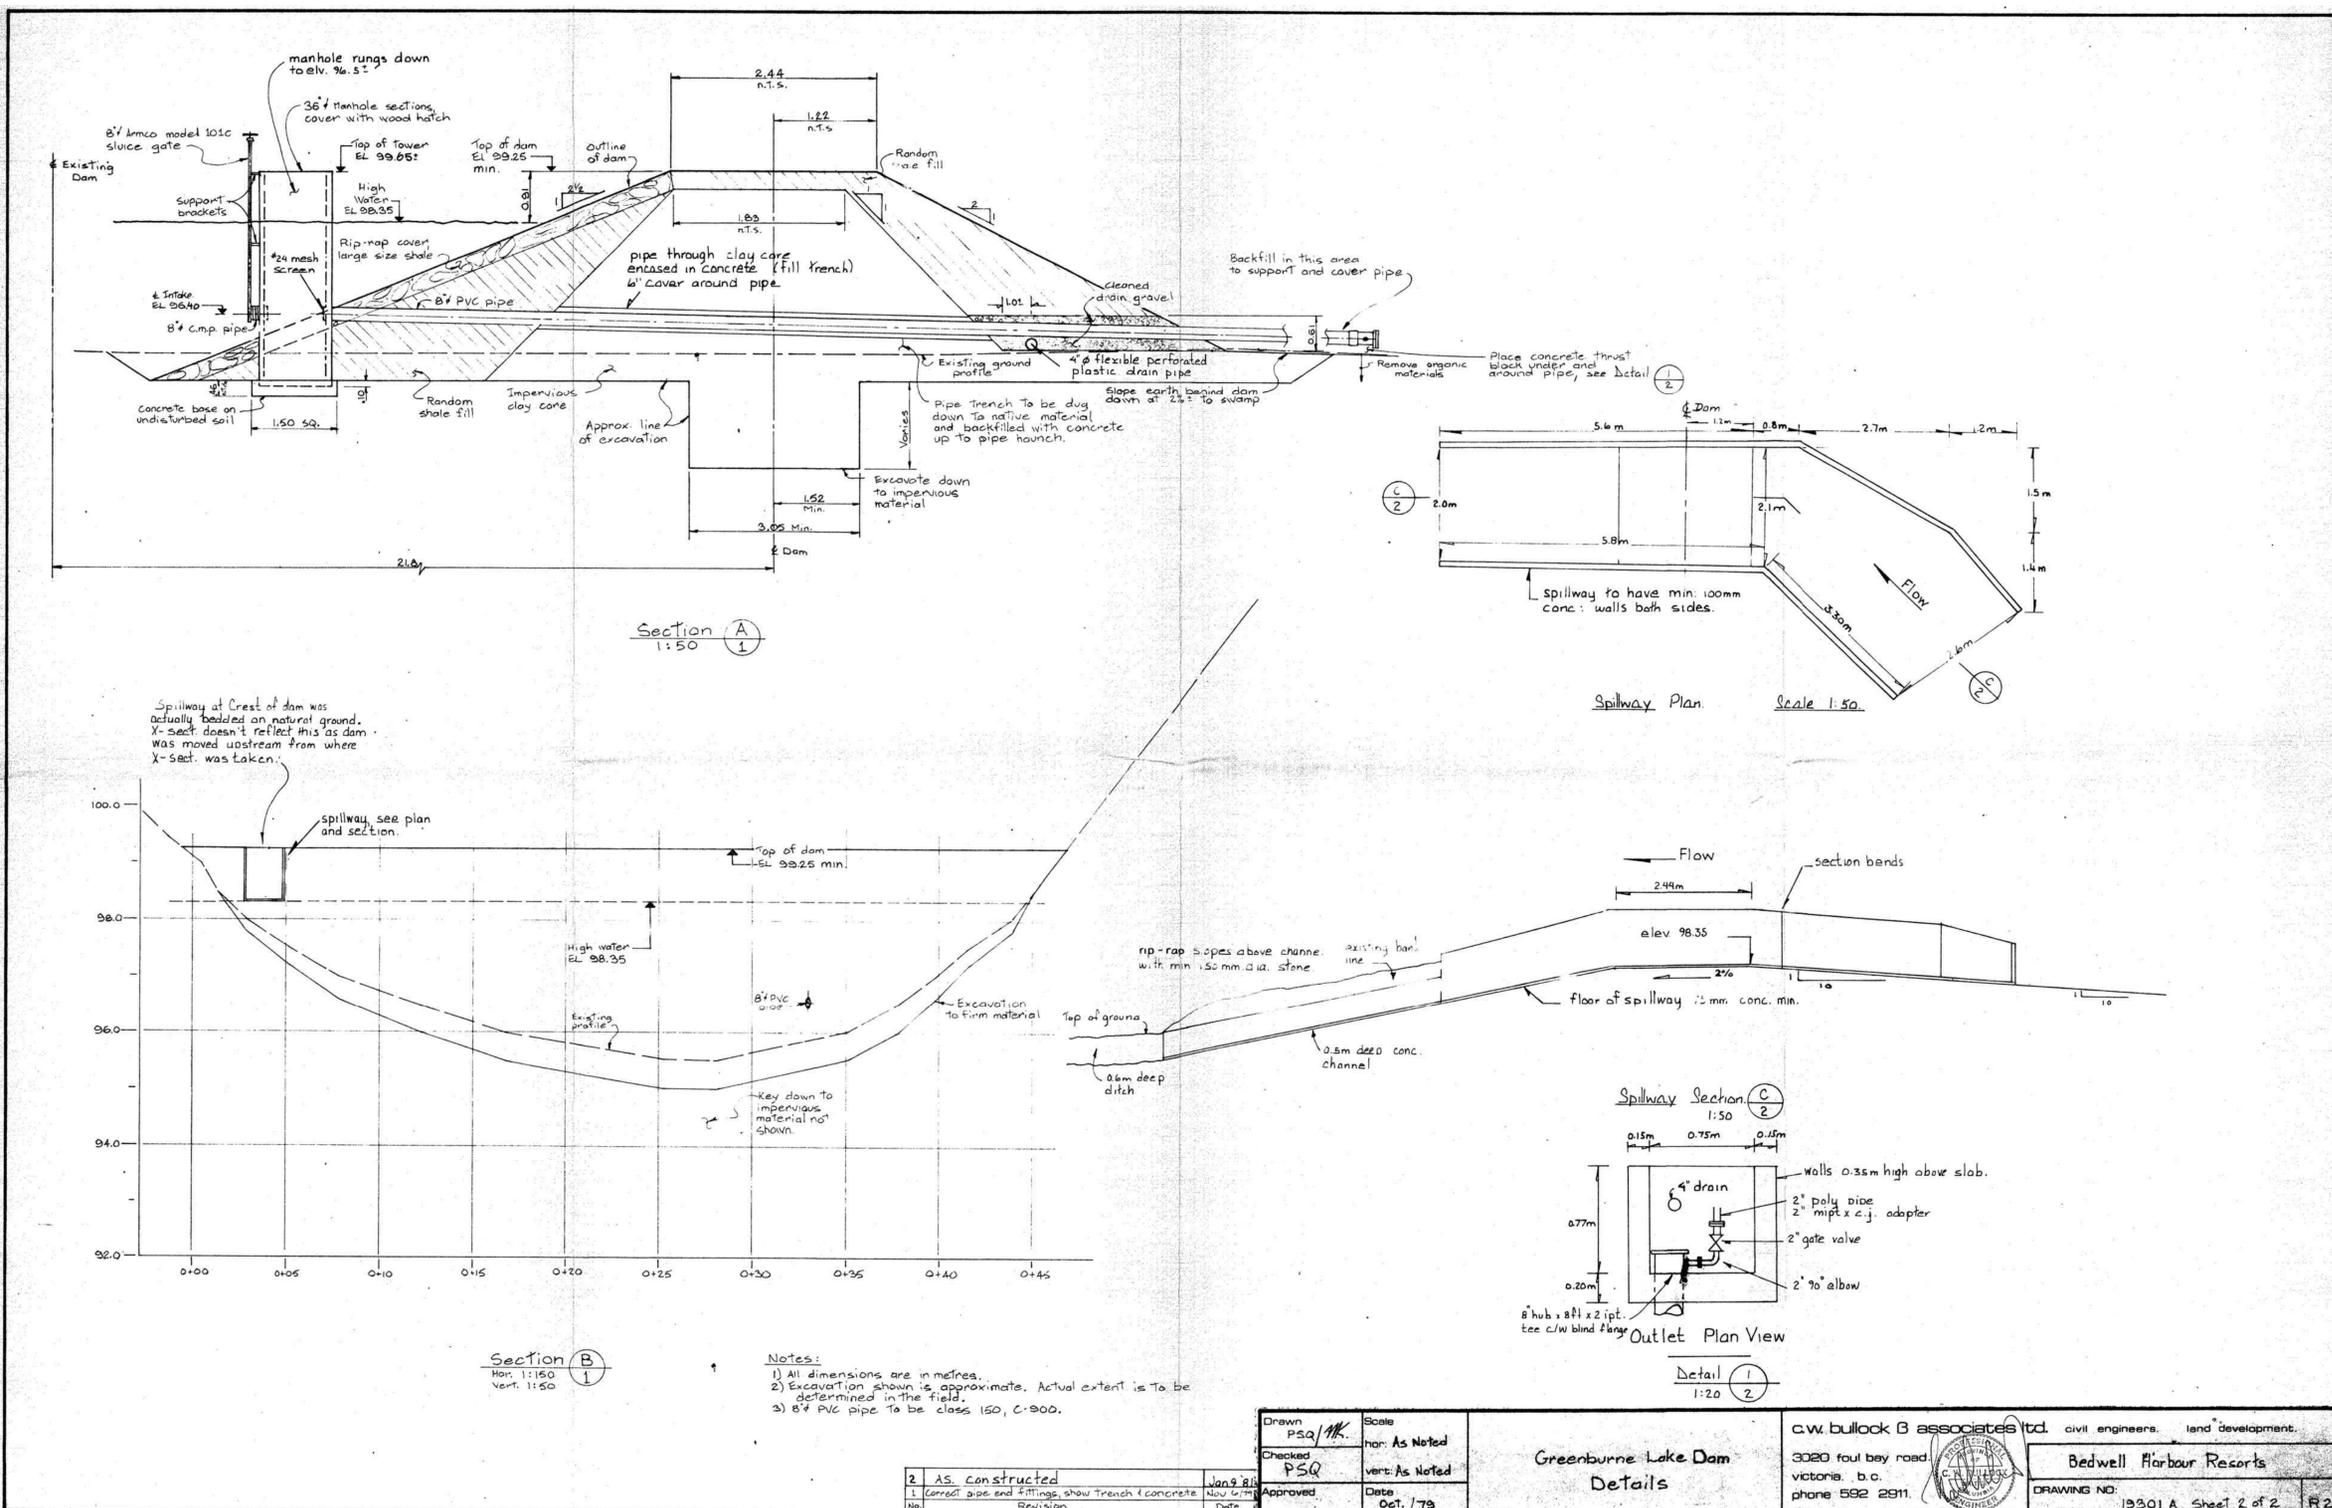Consultants Name / Nom de l'expert - conseil  
**TETRA TECH EBA ENGINEERING PRACTICE**  
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**GREENBURN LAKE DAM REHABILITATION**  
 GULF ISLAND NATIONAL PARK, BC  
 K13103348-01-001

drawing / dessin  
**SPILLWAY EXISTING STRUCTURE AND AS BUILT SECTIONS**

Designed By P. ALDRIDGE	Conçu par 2015/03/21	(yyyy/mm/dd)
Drawn By A. FRY	Dessiné par 2015/03/24	(yyyy/mm/dd)
Reviewed By R. SLOPEK	Examiné par 2015/03/25	(yyyy/mm/dd)
Approved By	Approuvé par	(yyyy/mm/dd)
Date		(yyyy/mm/dd)
Tender	Soumission	

Project Manager / Administrateur de projets  
 Project no. / No. du projet  
**5P420-14-5097/A**  
 Drawing no. / No. du dessin  
**C-3348-14**