


Addendum / Addenda

Project Description / Description de projet S-77 Re-Roofing		
Solicitation No./N° de sollicitation 15-22030	Project No./N° de projet 5055	W.O. No./N° d'ordre de travail
Departmental Representative / représentant ministériel Janik Leroux		Date June 17, 2015
Notice: This addendum shall form part of the tender documents and all conditions shall apply and be read in conjunction with the original plans and specifications.		Nota: Cet addenda fait partie intégrale des dossiers d'appel; toutes les conditions énoncées doivent être lues et appliquées en conjonction avec les plans et les devis originaux.


Refer to attached revised drawings D-5055-R1 and D-5055-R2 "Revised as per Addendum #2" dated 2015/06/16.

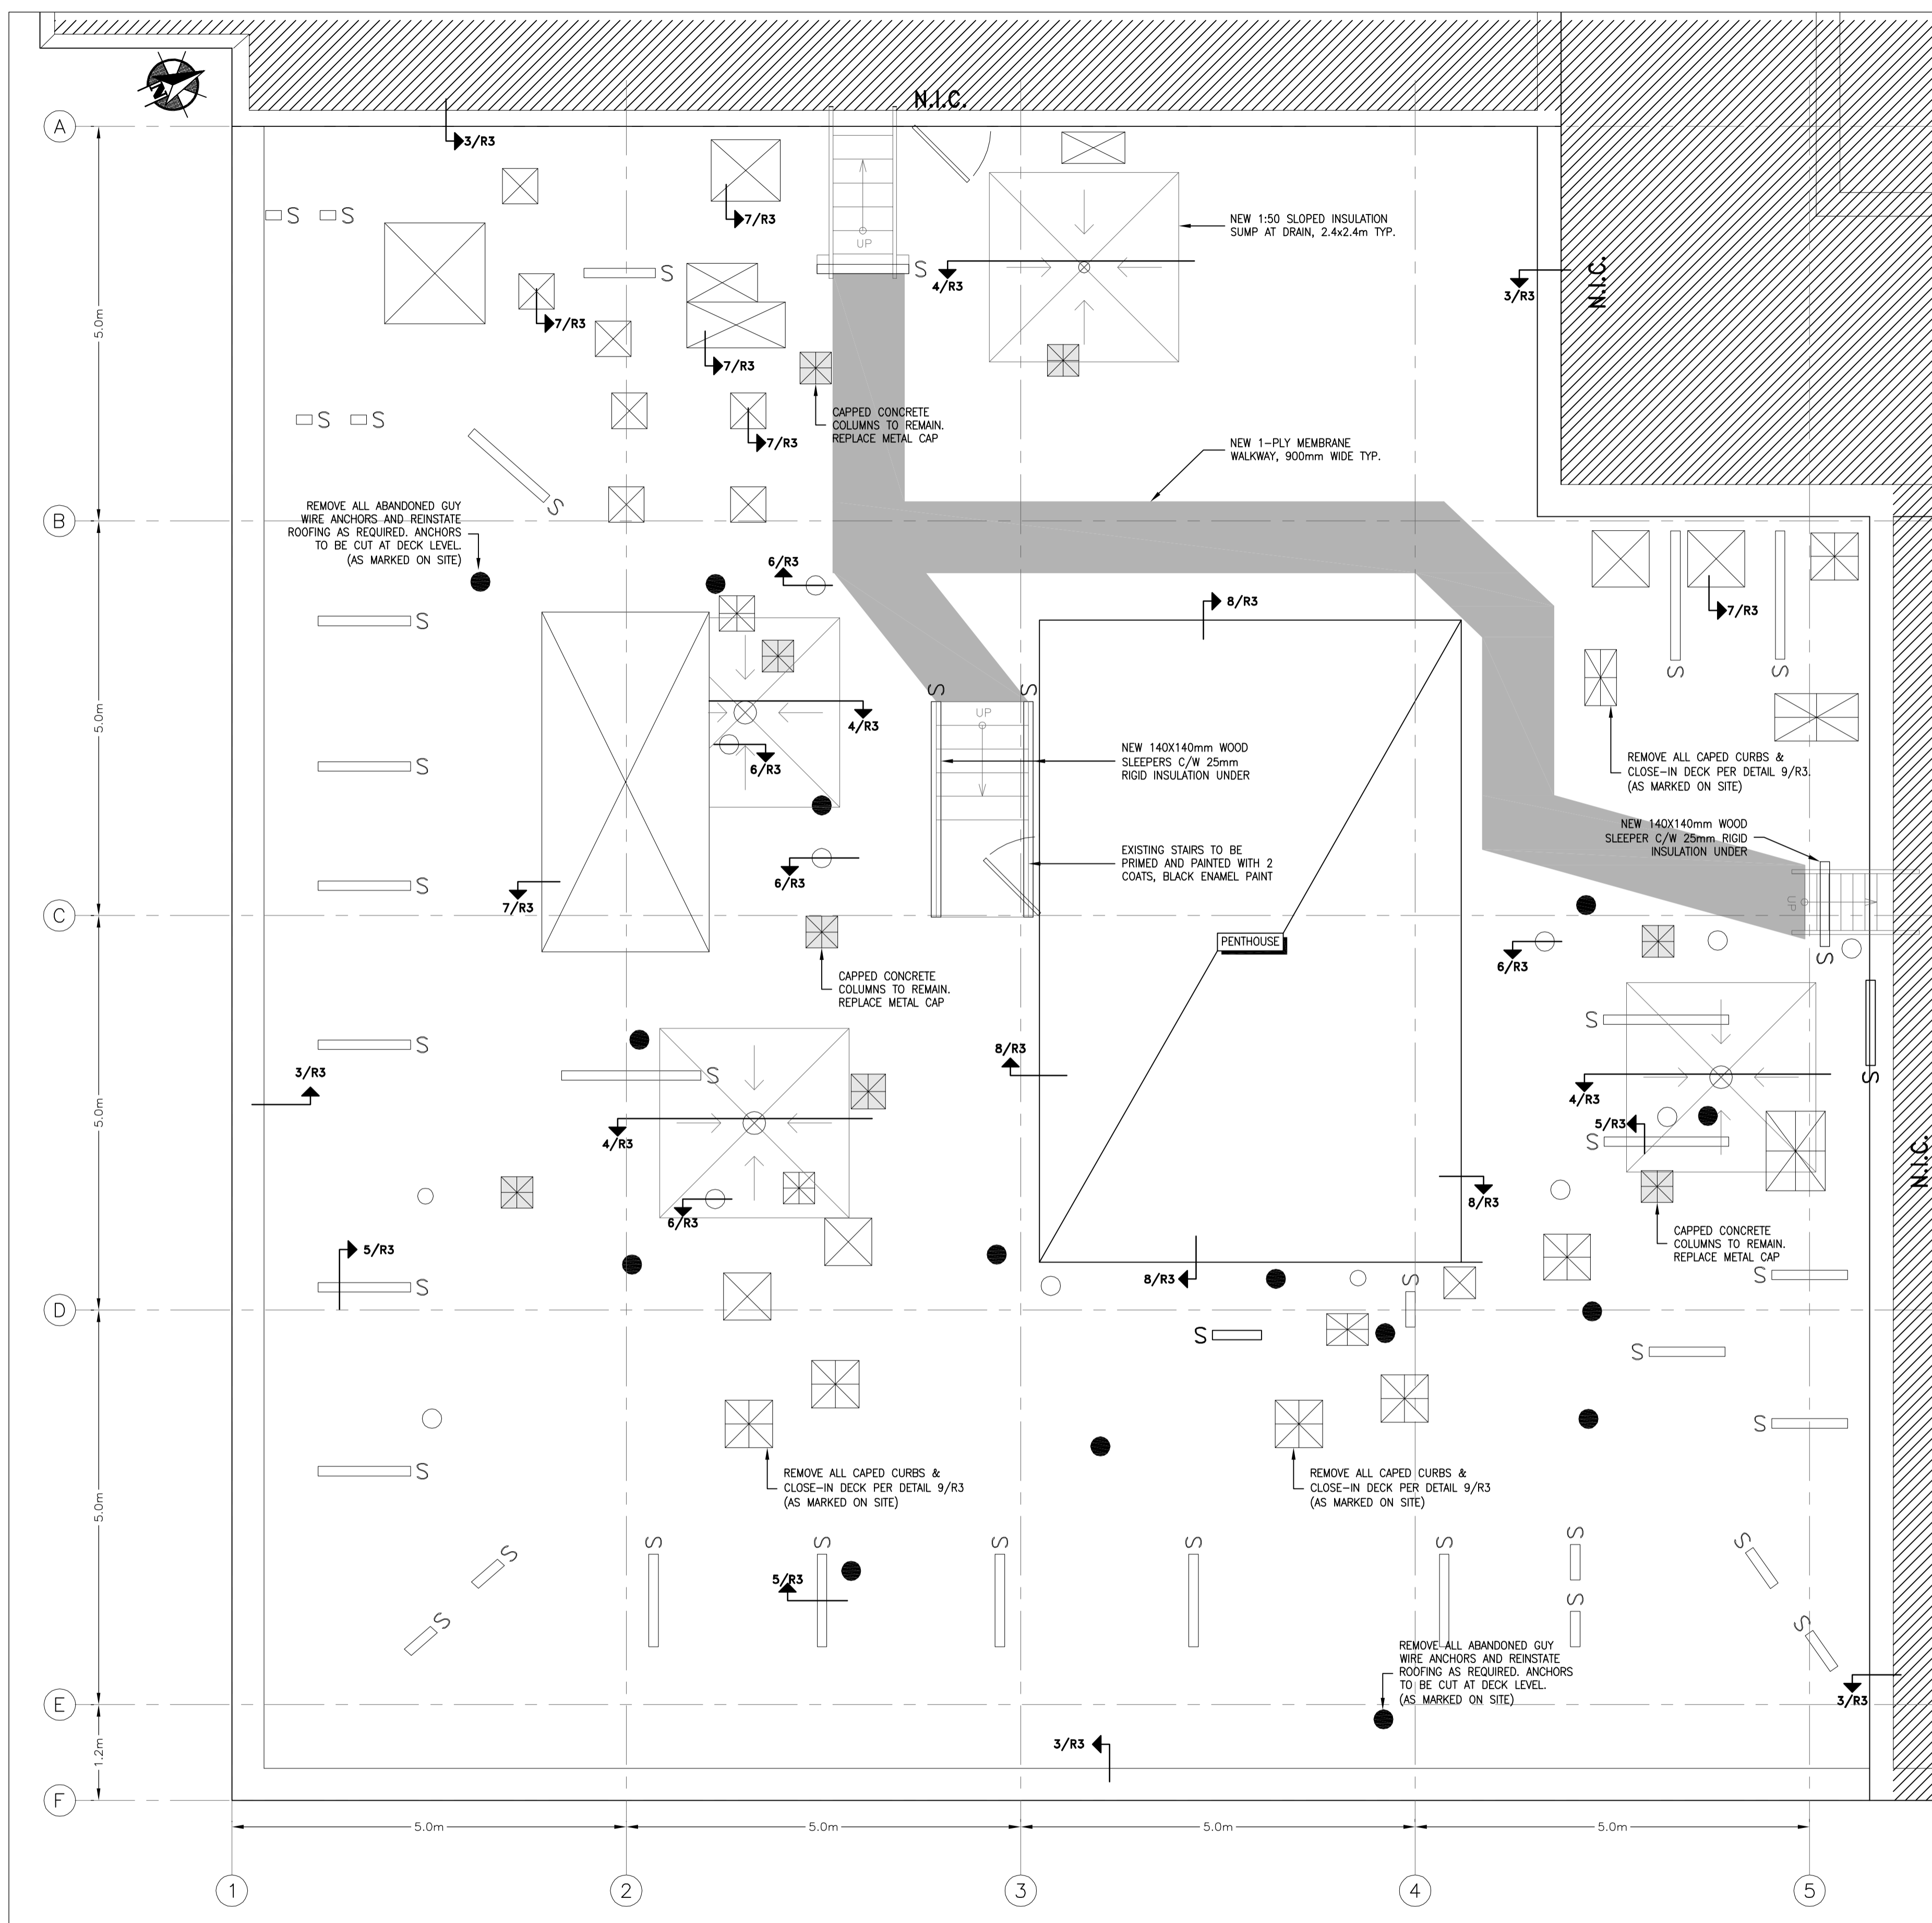

SCHEDULE	
ROOF 1	
NEW ROOF ASSEMBLY -NEW 2 PLY MBM -EXISTING ASSEMBLY TO REMAIN (POWER WASH AND PRIME MEMBRANE SURFACE)	




300-2611 QUEENSWAY DRIVE
 OTTAWA, ONTARIO CANADA K2B 8K2
 TELEPHONE: (613) 829-2800
 FAX: (613) 829-8299

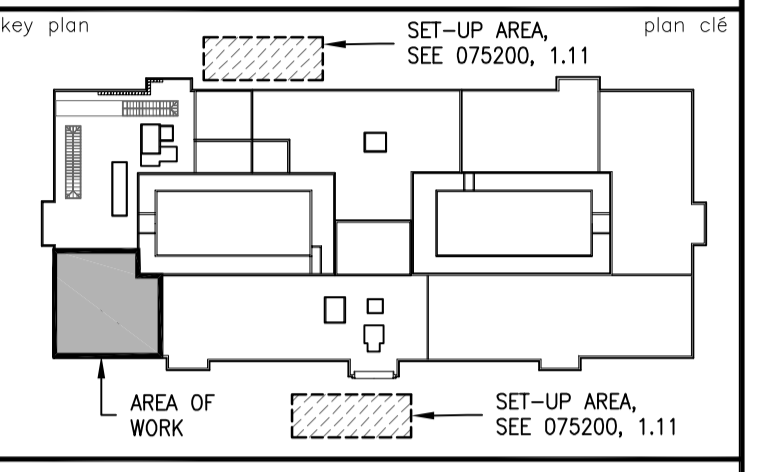

- SET-UP AREAS ADDED TO KEY PLAN
- SET-UP AREAS LOCATIONS ARE GENERAL LOCATIONS AND MAY VARY BY SITE OPERATIONS.
 - AT SETUP AREAS, PROTECT GRASS AREA WITH 3/4" PLYWOOD AND REINSTATE WITH TOP SOIL AND SOD (NURSERY GRADE) AS REQUIRED. KEEP SOD WATERED FOR MINIMUM 15 DAYS.

2015/06/16	REVISED AS PER ADDENDUM #2	J.C.
2015/05/27	ISSUED FOR TENDER	J.C.
2015/04/16	ISSUED FOR REVIEW	J.C.
No.	Date	Revision
		By: / Par:



- Date Printed / Date imprimée
- Verify all dimensions and site conditions and be responsible for same
 - Vérifier toutes les dimensions et l'état des lieux et en assumer la responsabilité

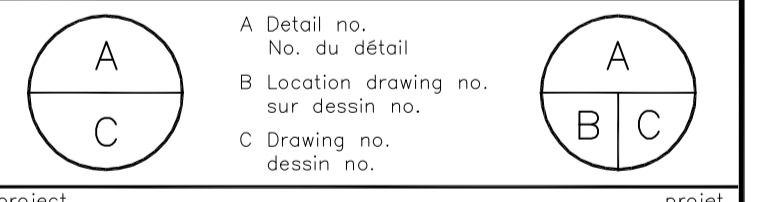


project / projet
NATIONAL RESEARCH COUNCIL CANADA
BUILDING S77 - ROOF REPLACEMENT
 100 SUSSEX DRIVE, OTTAWA, ONTARIO

drawing / dessin
ROOF 1 - ROOF PLAN


designed / conçu	M. PAULIN	date	2015/05/01
drawn / dessiné	J. C. / M. P.	scale	AS SHOWN
checked / vérifié	J. CALLENDER	sheet / feuille	1 of / de 4
approved / approuvé	-	job no. / no. de projet	-
dwg. no. / dessin no.	D-5055-R1		

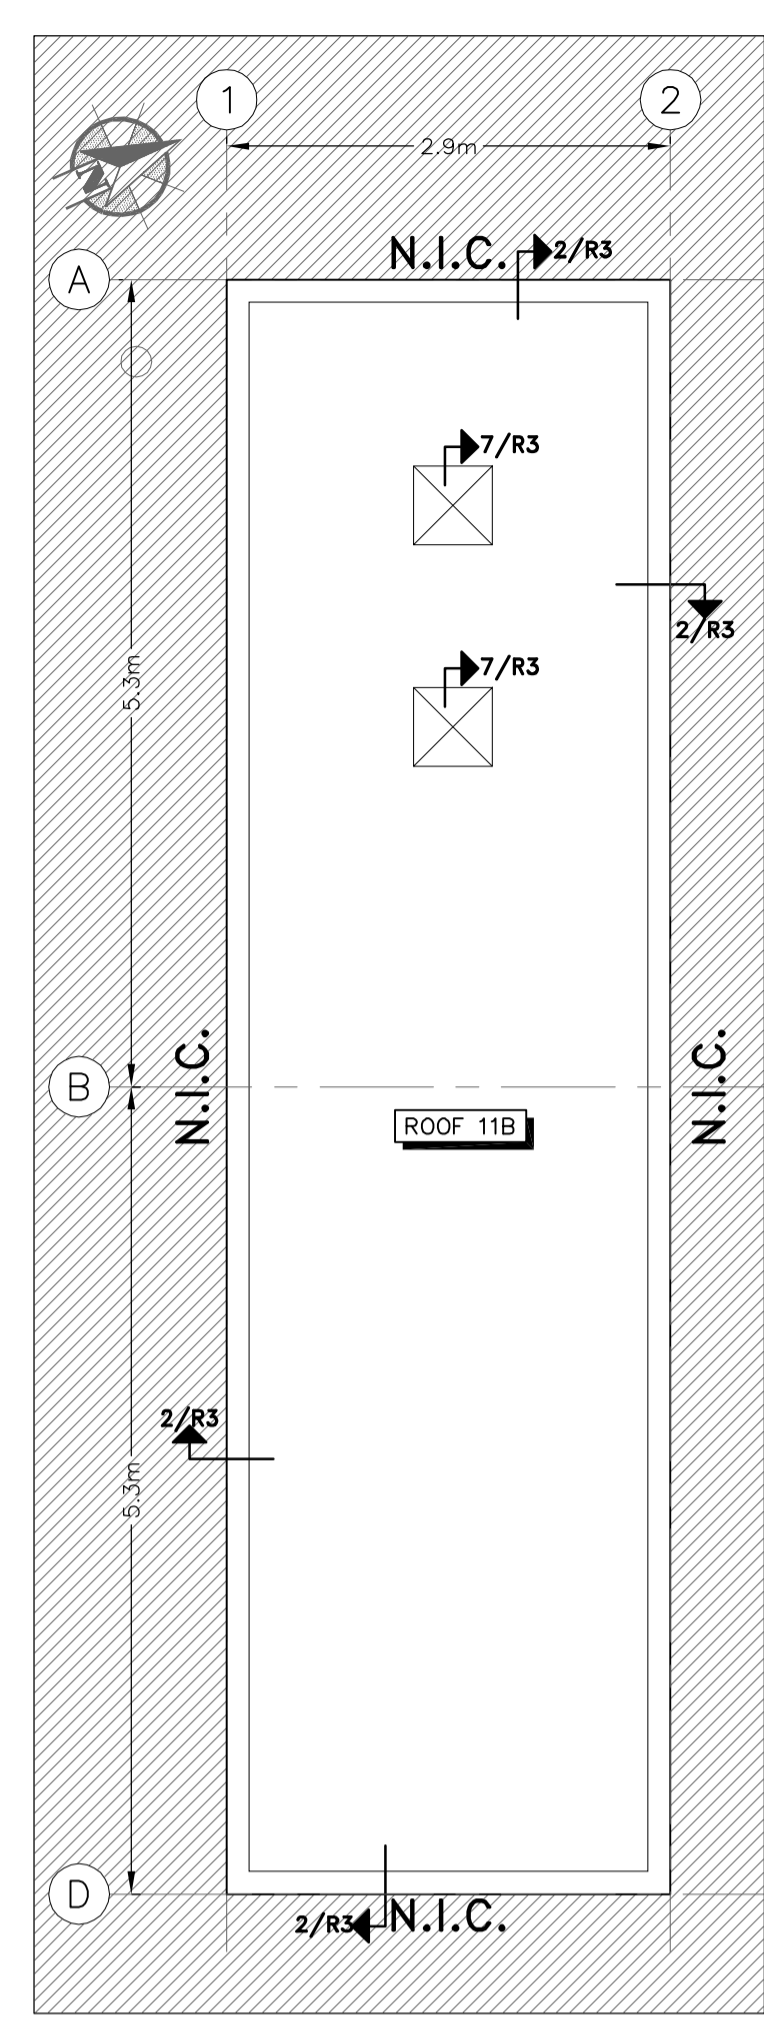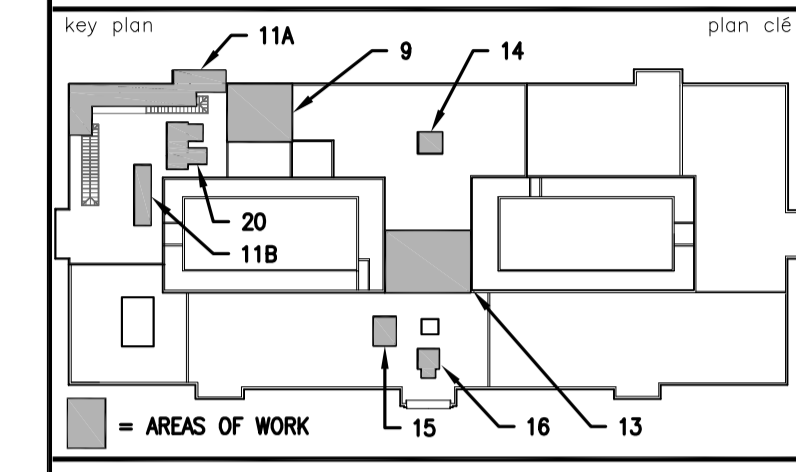


ROOF 11B - ROOF PLAN
 SCALE 1 : 50

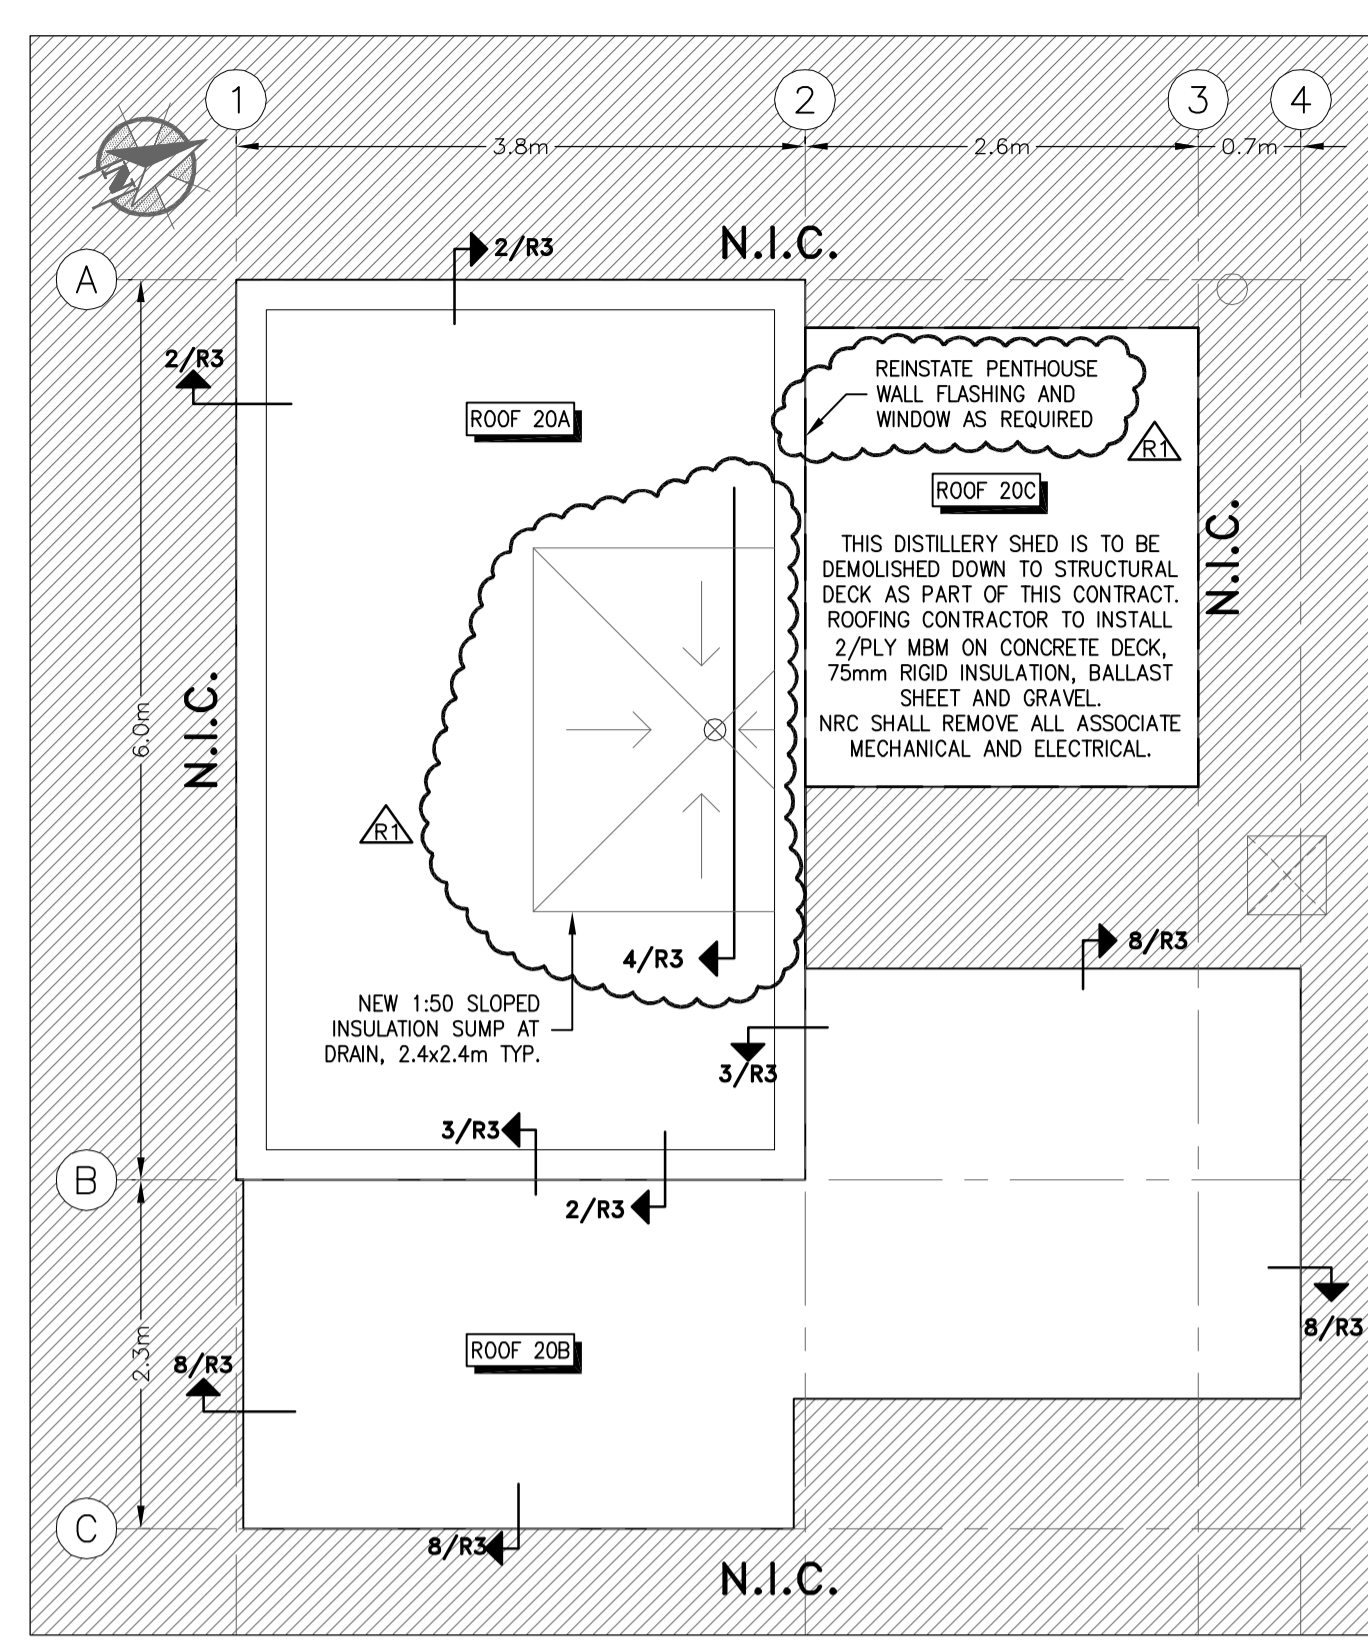


ROOF 20 - ROOF PLAN
 SCALE 1 : 50

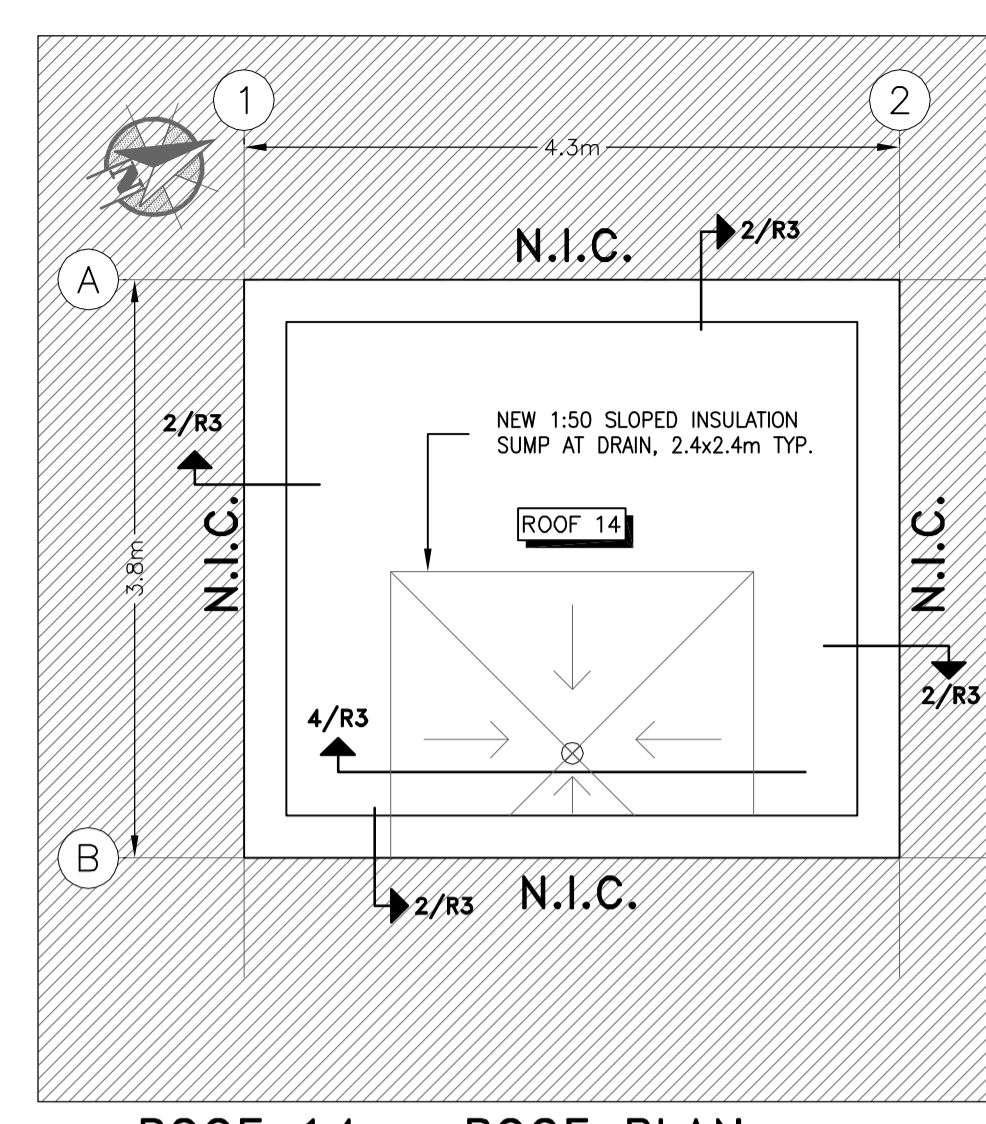


ROOF 14 - ROOF PLAN
 SCALE 1 : 50

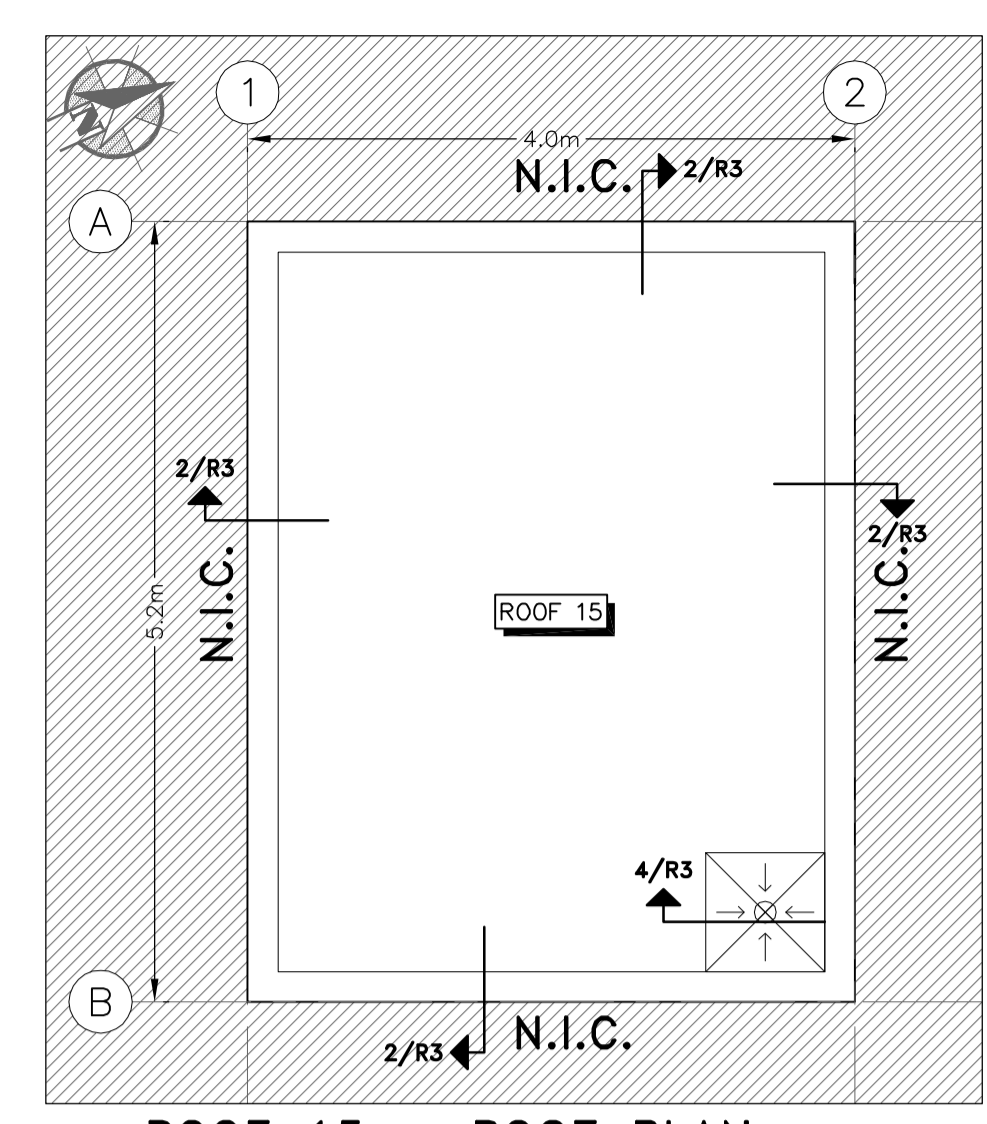

ROOF 15 - ROOF PLAN
 SCALE 1 : 50

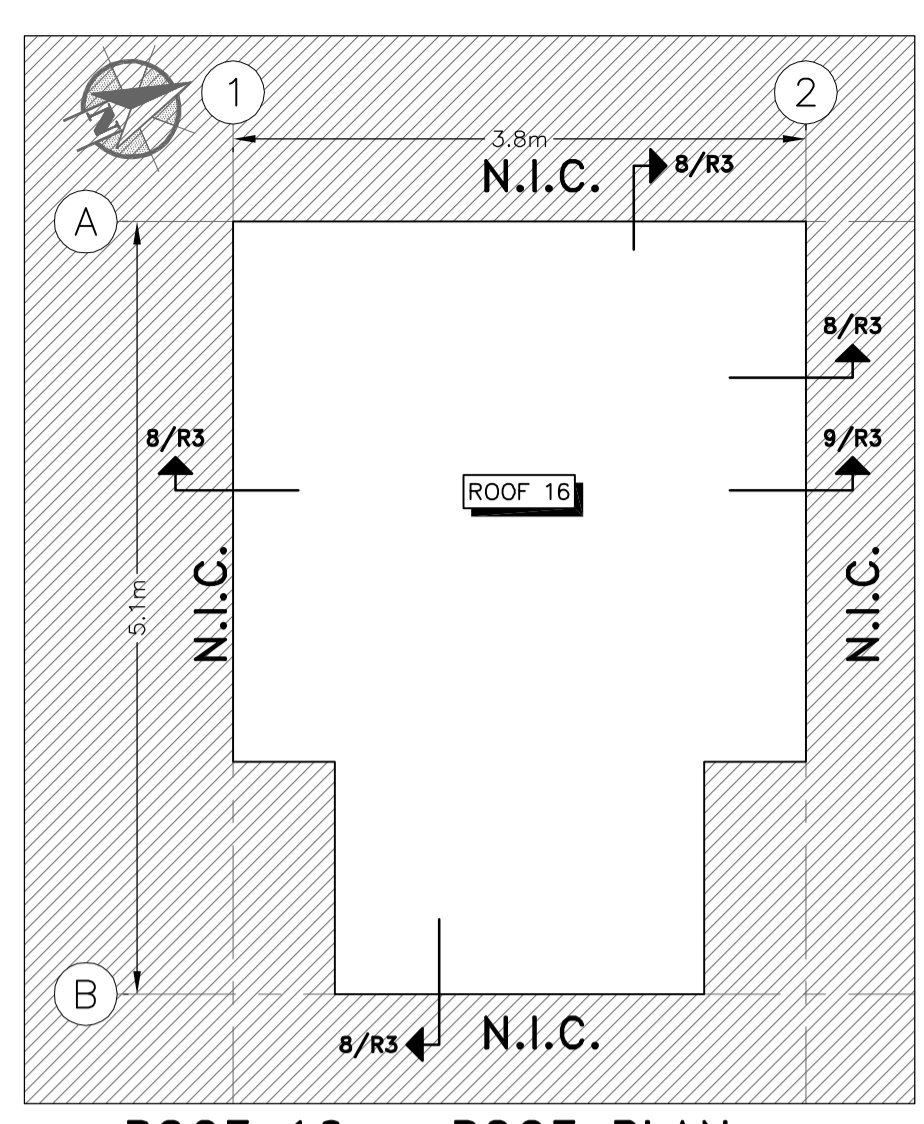


ROOF 16 - ROOF PLAN
 SCALE 1 : 50

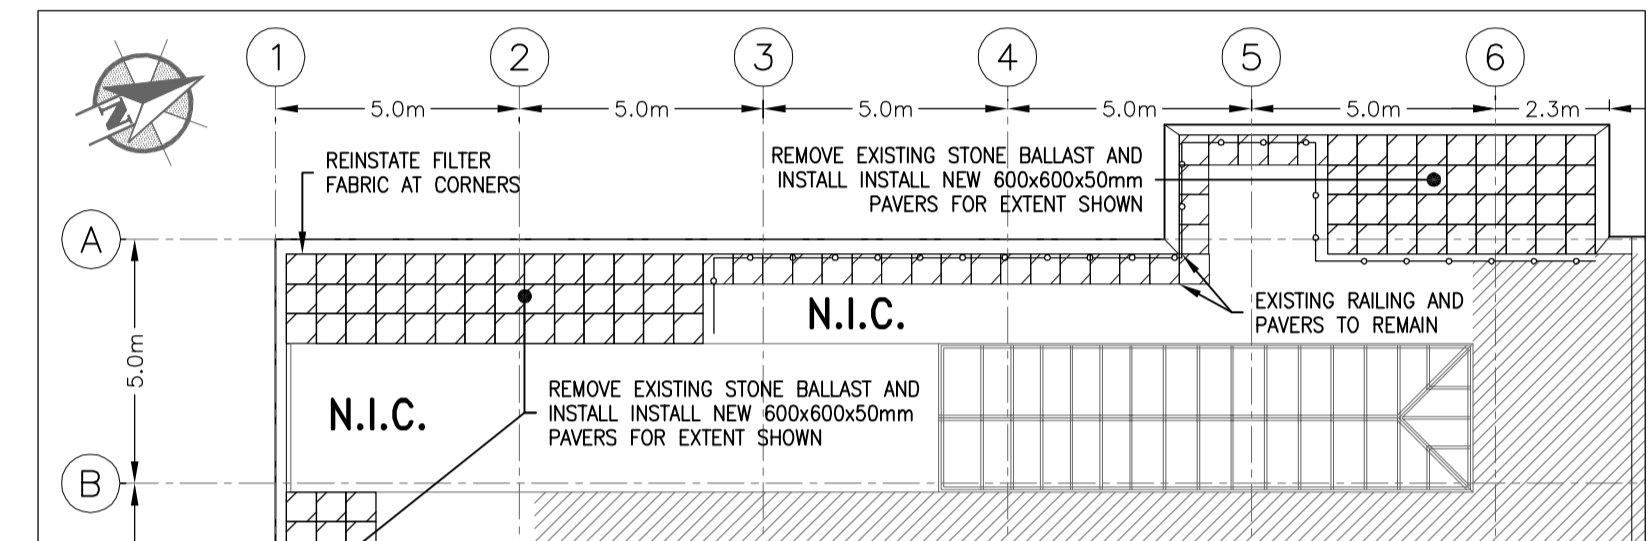


ROOF 11A - PARTIAL ROOF PLAN
 SCALE 1 : 150

SCHEDULE		
ROOF 11B NEW ROOF ASSEMBLY -NEW 2 PLY MBM -EXISTING ASSEMBLY TO REMAIN (POWER WASH AND PRIME MEMBRANE SURFACE)	ROOF 20C NEW ROOF ASSEMBLY -NEW 2 PLY MBM -NEW 16mm PLYWOOD -NEW 22ga R30 CAP -FILL ALL Voids WITH INSULATION	ROOF 16 NEW ROOF ASSEMBLY -NEW 2 PLY MBM -EXISTING ASSEMBLY TO REMAIN (POWER WASH AND PRIME MEMBRANE SURFACE)
ROOF 20A NEW ROOF ASSEMBLY -NEW 2 PLY MBM -EXISTING ASSEMBLY TO REMAIN (POWER WASH AND PRIME MEMBRANE SURFACE)	ROOF 14 NEW ROOF ASSEMBLY -NEW 2 PLY MBM -EXISTING ASSEMBLY TO REMAIN (POWER WASH AND PRIME MEMBRANE SURFACE)	ROOF 9 NEW ROOF ASSEMBLY -NEW 2 PLY MBM -NEW 6mm PROTECTION BOARD -EXISTING ASSEMBLY TO REMAIN
ROOF 20B NEW ROOF ASSEMBLY -NEW 2 PLY MBM -EXISTING ASSEMBLY TO REMAIN (POWER WASH AND PRIME MEMBRANE SURFACE)	ROOF 15 NEW ROOF ASSEMBLY -NEW 2 PLY MBM -EXISTING ASSEMBLY TO REMAIN (POWER WASH AND PRIME MEMBRANE SURFACE)	ROOF 13 NEW ROOF ASSEMBLY -NEW 2 PLY MBM -NEW 6mm PROTECTION BOARD -NEW 75mm RIGID INSULATION -NEW SLOPED INSULATION PER PLAN -NEW VAPOUR BARRIER -NEW 12mm DENSDECK -EXISTING STEEL DECK

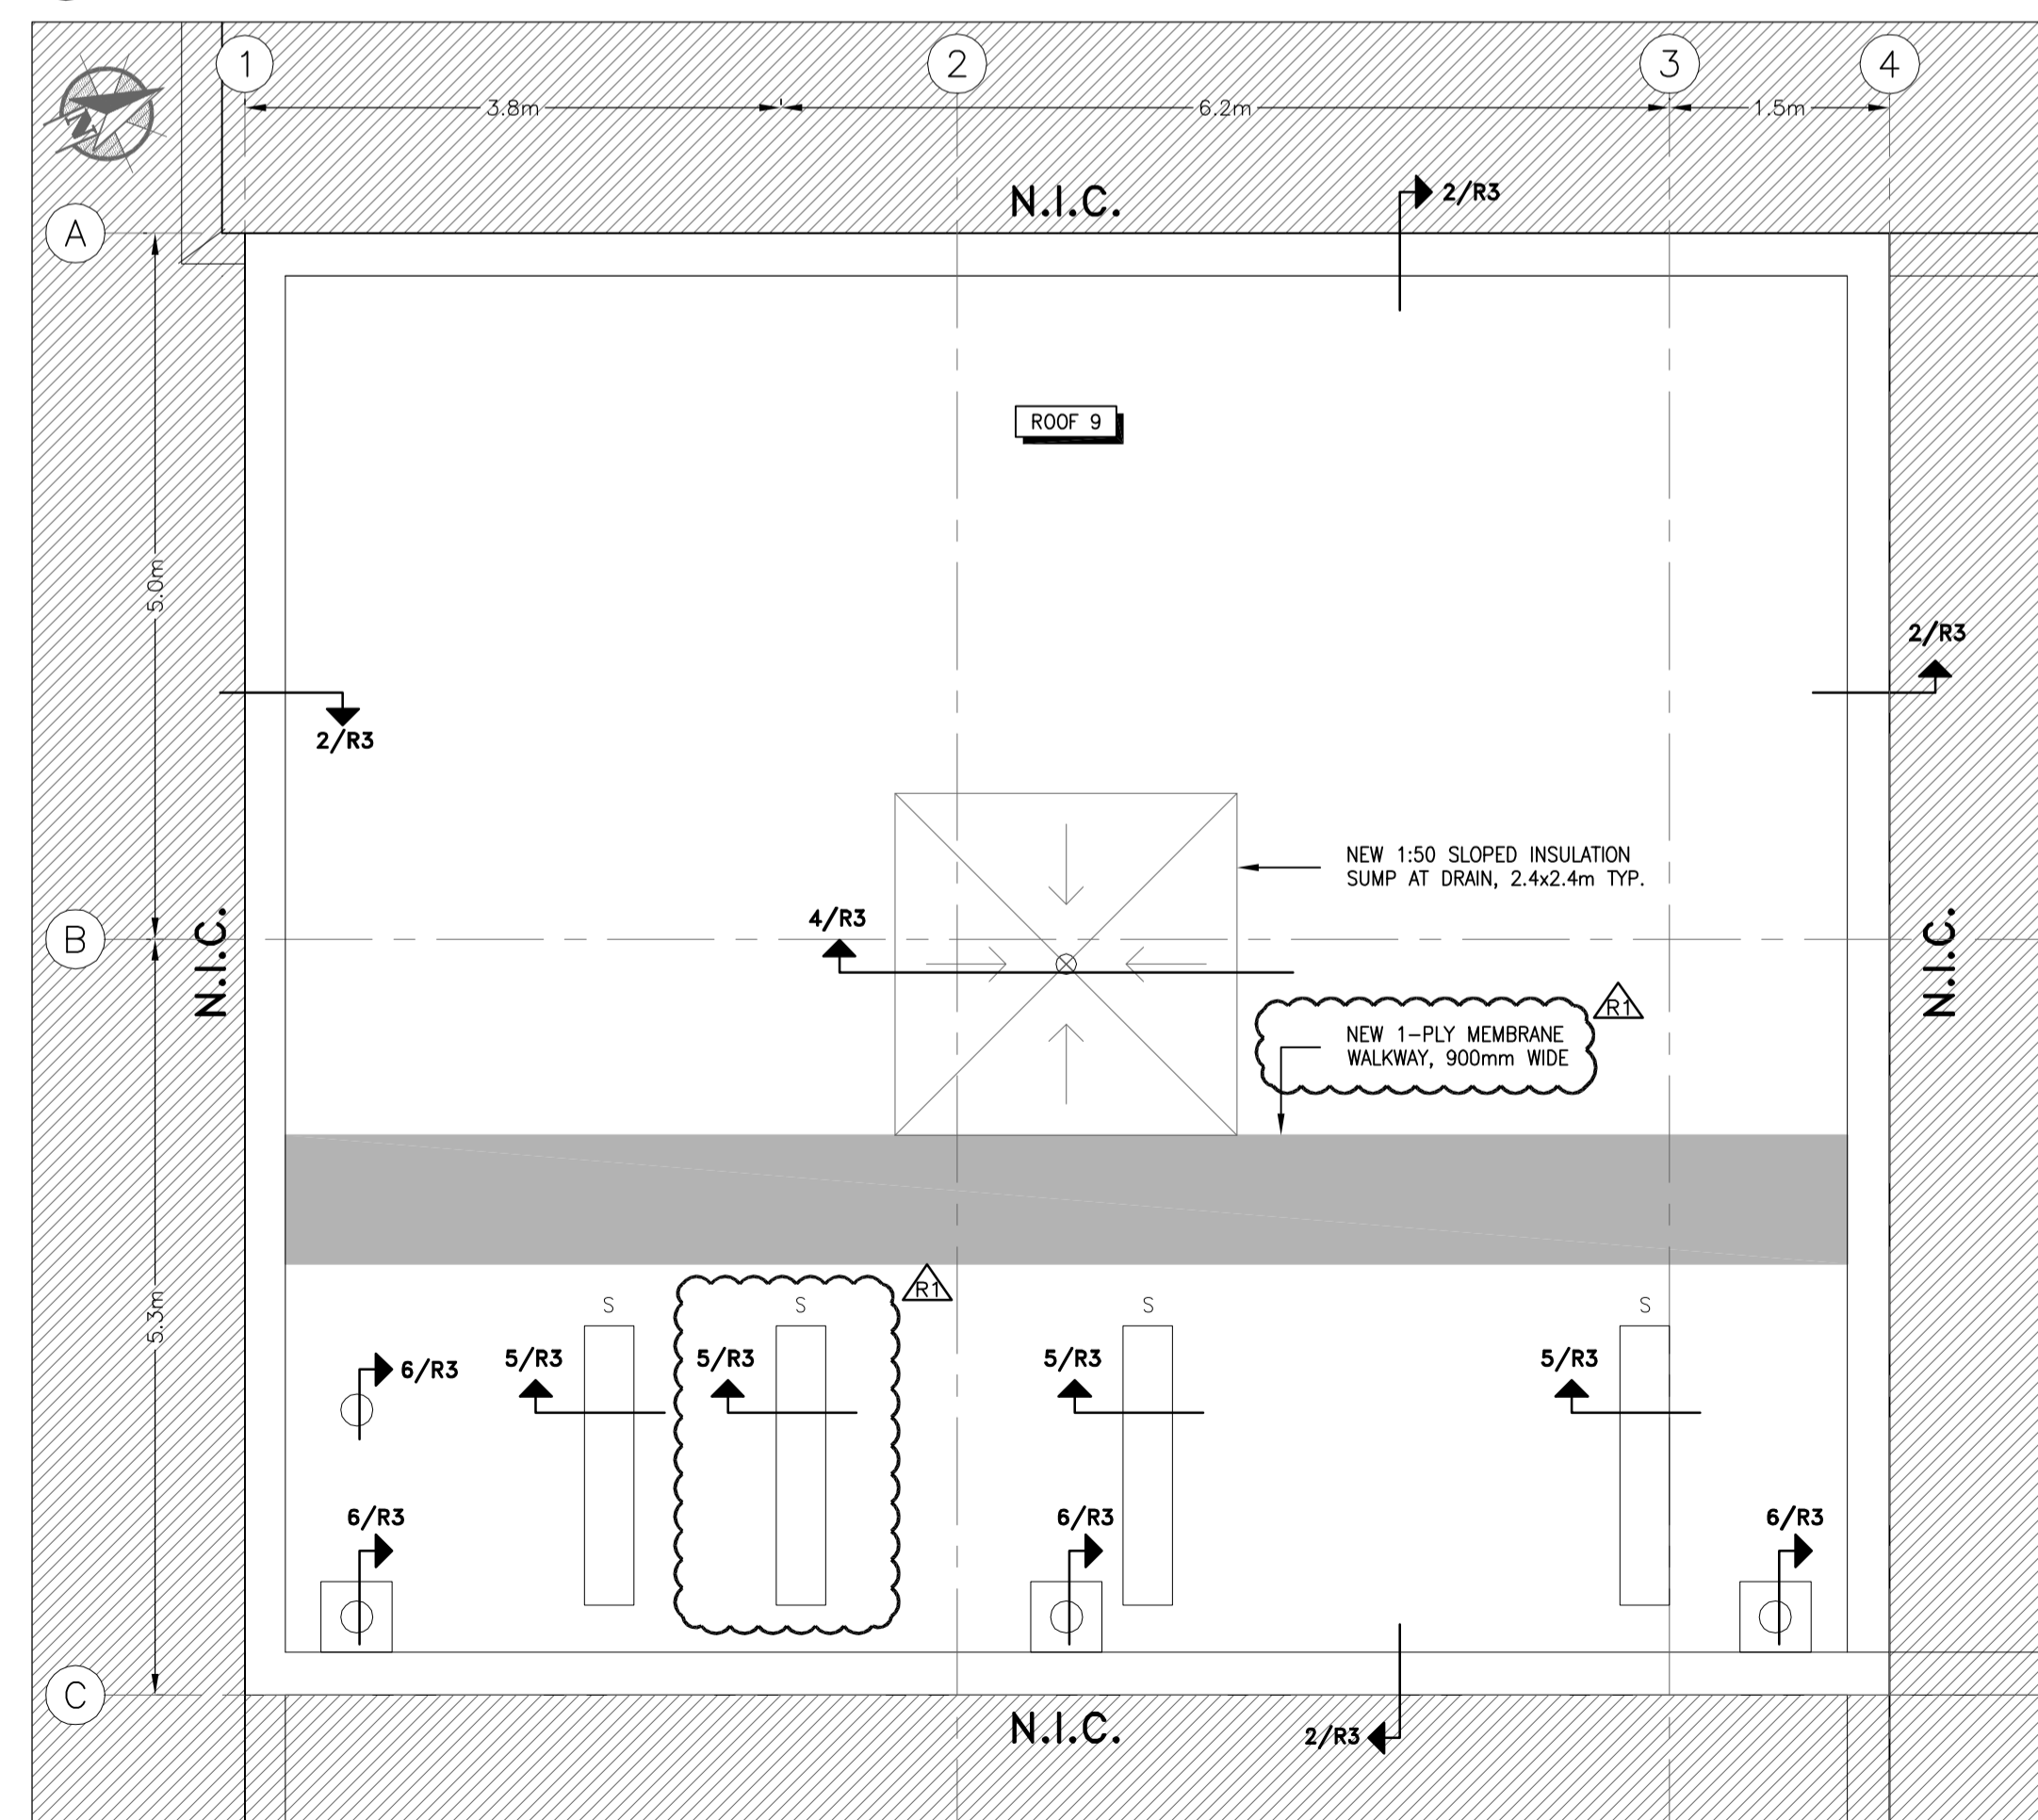


ROOF 9 - ROOF PLAN
 SCALE 1 : 50

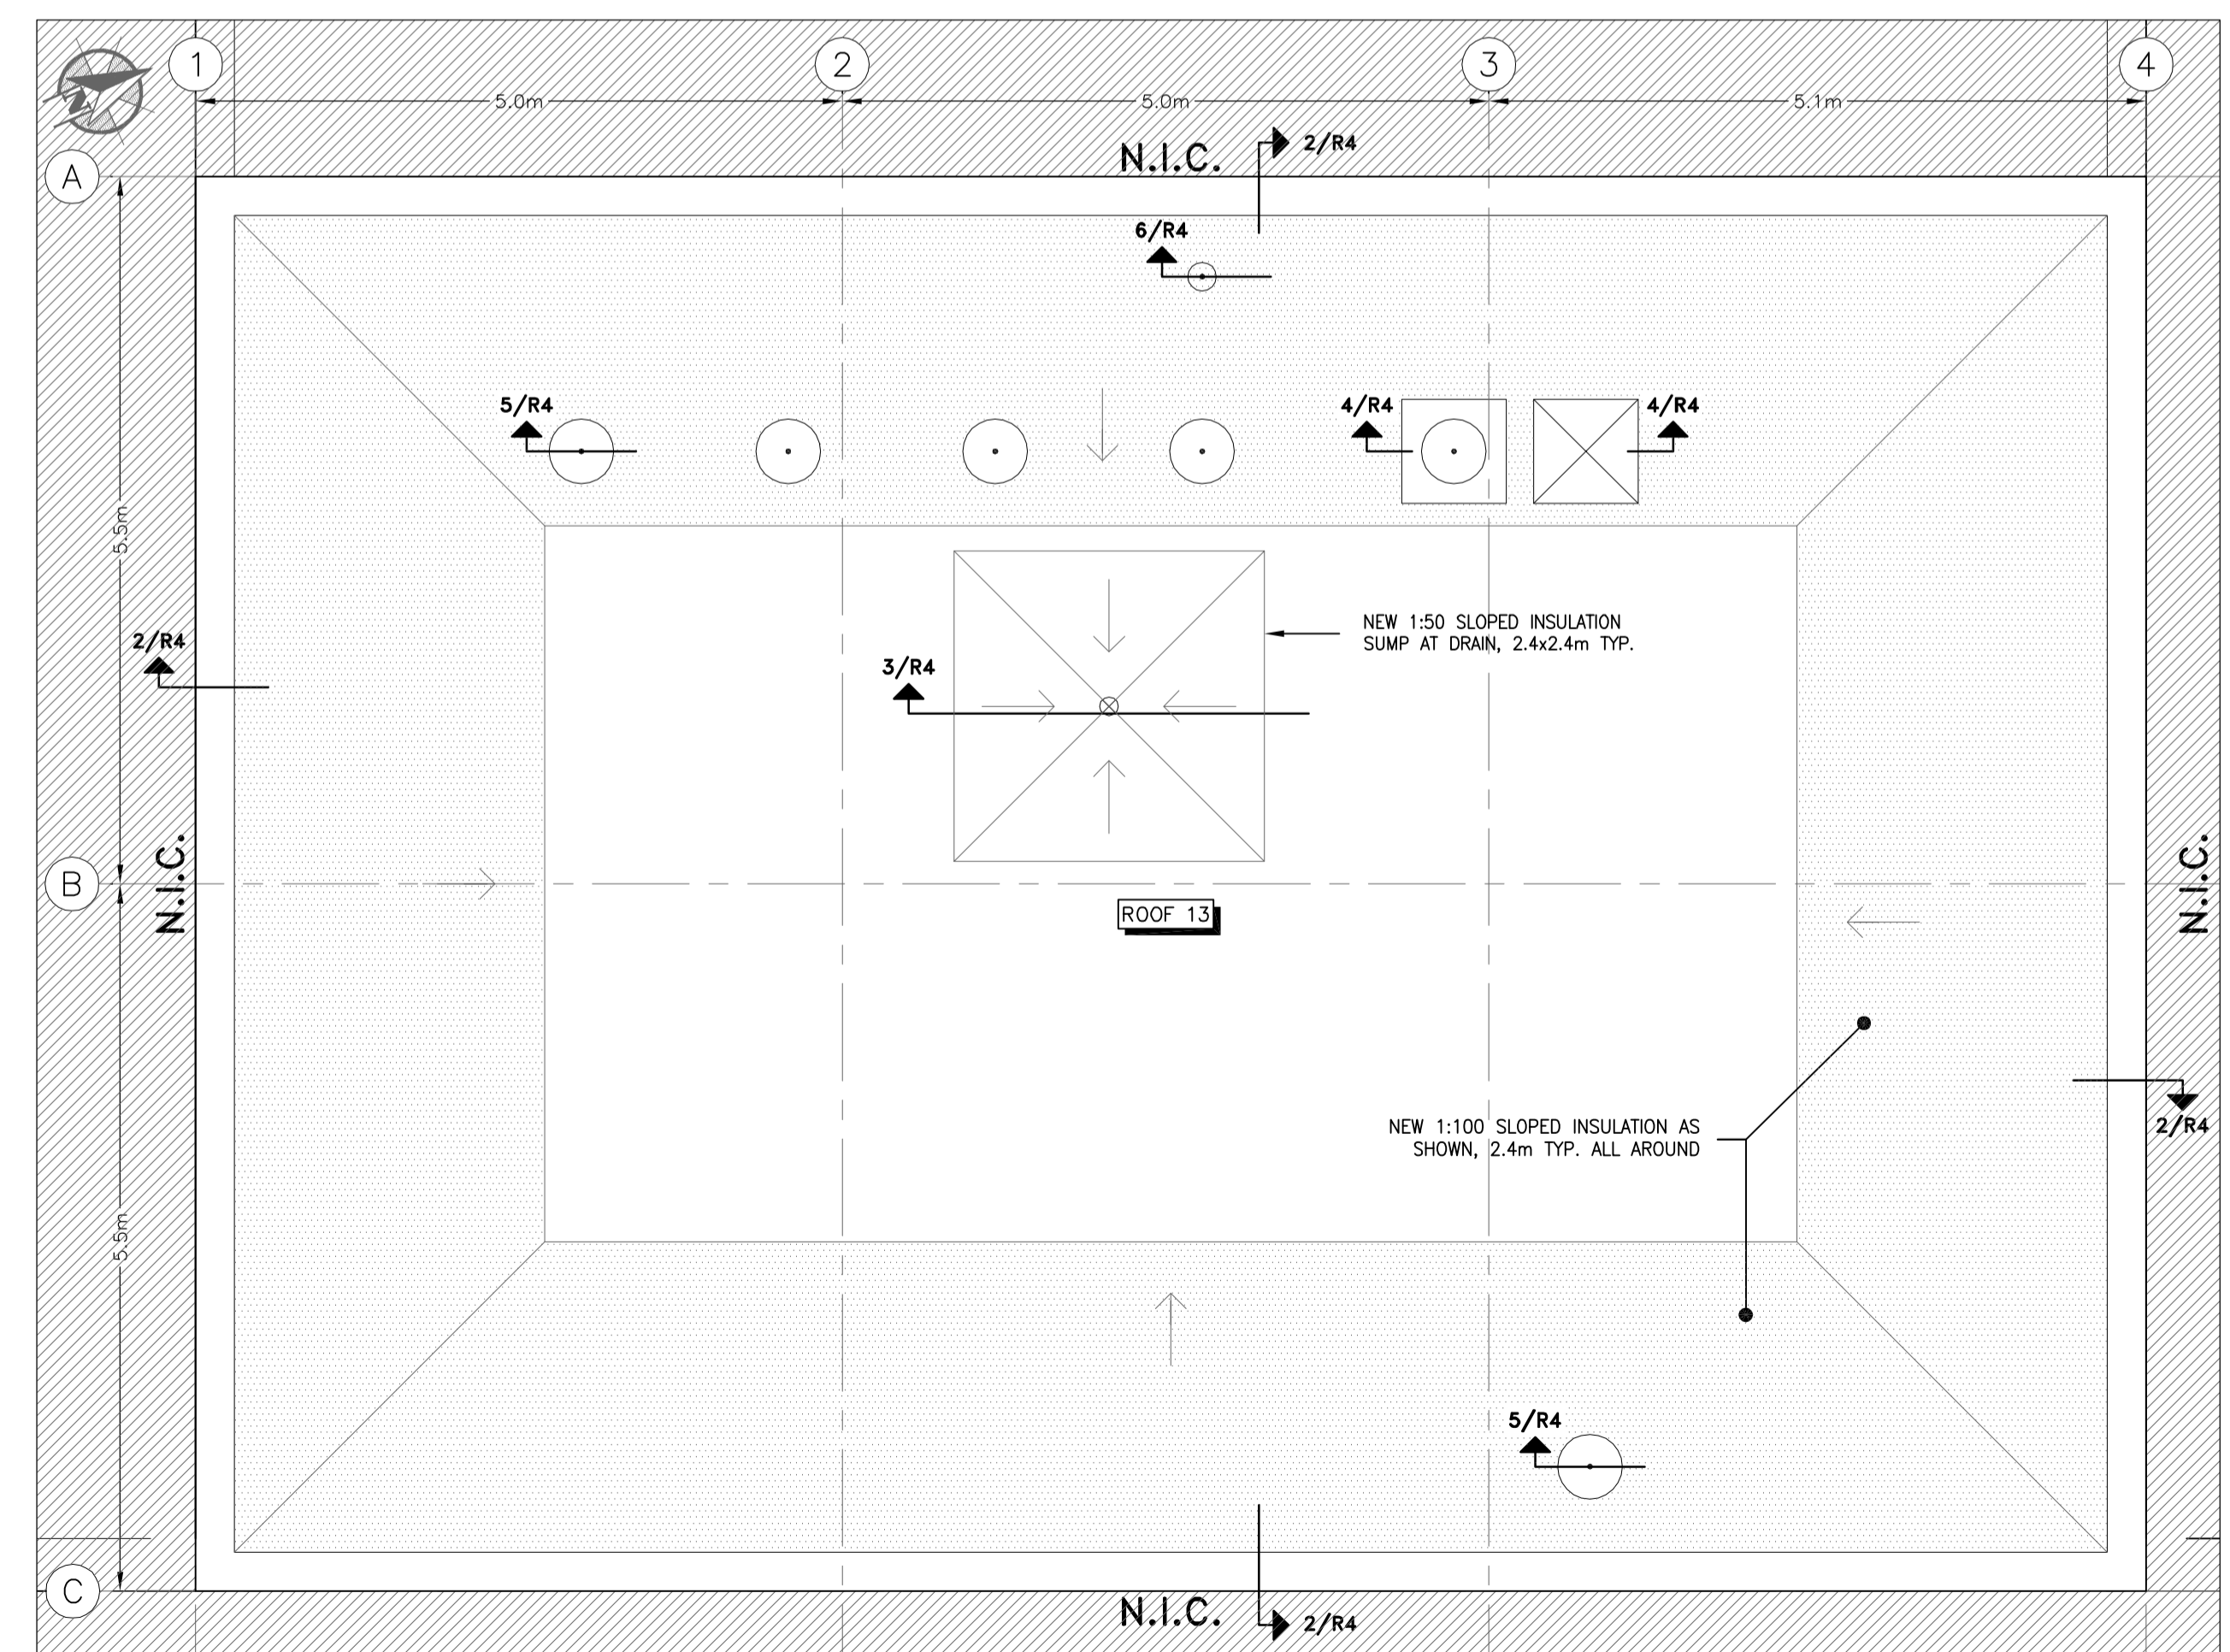

ROOF 13 - ROOF PLAN
 SCALE 1 : 50

No.	Date	Revision	By:	Date imprimée
2015/06/16	REVISED AS PER ADDENDUM #2	J.C.		
2015/05/27	ISSUED FOR TENDER	J.C.		
2015/04/16	ISSUED FOR REVIEW	J.C.		

- Verify all dimensions and site conditions and be responsible for same
- Vérifier toutes les dimensions et l'état des lieux et en assumer la responsabilité

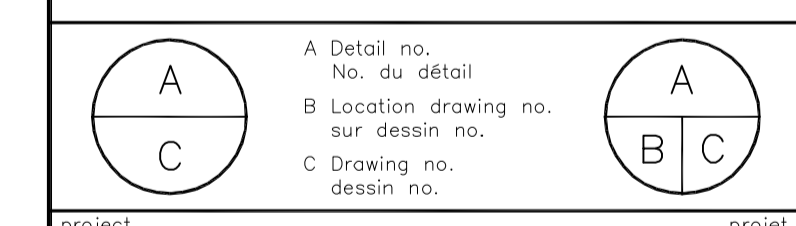

project: **NATIONAL RESEARCH COUNCIL CANADA**
 BUILDING S77 - ROOF REPLACEMENT
 100 SUSSEX DRIVE, OTTAWA, ONTARIO

ROOF PLANS

designed	conçu	date	date
M. PAULIN		2015/05/01	
drawn	dessiné	scale	échelle
J. C. / M. P.		AS SHOWN	
checked	vérifié	sheet	feuille
J. CALLENDER		2 of/de 4	
approved	approuvé	job no.	no. de projet

dwg. no. **D-5055-R2** dessin no.