


GENERAL NOTES

1. GENERAL CONTRACTOR TO ALLOW FOR A CERTIFIED MANUFACTURERS TECHNICIAN TO COME ON SITE AND PROGRAM ALL NETWORKABLE LUMINAIRES, CONTROLLERS ETC. MODIFIED BY THESE RENOVATIONS FOR A FULLY FUNCTIONAL LIGHTING SYSTEM AS SHOWN. EXISTING LUMINAIRE ADDRESSES AND LOOP CONFIGURATION TO BE CONFIRMED ON SITE.
2. RELOCATED LUMINAIRES ARE TO BE CONNECTED TO EXISTING LIGHTING AND CONTROL CIRCUITS AS INDICATED WITH WIRING IN EMT SURFACE MOUNTED TO THE CONCRETE CEILING.
3. EXISTING FLOOR PLANS ARE ISSUED FOR INFORMATION AND SHOW MAJOR ITEMS ONLY. CONTRACTOR IS TO EXAMINE ALL ELECTRICAL, MECHANICAL AND ARCHITECTURAL DRAWINGS, VISIT THE SITE TO VERIFY EXISTING EQUIPMENT AND CONDITIONS AND SCOPE OF WORK PRIOR TO SUBMITTING A TENDER PRICE. EXTRAS WILL NOT BE CONSIDERED BECAUSE ACTUAL CONDITIONS DIFFER FROM DRAWINGS AND ALL COSTS RELATED TO EXISTING SITE CONDITIONS MUST BE INCLUDED IN TENDER PRICE.
4. BRANCH CIRCUIT WIRING TO BE SIZED FOR A MAXIMUM VOLTAGE DROP OF 3% IN ACCORDANCE WITH THE OEC.
5. OCCUPANCY SENSOR PATTERNS AND SENSITIVITIES ARE TO BE ADJUSTED TO BEST SUIT THE ASSOCIATED SPACE AND ELIMINATE NUISANCE SWITCH ON/OFF OF LUMINAIRES.
6. ELECTRICAL PANEL 'EL3' IS LOCATED IN THE ELECTRICAL ROOM ON THE THIRD FLOOR ADJACENT TO STAIR 3.
7. ALL EXPOSED CONDUIT IS TO BE PAINTED TO MATCH COLOR OF ADJACENT SURFACE.
8. COORDINATE DRILLING INTO EXISTING CONCRETE CEILING WITH GENERAL CONTRACTOR TO ENSURE EXISTING RADIANT HEATING SYSTEMS ARE NOT DAMAGED.

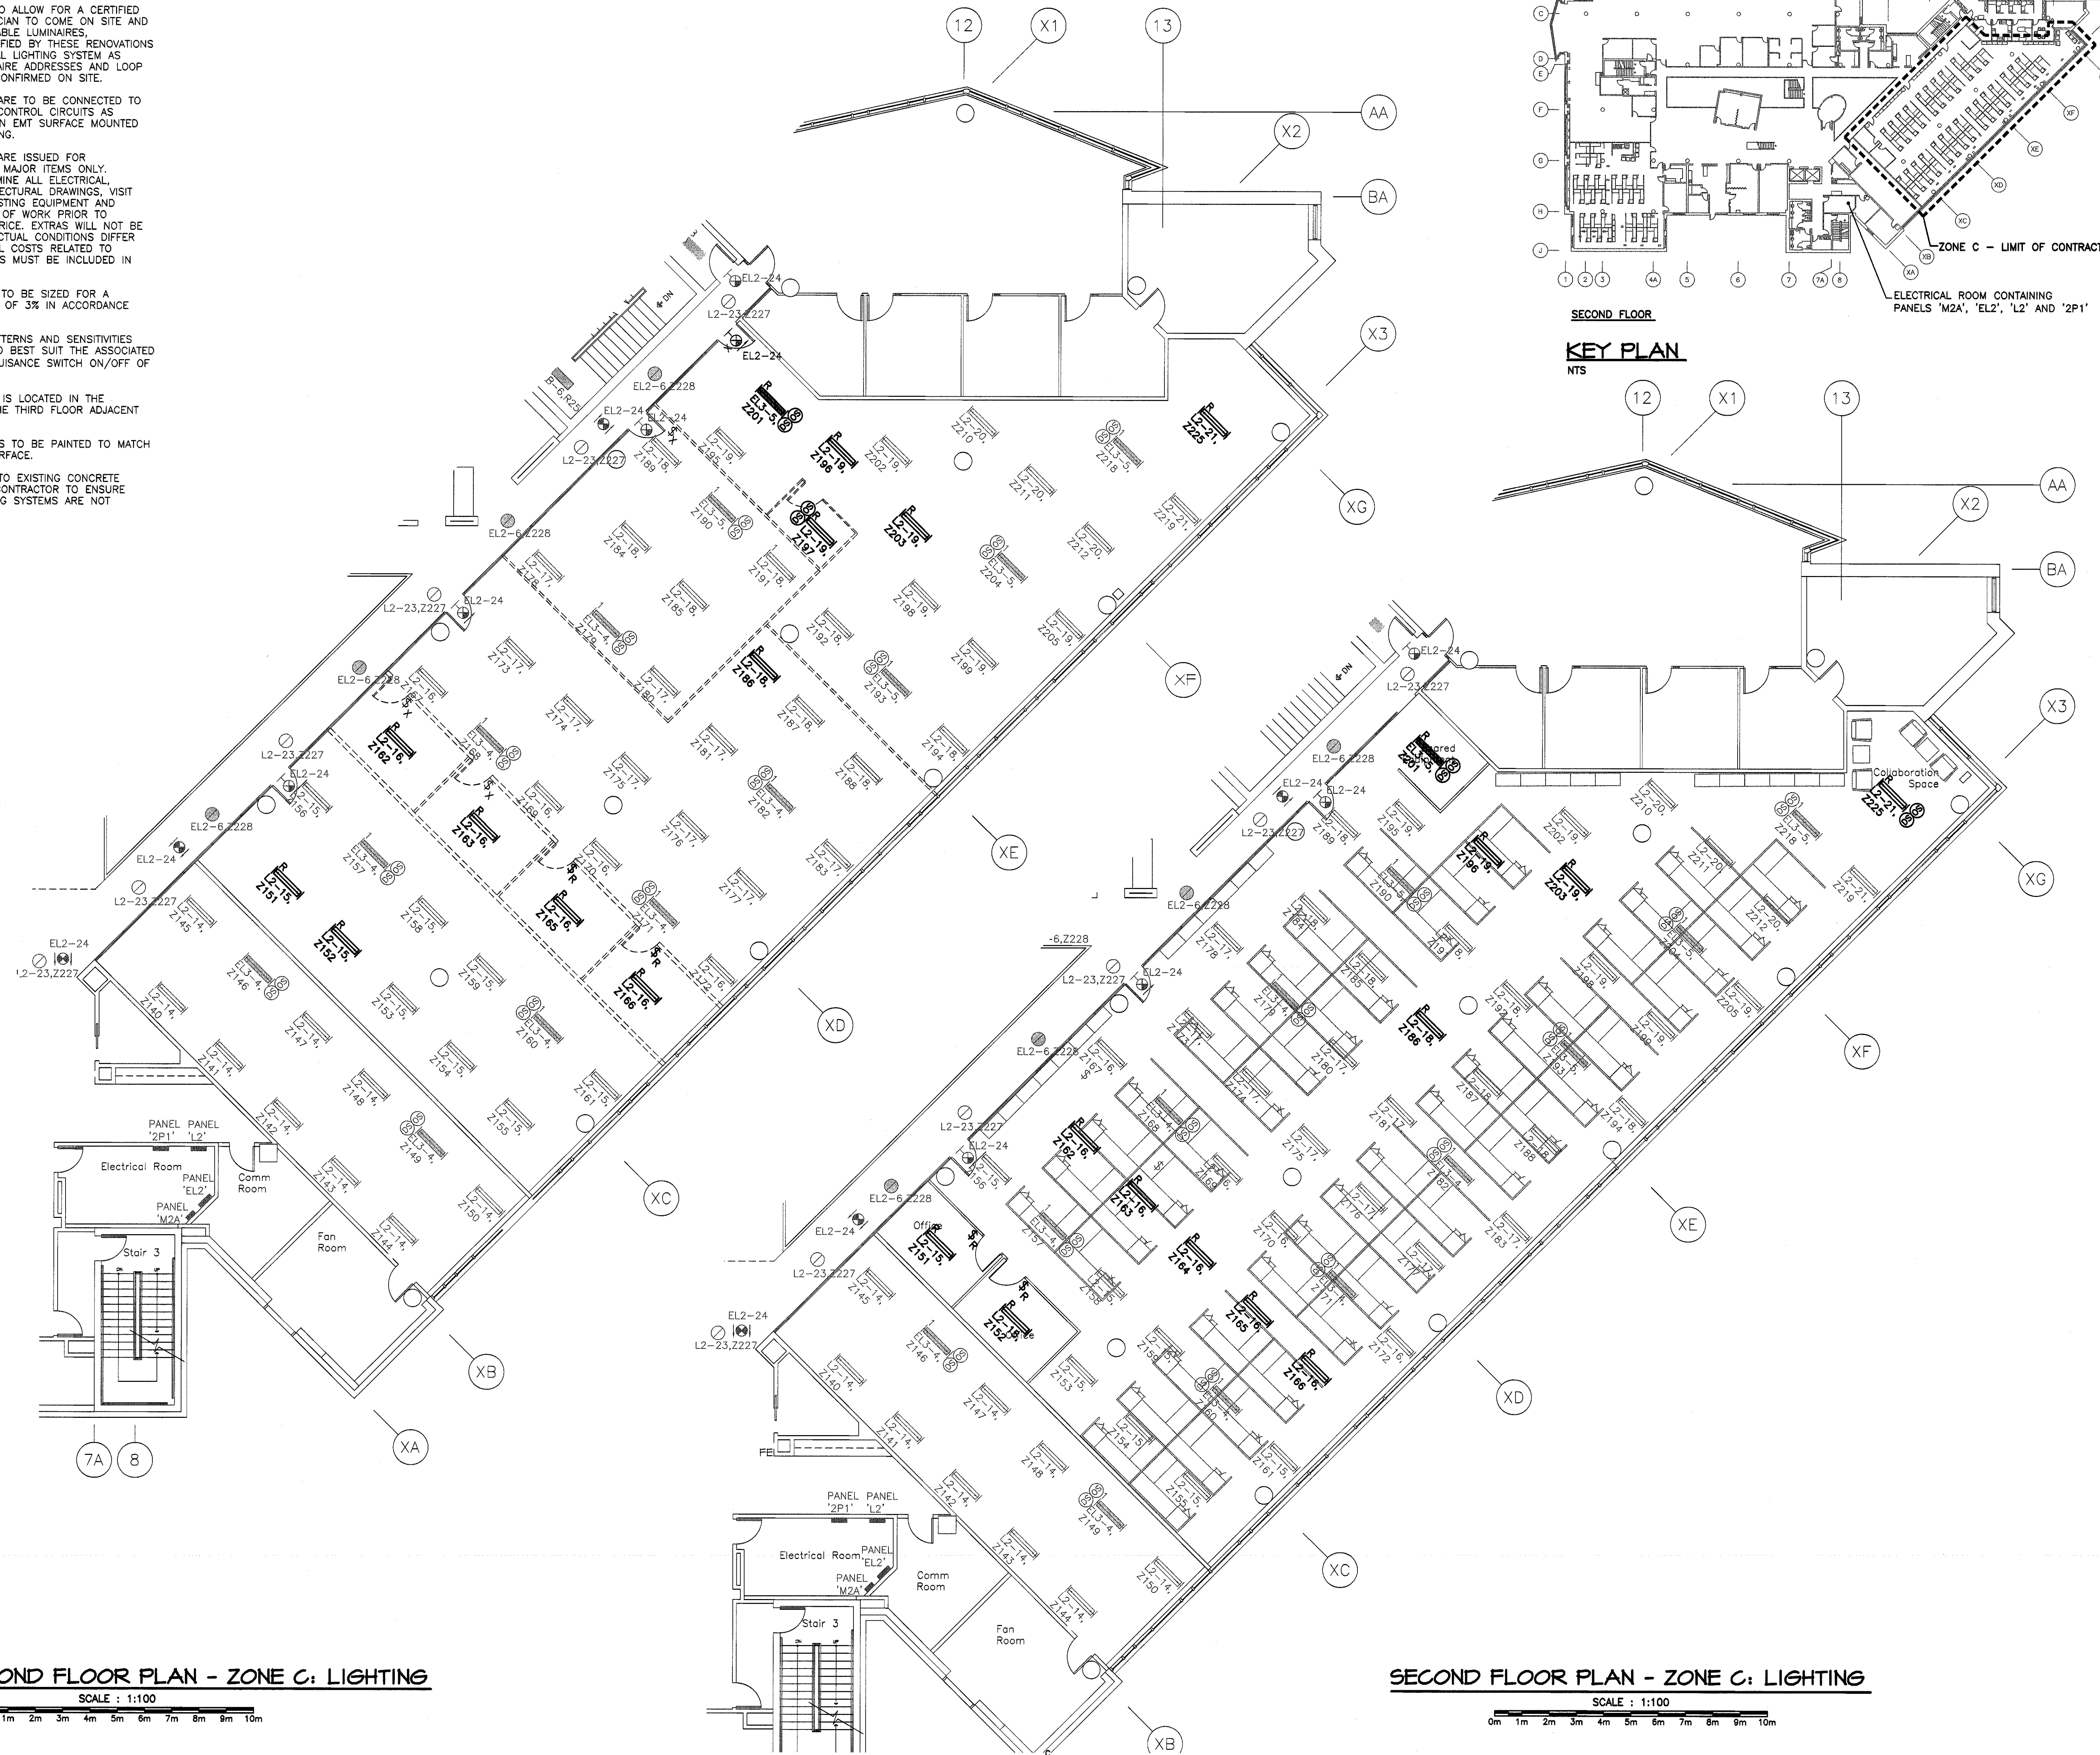

DEMOLITION SECOND FLOOR PLAN - ZONE C: LIGHTING


SCALE : 1:100

0m 1m 2m 3m 4m 5m 6m 7m 8m 9m 10m

SECOND FLOOR PLAN - ZONE C: LIGHTING

SCALE : 1:100

0m 1m 2m 3m 4m 5m 6m 7m 8m 9m 10m

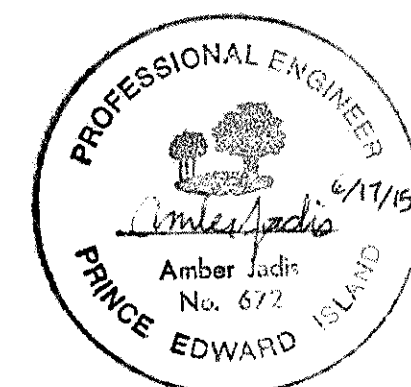

0	ISSUED FOR TENDER	June/17/2015
revisions		date

ESDC CONSOLIDATION
FIT-UP
JEAN CANFIELD
BUILDING
CHARLOTTETOWN, PEI

SECOND FLOOR PLAN
ZONE C
ELECTRICAL
LIGHTING

designed	E.S.C. P.ENG / A.D.J., P.ENG	conçu
date	2015-03-04	
drawn	M.E.M., C.E.T.	dessiné
date	2015-03-04	
approved		approuvé
date		
Tender		Soumission
Project Manager	Administrateur de projets TPSGC	
project number	R.061033.001	no. du projet
drawing no.	E4 OF 4	no. du dessin