



- NOTES:
1. EXTERIOR LIGHTING TO BE CONTROLLED VIA THE LIGHTING CONTROL SYSTEM'S INTERNAL ASTRONOMICAL TIME CLOCK.
 2. EXTERIOR LIGHTING OVERRIDE SWITCHES TO BE LOCATED HERE. PROVIDE LAMACOID CLEARLY IDENTIFYING SWITCH PURPOSE.
 3. L4 FIXTURES IN ROOMS 102, 102A AND 102B TO BE SUSPENDED AT 3000mm A.F.F.
 4. SWITCH TO CONTROL ALL LIGHTING IN GENERAL OFFICE 102.

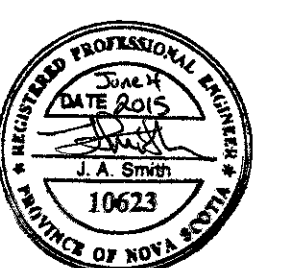

1 ISSUED FOR TENDER JUN. 4 2015
revisions date
project **ARGO BUILDING
BEDFORD INSTITUTE
OF OCEANOGRAPHY**
project
DARTMOUTH, NS

drawing design
**ELECTRICAL LIGHTING
AND LIGHTING
CONTROL**

designed JS conju
date FEBRUARY 2015
drawn RD dessin
date FEBRUARY 2015
approved approuvé
date
Tender Submission
NS PWGSC Project Manager Administrateur de projets TPSSC
project number no. du projet
R.069793.001
drawing no. no. du dessin
E102

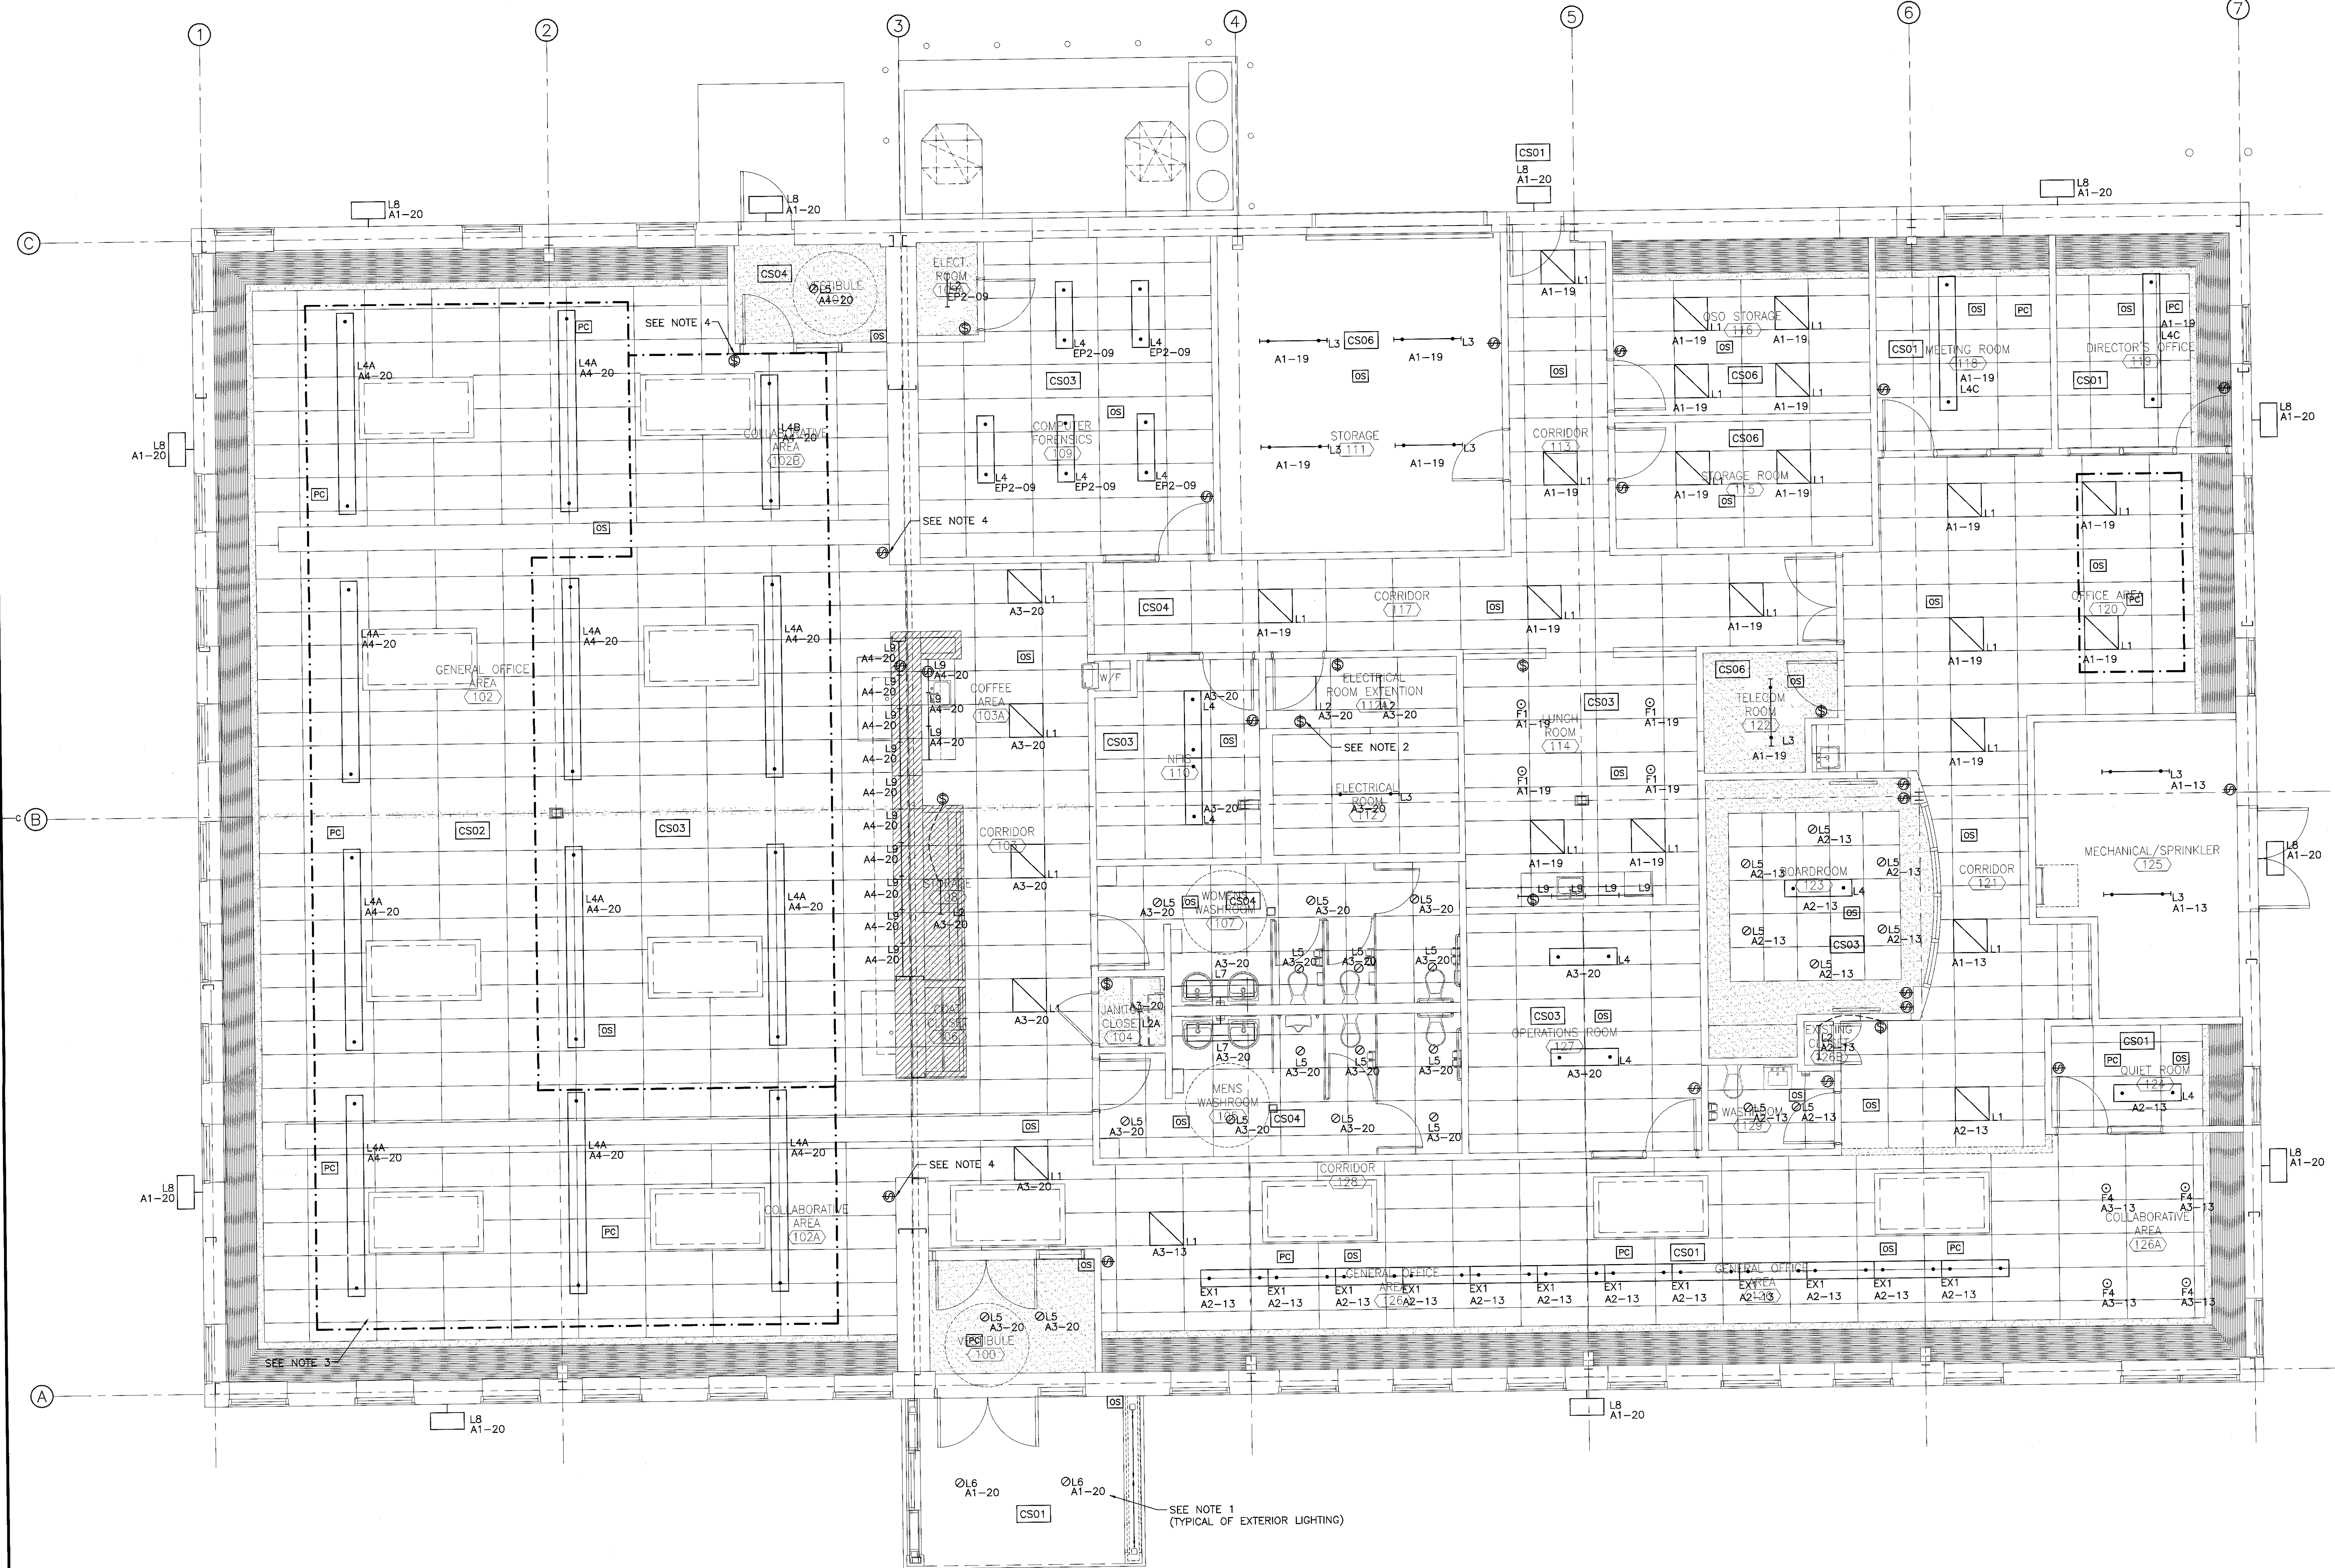

FLOOR PLAN - ELECTRICAL LIGHTING AND LIGHTING CONTROL

SCALE: 1:50
0m 1m 2m 3m 4m 5m