


- LEGEND:**
- BP# - DENOTES BASE PLATE - SEE
DETAIL 1/S4.
- C1 - DENOTES HSS102 x 102 x
6.4 COLUMN.
- F# - DENOTES FOOTING - SEE
SCHEDULE.
- P# - DENOTES PILASTER - SEE
DETAIL 1/S2.
- AR# - DENOTES ANCHOR RODS -
SEE DETAIL 2/S2.

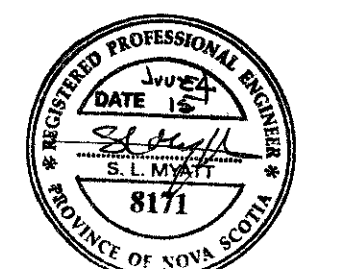

1	ISSUED FOR TENDER	JUN. 4 2015
revisions		date


project
**ARGO BUILDING
BEDFORD INSTITUTE
OF OCEANOGRAPHY**
DARTMOUTH, NS

drawing
**STRUCTURAL
ENTRANCE VESTIBULE
FOUNDATION PLANS**

designed STACEY MYATT conçu
date MARCH 2015
drawn SHANNON FRASER dessiné
date MARCH 2015
approved CHRIS RUDDICK approuvé
date MARCH 2015

Tender
PWOSC Project Manager Administrateur de projets TPSCG
project number no. du projet
R.069793.001
drawing no. no. du dessin


S2

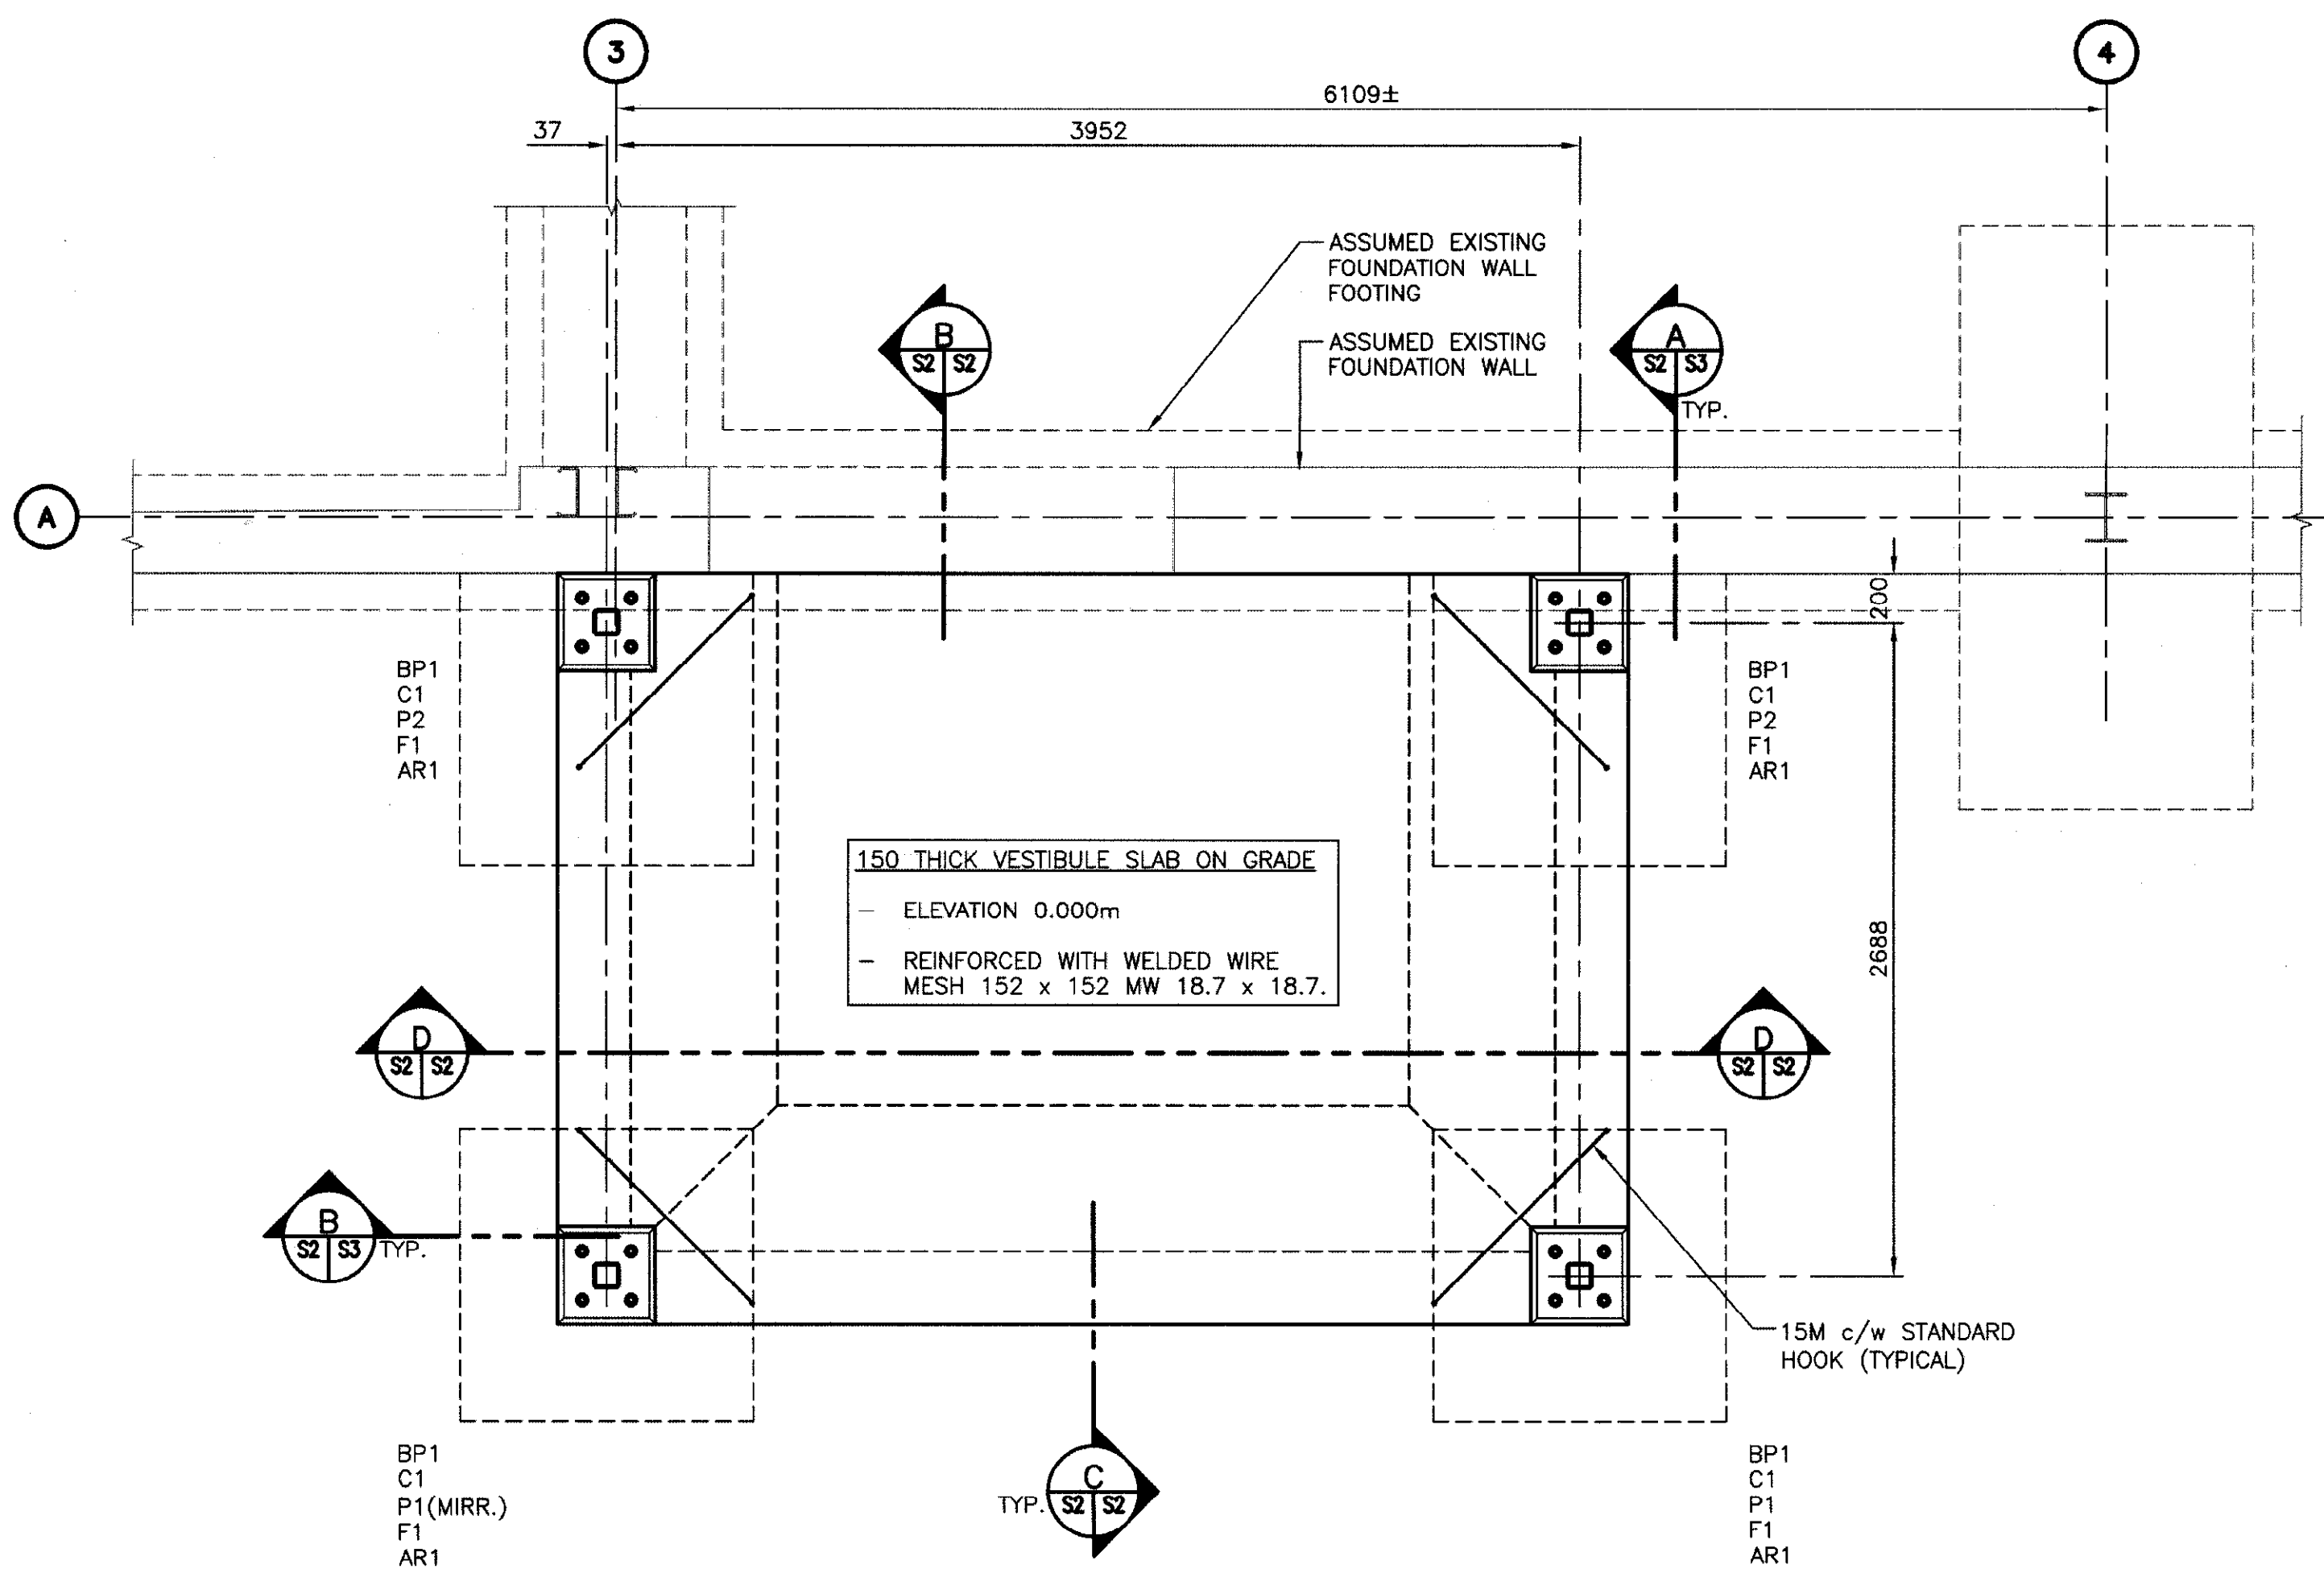

PLAN DETAIL - WEST VESTIBULE FOUNDATIONS

SCALE: 1:25


0mm 500mm 1000mm 1500mm 2000mm 2500mm

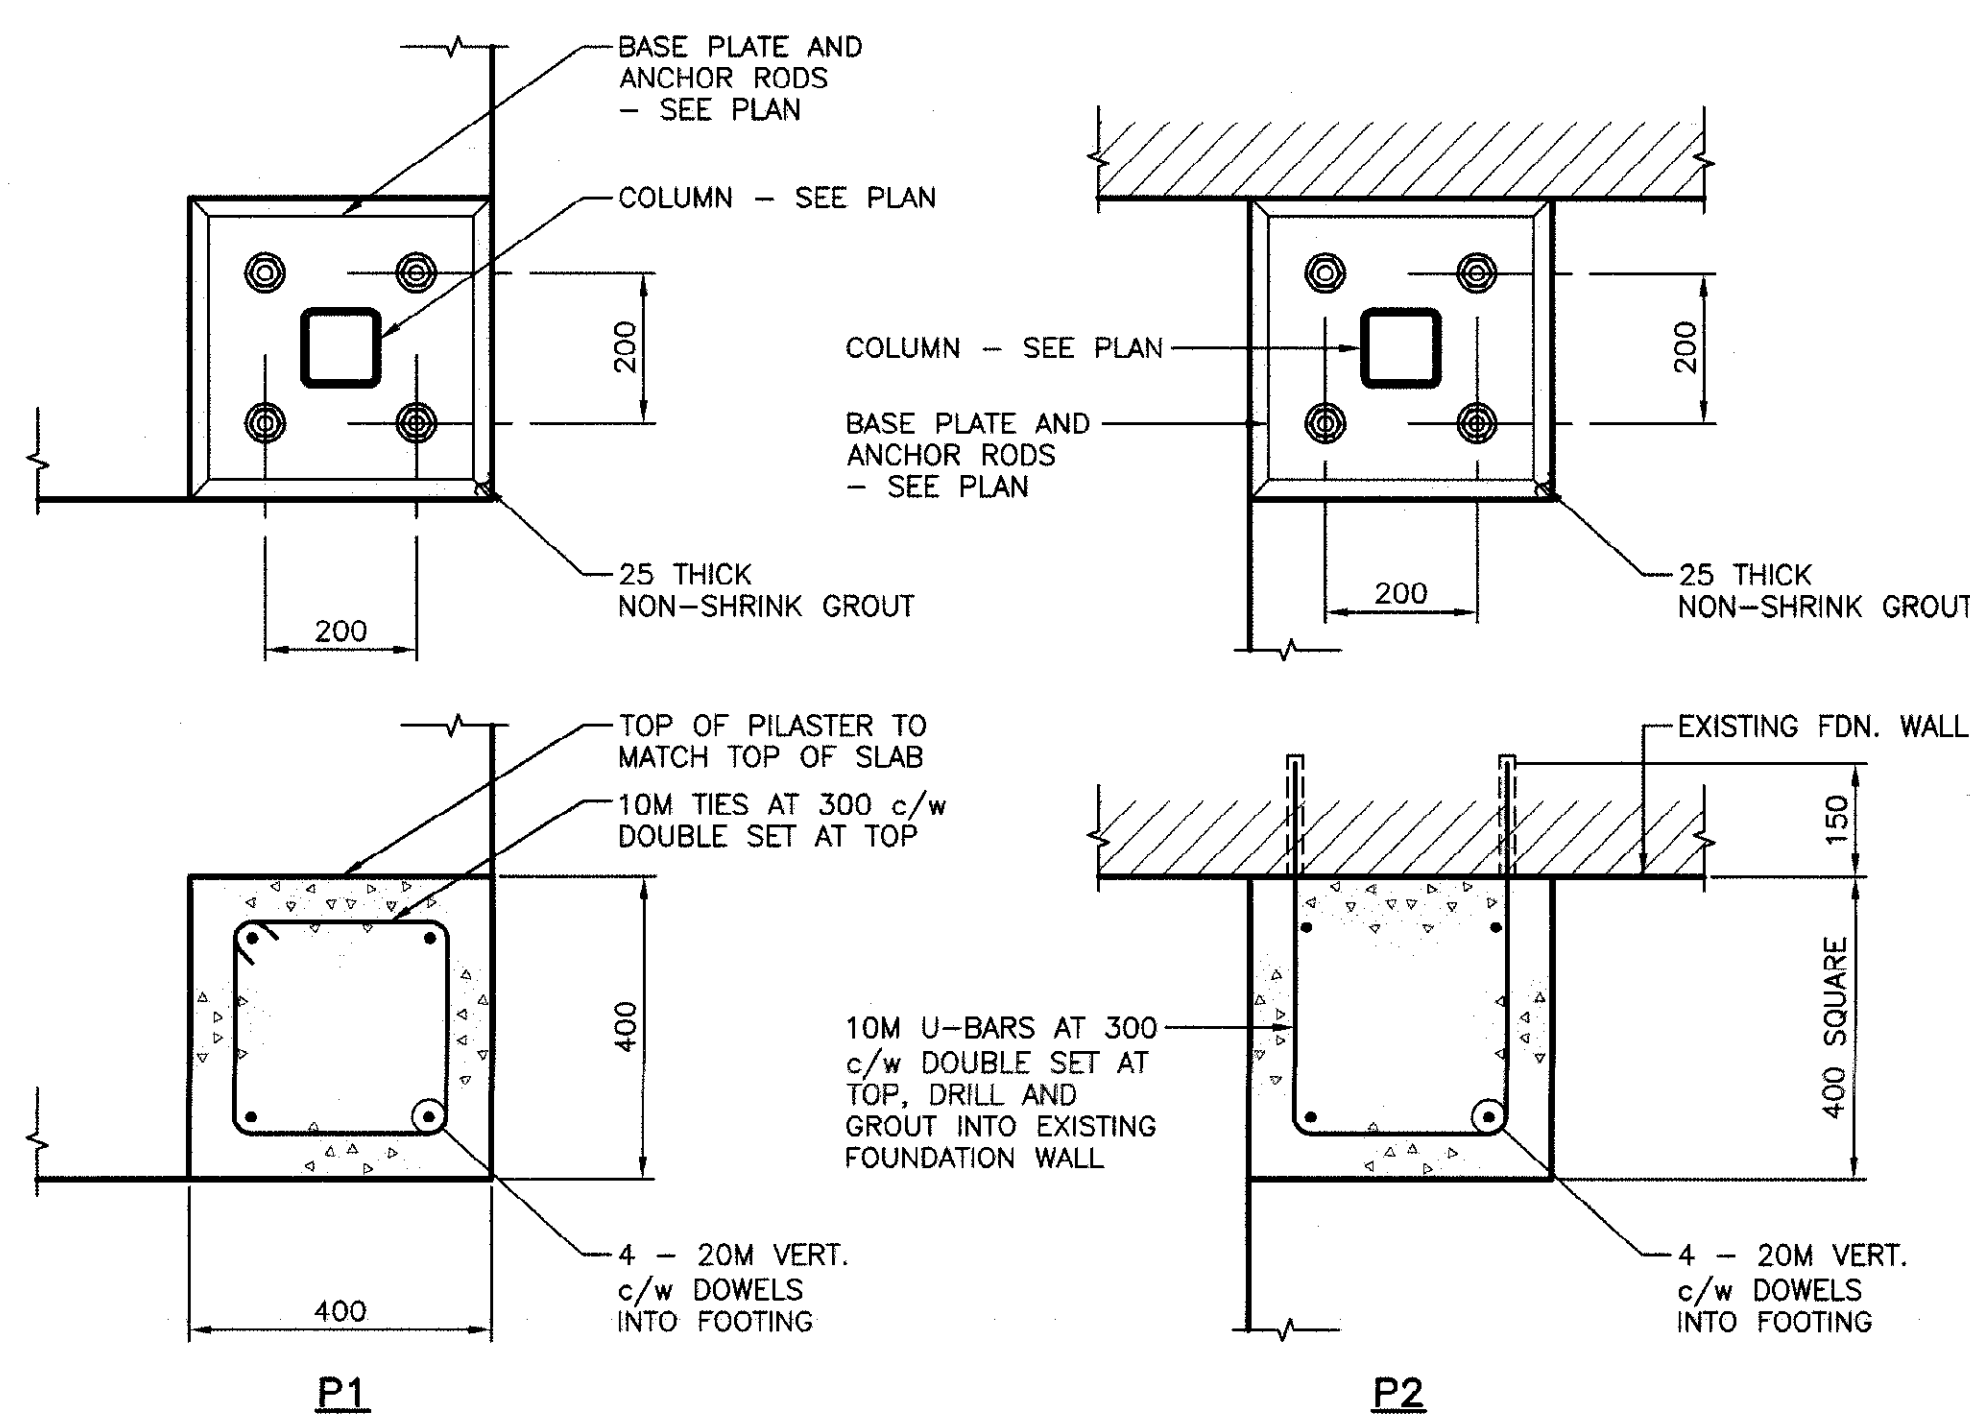

DETAIL - TYPICAL PILASTERS

SCALE: 1:10


0mm 100 200 300 400 500 600 700 800 900 1000mm

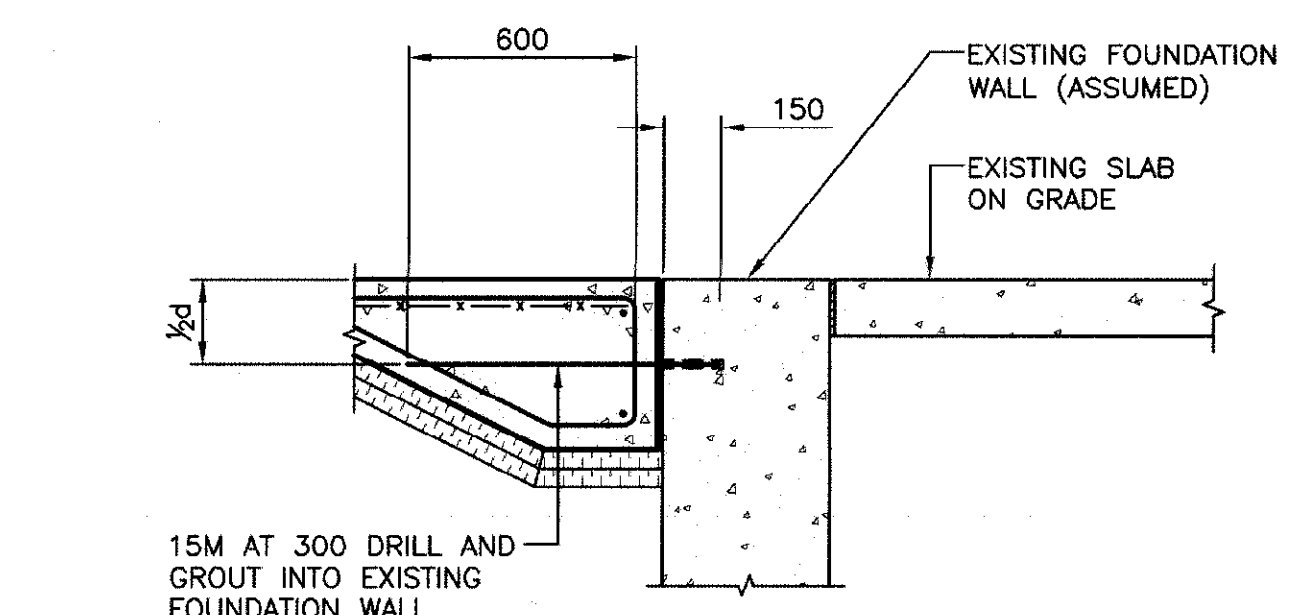

SECTION - SLAB CONNECTION AT DOOR A

SCALE: 1:20


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SECTION - SLAB CONNECTION AT DOOR B

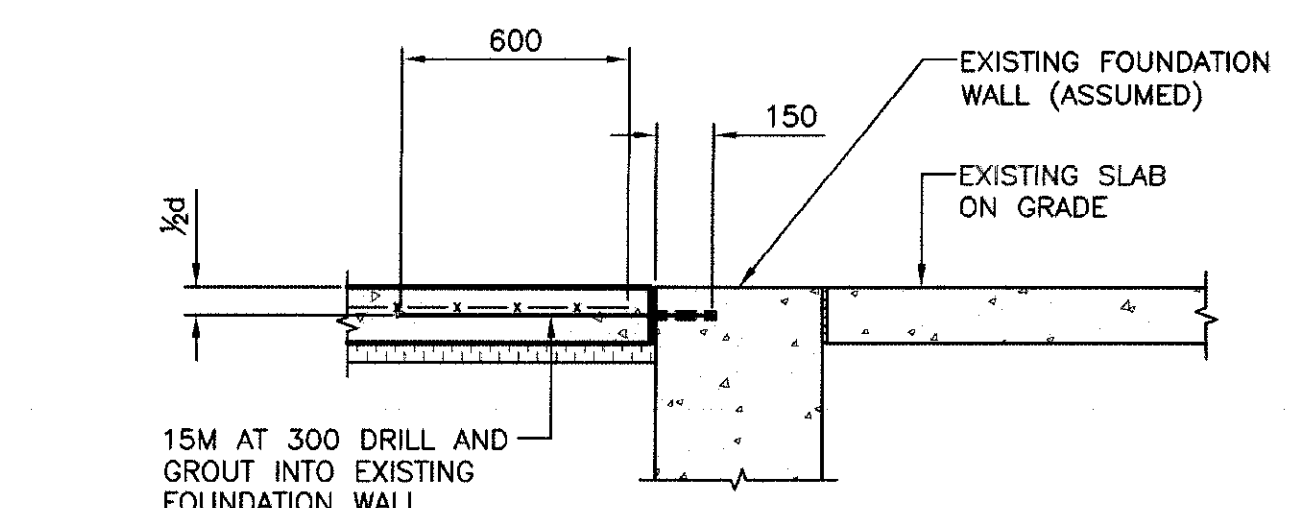SCALE: 1:20


0mm 500mm 1000mm 1500mm 2000mm 2500mm



DETAIL - TYPICAL ANCHOR RODS

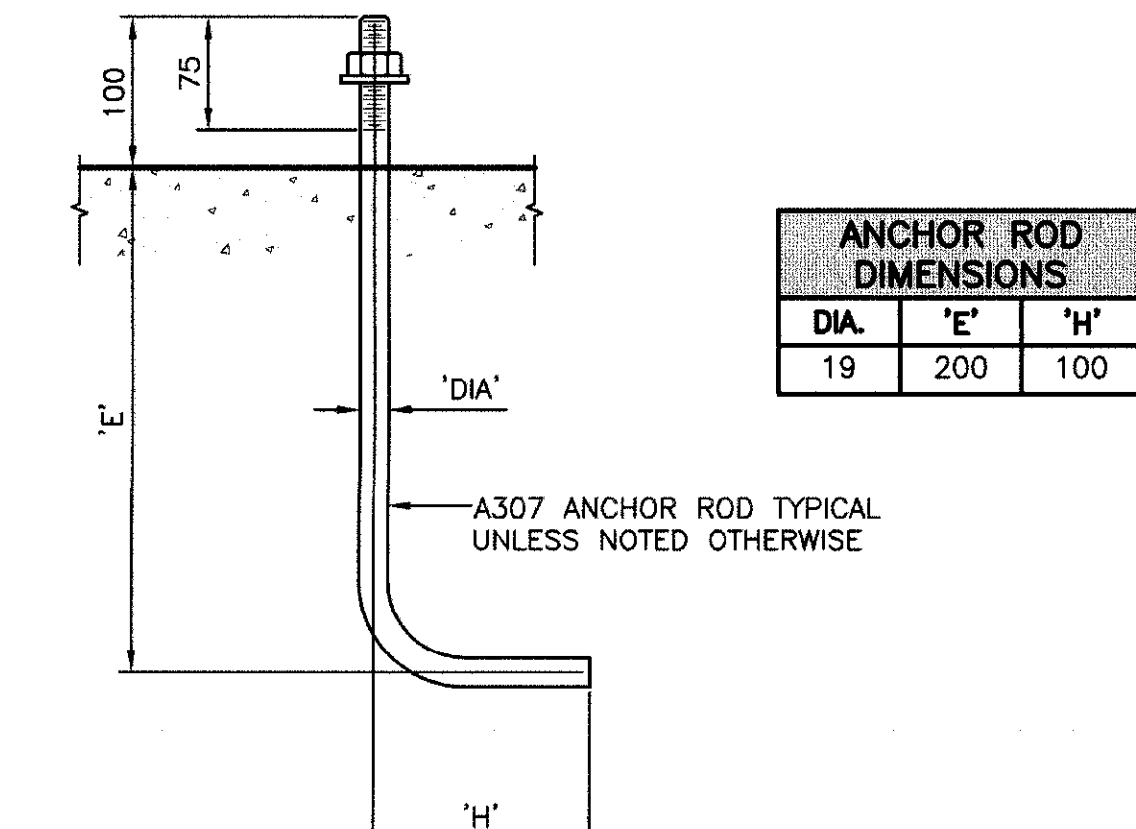SCALE: N.T.S.


ANCHOR ROD DIMENSIONS		
DIA	'E'	'H'
19	200	100

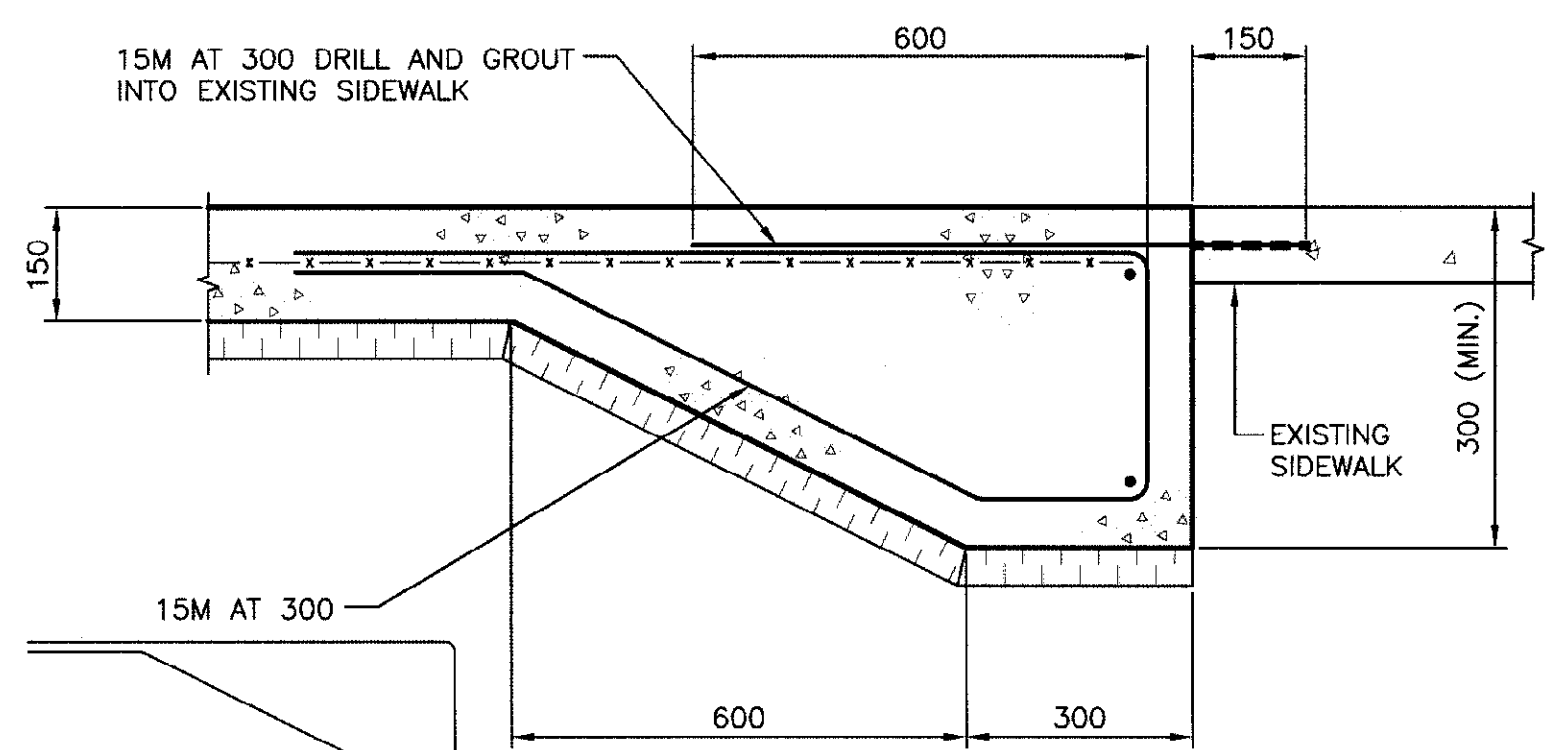

SECTION - PERIMETER SLAB THICKENING

SCALE: 1:10

0mm 100 200 300 400 500 600 700 800 900 1000mm

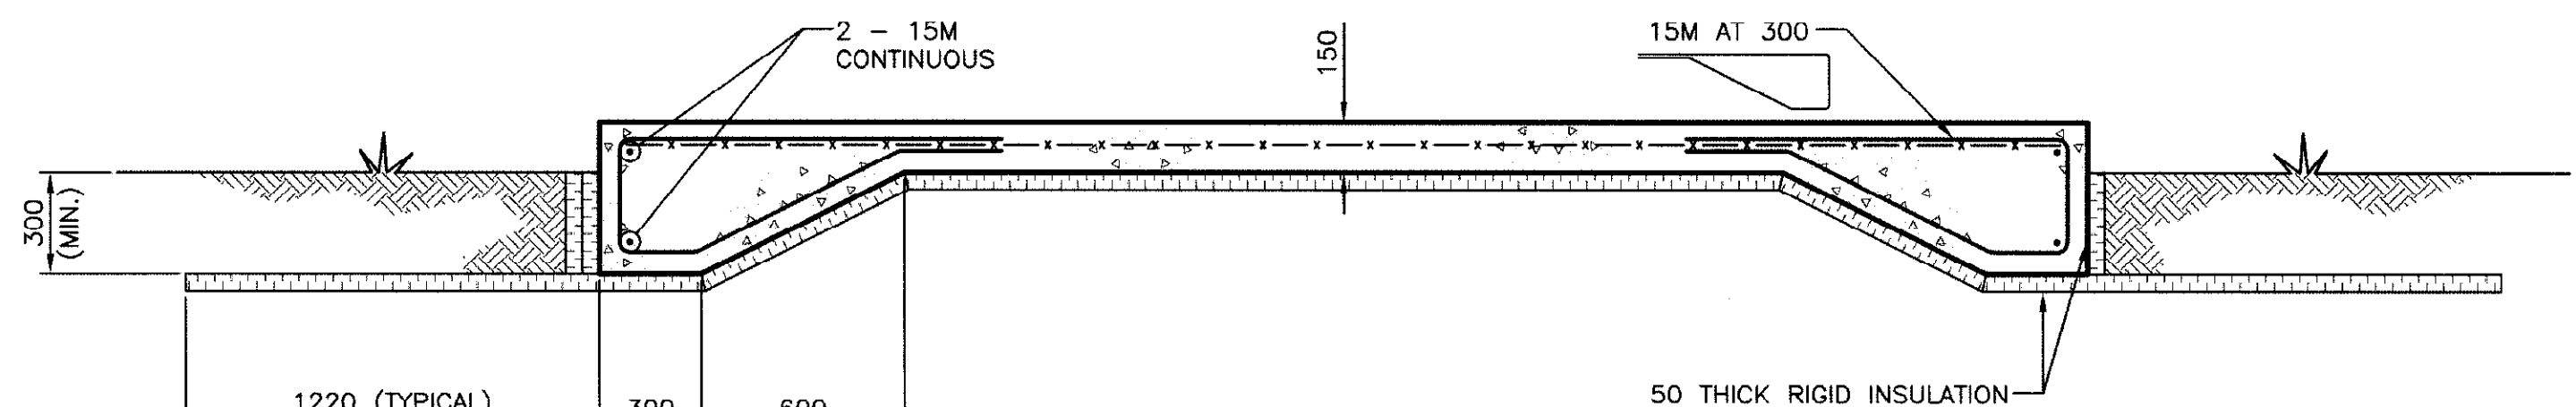

SECTION - LONGITUDINAL CROSS SECTION

SCALE: 1:20

0mm 500mm 1000mm 1500mm 2000mm 2500mm

FOOTING SCHEDULE		
DESIGNATION	SIZE	REINFORCING
F1	1200 x 1200 x 250 DEEP	4 - 15M EACH WAY TOP AND BOT.