



INDIAN HEAD AAFC
B017 ADDITION
INDIAN HEAD, SK

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Issue Record:
YY.MM.DD/Issued For/Issued To/Issued By

Revisions:
R# Brief Description/YY.MM.DD/Revised By

BUILDING ELEVATIONS
& SECTIONS

Designed By: CAL Scale: AS INDICATED

Drawn By: JS/ST/DN Date: MARCH 2013

Checked By: CAL Date: -

Project No.: 4796

A3.1

Revision No.: R# Date: YYYY.MM.DD

Issued For: -

Date Issued: YYYY.MM.DD

Date Plotted: 2015.06.15

WALL ASSEMBLIES

- E-1 EXTERIOR WALL
FR: N/A STC: N/A
• PRE-FINISHED LIGHT GAUGE METAL WALL CLADDING SYSTEM, COLOR SELECTION BY OWNER (MATCH EXISTING).
• WALL GIRTS @ MIN 48" O.C. (VERIFY)
• R-28 SEMI RIGID BATT INSULATION
• 6 mil POLY VAPOUR BARRIER
• PREFINISHED METAL LINER PANEL @ INTERIOR (TYPICAL)

- E-2 EXISTING WALL
• PRE-FINISHED METAL PANELS @ EXTERIOR
• WALL GIRTS (VERIFY SPACING)
• BATT INSULATION
• 6 mil POLY VAPOUR BARRIER
• INTERIOR LINER PANELS
• FURR OUT @ NEW SPACE W/ 7/8" HAT CHANNELS & PREFIN METAL LINER PANELS.

- P-1 INTERIOR WALL
FR: N/A STC: N/A
• METAL LINER PANEL OVER 1/2" PLYWOOD BACKING
• 2"x6" WOOD STUDS @ 16" O.C., FULL HT. (3" FLOAT) C/W ACoustICAL INSULATION
• 1/2" GWB (USE MOISTURE RESISTANT GWB FOR PLUMBING WALLS) OR METAL LINER PANEL, AS PER FINISH NOTES.

FLOOR ASSEMBLIES

- F1 APRON SLAB @ GARAGE/SIDEWALK/CONC PAD
• 7" CONCRETE SLAB ON GRADE
• INTEGRATED HARDENER. (SEE STRUCTURAL FOR REINF)
• 6 mil POLY VAPOUR BARRIER
• MIN. 12" COMPACTED GRANULAR FILL
• NON-SKID SURFACE ON SIDEWALK AND CONC PAD.

- F1a SLAB @ ENTRY
• 5" CONCRETE SLAB ON GRADE
• INTEGRATED HARDENER. (SEE STRUCTURAL FOR REINF)
• MIN. 12" COMPACTED GRANULAR FILL
• NON-SKID SURFACE.

- F2 MEZZANINE FLOOR
• 3/4" T&G PLYWOOD SUB FLOOR
• 2"x8" WOOD JOIST
• FINISH WITH RESIN EPOXY PAINT WITH ANTI-SLIP PROVISIONS.


- F3 MEZZANINE FLOOR
• 3/4" T&G PLYWOOD SUB FLOOR
• 2"x10" WOOD JOIST
• FINISH WITH RESIN EPOXY PAINT WITH ANTI-SLIP PROVISIONS.

- F4 EXISTING FLOOR


ROOF ASSEMBLIES

- R1 ROOF OVER ADDITION
FR: N/A STC: N/A
• STANDING SEAM PRE-FINISHED METAL ROOF SYSTEM (PART OF METAL BLDG PACKAGE)
• PRE-ENGINEERED STEEL BUILDING SYSTEM, PREFINISHED
• R28 BATT INSULATION C/W VAPOUR BARRIER (PART OF METAL BLDG PACKAGE)
• 6 MIL POLY VAPOUR BARRIER
• PRE-FINISHED METAL LINER PANELS.


- R2 EXISTING ROOF

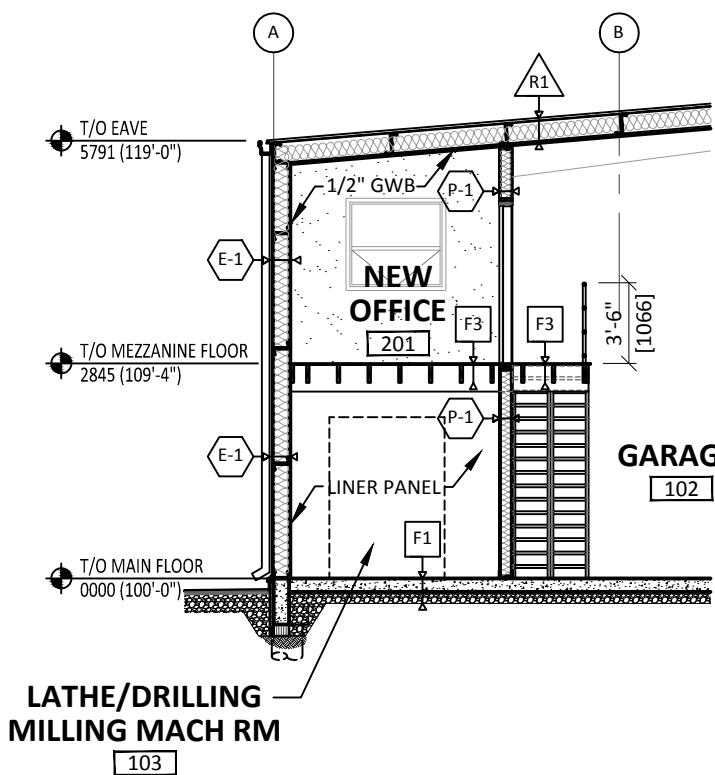


8 BUILDING SECTION
A3.1 SCALE 1:100

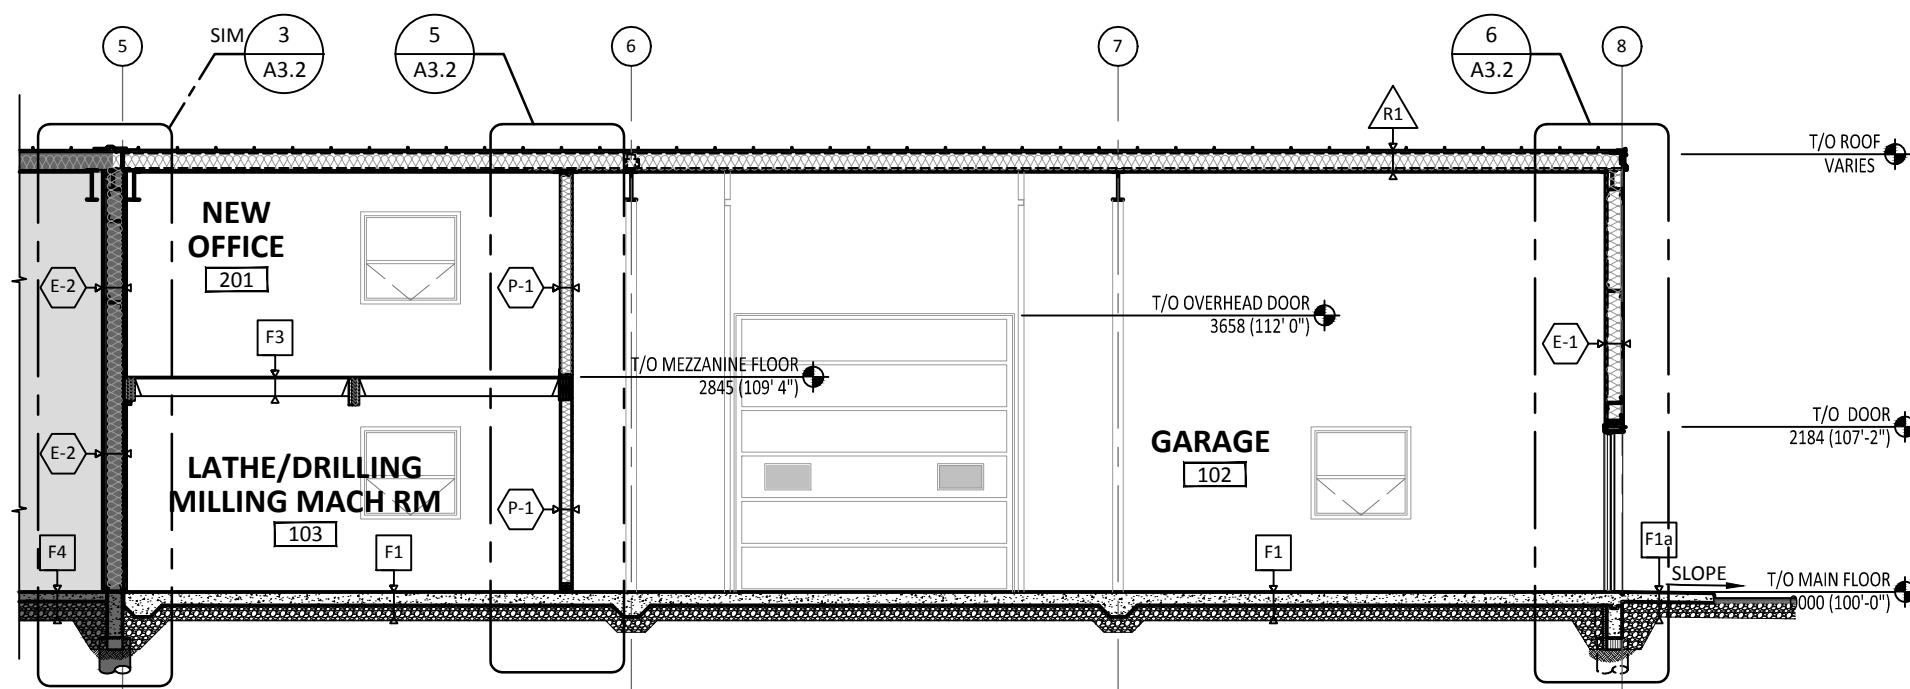


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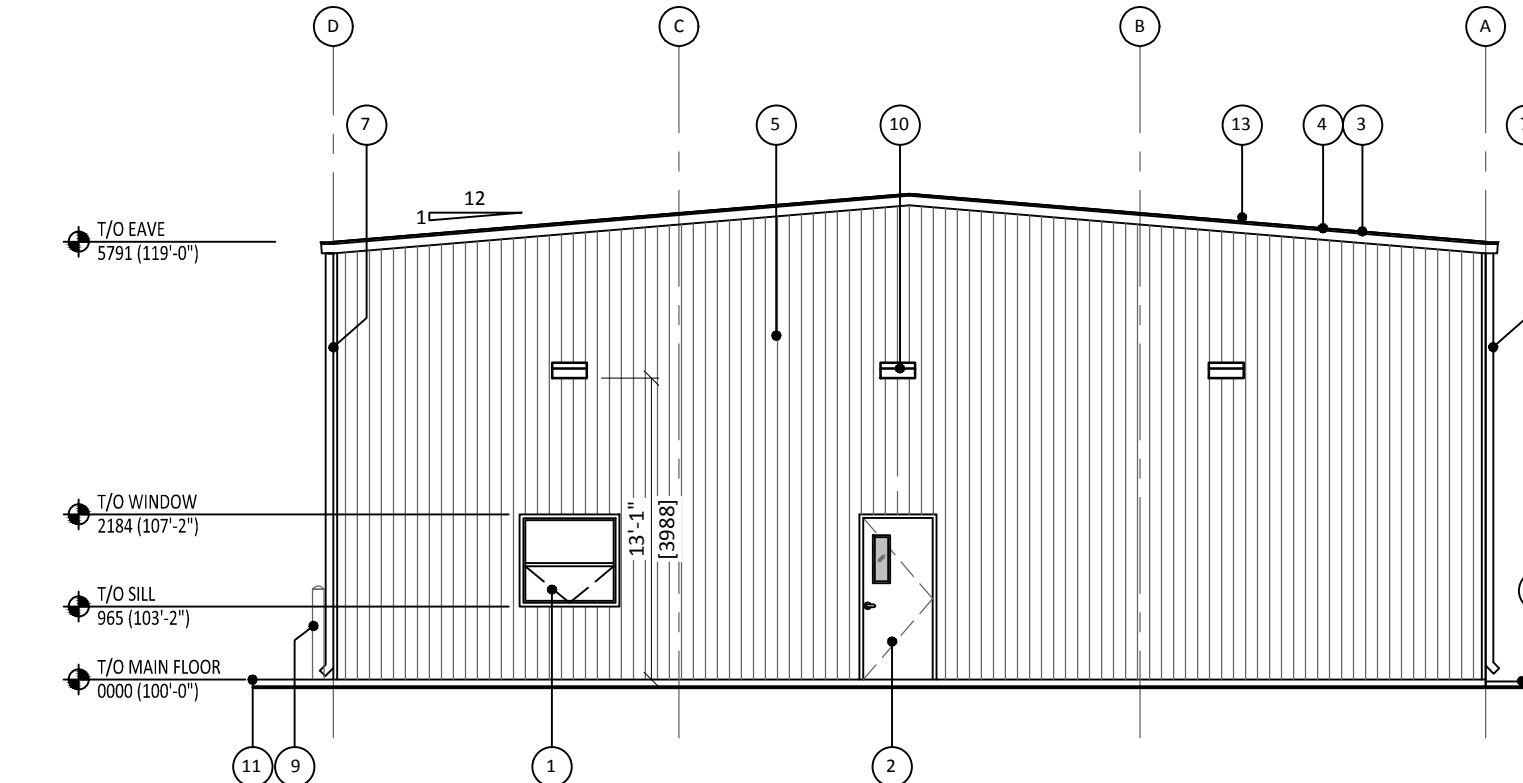
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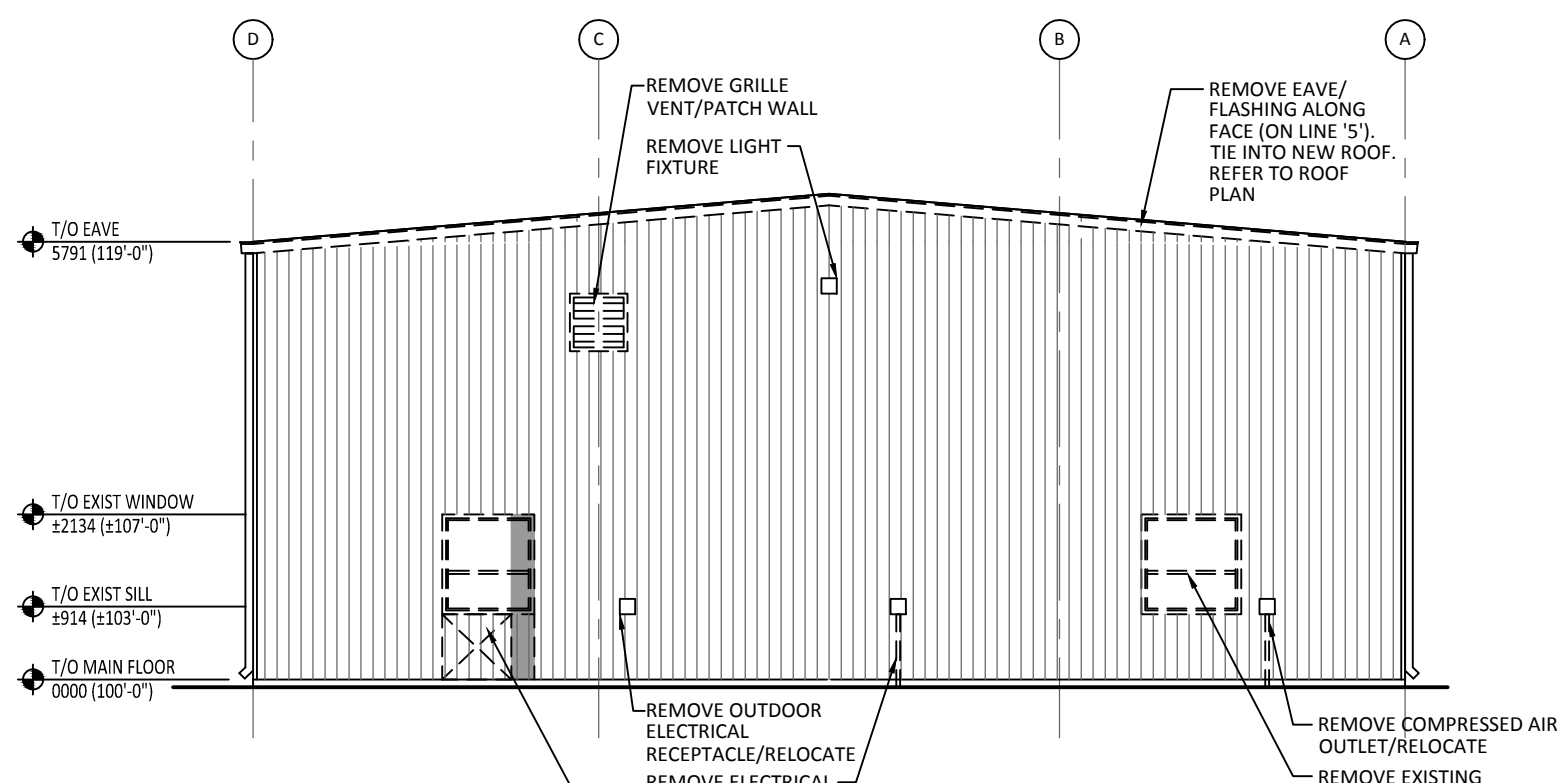
5 BUILDING SECTION
A3.1 SCALE 1:100

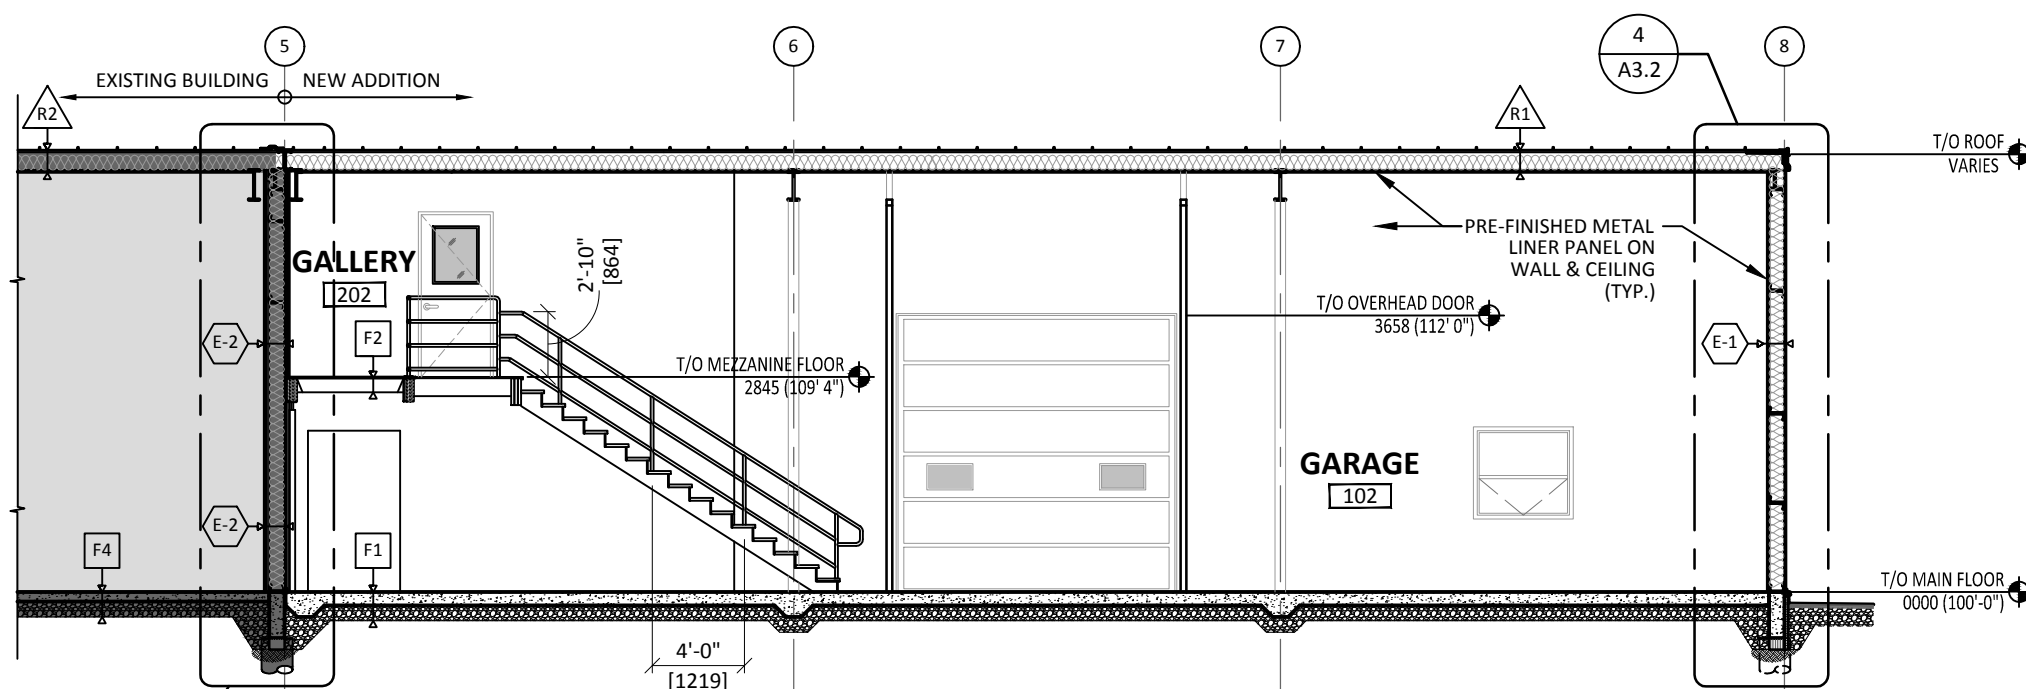


1 EAST ELEVATION
A3.1 SCALE 1:100

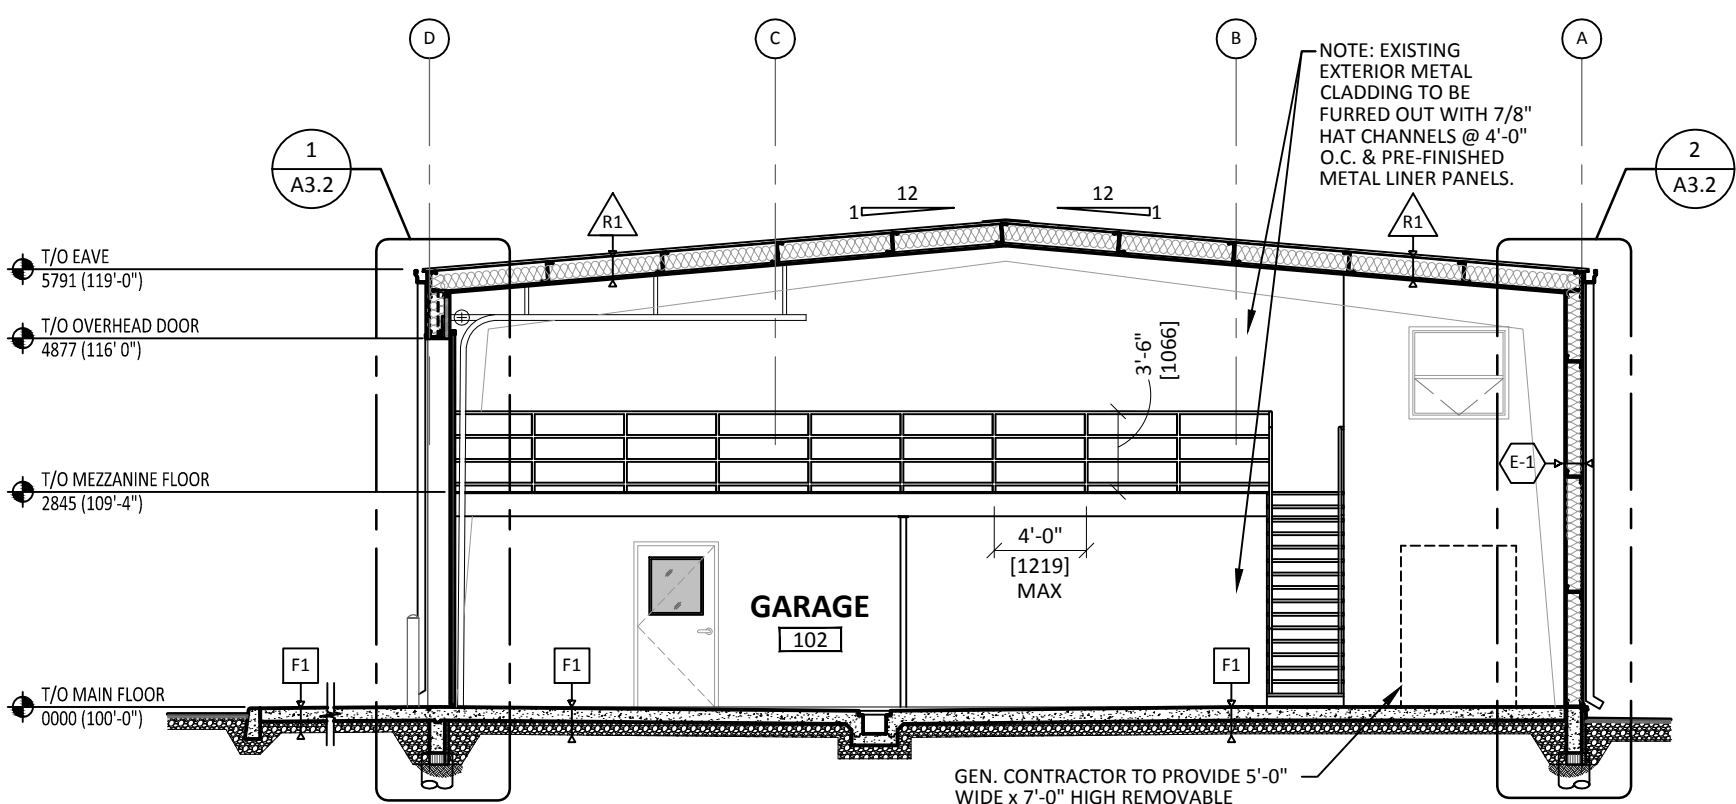

2 NORTH ELEVATION
A3.1 SCALE 1:100

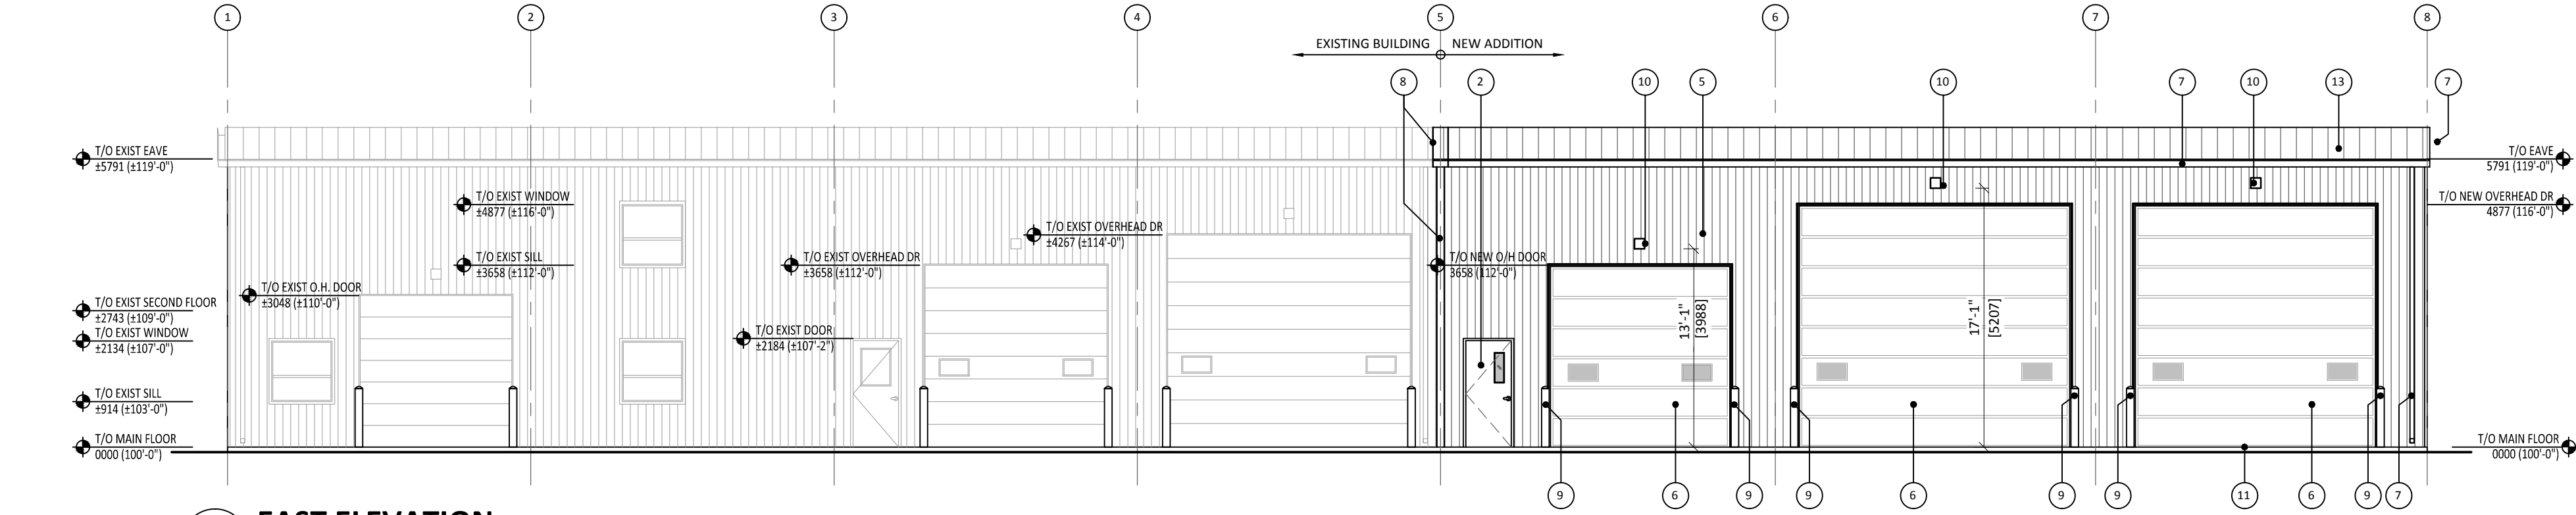

3 EXISTING/DEMO NORTH ELEVATION
A3.1 SCALE 1:100

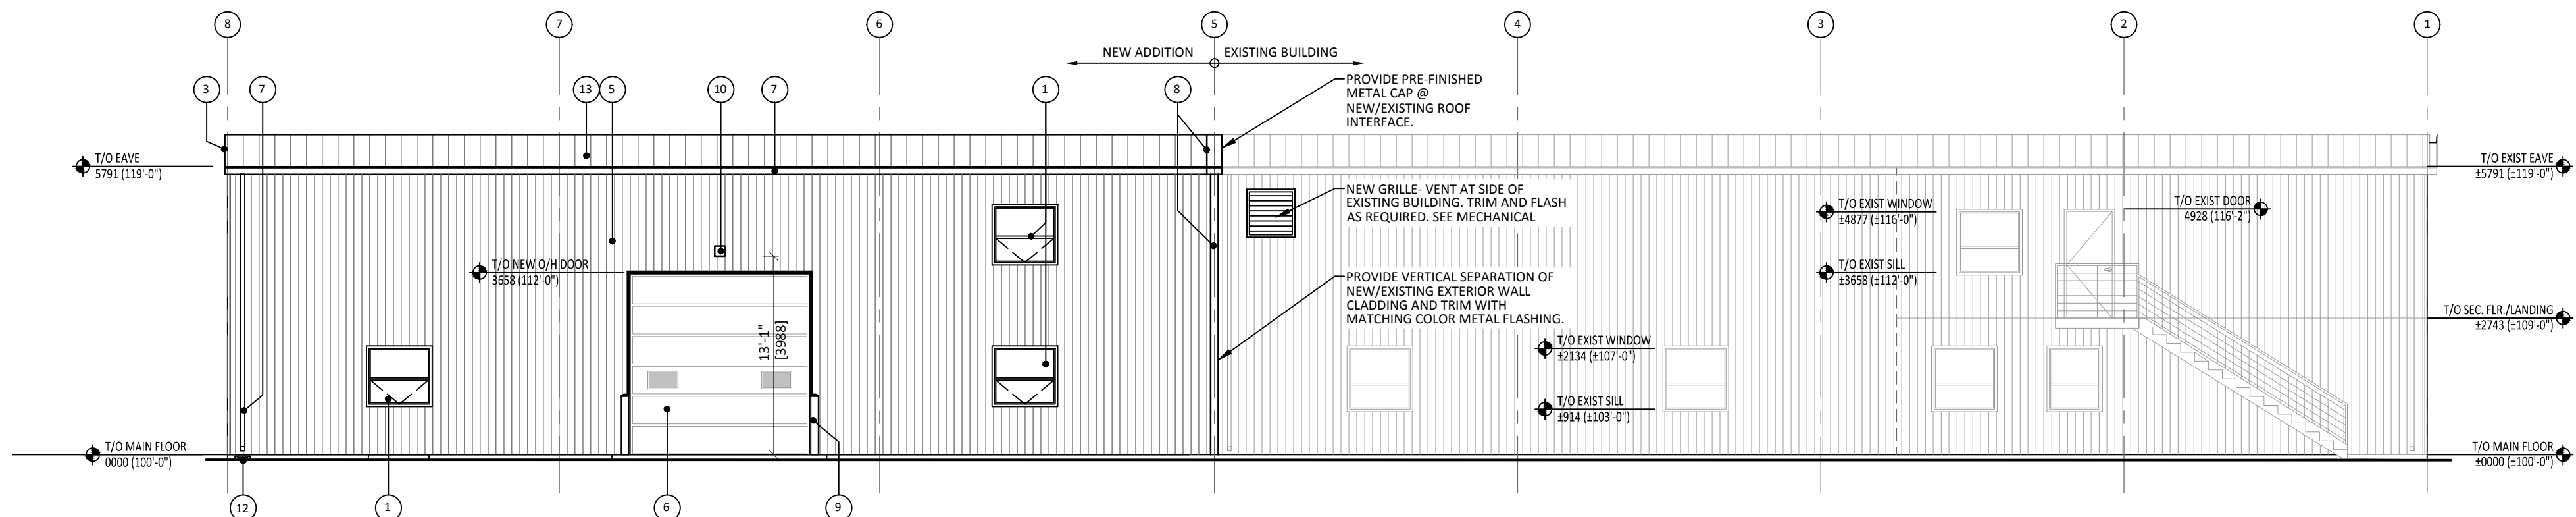

4 WEST ELEVATION
A3.1 SCALE 1:100

ELEVATIONS MATERIALS KEY	
1	PVC WINDOW, SEALED UNITS. SEE WINDOW SCHEDULE
2	INSULATED HOLLOW METAL DOOR. SEE DOOR SCHEDULE. COLOR TO MATCH CLADDING
3	PRE-FINISHED METAL FASCIA. COLOR TO MATCH EXISTING
4	PRE-FINISHED METAL DRIP EDGE FLASHING. COLOR TO MATCH CLADDING
5	PRE-FINISHED METAL CLADDING (BY BUILDING SUPPLIER) TO MATCH EXISTING WALL CLADDING
6	OVERHEAD INSULATED STEEL DOOR BY BUILDING SUPPLIER (SEE DOOR SCHEDULE)
7	HORIZONTAL PRE-FINISHED METAL GUTTER & DOWNSPOUT SYSTEM BY (BUILDING SUPPLIER) C/W EXTENSIONS
8	PRE-FIN METAL CAP & WALL TRIM @ NEW/EXISTING ROOF & WALL CLADDING INTERFACE.
9	STEEL/ CONCRETE BOLLARDS DETAIL 5/A2.2
10	LIGHT FIXTURE (SEE ELEC. DRAWING)
11	CONC. APRON, SLOPE 1%
12	MIN. 3" PRECAST CONCRETE SPLASH PAD
13	ROOF STANDING SEAM PRE-FINISHED METAL CLADDING TO MATCH EXISTING (SEE ROOF ASSEMBLY) (LIGHT GAUGE METAL BUILDING SYSTEM)