





KEYPLAN:

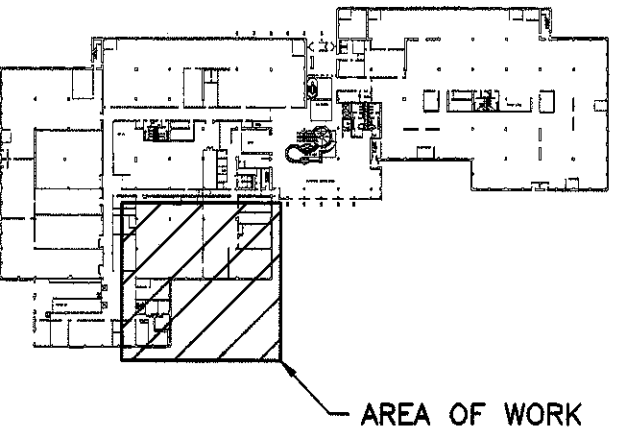

AREA OF WORK

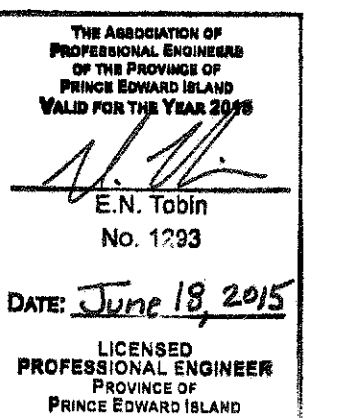

P4	ISSUED FOR TENDER	JUN 18 2015
P3	ISSUED FOR 100% REVIEW	MAY 4 2015
P2	ISSUED FOR 99% REVIEW	MAR 23 2015
P1	ISSUED FOR 66% REVIEW	FEB 12 2015
revisions		date

A	A detail no. no. du detail	A
C	B location drawing no. sur dessin no.	B C
	C drawing no. dessin no.	

project projet


**JOSEPH A GHIZ
BUILDING CHILLER PLANT
REPLACEMENT**

SUMMERSIDE, PEI


drawing dessin

**MECHANICAL
PIPING DETAILS
(NEW CONSTRUCTION)
SHEET 1 OF 2**


designed SF	conçu
date JAN, 2015	
drawn TC	dessiné
date JAN, 2015	
approved PM	approuvé
date JAN, 2015	
Tender RYAN MCGUIRE	Soumission
PWC Project Manager	Administrateur de projets TPC
project number	no. du projet
R055258.001	
drawing no.	no. du dessin
M-7	

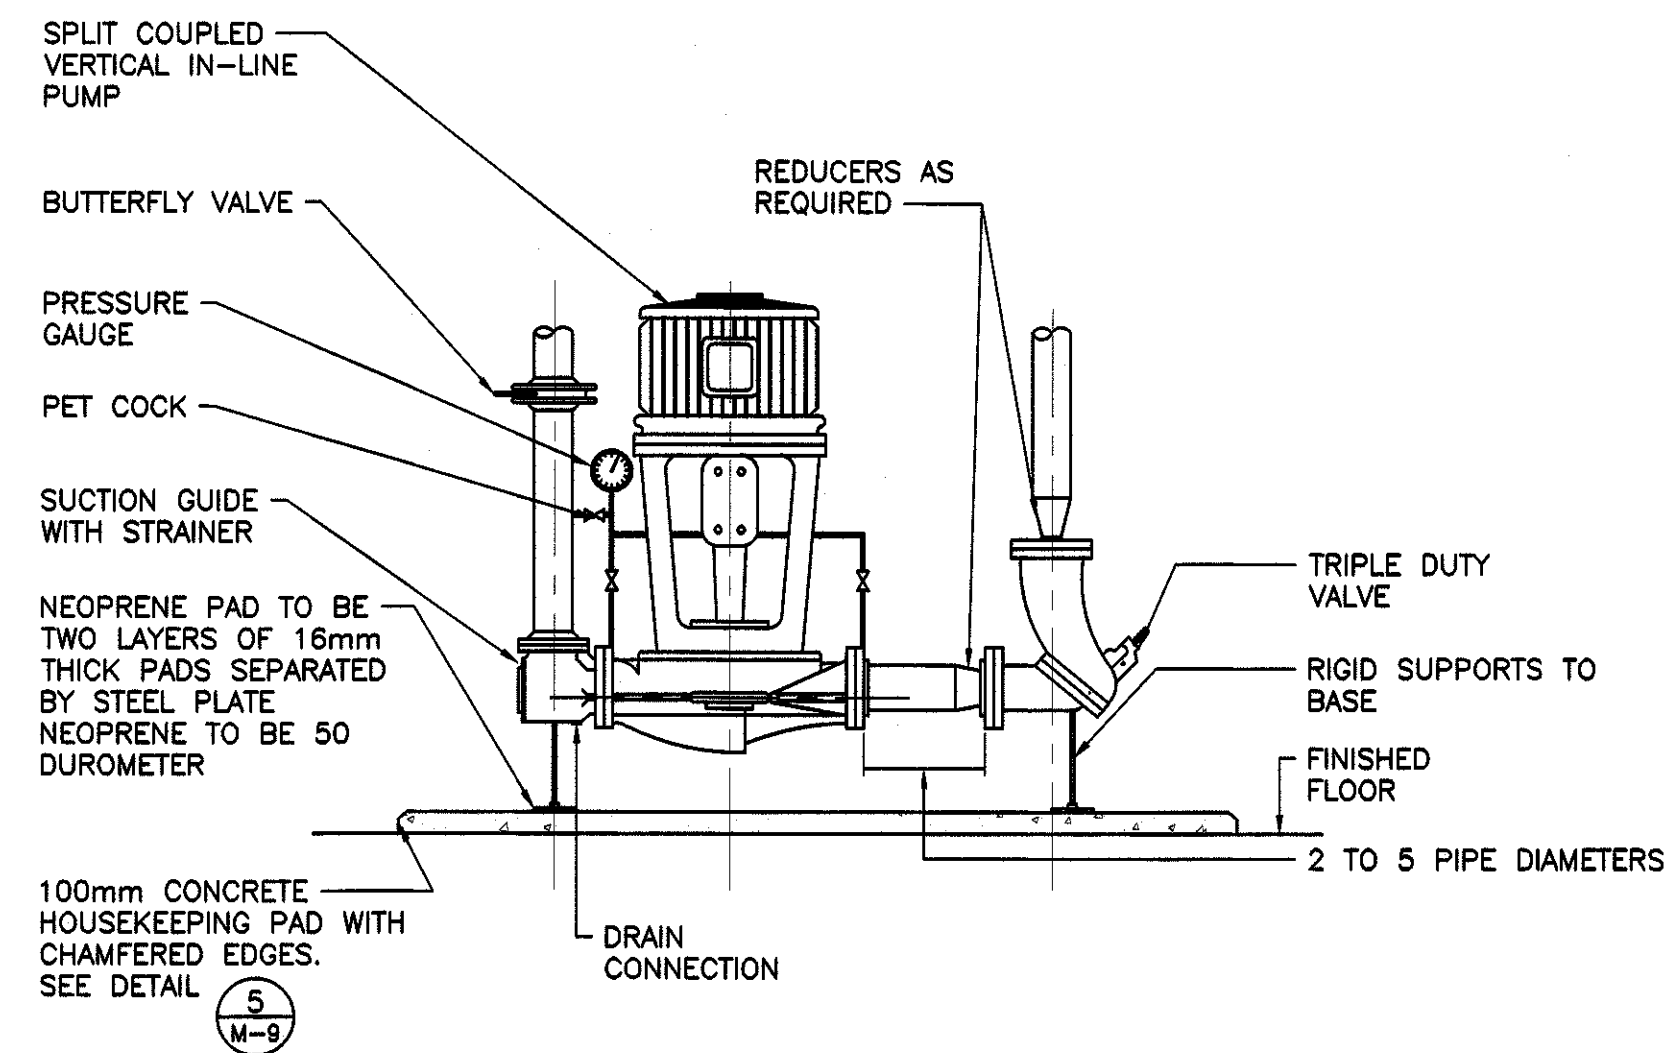


DETAIL - VERTICAL IN-LINE PUMP BASE MOUNTED
TYPICAL FOR PUMPS P-62A, P-62B, P-82, P-83, P-3, P-4, P-94, P-95, P-96
SCALE : N.T.S.

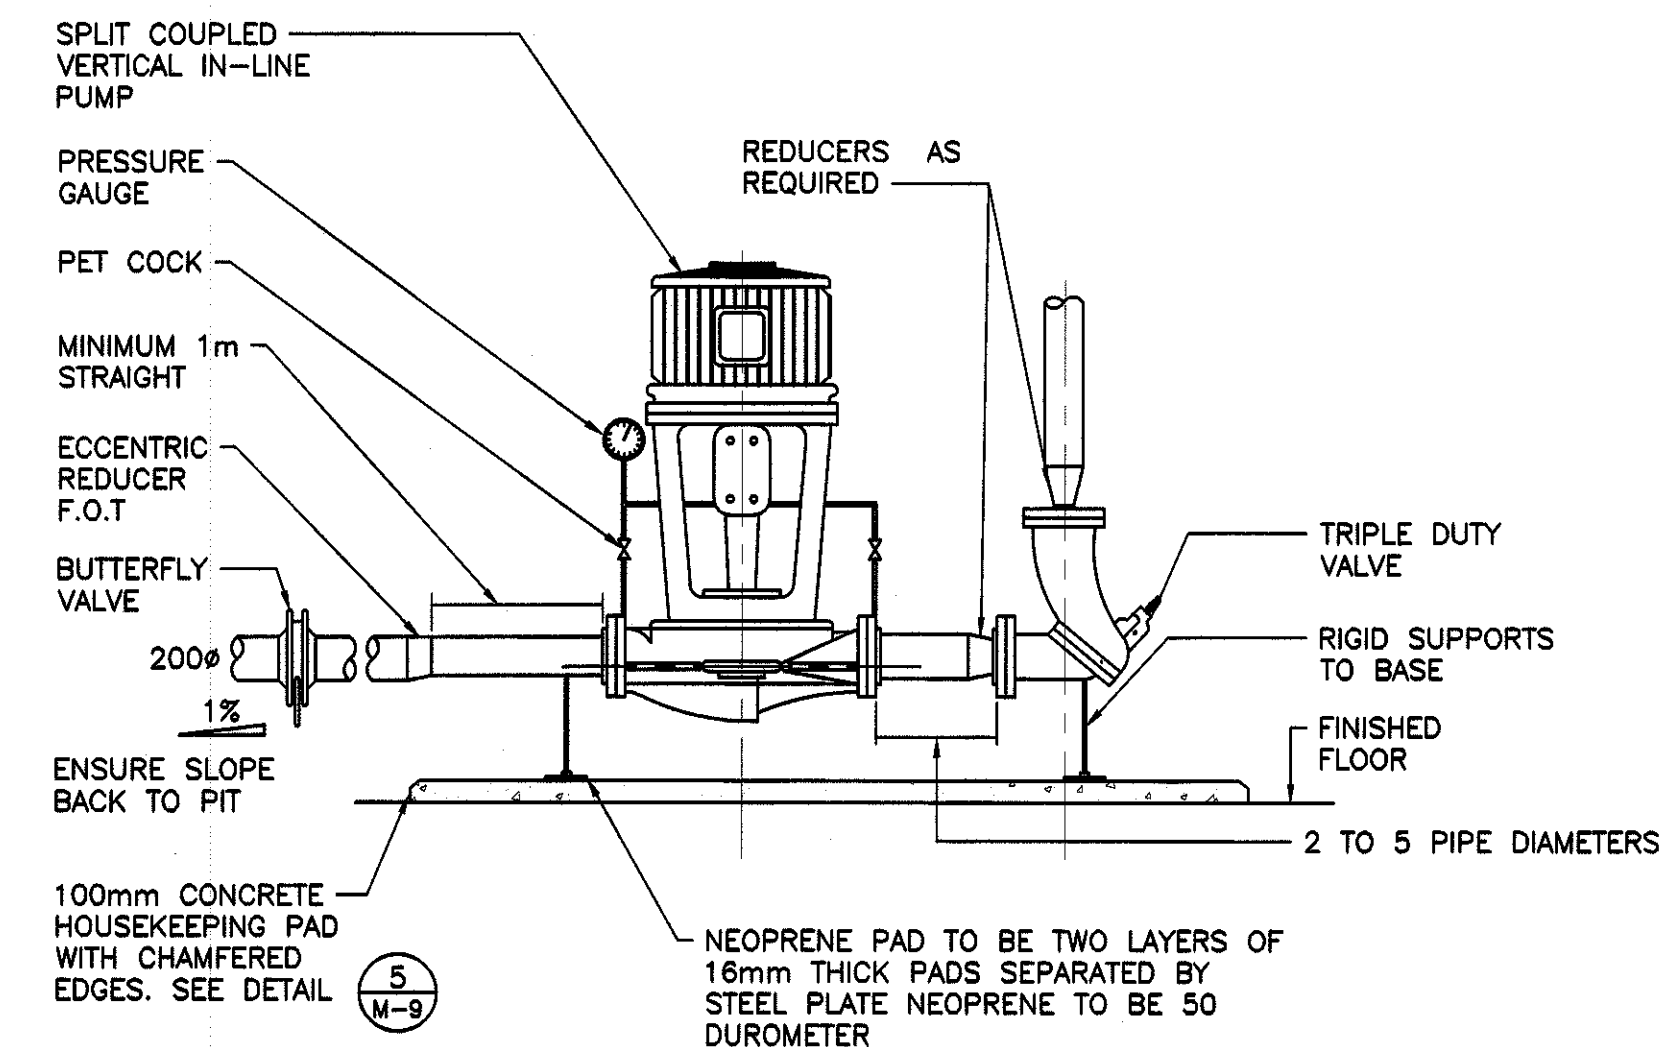

DETAIL - VERTICAL IN-LINE PUMP BASE MOUNTED
TYPICAL FOR PUMPS P-97, P-98, P-99
SCALE : N.T.S.

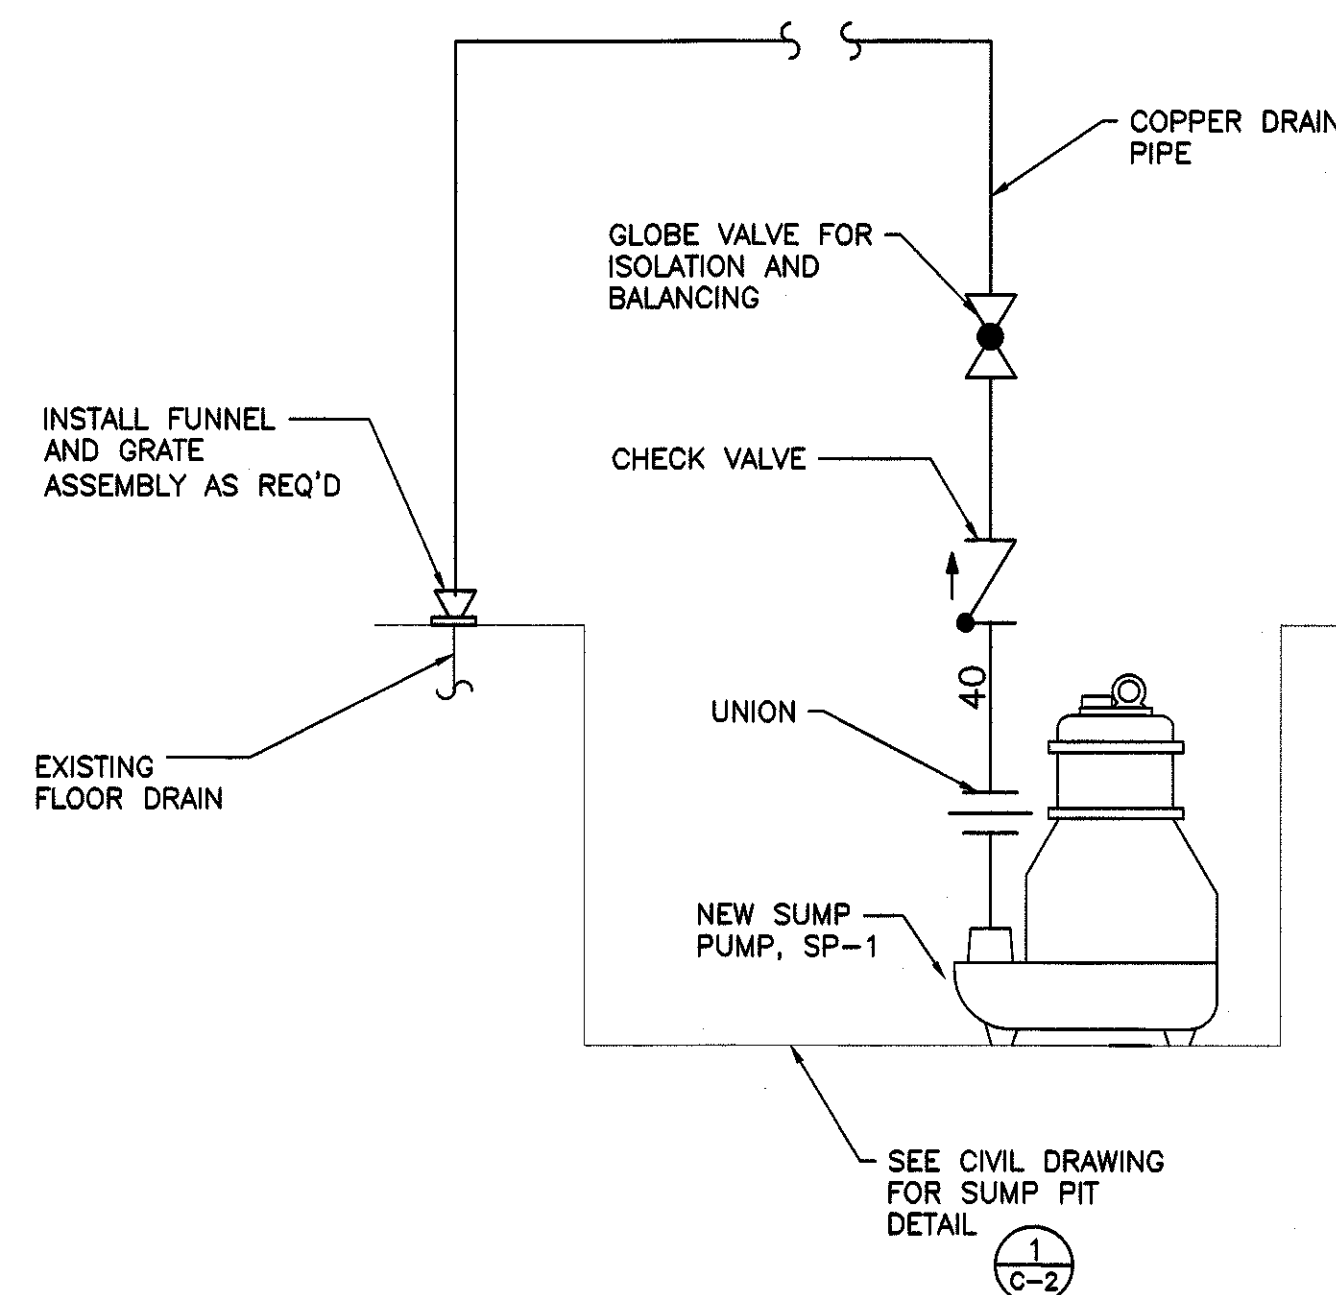


**1
M-3** **DETAIL - SUMP PUMP PIPING**
SCALE : N.T.S.

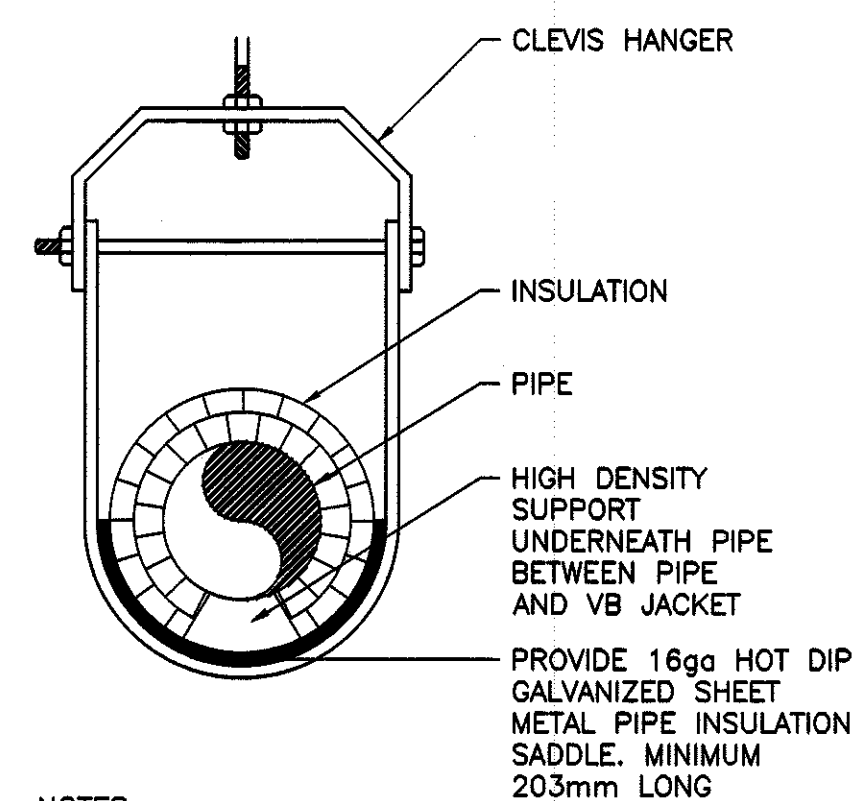

- NOTES:
1. INTEGRITY OF THE VAPOUR BARRIER SHALL BE CONTINUOUS, DO NOT BREAK THE VAPOUR BARRIER.
 2. PIPE INSULATION SADDLE AND CLEVIS HANGER TO SUIT SIZE OF PIPE AND INSULATION THICKNESS.
 3. PIPE SUPPORT COMPONENTS AND HARDWARE FOR OUTDOOR INSTALLATION SHALL BE HOT DIP GALVANIZED.

DETAIL - CHILLED WATER PIPE INSULATION (TYPICAL)
SCALE : N.T.S.

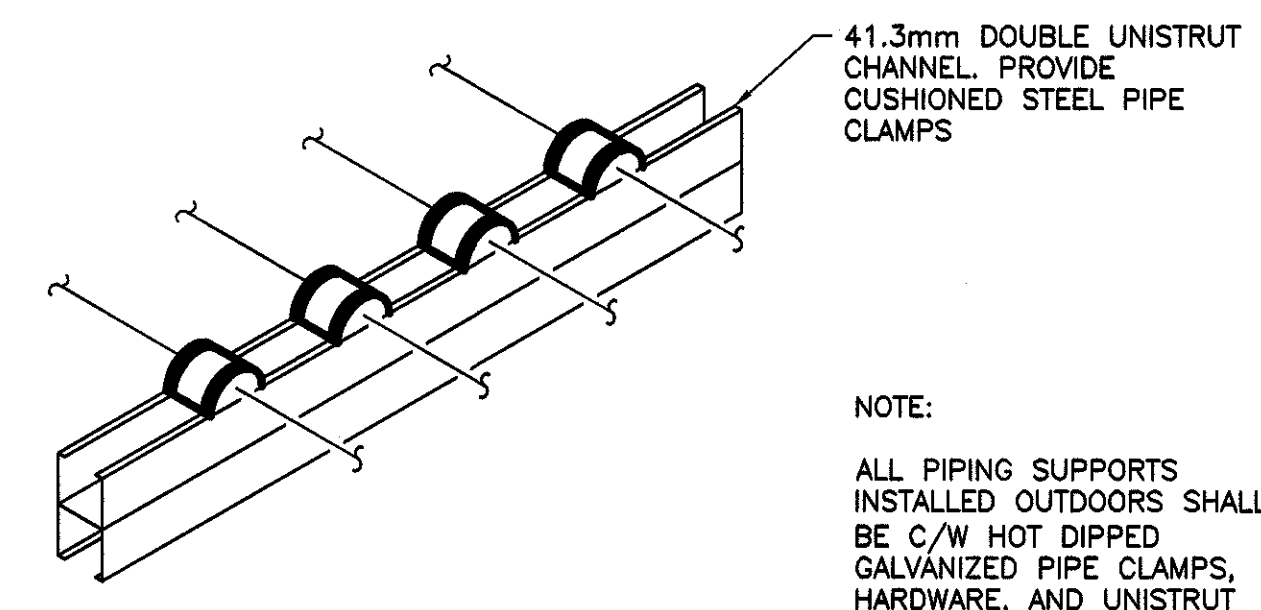

DETAIL - TYPICAL REFRIGERANT PIPING SUPPORT
SCALE : N.T.S.