


EXISTING ELECTRICAL WORK SHOWN IN LIGHT.
NEW ELECTRICAL WORK SHOWN IN DARK.

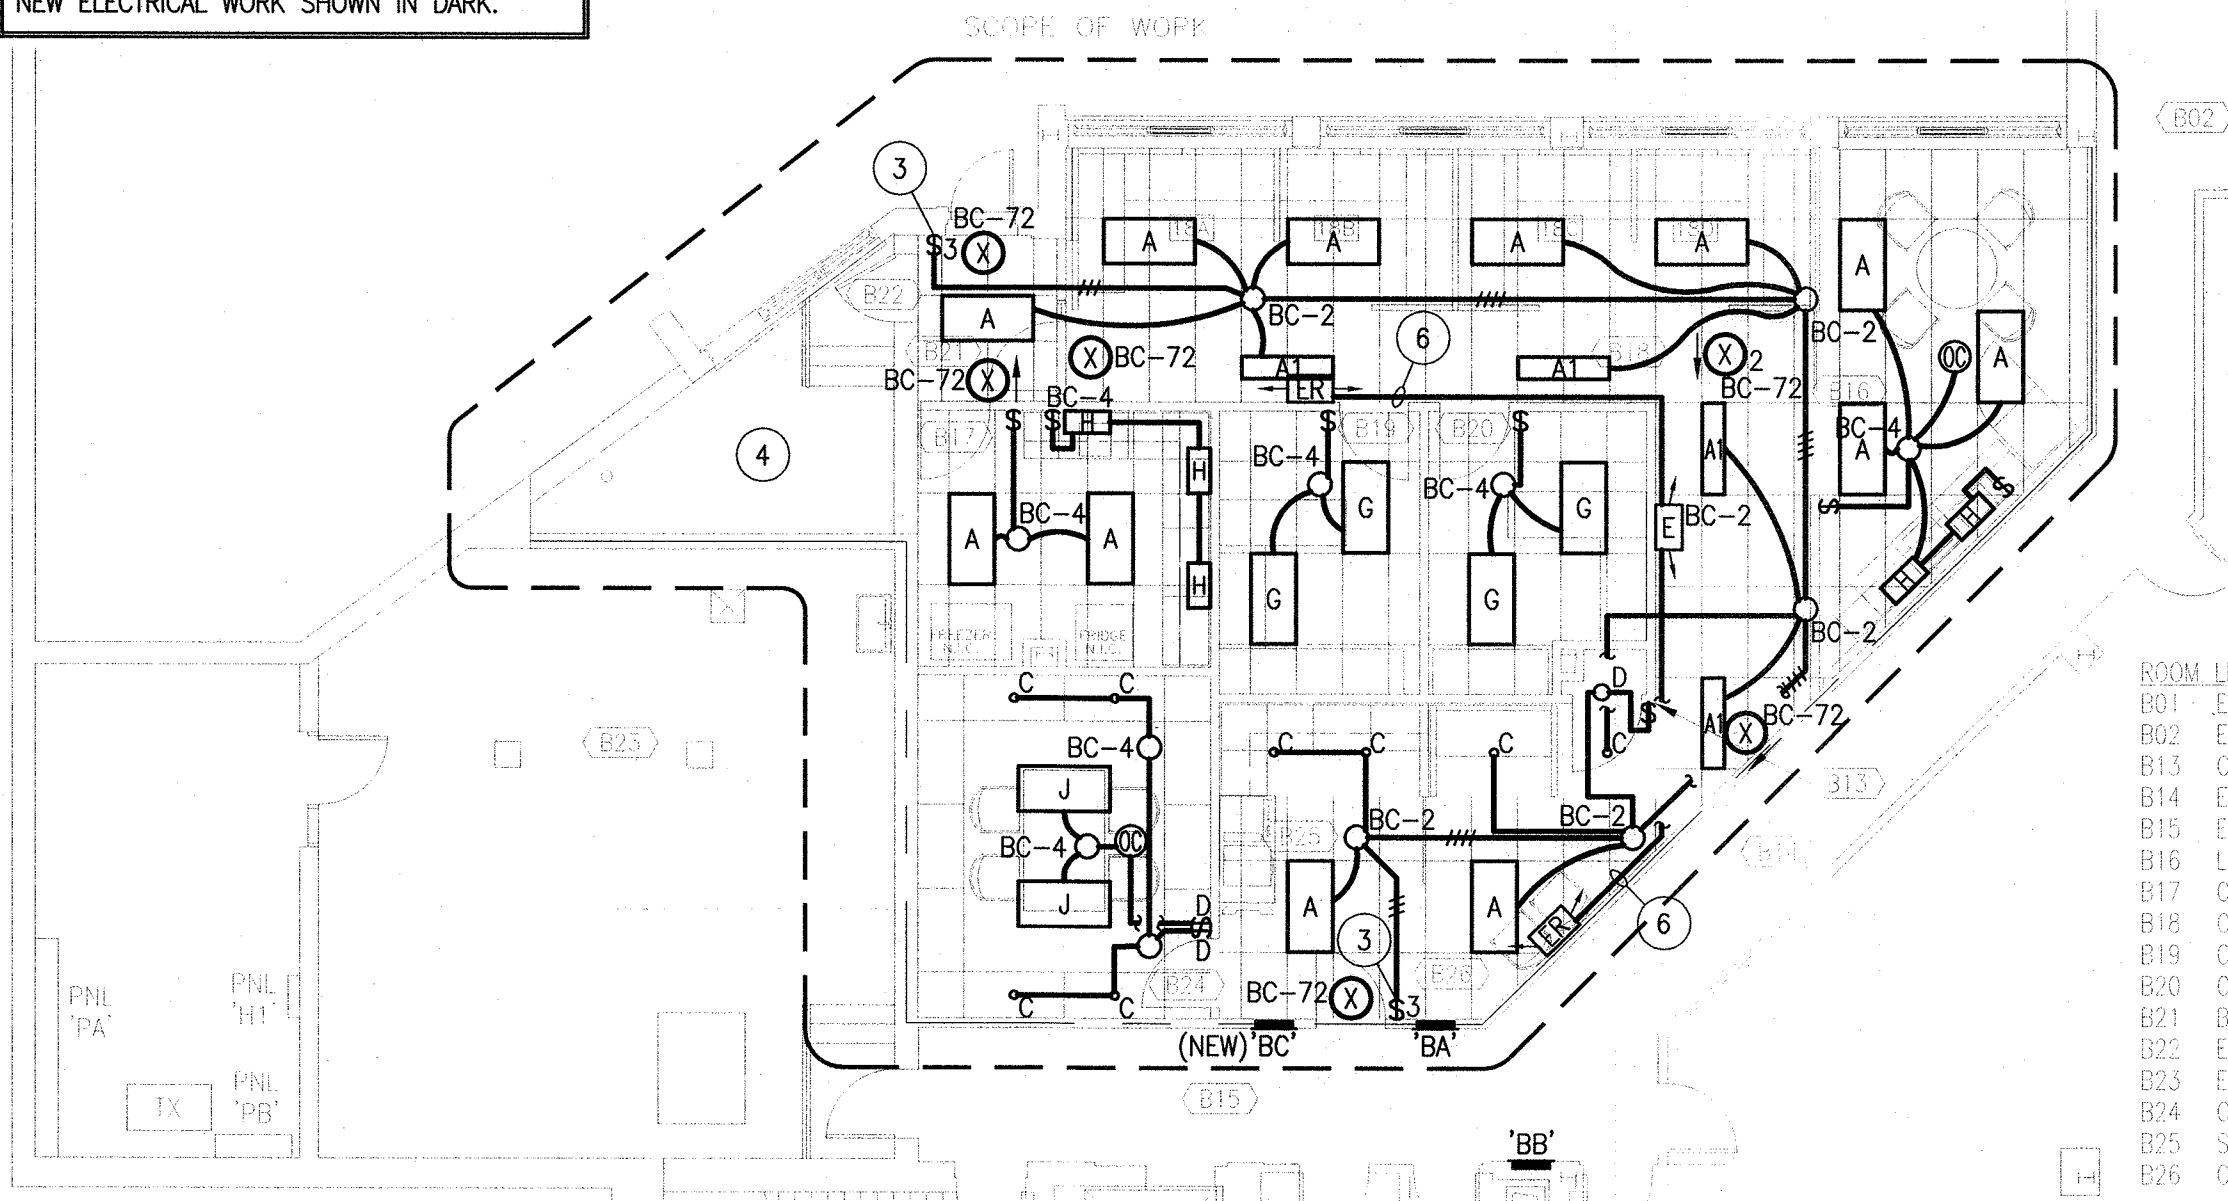


ROOM LEGEND
B01 - EXISTING ENTRY
B02 - EXISTING LOBBY
B13 - CLOSET
B14 - EXISTING CORRIDOR
B15 - EXISTING CORRIDOR
B16 - LUNCH
B17 - CFIA LABORATORY
B18 - CFIA OPEN OFFICE AREA
B19 - CFIA OFFICE 1
B20 - CFIA OFFICE 2
B21 - BACK CORRIDOR
B22 - EXISTING CFIA STORAGE
B23 - EXISTING MECHANICAL
B24 - CFIA MEETING ROOM
B25 - SHARED EQUIPMENT
B26 - CFIA ENTRY

SCALE/ÉCHELLE: 1:100
0m 1m 2m 3m 4m 5m 6m 7m 8m 9m 10m

1 LIGHTING LAYOUT
E3 SCALE 1:100

EXISTING ELECTRICAL WORK SHOWN IN LIGHT.
NEW ELECTRICAL WORK SHOWN IN DARK.

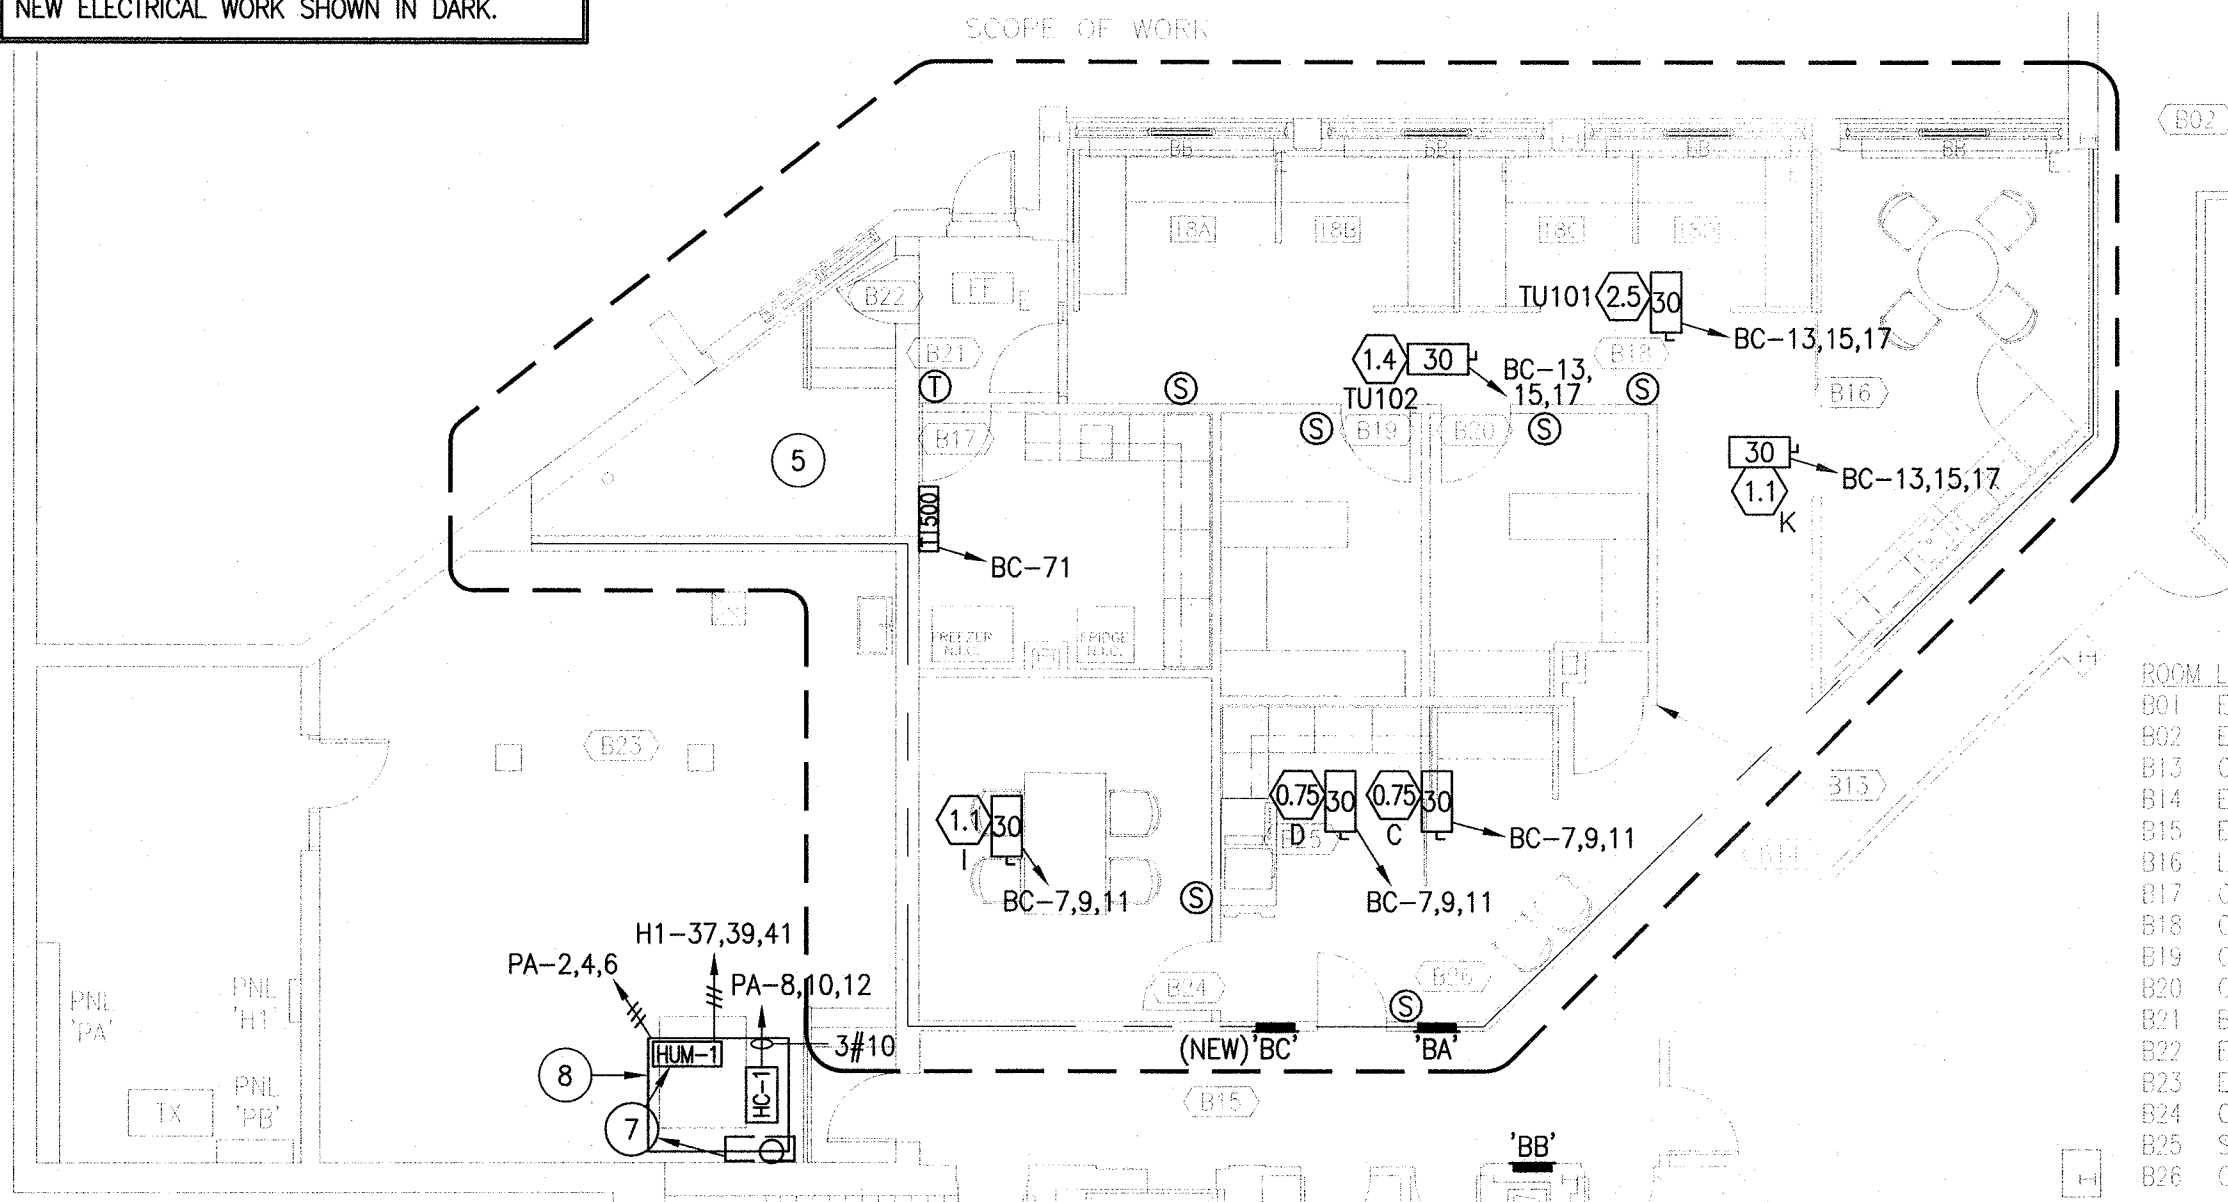

ROOM LEGEND
B01 - EXISTING ENTRY
B02 - EXISTING LOBBY
B13 - CLOSET
B14 - EXISTING CORRIDOR
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B23 - EXISTING MECHANICAL
B24 - CFIA MEETING ROOM
B25 - SHARED EQUIPMENT
B26 - CFIA ENTRY

SCALE/ÉCHELLE: 1:100
0m 1m 2m 3m 4m 5m 6m 7m 8m 9m 10m

2 HEATING LAYOUT
E3 SCALE 1:100

NOTES

1. **GENERAL:** ALL EMERGENCY LIGHTING MUST BE WIRED TO CIRCUIT INDICATED PRIOR TO SWITCHING.
2. **GENERAL:** ENSURE ALL LIGHTING FEEDS OVER 24.6m ARE UPSIZED TO #10; OVER 39m ARE UPSIZED TO #8.
3. SWITCH TO CONTROL LIGHTS IN CORRIDORS AND OPEN OFFICE AREAS.
4. EXISTING LIGHTING/CONTROL TO REMAIN.
5. EXISTING HEATING/CONTROL TO REMAIN.
6. 2#14 DC.
7. RELOCATED HUMIDIFIER FROM WALL TO LOCATION ABOVE AHU-1 BY MECHANICAL CONTRACTOR. JUNCTION BOX TO BE SUPPLIED AND INSTALLED BY ELECTRICAL CONTRACTOR AT OLD LOCATION TO ALLOW ALL WIRING TO BE SPLICED AND RE-ATTACHED TO HUMIDIFIER'S NEW LOCATION ADHERING TO C.E.C. 2012 REQUIREMENTS. COORDINATE WITH MECHANICAL CONTRACTOR.
8. THE NEW AHU-1 AND HC-1 ARE TO BE REPLACED IN SAME LOCATION AS EXISTING AIR HANDLING UNIT AND HEATING COIL ONCE THE OLD EQUIPMENT HAS BEEN REMOVED. THE WIRING, CIRCUITS, CONDUIT, DISCONNECTS AND CONTROLS TO BE RE-USED.

Public Works and Government Services Canada
Travaux Publics et Services gouvernementaux Canada

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Stamp

Etampe



4	ISSUED FOR TENDER	2015.05.26
3	99% REVIEW SUBMISSION	2015.04.10
2	50% REVIEW SUBMISSION	2014.10.10
1	DESIGN DEVELOPMENT REVIEW	2014.09.12
revisions		date

project project

**CFIA FIT-UP
WOODSTOCK GOVERNMENT OF
CANADA BUILDING
680 MAIN STREET
WOODSTOCK, NB**

drawing dessin

**ELECTRICAL
LIGHTING &
HEATING**

designed	SHAWN CHISHOLM	conçu
date	2015.05.26	
drawn	JODI PARKER	dessiné
date	2015.05.26	
approved	TRACEY MCDADE, P.ENG.	approuvé
date	2015.05.26	
Tender		Soumission
PWGSC Project Manager	Administrateur de projets TPSGC	
project number		no. du projet

R.067717.001

drawing no. no. du dessin

E3 of 4