

GENERAL NOTES:

1. Do not scale drawing; verify dimensions on site.
2. Drawings to be read as a set.
3. Dimensions are in mm unless otherwise noted.
4. All areas damaged during construction are to be made good.
5. Where noted existing walls to be modified to meet specified fire rating.
6. Floor assembly above premises to maintain 45 minute fire-rating, apply fire-proofing to underside of deck where required to achieve continuous fire separation above.

DEMOLITION NOTES

1. Remove all partitions, doors, window coverings and millwork, where noted.
2. Remove all flooring throughout except Storage Room B22, make good floor slab to receive new flooring.
3. Retain and reuse existing ceiling grid where possible.
4. All card access equipment to be kept for reuse where applicable.









LEGEND:


- WALL TO BE REMOVED
- NEW WALLS
- FIRE RATED WALL - 45 MIN.
- FIRE RATED WALL - 1 HR.
- (218A) DOOR NUMBER
- ① WALL TYPE INDICATOR
- [S1] INTERIOR SCREEN NUMBER
- ① KEYED NOTE INDICATOR

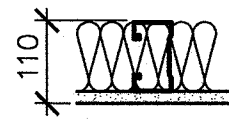PARTITION TYPE SCHEDULE

NOTES FOR INTERNAL WALL TYPES

1. REFER TO FINISH SCHEDULE FOR WALL FINISHES AND WALL BASE TYPE.
2. THIS DRAWING SHOULD BE READ IN CONJUNCTION WITH FINISHES SCHEDULE.
3. REFER TO FLOOR PLANS FOR WALL TYPE LOCATIONS.
4. SOUND BATTS WILL BE 92mm THICKNESS UNLESS NOTED OTHERWISE.


TYPE	INTERNAL WALL TYPE DESCRIPTION	STC	FIRE RATING
1	 <p>16 FIRE RESISTANT GYPSUM BOARD ON BOTH SIDES TO U/S STRUCTURE</p> <p>92 STUDS WITH SOUND BATTS IN CAVITY TO U/S STRUCTURE</p>	STC 47 BASED ON WALL TYPE S4b NBC 2010	45 MIN. BASED ON ULC DESIGN W-453
1C	 <p>CERAMIC WALL TILE</p> <p>16 FIRE RESISTANT GYPSUM BOARD ON BOTH SIDES TO U/S STRUCTURE</p> <p>92 STUDS WITH SOUND BATTS IN CAVITY TO U/S STRUCTURE</p>	STC 47 BASED ON WALL TYPE S4b NBC 2010	45 MIN. BASED ON ULC DESIGN W-453
2	 <p>16 GYPSUM BOARD ON BOTH SIDES TO U/S STRUCTURE</p> <p>92 STUDS WITH SOUND BATTS IN CAVITY TO U/S STRUCTURE</p>	STC 47 BASED ON WALL TYPE S4b NBC 2010	
2C	 <p>CERAMIC WALL TILE</p> <p>16 GYPSUM BOARD ON BOTH SIDES TO U/S STRUCTURE</p> <p>92 STUDS WITH SOUND BATTS IN CAVITY TO U/S STRUCTURE</p>	STC 47 BASED ON WALL TYPE S4b NBC 2010	
3	 <p>16 FIRE RESISTANT GYPSUM BOARD ON BOTH SIDES TO U/S STRUCTURE</p> <p>92 STUDS WITH SOUND BATTS IN CAVITY TO U/S STRUCTURE</p>	STC 47 BASED ON WALL TYPE S4b NBC 2010	45 MIN. BASED ON ULC DESIGN W-453
3C	 <p>CERAMIC TILE</p> <p>16 FIRE RESISTANT GYPSUM BOARD ON BOTH SIDES TO U/S STRUCTURE</p> <p>92 STUDS WITH SOUND BATTS IN CAVITY TO U/S STRUCTURE</p>	STC 47 BASED ON WALL TYPE S4b NBC 2010	45 MIN. BASED ON ULC DESIGN W-453
4	 <p>16 FIRE RESISTANT GYPSUM BOARD ON BOTH SIDES TO U/S STRUCTURE</p> <p>92 STUDS WITH SOUND BATTS IN CAVITY TO U/S STRUCTURE</p>	STC 47 BASED ON WALL TYPE S4b NBC 2010	1 HR. BASED ON ULC DESIGN W-453
4C	 <p>CERAMIC TILE</p> <p>16 FIRE RESISTANT GYPSUM BOARD ON BOTH SIDES TO U/S STRUCTURE</p> <p>92 STUDS WITH SOUND BATTS IN CAVITY TO U/S STRUCTURE</p>	STC 47 BASED ON WALL TYPE S4b NBC 2010	1 HR. BASED ON ULC DESIGN W-453

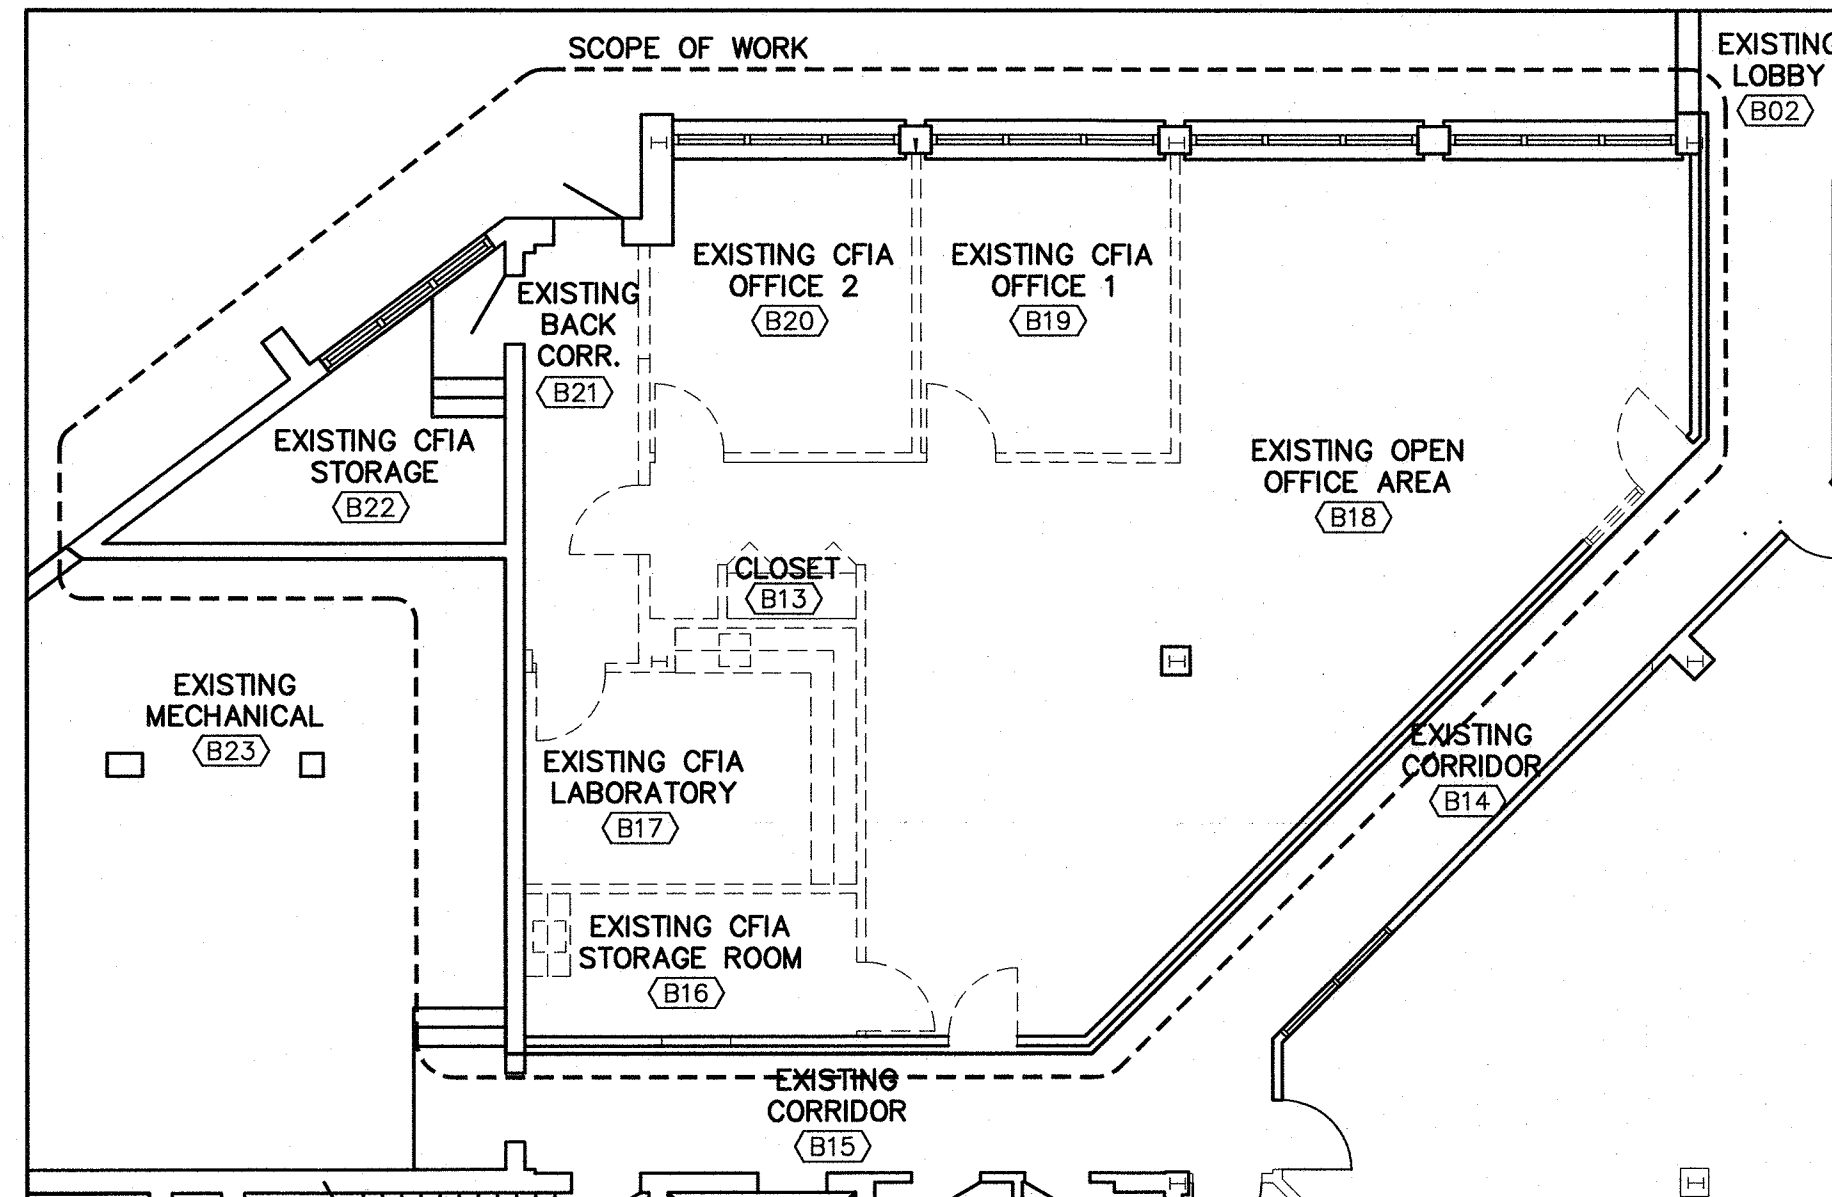

EXISTING/DEMOLITION PLAN

SCALE : 1:100

0m 1m 2m 3m 4m 5m 6m 7m 8m 9m 10m

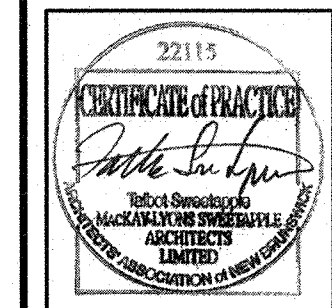

3	ISSUED FOR TENDER	05.26.15
2	99% REVIEW SUBMISSION	04.10.15
1	50% REVIEW SUBMISSION	01.10.14
revisions		date

project project

WOODSTOCK CFIA
FIT-UP
GOCB
680 MAIN STREET
WOODSTOCK, NB

drawing dessin

DEMOLITION PLAN, PARTITION TYPE SCHEDULE

designed	DEC	conçu
date	10.10.14	
drawn	DEC	dessiné
date	10.10.14	
approved		approuvé
date		
Tender		Soumission
PWGSC Project Manager	2015/06/24	Administrateur de projets TPSGC
project number		no. du projet

R.067717.001

drawing no. no. du dessin

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