



SITE PLAN

SCALE : 1:100
0m 1m 2m 3m 4m 5m 6m 7m 8m 9m 10m

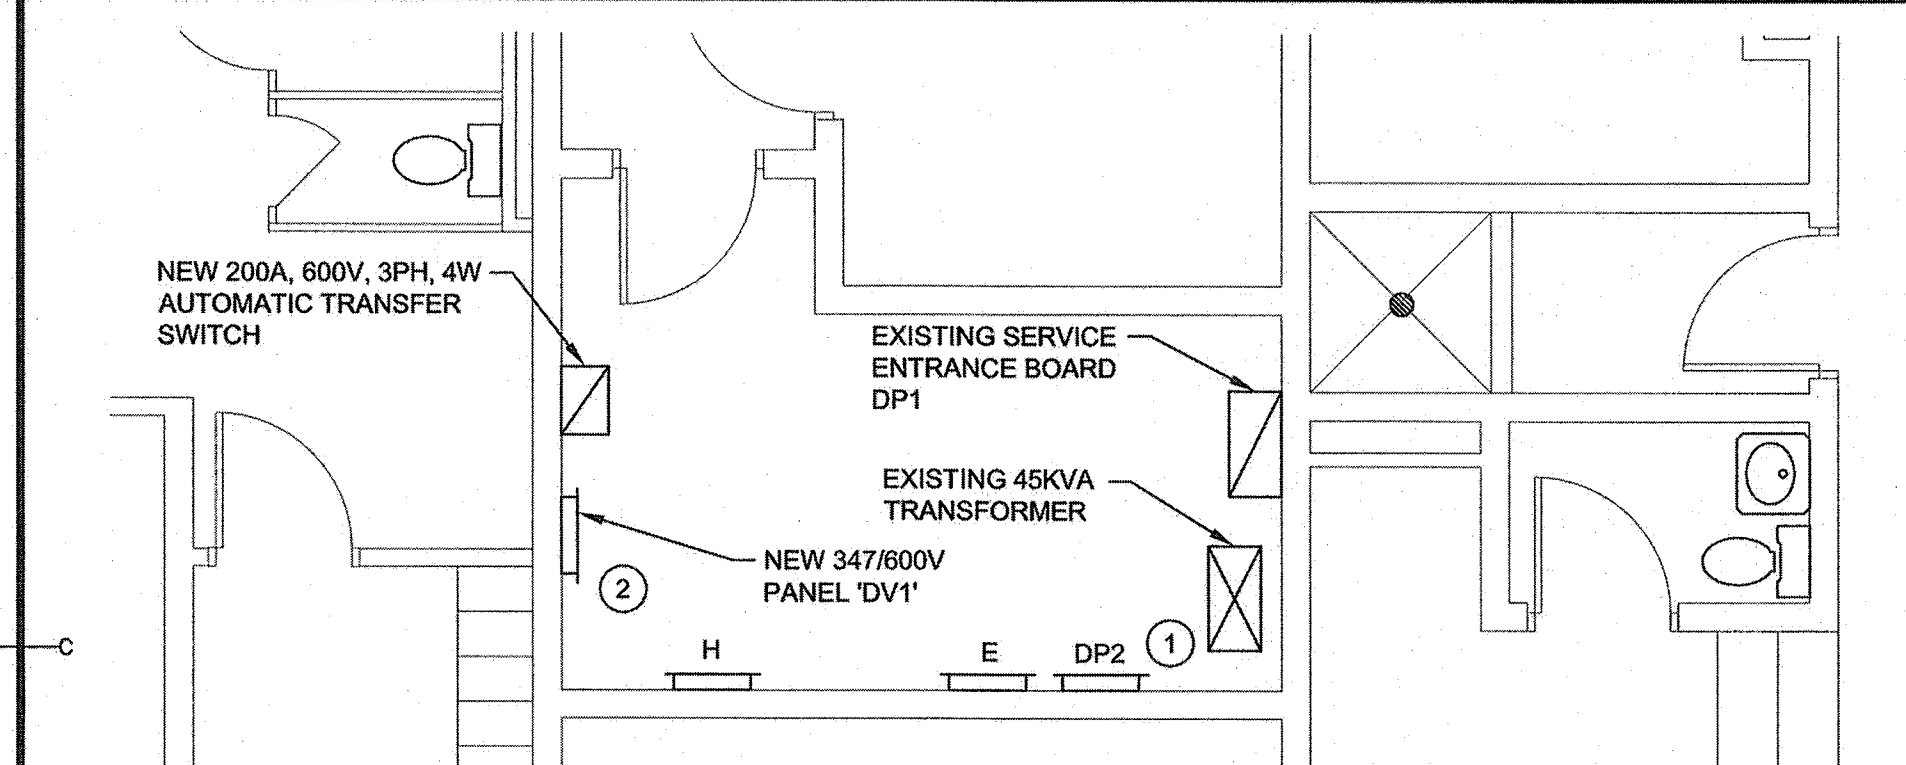


PARTIAL FLOORPLAN

SCALE: 1:50
0m 1m 2m 3m 4m 5m

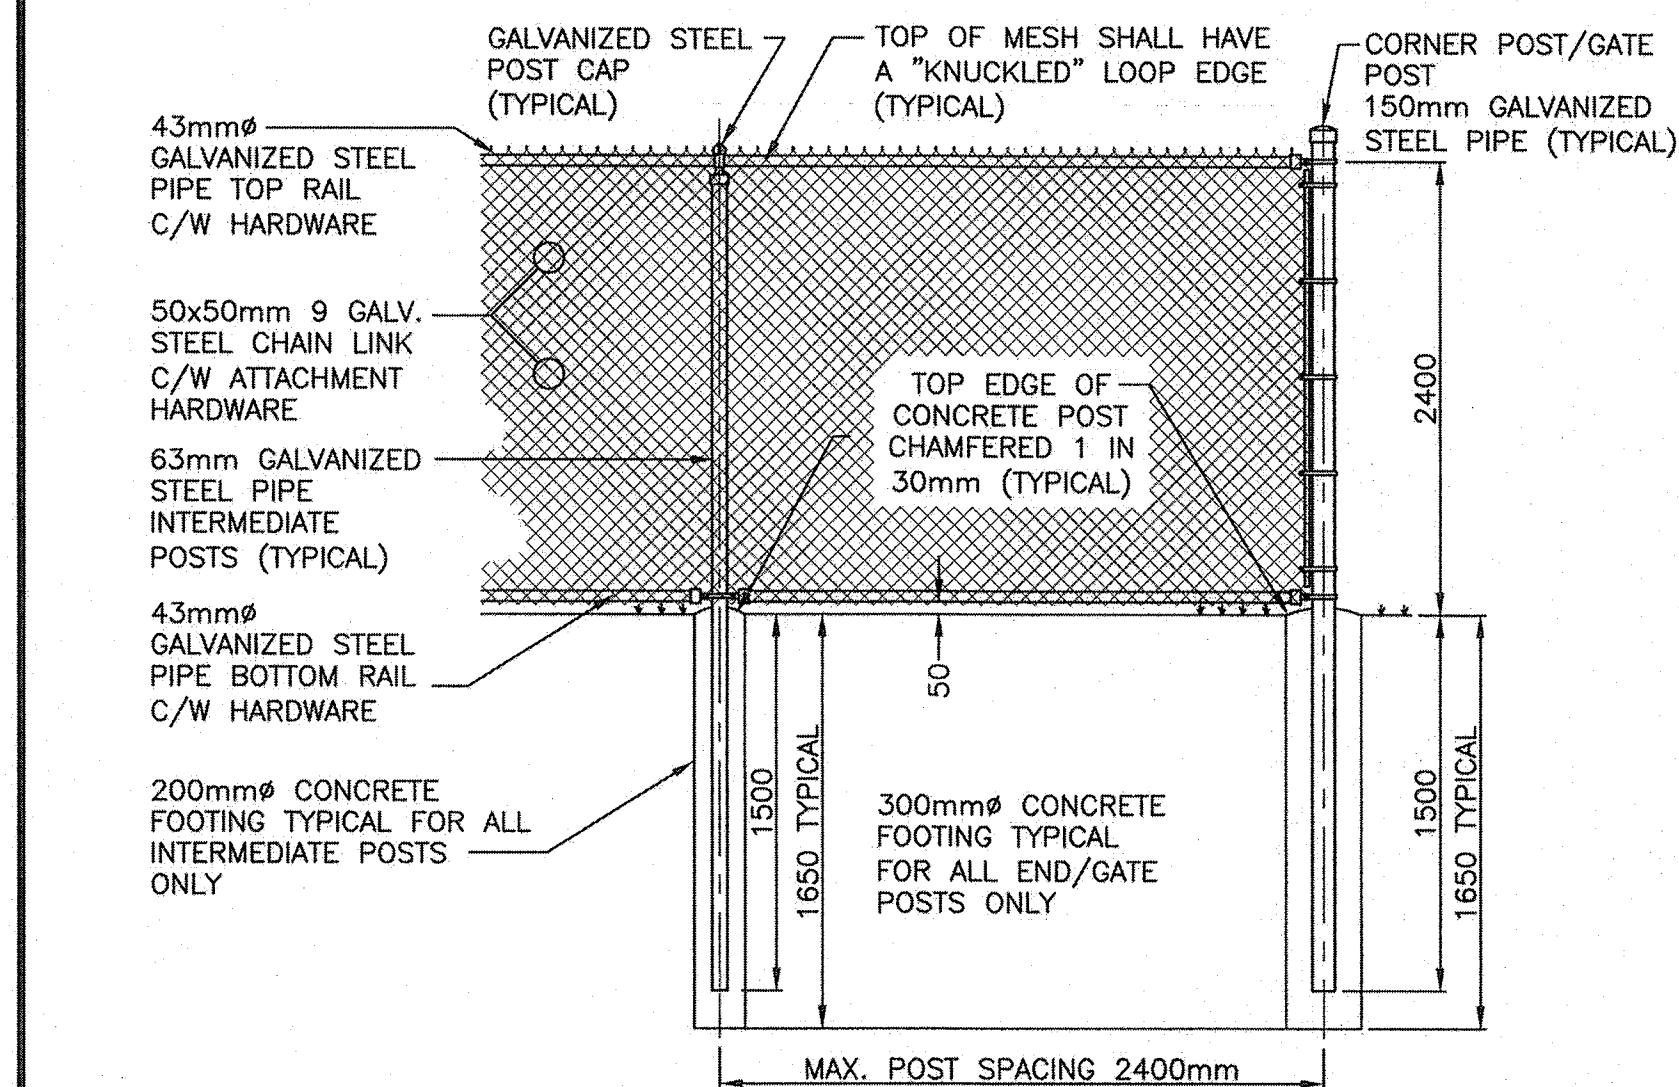


CHAIN LINK FENCE DETAIL

SCALE/ECHELLE: N.T.S.

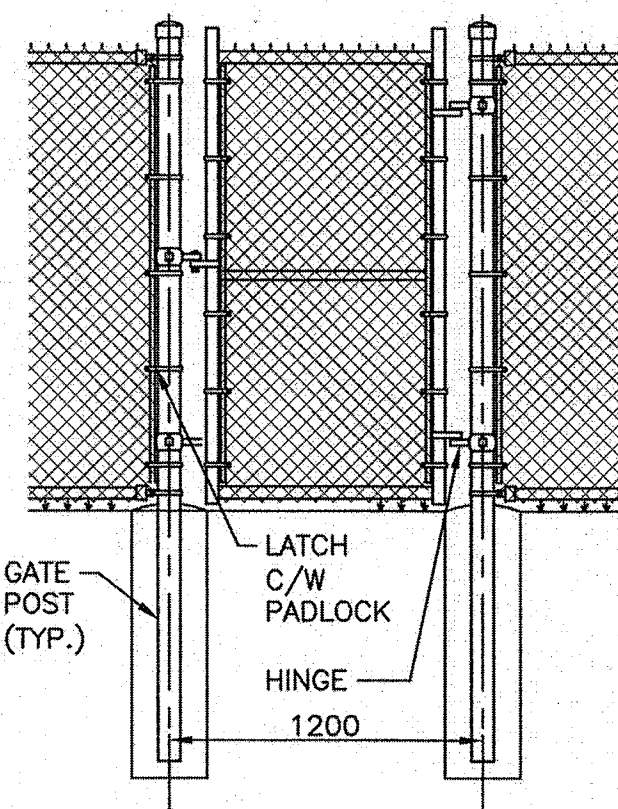

GATE DETAIL

SCALE/ECHELLE: N.T.S.

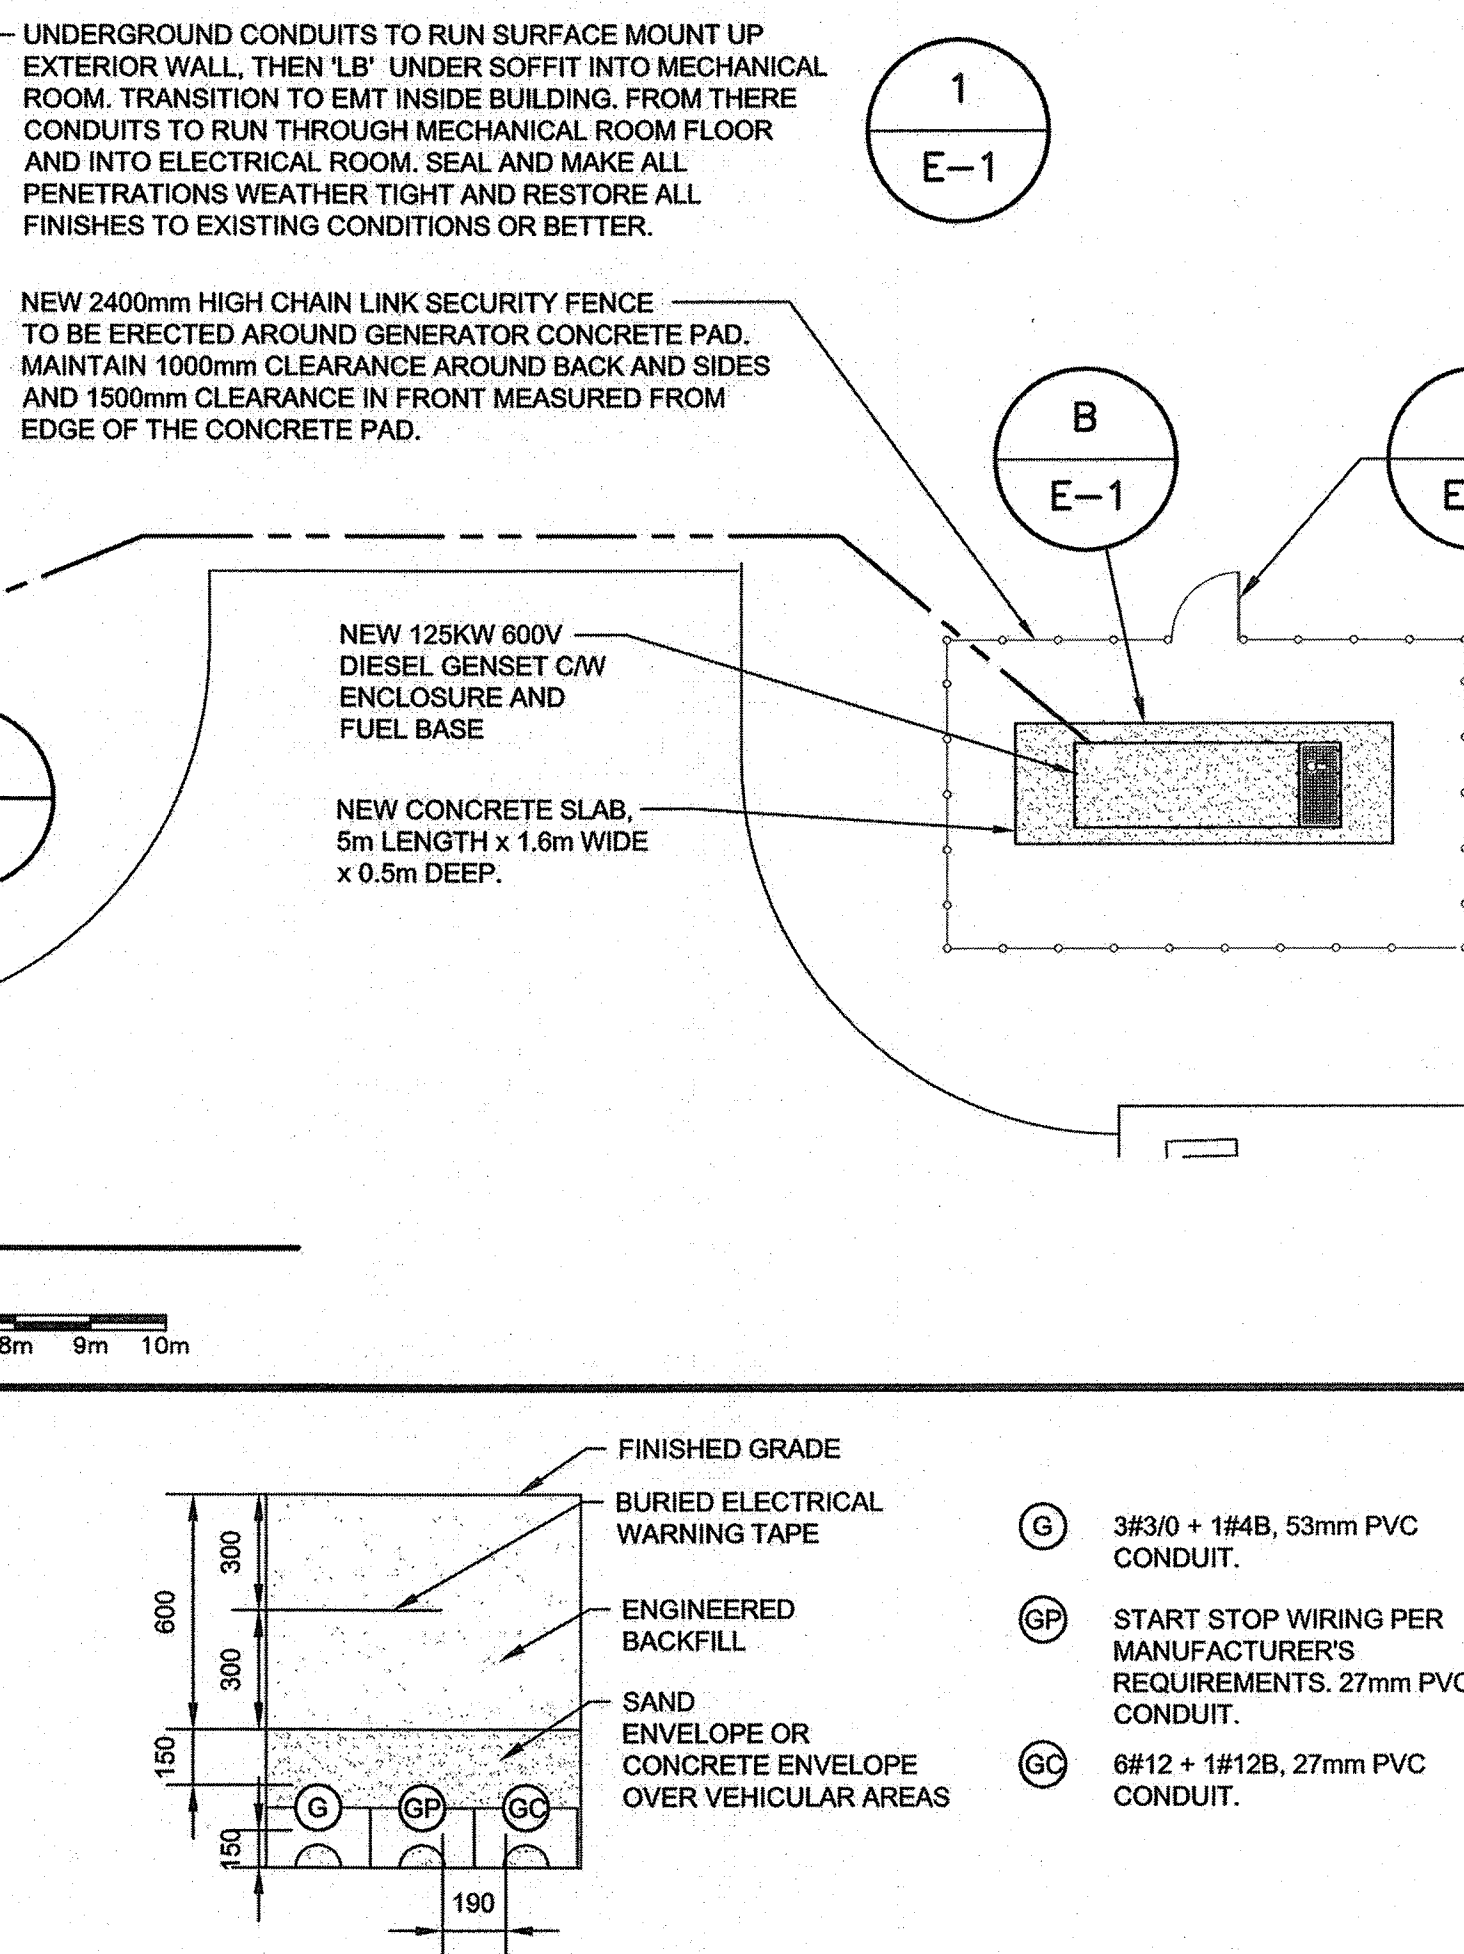


DIRECT BURIED PVC CONDUIT

SCALE/ECHELLE: N.T.S.


- GENERAL NOTES:**
- ALL WORK TO BE CARRIED OUT IN ACCORDANCE WITH LATEST EDITION OF CEC.
 - CONDUIT ROUTING SHOWN DIAGRAMMATICALLY. FIELD ROUTE AND VERIFY.
 - CONSTRUCTION BARRICADES TO BE ERECTED AROUND AREA OF WORK.
 - WORK MUST NOT INTERFERE WITH TRAFFIC OR BUILDING OPERATIONS.
 - CONTRACTOR IS RESPONSIBLE FOR LOCATING EXISTING UNDERGROUND SERVICES AND OBSTRUCTIONS.

- KEYNOTES**
- PROVIDE THREE (3) NEW 15A/1P BREAKERS IN PANEL 'DP2' TO FEED GENERATOR BATTERY CHARGER, BLOCK HEATER AND GENERATOR HEATER. EXISTING PANEL IS A SIEMENS.
 - EXTEND ALL EXISTING CIRCUITS FROM SERVICE ENTRANCE BOARD 'DP1' TO NEW PANELBOARD 'DV1' USING A SPLICE BOX INSTALLED ADJACENT TO 'DP1'. PROVIDE EXTRA SPLICE BOXES IF REQUIRED. REFER TO POWER DISTRIBUTION SINGLE LINE FOR BREAKERS IN PANEL 'DV1'. TEST RELOCATED CIRCUITS AND SUBMIT WITH O&M MANUALS.

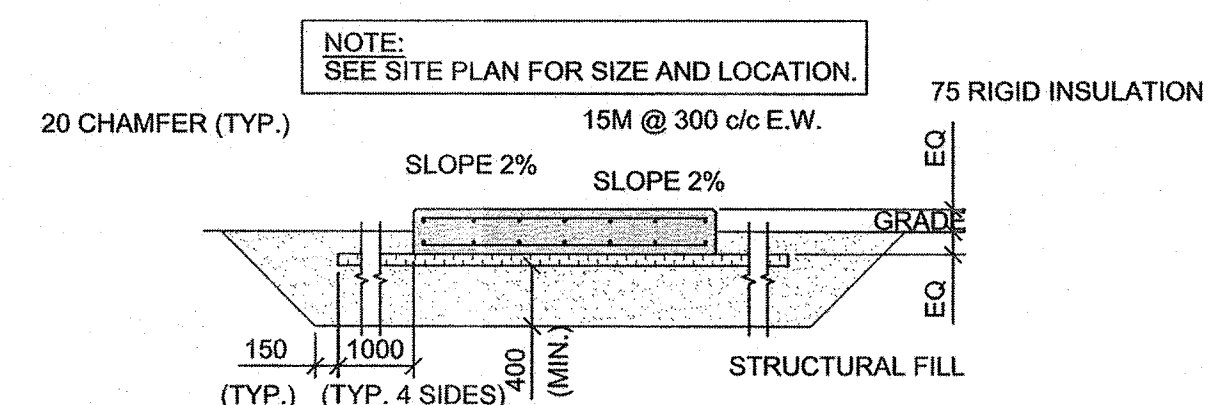

CONCRETE SLAB DETAIL

SCALE/ECHELLE: N.T.S.

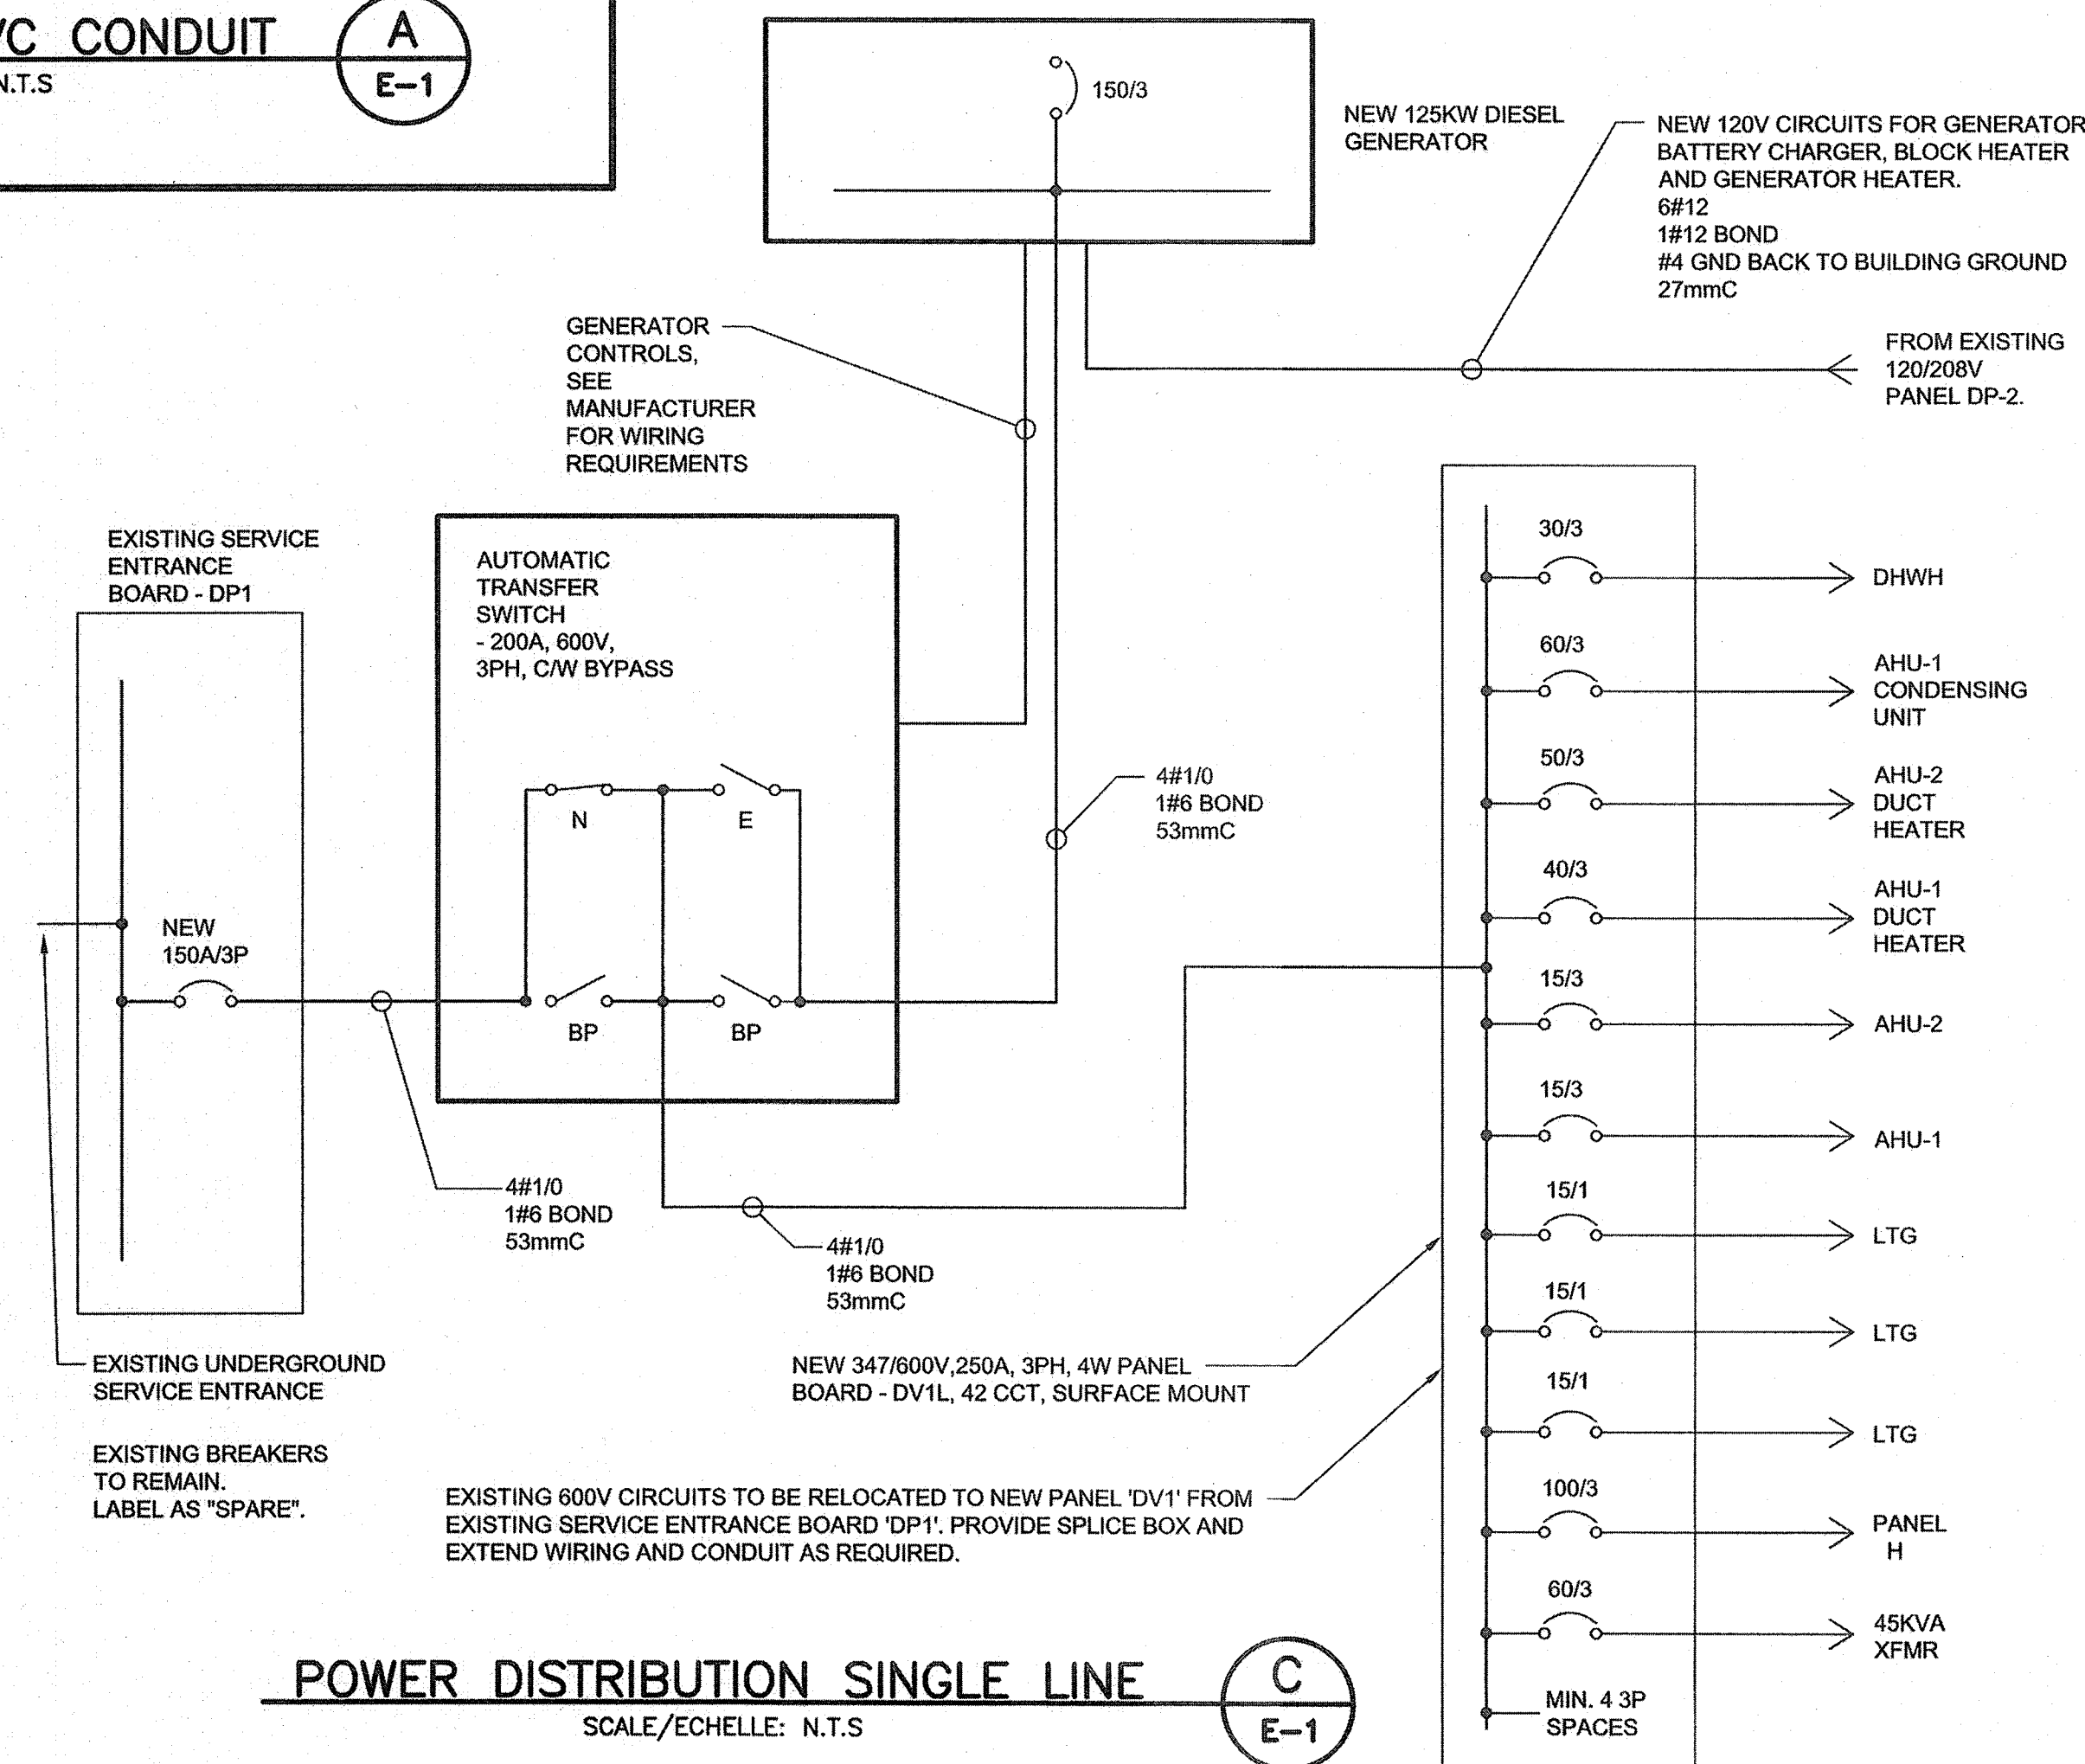

POWER DISTRIBUTION SINGLE LINE

SCALE/ECHELLE: N.T.S.

0	RELEASED FOR TENDER	APR.30 2015
revisions		date
project		project

**HAMPTON INSTALL
EMERGENCY
GENERATOR**

drawing dessin

**ELECTRICAL
PLANS AND
DETAILS**

designed M. GALLANT	conçu
date APRIL 2015	
drawn M. GALLANT	dessiné
date APRIL 2015	
approved	approuvé
date	
Tender	Soumission
PWOSC Project Manager	Administrateur de projets TPSCC
project number	no. du projet
R.061867.003	
drawing no.	no. du dessin
E-1	