

WHITBY HARBOUR WHARF REPAIRS

DRAWING INDEX:

- S-00 TITLE PAGE
- S-01 EXISTING CONDITIONS, DEMOLITION AND REMOVALS
- S-02 EAST SIDE EXISTING TYPICAL SECTIONS, DEMOLITION AND REMOVALS
- S-03 WEST SIDE EXISTING TYPICAL SECTIONS, DEMOLITION AND REMOVALS
- S-04 TYPICAL EXISTING DETAILS, DEMOLITION AND REMOVALS
- S-05 SITE PLAN OF TYPICAL REPAIR DETAILS
- S-06 TYPICAL REPAIR DETAILS
- S-07 TYPICAL LADDER REPAIR DETAILS
- S-08 TYPICAL REPAIR DETAILS
- S-09 SITE PLAN OF NEW SCOUR MAT LOCATIONS
- S-10 NEW SCOUR MAT TYPICAL SECTIONS

WHITBY, ONTARIO



SMALL CRAFT HARBOURS

CENTRAL AND ARCTIC REGION


GOUVERNEMENT DU CANADA

FISHERIES PECHES AND OCEANS ET OCÉANS




Riggs Engineering Ltd.
1240 Commissioners Rd. W, Suite 205 London, Ontario, N6K 1C7 Tel: (519) 657-1040 Fax: (519) 657 8631

Website: www.riggsengineering.com

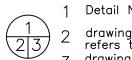

2 drawing no. — where detail required refers to MA—
3 drawing no. — where detailed refers to MA—

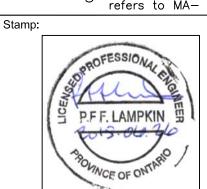

REV	ISIONS:		DATE:
SCALE:		CLASS:	
	AS NOTED		

WHITBY HARBOUR WHARF REPAIRS

DESCRIPTION:

TITLE PAGE

WN:	APPROVED:
A.M	P.L.
:	DATE:
2015-06-25	2015-06-25
	A.M :: 2015-06-25

LOCATION:

WHITBY, ONTARIO


LOCATOR CODE: DRAWING NO.: 721422


WATER LEVEL CHART


																					- 1	Via	ay	20)1	5	M	ai				
	Jan	Fak	Mar	Ann	Mar	20 Jun	014 Jul	Δ	Ser	los	: No	v De	c Ja	an In	eb	Mar	Apr	Мау	Jun)15 Jui	Aug	Sep	Oct	Nov	Dec	Jan	Feb	_	016 Apr	May	Jun	
.00 -	Jan	Fév	M ar	Avr	M ai	Juir	Juil	Ao	Sep	Oct	No	-			év	Mar	Avr	M ai		Juil		Sep			Déc		Fév		Avr	Mai	Juin	175
		Lak					Éri			198	6						1985	1986	1986	1986	1986		1986						1985	1986	1986	175
	1987	1987	1986	198	198	5 198	6 198	198	6 198	6	198	6 19	36 19	87 1	987	1986		-	-	-	1000	1986	1000	1986	1986	1987	1987	1986	_	_		175
	Ε	_											-	=																		
00 -	E					E	-		-			Ŧ		7				-3	-	•				-		F						174
	_	_	1	/						-	-	F	Ŧ	\rightarrow	_	1						-	-									174
00 -					-	-		-	-			Ŧ	Ŧ					-	-		-	_								-		173
	1935	1936	1025	1935	1935	1935	193	193	193	5 193	5 103	5 19:	25 19	35 4	026	1035	1935	1935	1935	1935	1935	1935	1935	1026	1025	1935	4026	1036		1935	1935	173
		1950	1000								100	2 10.	33.33		936	1555								1000	1000		1930		8-20	114		
00 -						20	014						T						20)15						<u>_</u>			0-20	714	=	172
	Jan Jan	Feb Fév	M ar M ar	Apr	M ay M ai	_	Jul	Au			No No				eb év	Mar Mar	Apr Avr	M ay M ai	_	Jul	Aug		Oct Oct		Dec		Feb Fév	M ar M ar	Apr	May Mai	Jun Juin	
00]	Jan	-		_	_	-	ac	÷	-	_	1.40	V De	0.0	all t	ev	IVI (II	AVI				A00	Sep	Oct	1404	Dec	Jan	rev	IVI BI	AVI			76.
				197	197	_	2 194	_			Ī						1973	1973	1952	1947	1947								1973	1973	1952	
	1946	1952	1952	_			-	-	194		5 10/	5 19	15 10	1	952	1952	-	Е			-	1947		10/4	5 1945	1946	1952	195	_	Г		75.
00 -	1540	_			_	L				-	-	-	-	40									_	_	-	1540	=					75.
				1	/	E		1									1	-	···		-	٠,										
	=	-	Í					E		\				4			/						٠.		E							74.
00 -										Ė	Ė	I				$\stackrel{\sim}{}$									E							74.
HING.			_		1935	1935	193		-	_		F				_		1935	1935	1934	=	_			F			-	-	1935	1935	
	1935	1936	1935	1935				193	193	193	4 400	4 19	. 19	35 1	936	1935	1935				1934	1934	1934	1024	1934	1935	1936	1935	1935	5		73.
00											193	79.	54						-					1934	1934			_	8-20	014		73.
00		-				_)14	_	_	_	_	_	T	_					_)15		-		1	_	Г		_)16			75.
		Fév		Apr Avr	M ay M ai		Jul Juil	Au Ao	Sep Sep			v De v De		an F	év.	Mar Mar	Apr Avr	M ay M ai	2 2	Jul Juil					Dec					May Mai		
.00		Мо	ntr	éal	На	rbc	ur	/ P	ort	de	Мс	ntr	éa	ı				407								106	196	7		107		9.6
	1968	1967	197:		197								19	968	1967	197:	1976	197											197	197		
.00			-			197	4									-			1974									197			1974	8.6
					^		197	3 197	2		190	67 19	72							1973	1972			196	7 197	2						
.00				Í	K	$\overline{}$				6 198	6							<					1986						F	1		7.6
			1	/		1	\									1		Ė	1				-	٠.				1			-	130
.00		_	V			Ē	1	_		1	-			1	1		\triangle	J			-				T	Π						6.6
				2003	3											V	2003	1											200	3		
.00 -	2003	2003	2003				-			-	-	-		003	2003	200		_					=	-	-	200	200	200			2010	5.6
					201	201	20	2 20	12 20	12 20	07 20	107-2(002					201	201	201	2012	2012	200	200	200	2		_	18-20	-		
00 -	_					ΔΙΙ	- T	me	Δν	erac	re l	_									M	OVE	nne	de	to	ıt te	mn					4.6
						, (11	100				-			_		-	-	-		- 1	1.4	-4-		ut			р	-				


INFORMATION OBTAINED FROM MONTHLY WATER LEVEL BULLETIN GREAT LAKES AND MONTREAL HARBOUR CANADIAN HYDROGRAPHIC SERVICE.


INFORMATION ALSO AVAILABLE AT THE FOLLOWING WEB SITE: http://www.waterlevels.gc.ca/C&A/bulletin-eng.html

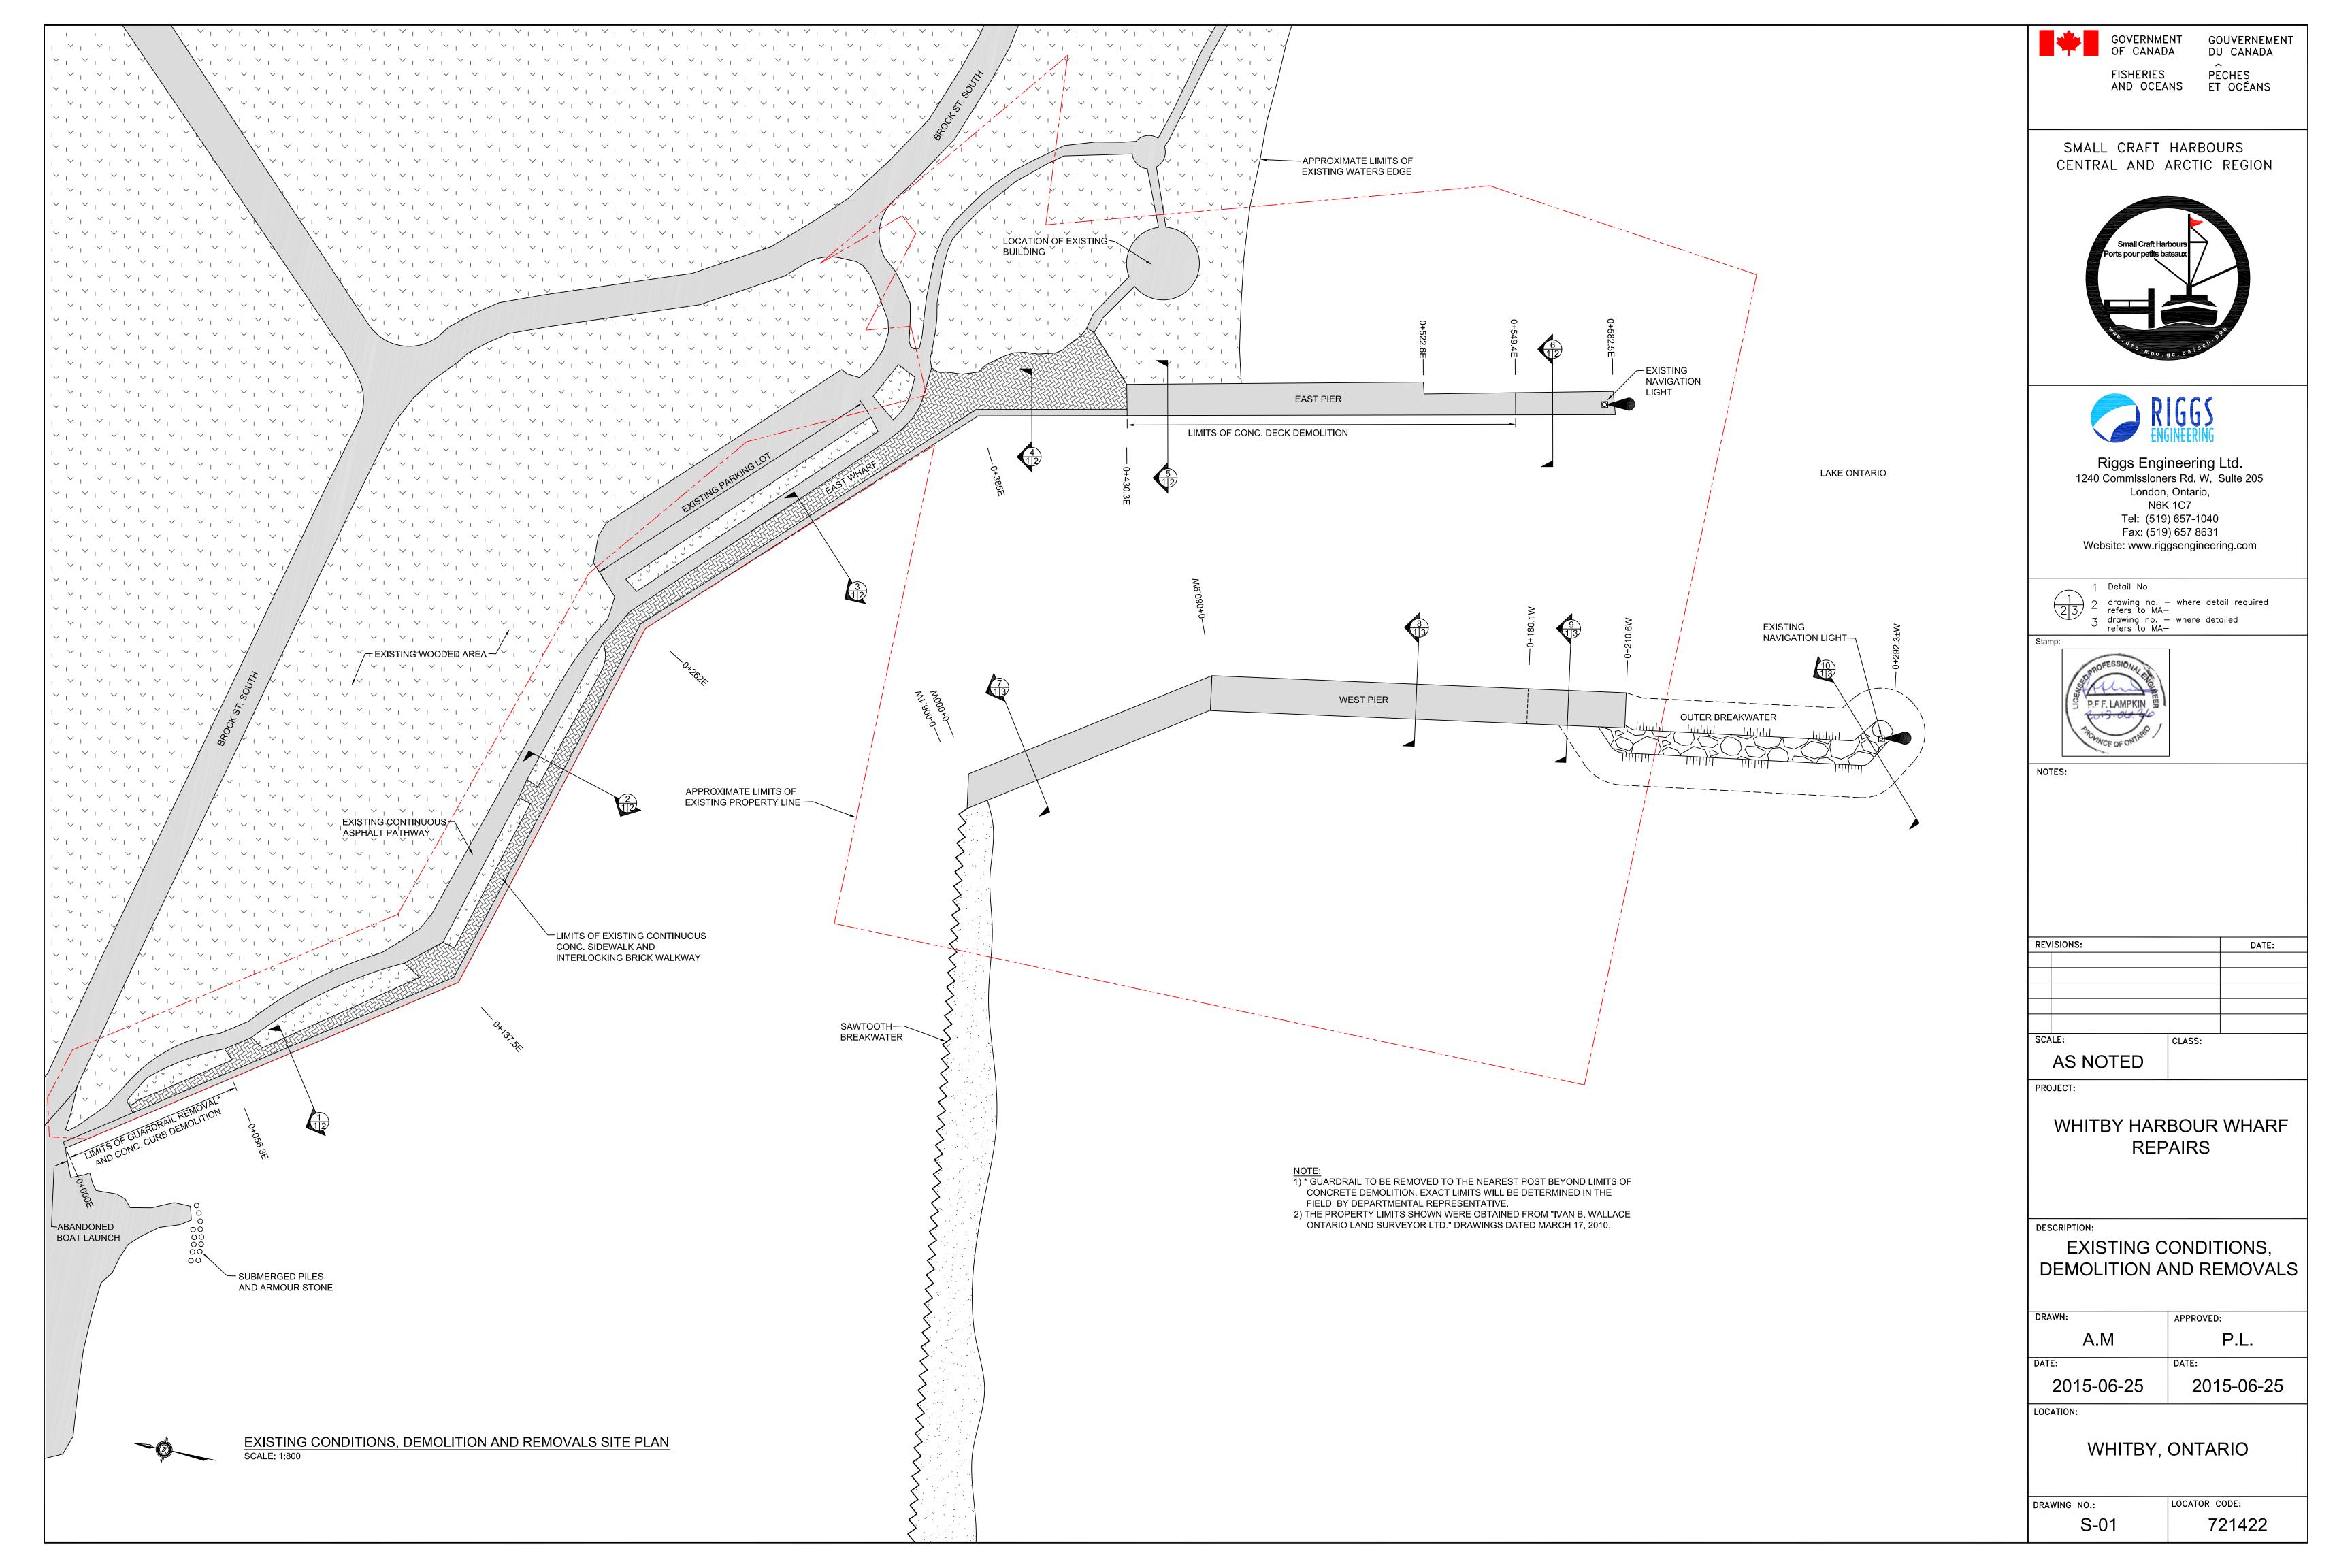


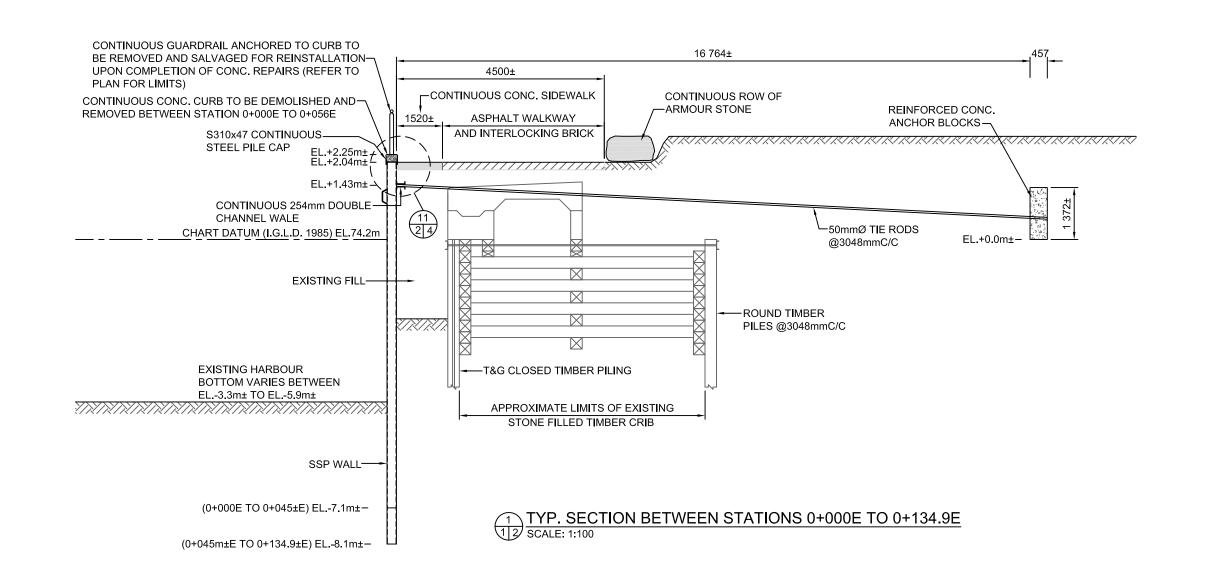


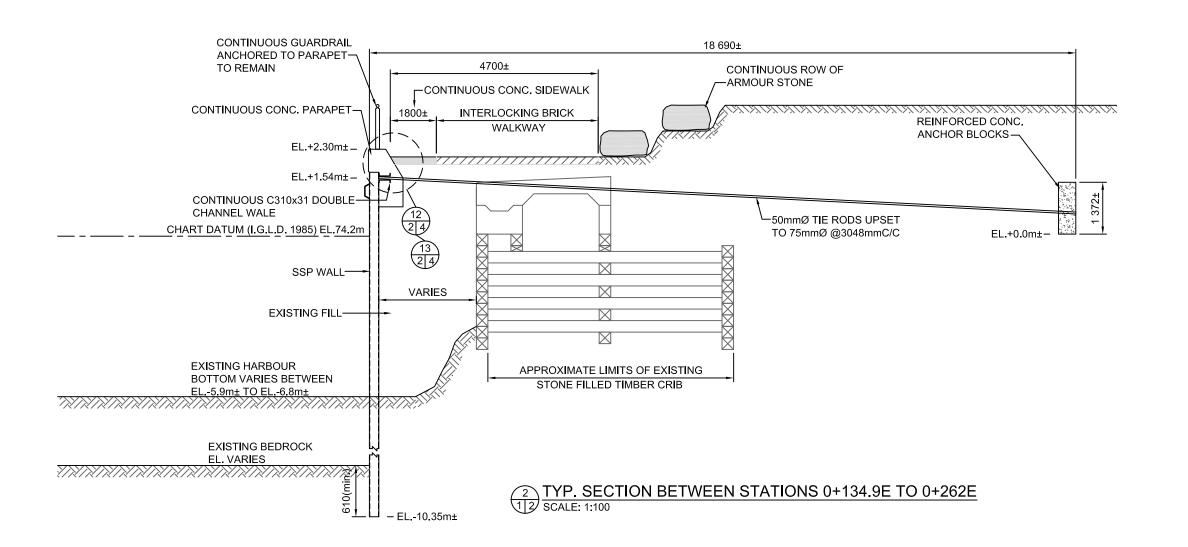

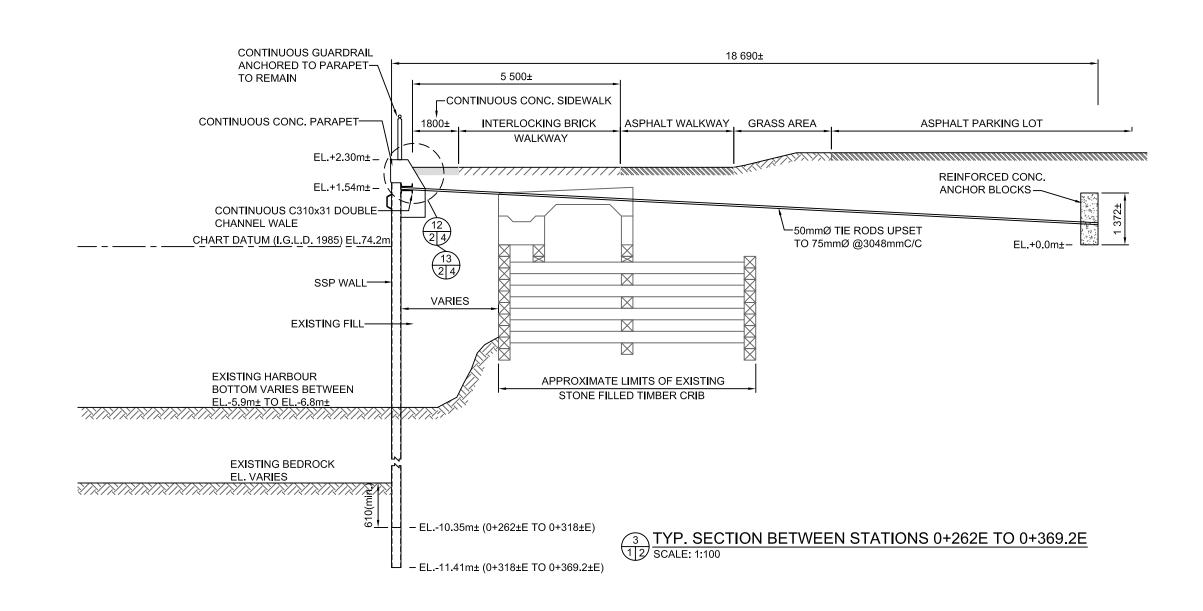

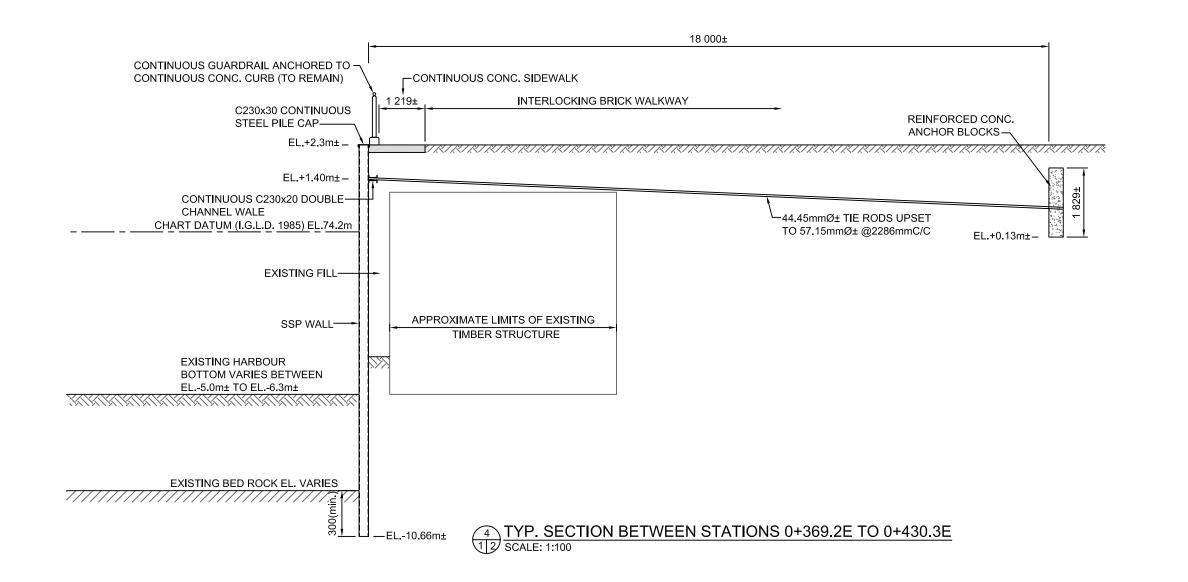

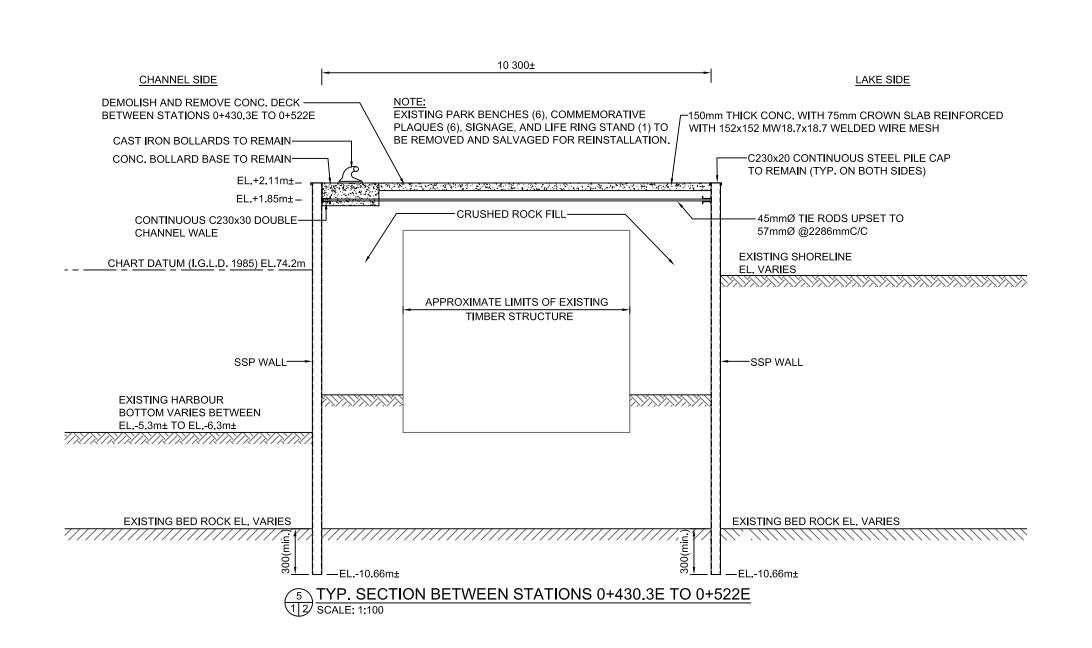

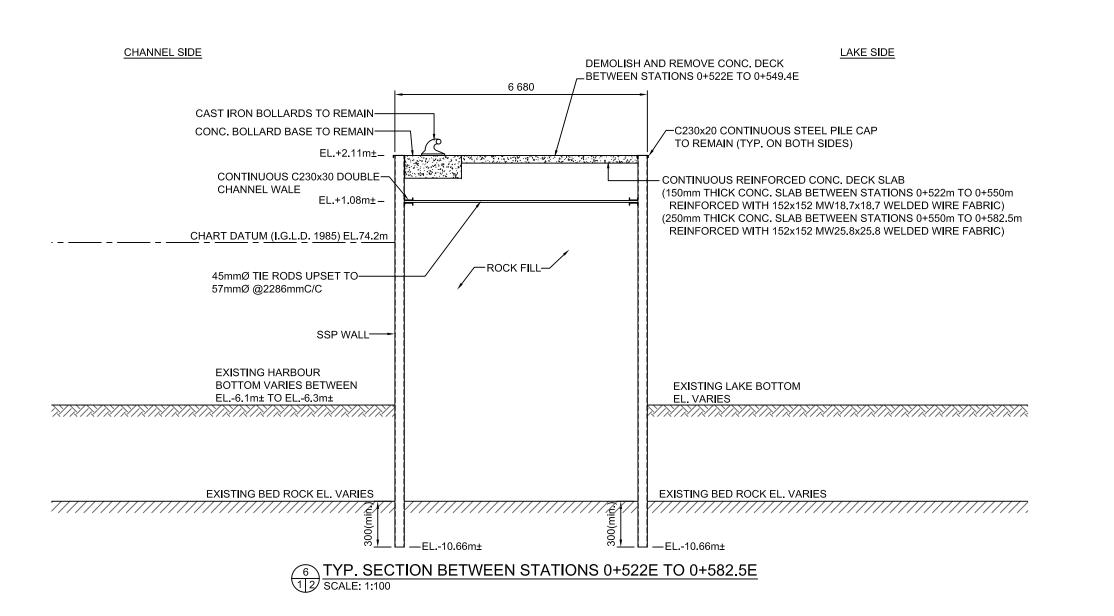

GOVERNMENT **FISHERIES**

DU CANADA **PECHES** AND OCEANS ET OCÉANS

GOUVERNEMENT

SMALL CRAFT HARBOURS CENTRAL AND ARCTIC REGION






Riggs Engineering Ltd. 1240 Commissioners Rd. W, Suite 205 London, Ontario, N6K 1C7 Tel: (519) 657-1040 Fax: (519) 657 8631 Website: www.riggsengineering.com

1 Detail No.

drawing no. — where detail required refers to MA— 3 drawing no. — where detailed refers to MA—

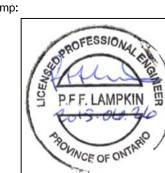

NOTES:

REVISIONS:	DATE:		
SCALE:		CLASS:	
AS N	OTED		

PROJECT:

WHITBY HARBOUR WHARF REPAIRS

DESCRIPTION: EAST SIDE **EXISTING TYP. SECTIONS,**


DRAWN: APPROVED: $\mathsf{A}.\mathsf{M}$ DATE: 2015-06-25 2015-06-25


DEMOLITION AND REMOVALS


LOCATION:


WHITBY, ONTARIO

LOCATOR CODE: DRAWING NO.: 721422

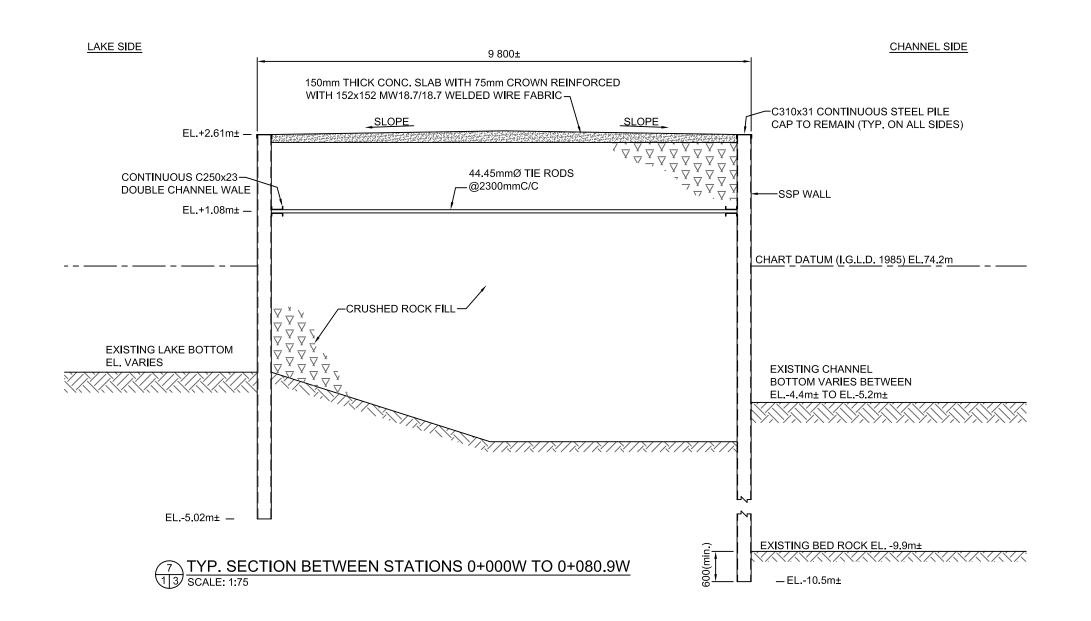

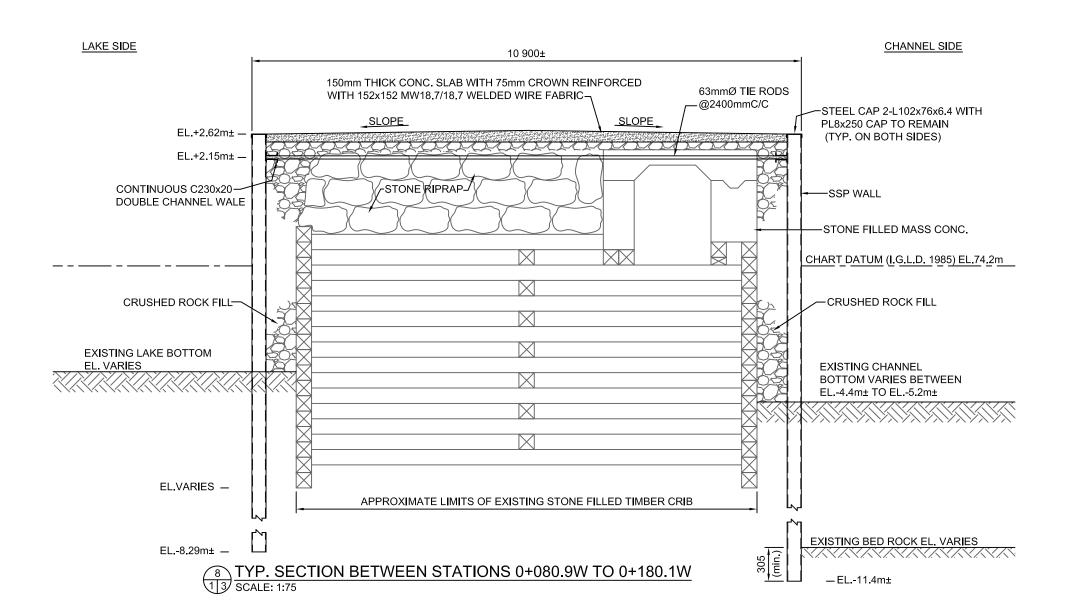

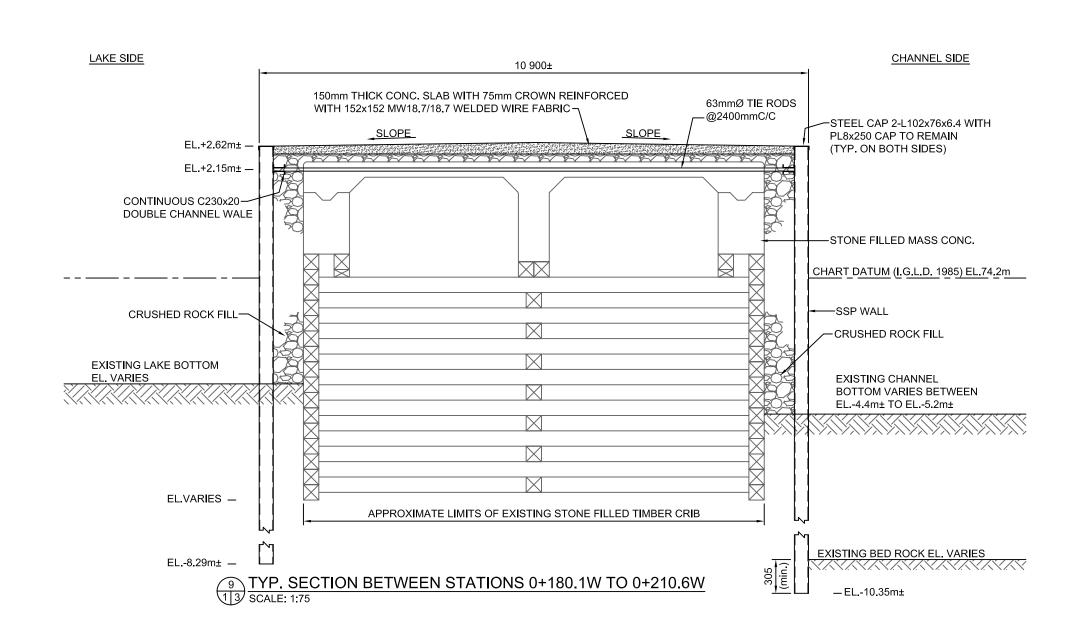

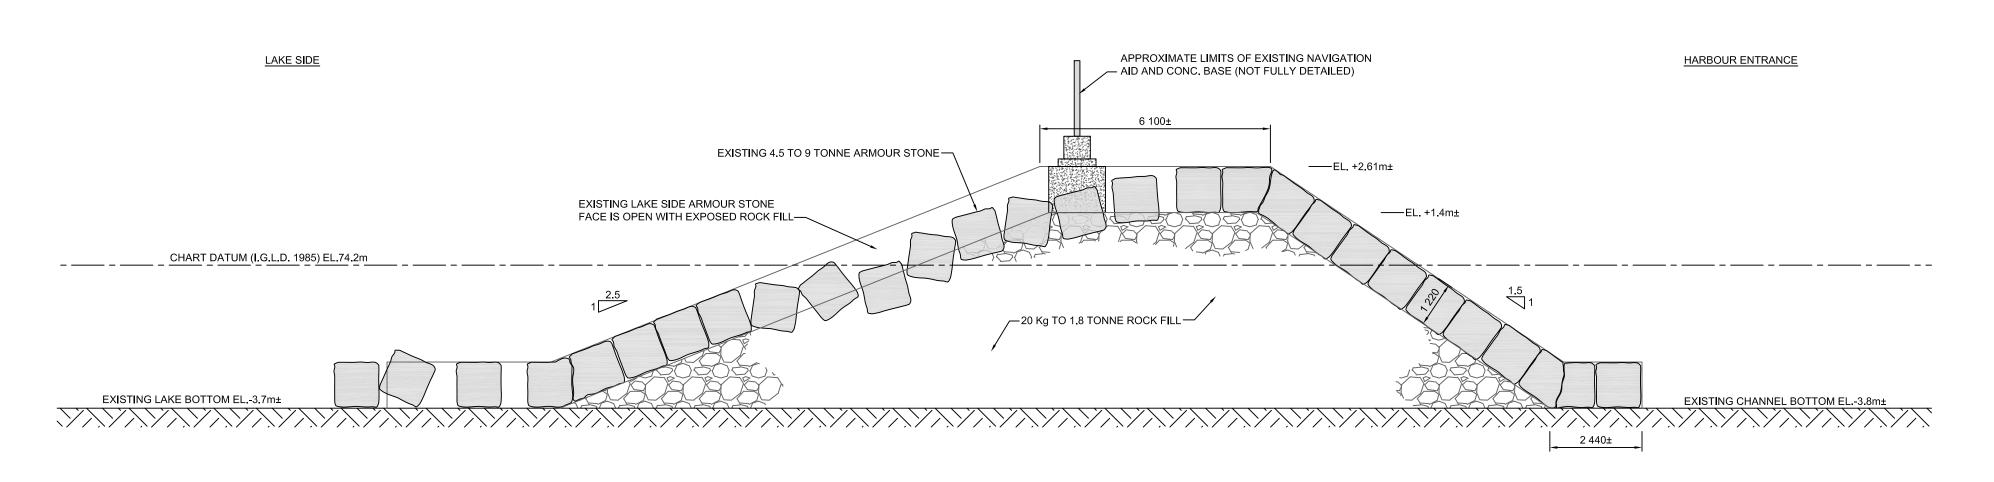

TYP. SECTION BETWEEN STATIONS 0+210.6W TO 0+292.3W SCALE: 1:100

GOVERNMENT **FISHERIES**

DU CANADA **PECHES** ET OCÉANS AND OCEANS

GOUVERNEMENT

SMALL CRAFT HARBOURS CENTRAL AND ARCTIC REGION





Riggs Engineering Ltd. 1240 Commissioners Rd. W, Suite 205 London, Ontario, N6K 1C7 Tel: (519) 657-1040 Fax: (519) 657 8631 Website: www.riggsengineering.com

1 Detail No.

2 drawing no. — where detail required refers to MA— 3 drawing no. — where detailed refers to MA—

NOTES:

REV	ISIONS:		DATE:
SCALE:		CLASS:	
	AS NOTED		

PROJECT:

WHITBY HARBOUR WHARF REPAIRS


DESCRIPTION: WEST SIDE EXISTING TYP. SECTIONS, **DEMOLITION AND REMOVALS**

DRAWN:	APPROVED:
A.M	P.L.
DATE:	DATE:
2015-06-25	2015-06-25


LOCATION:

WHITBY, ONTARIO


LOCATOR CODE: DRAWING NO.: S-03 721422

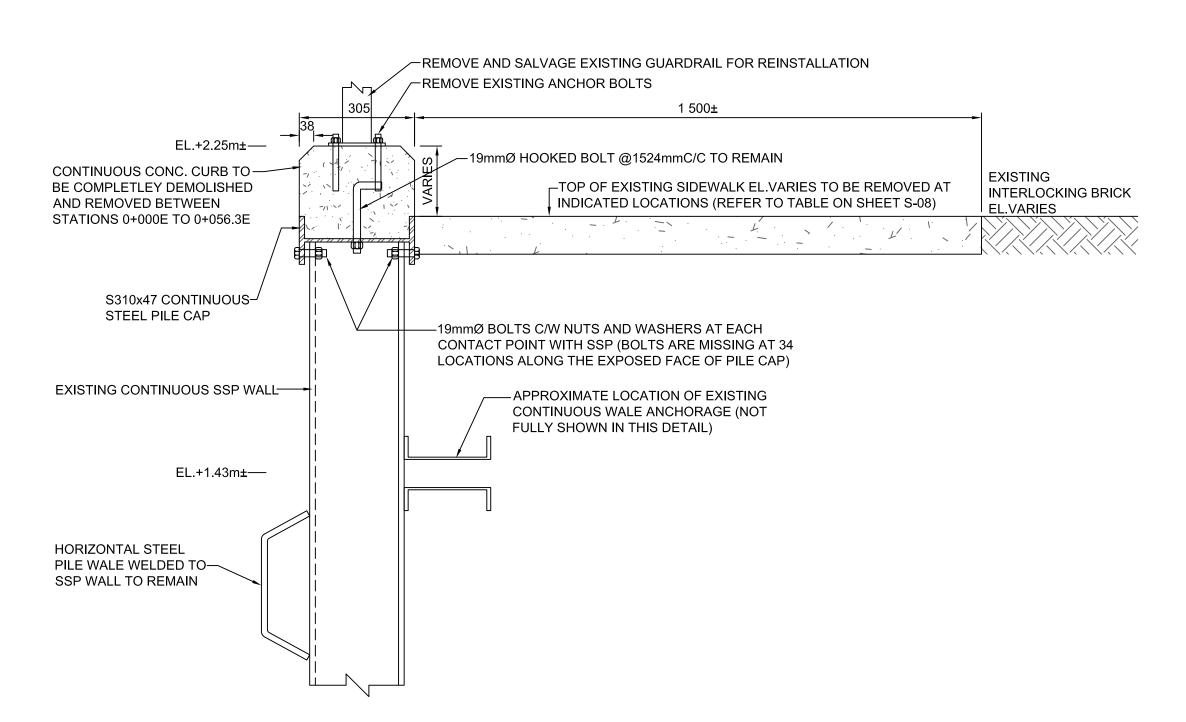

TYP. EXISTING CONC. PARAPET DETAIL (STATIONS 0+000E TO 0+134.9E)
SCALE: 1:10

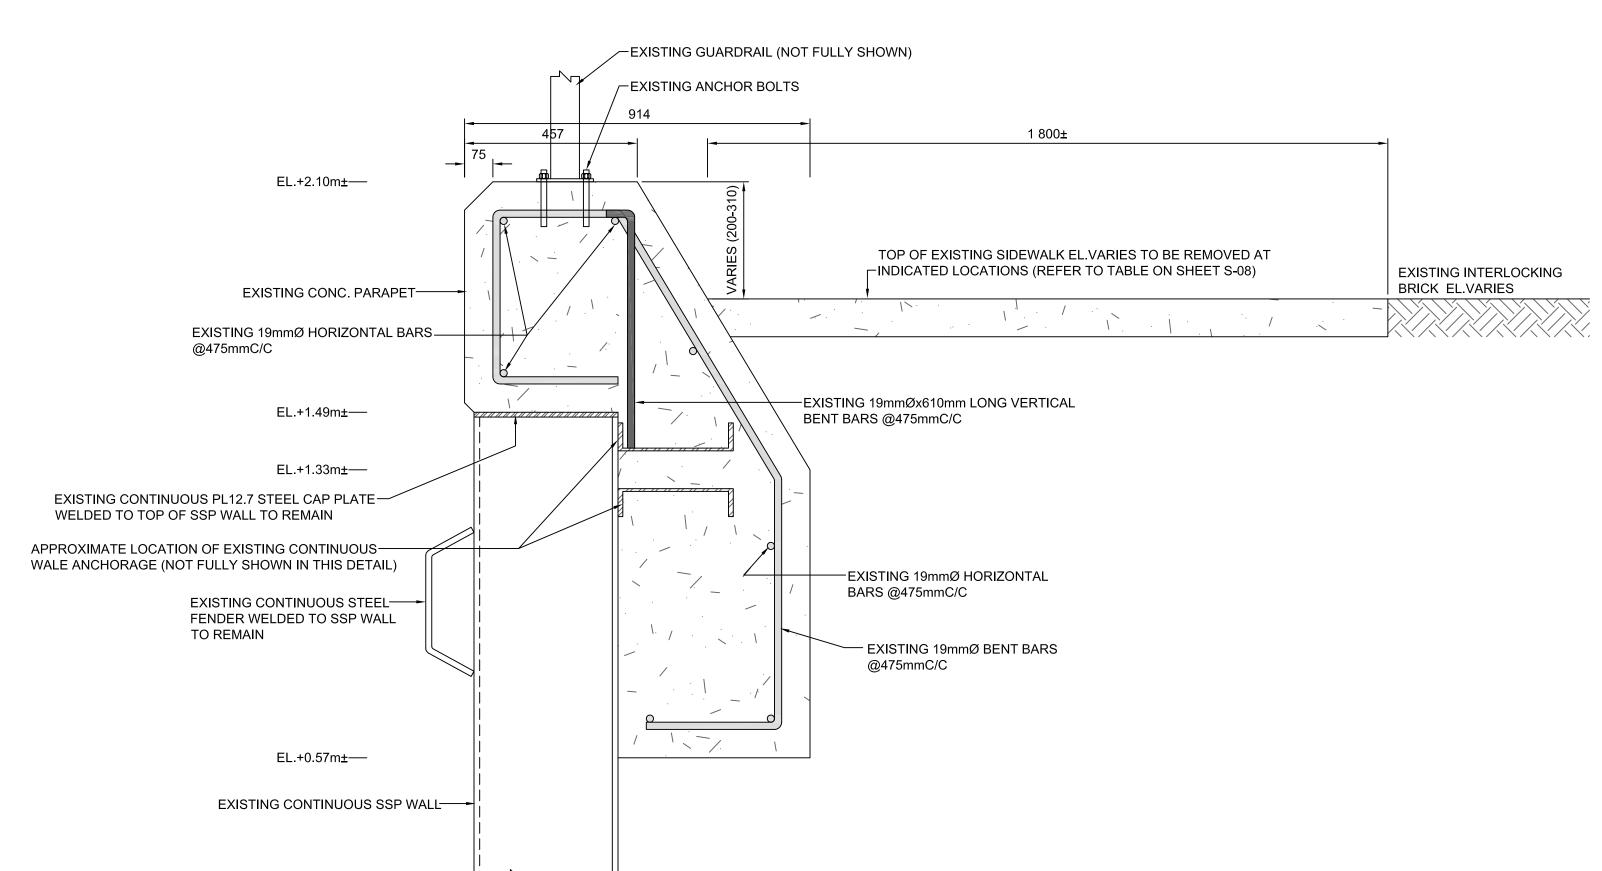

TYP. CONC. PARAPET DETAIL (STATIONS 0+187.4E TO 0+369.2±E)
SCALE: 1:10

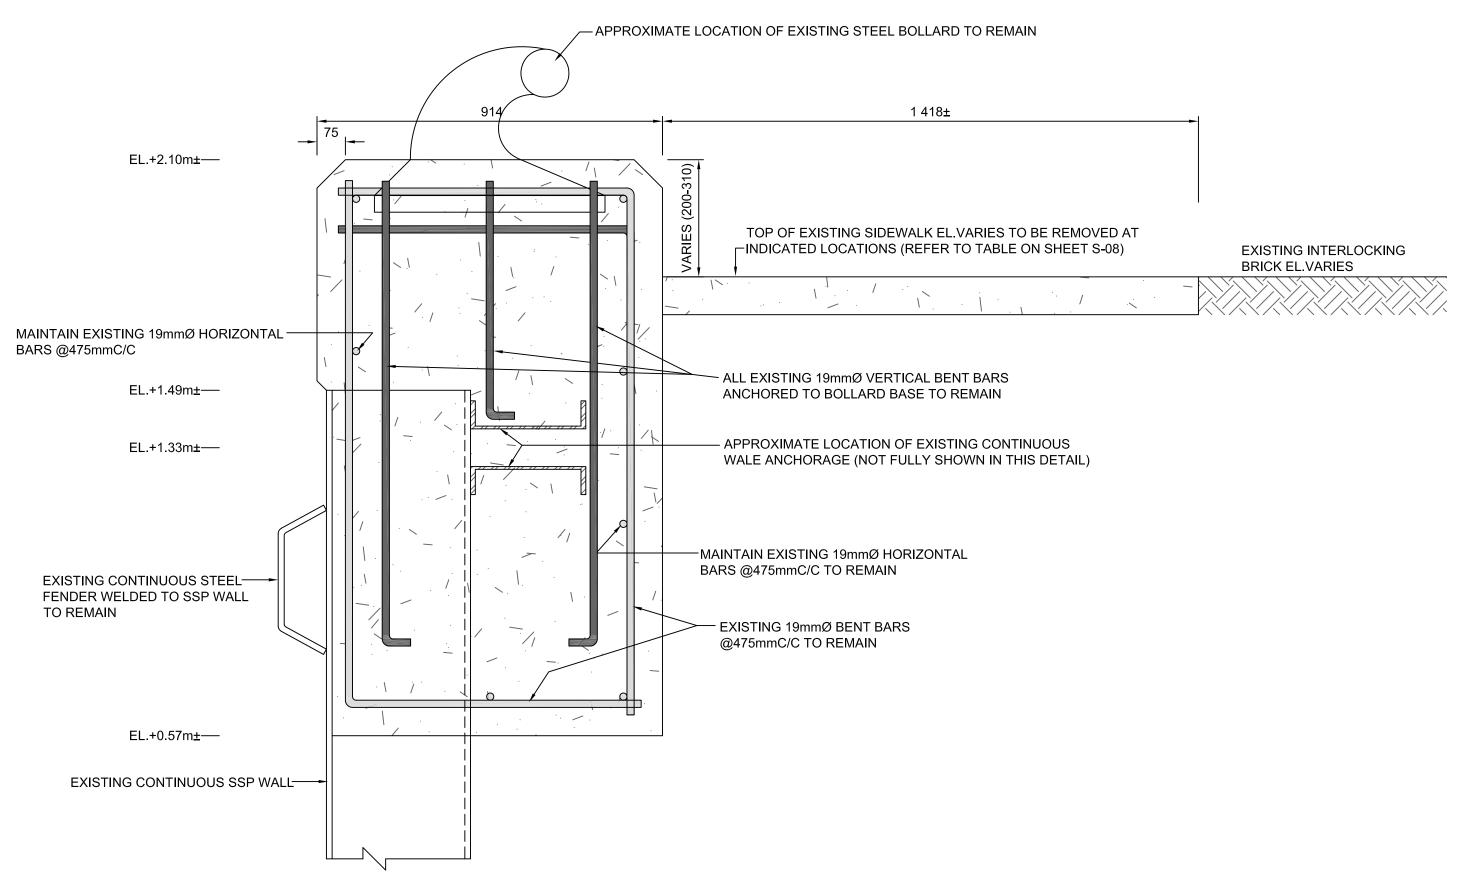

TYP. CONC. PARAPET DETAIL AT BOLLARD LOCATIONS (STATIONS 0+187.4E TO 0+369.2±E)
SCALE: 1:10



GOUVERNEMENT DU CANADA

PECHES AND OCEANS ET OCÉANS

SMALL CRAFT HARBOURS CENTRAL AND ARCTIC REGION





Riggs Engineering Ltd. 1240 Commissioners Rd. W, Suite 205 London, Ontario, N6K 1C7 Tel: (519) 657-1040 Fax: (519) 657 8631 Website: www.riggsengineering.com

1 Detail No.

2 drawing no. — where detail required refers to MA—
3 drawing no. — where detailed refers to MA—

REVISIONS:	DATE:	
SCALE:	CLASS:	
AS NOTED		

PROJECT:

WHITBY HARBOUR WHARF REPAIRS

DESCRIPTION:


TYP. EXISTING DETAILS, **DEMOLITION AND REMOVALS**


DRAWN:	APPROVED:
A.M	P.L.
DATE:	DATE:
2015-06-25	2015-06-25

LOCATION:


WHITBY, ONTARIO

LOCATOR CODE: DRAWING NO.: 721422

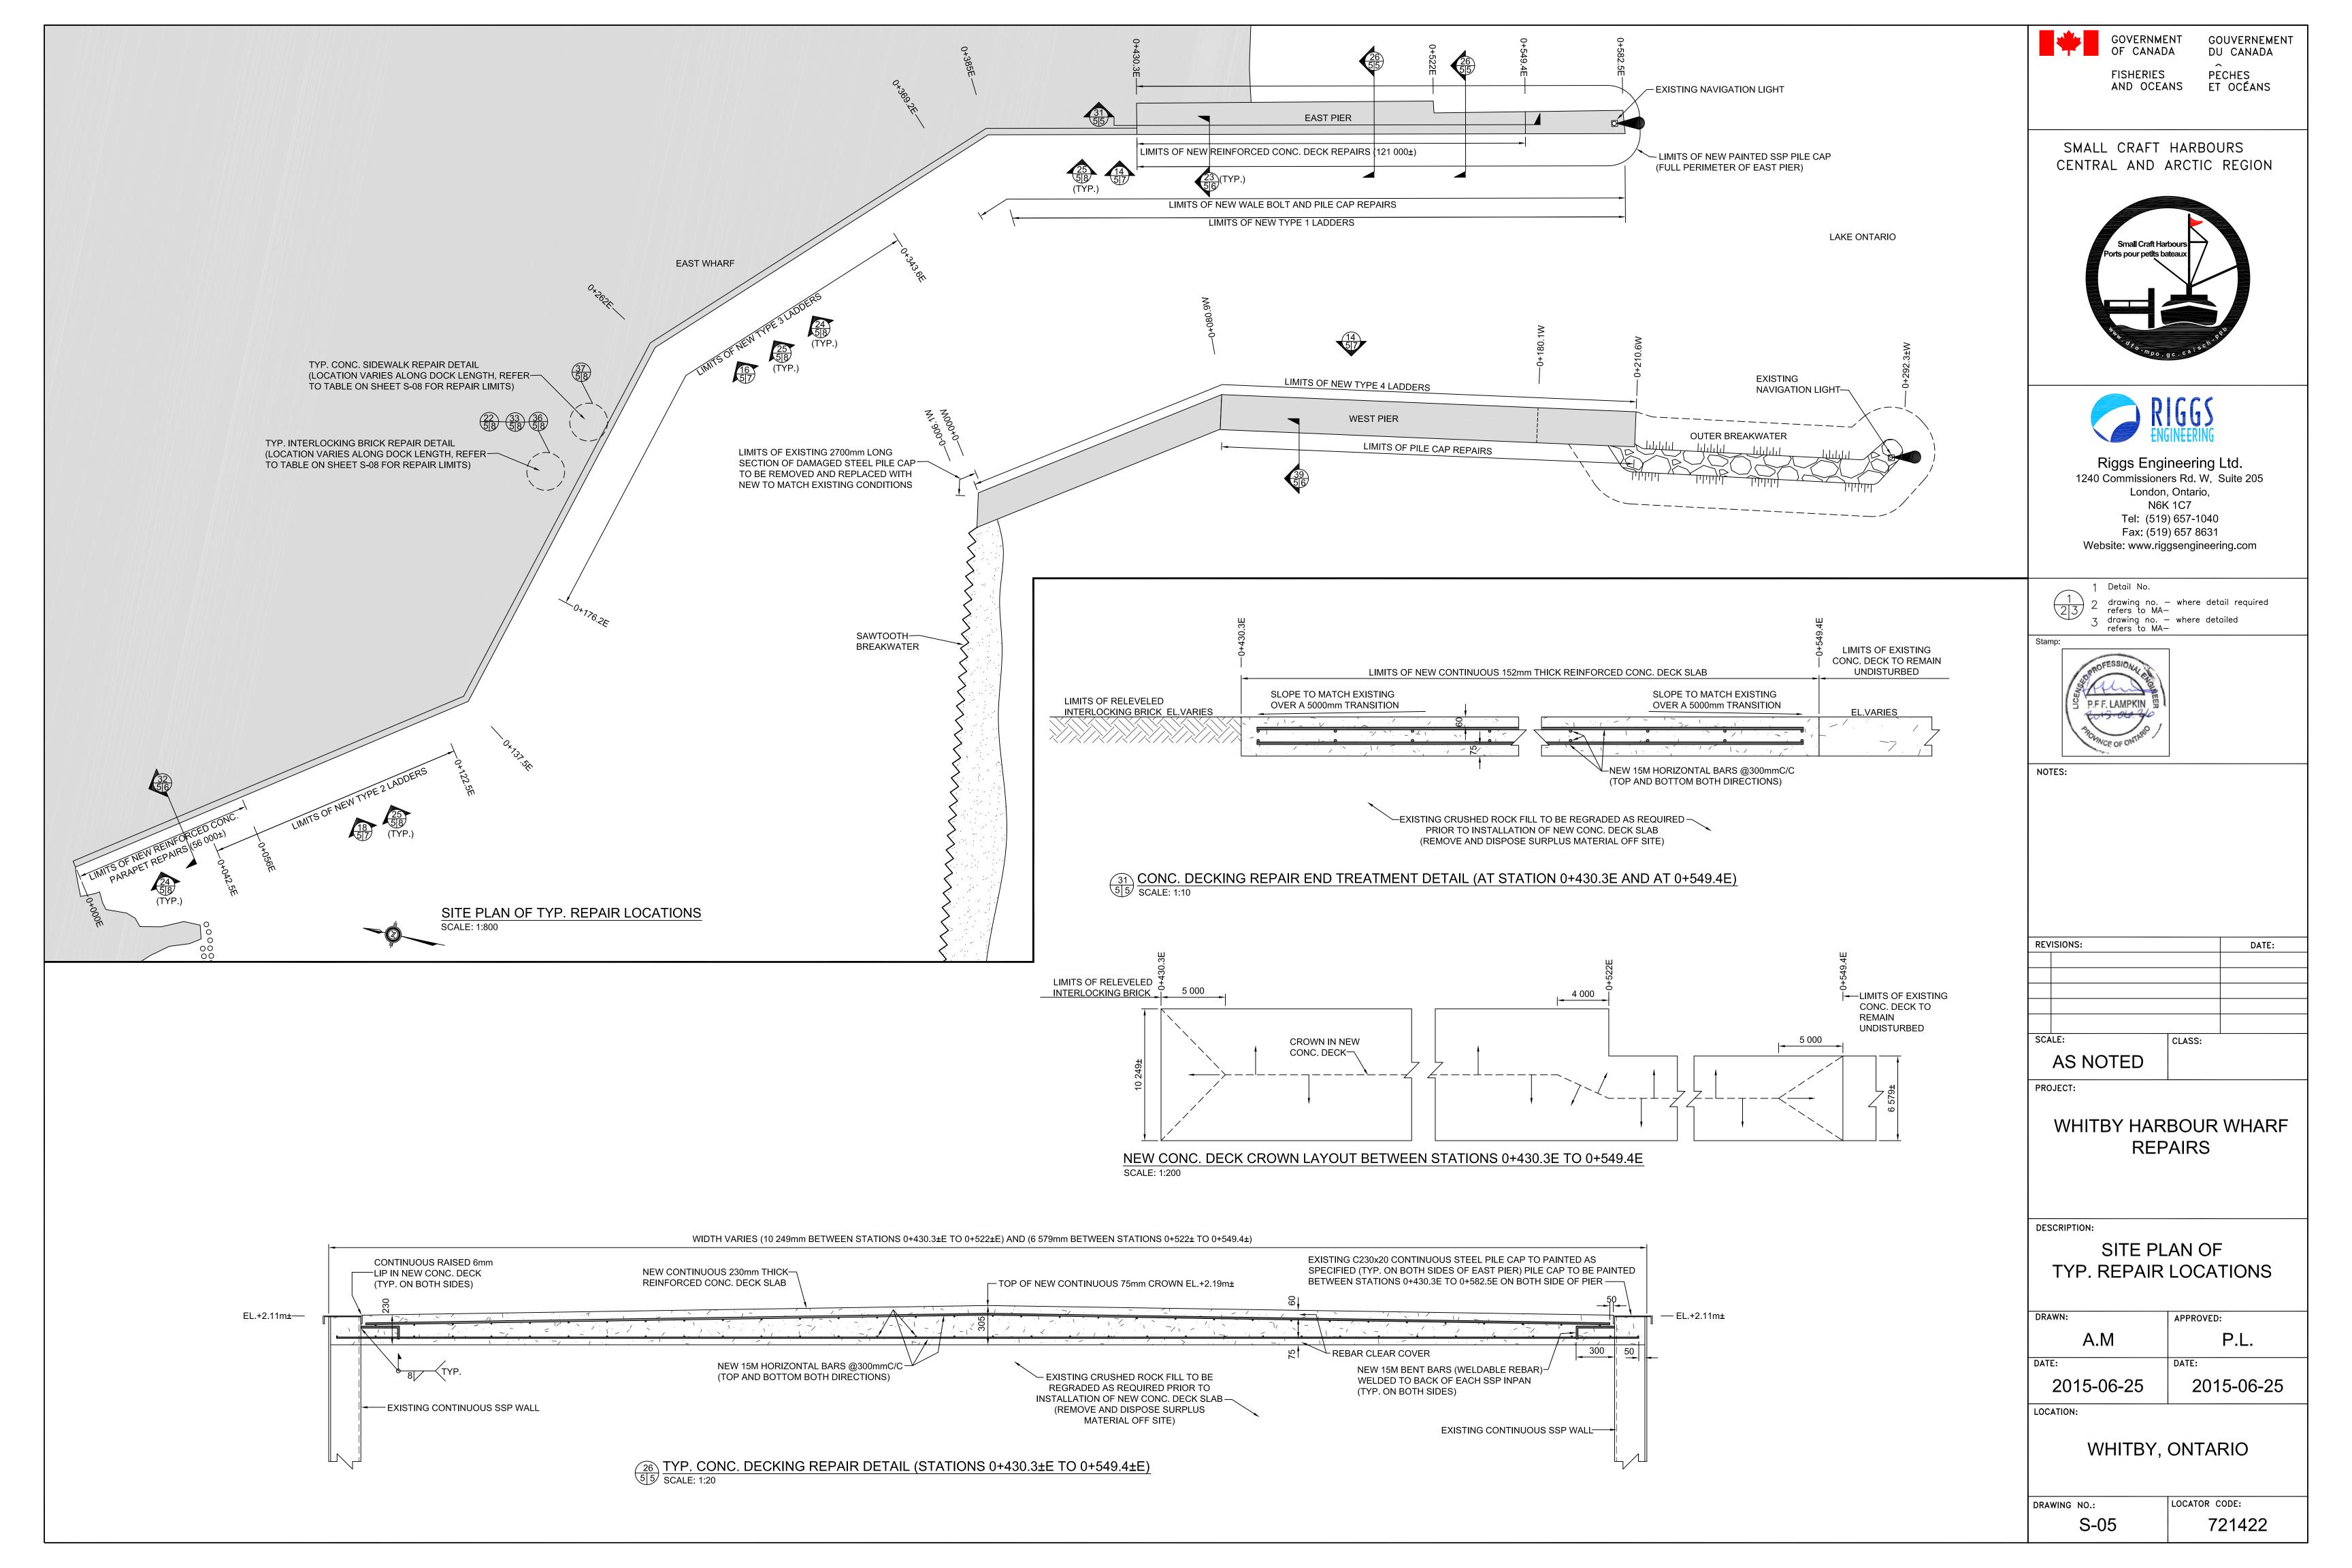

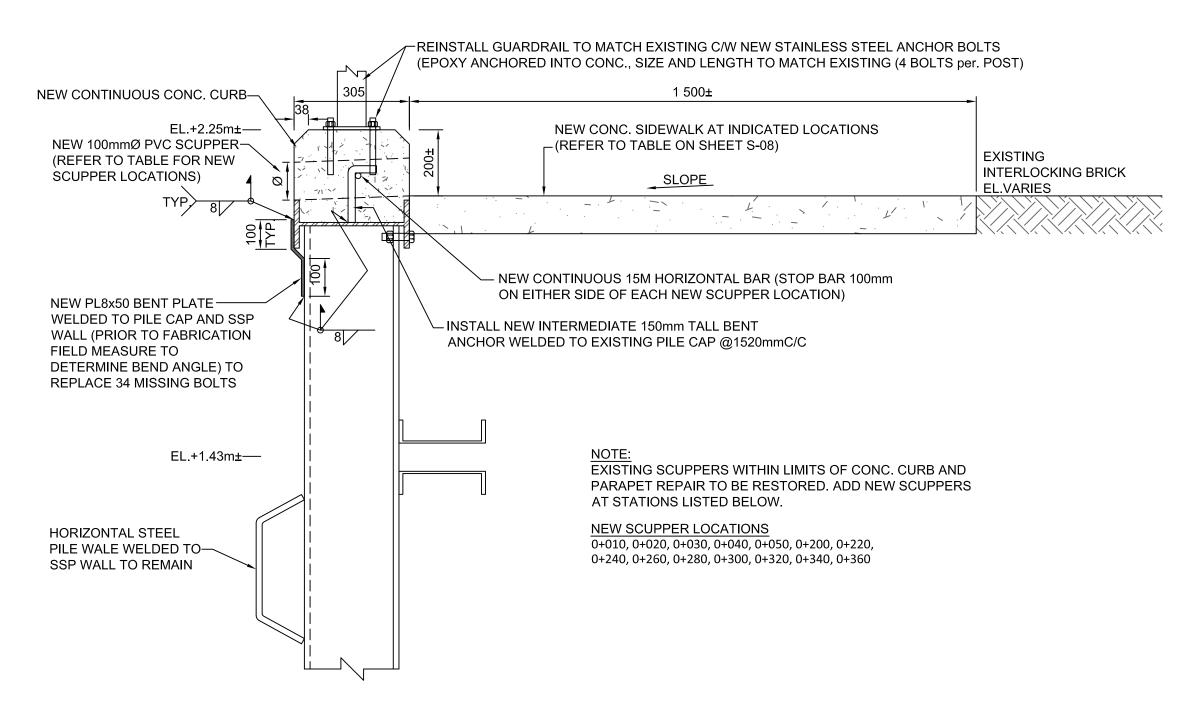


TYP. CONC. PARAPET REPAIR AND STEEL STRAP DETAIL (STATIONS 0+000E TO 0+056±E)
SCALE: 1:10

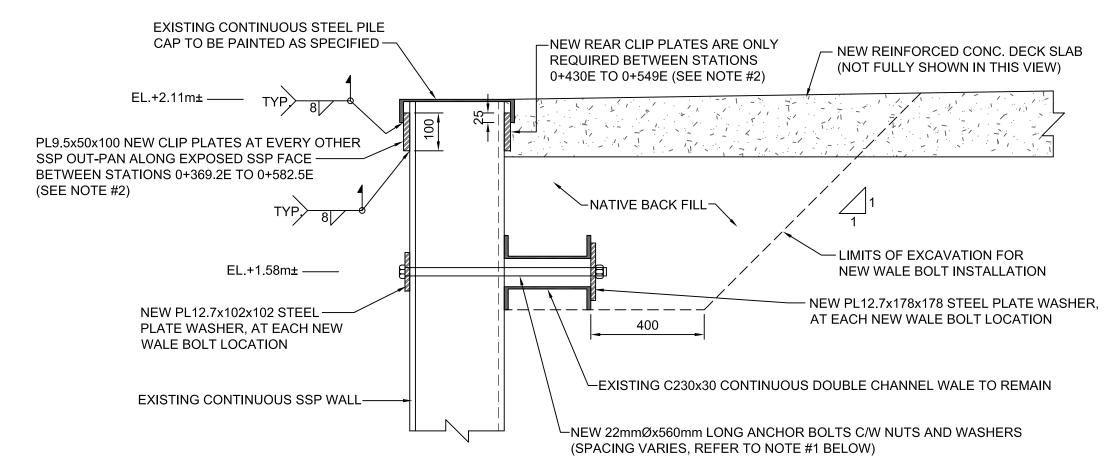

NOTE:
1) NEW WALE BOLT REPAIRS ARE REQUIRED AT STATIONS 0+466.5E, 0+467.5E, 0+519.5E.
2) NEW SPACER PLATES ARE REQUIRED BETWEEN STATIONS 0+369.2E TO 0+582.5E.

23 TYP. WALE BOLT AND SSP PILE CAP REPAIR DETAIL (EAST SIDE)

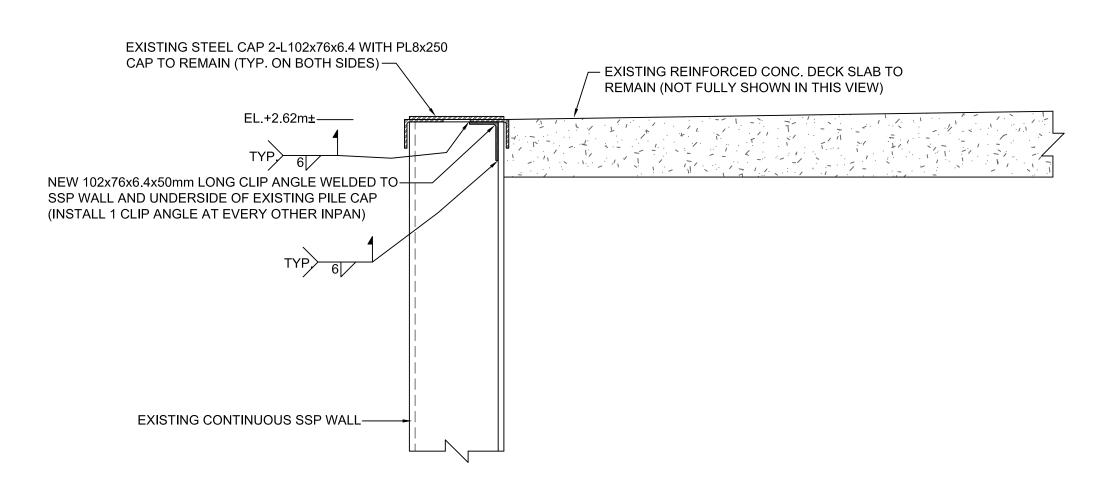

TYP. SSP PILE CAP REPAIR DETAIL (WEST PIER 0+080.9W TO 0+210.6W)
SCALE: 1:10

GOVERNMENT

DU CANADA **PECHES**

GOUVERNEMENT

FISHERIES ET OCÉANS AND OCEANS

SMALL CRAFT HARBOURS CENTRAL AND ARCTIC REGION





Riggs Engineering Ltd. 1240 Commissioners Rd. W, Suite 205 London, Ontario, N6K 1C7 Tel: (519) 657-1040 Fax: (519) 657 8631 Website: www.riggsengineering.com

1 Detail No.

2 drawing no. — where detail required refers to MA—
3 drawing no. — where detailed refers to MA—



NOTES:

REVISIONS:			DATE:		
SCALE:			CLASS:		
AS N	NOTED				

PROJECT:

WHITBY HARBOUR WHARF REPAIRS

DESCRIPTION:


TYP. REPAIR DETAILS

DRAWN:	APPROVED:
A.M	P.L.
DATE:	DATE:
2015-06-25	2015-06-25
The state of the s	


LOCATION:

WHITBY, ONTARIO


LOCATOR CODE: DRAWING NO.: S-06 721422

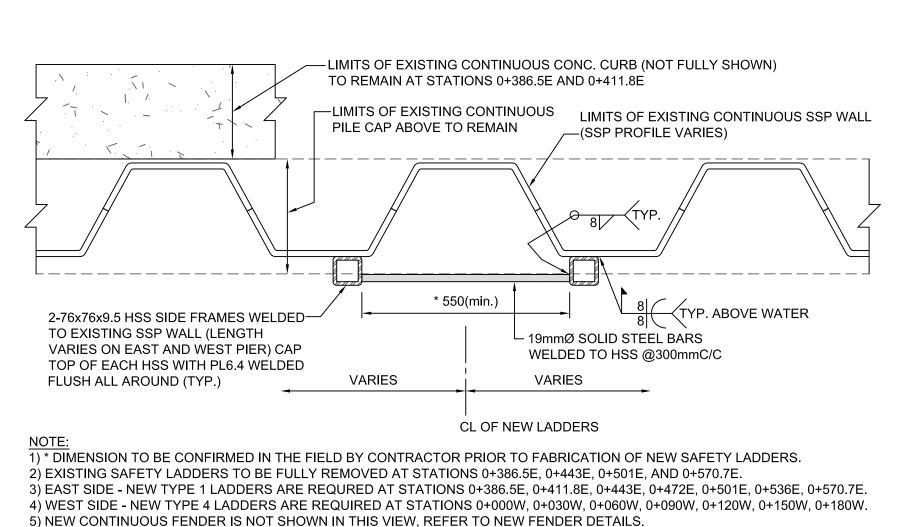

(TYPE 1 & 4) NEW LADDER TYP. PLAN DETAIL SCALE: 1:10

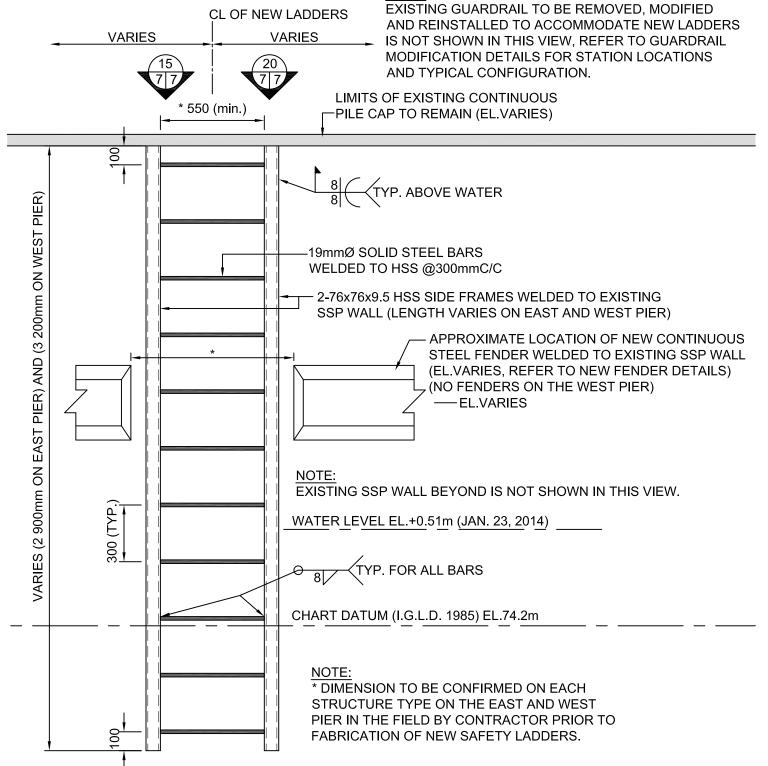


(TYPE 1 & 4) NEW LADDER TYP. ELEVATION DETAIL

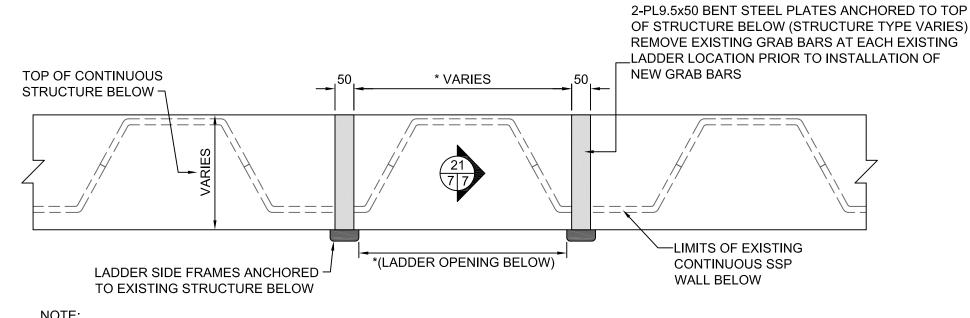


1) * DIMENSION TO BE CONFIRMED IN THE FIELD BY CONTRACTOR PRIOR TO FABRICATION OF NEW SAFETY LADDERS. 2) EXISTING GRAB BARS TO BE FULLY REMOVED AT STATIONS 0+176.2E, 0+282.6E, 0+343.6E, 0+443E, 0+501E, 0+570.7E. 3) NEW GRAB BARS ARE REQUIRED AT ALL NEW LADDER LOCATIONS ON EAST PIER AND WEST PIER.

 $\underbrace{\frac{20}{7|7}}_{\text{SCALE: 1:10}} \underbrace{\frac{\text{TYP. LADDER GRAB BAR PLAN DETAIL}}_{\text{SCALE: 1:10}}$

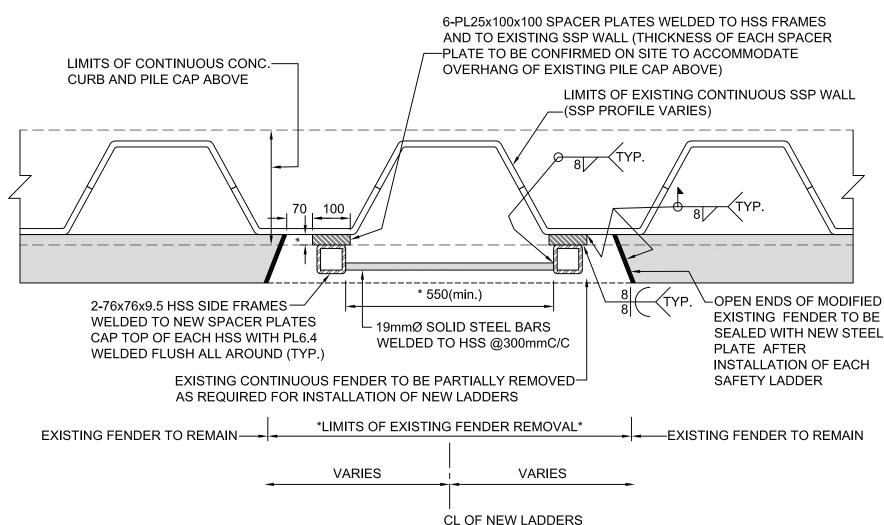


1) * DIMENSION TO BE CONFIRMED IN THE FIELD BY CONTRACTOR PRIOR TO FABRICATION OF NEW SAFETY LADDERS. 2) EXISTING FENDER MODIFICATIONS ARE REQUIRED AT STATIONS 0+042.5E, 0+082.5E AND 0+122.5E. 3) EAST SIDE - NEW TYPE 2 LADDERS ARE REQURED AT STATIONS 0+042.5E, 0+082.5E, 0+122.5E.


(TYPE 2) NEW LADDER TYP. PLAN DETAIL SCALE: 1:10

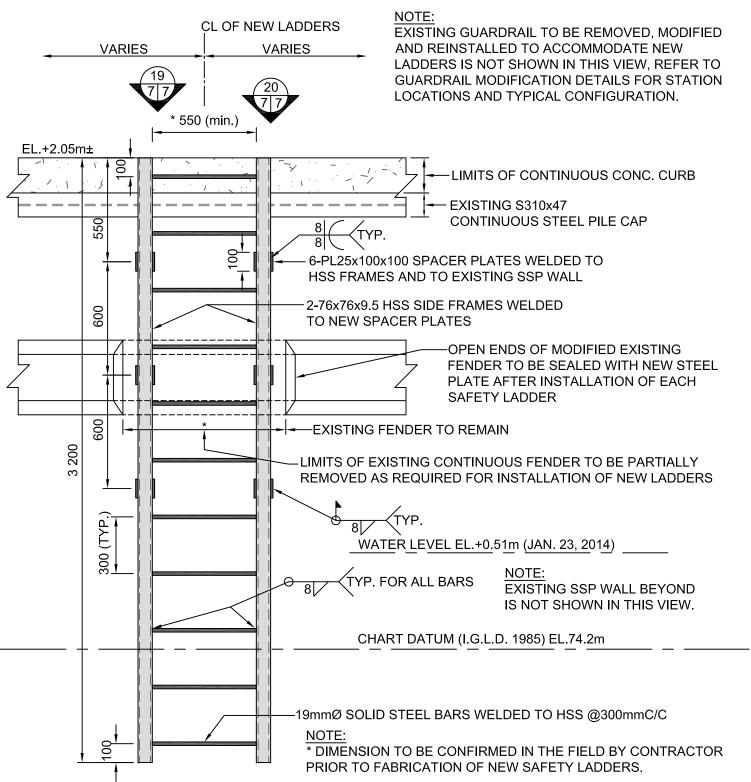


(TYPE 2) NEW LADDER TYP. ELEVATION DETAIL SCALE: 1:20

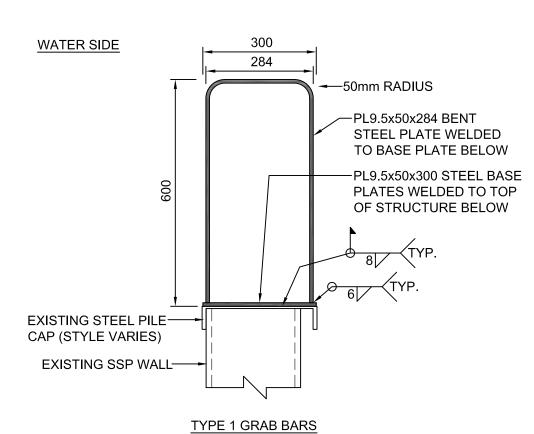

REQUIRED AT STATIONS 0+386.5E, 0+411.8E, 0+443E, 0+472E, 0+501E, 0+536E, 0+570.7E, 0+000W, 0+030W, 0+060W, 0+090W, 0+120W, 0+150W, 0+180W

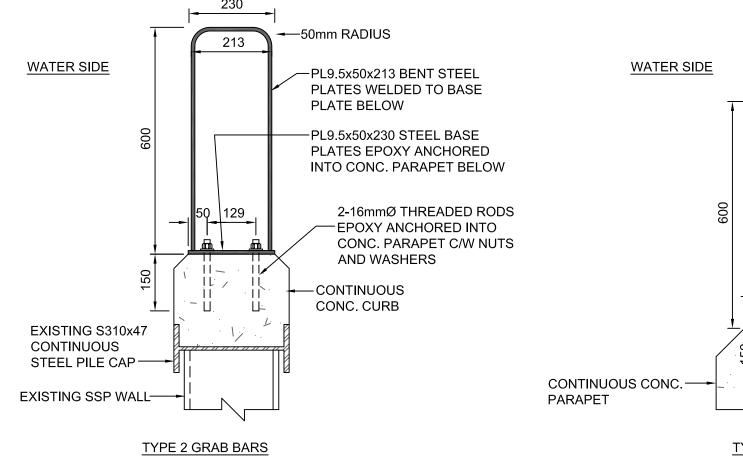

REQUIRED AT STATIONS 0+042.5E, 0+082.5E, 0+122.5E

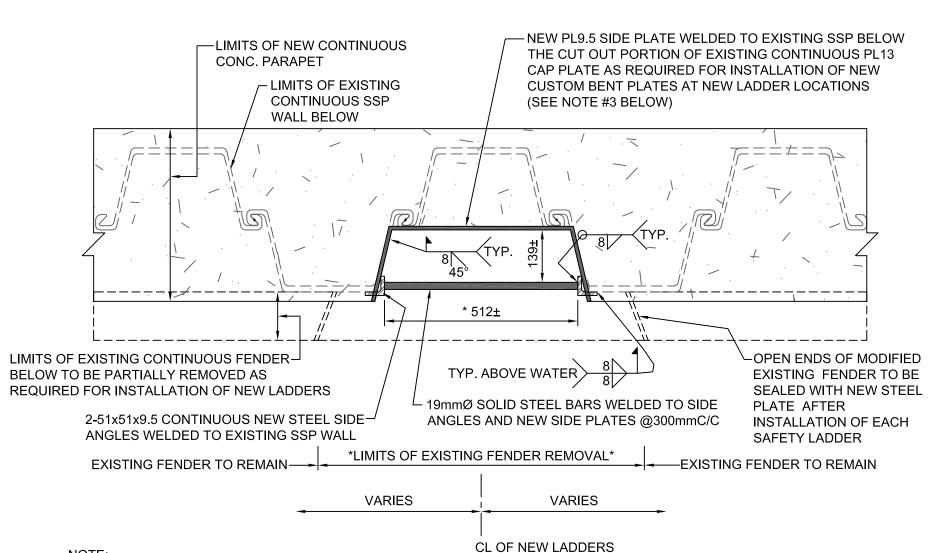


1) * DIMENSION TO BE CONFIRMED IN THE FIELD BY CONTRACTOR PRIOR TO FABRICATION OF NEW SAFETY LADDERS. 2) EXISTING FENDER MODIFICATIONS ARE REQUIRED AT STATIONS 0+211E, 0+246.4E, AND 0+311E.


3) NEW STEEL SIDE PLATES ARE ONLY REQUIRED AT STATIONS 0+211E, 0+246.4E, AND 0+311E.

4) EXISTING SAFETY LADDERS TO BE FULLY REMOVED AT STATIONS 0+176.2E, 0+246.4E, 0+282.6E, AND 0+343.6E. 5) EAST SIDE - NEW TYPE 3 LADDERS ARE REQURED AT STATIONS 0+176.2E, 0+211E, 0+246.4E, 0+282.6E, 0+311E, 0+343.6E.

17 (TYPE 3) NEW LADDER TYP. PLAN DETAIL 77 SCALE: 1:10

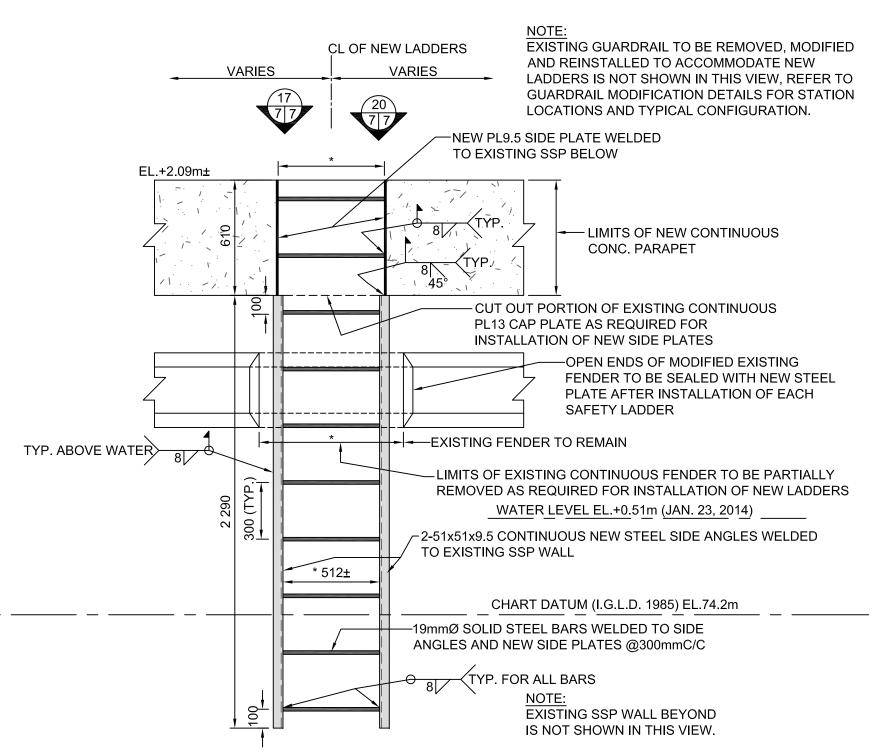

(TYPE 3) NEW LADDER TYP. ELEVATION DETAIL

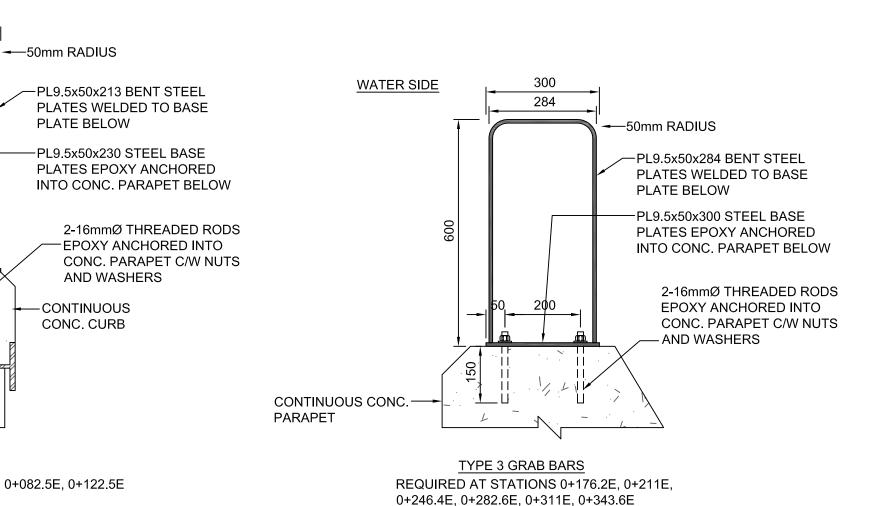

WHITBY HARBOUR WHARF

REPAIRS

DESCRIPTION:

TYP. LADDER REPAIR **DETAILS**

DRAWN:	APPROVED:
A.M	P.L.
DATE:	DATE:
2015-06-25	2015-06-25

LOCATION:

WHITBY, ONTARIO

LOCATOR CODE: DRAWING NO.: S-07 721422

 $\underbrace{ ^{21}_{7|7} }_{\text{SCALE: 1:10}} \underbrace{ \text{TYP. LADDER GRAB BAR CONNECTION DETAILS} }_{\text{SCALE: 1:10}}$

NEW LADDERS ARE NOT SHOWN IN THESE DETAILS.

FISHERIES PECHES AND OCEANS ET OCÉANS

GOVERNMENT

OF CANADA

GOUVERNEMENT

DU CANADA


SMALL CRAFT HARBOURS CENTRAL AND ARCTIC REGION






Riggs Engineering Ltd. 1240 Commissioners Rd. W, Suite 205 London, Ontario, N6K 1C7 Tel: (519) 657-1040 Fax: (519) 657 8631

Website: www.riggsengineering.com

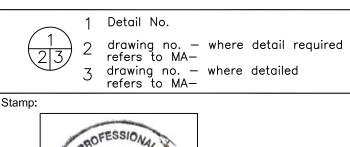


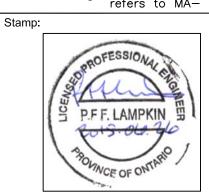

NOTES:

REVISIONS: DATE: SCALE: CLASS: AS NOTED

PROJECT:

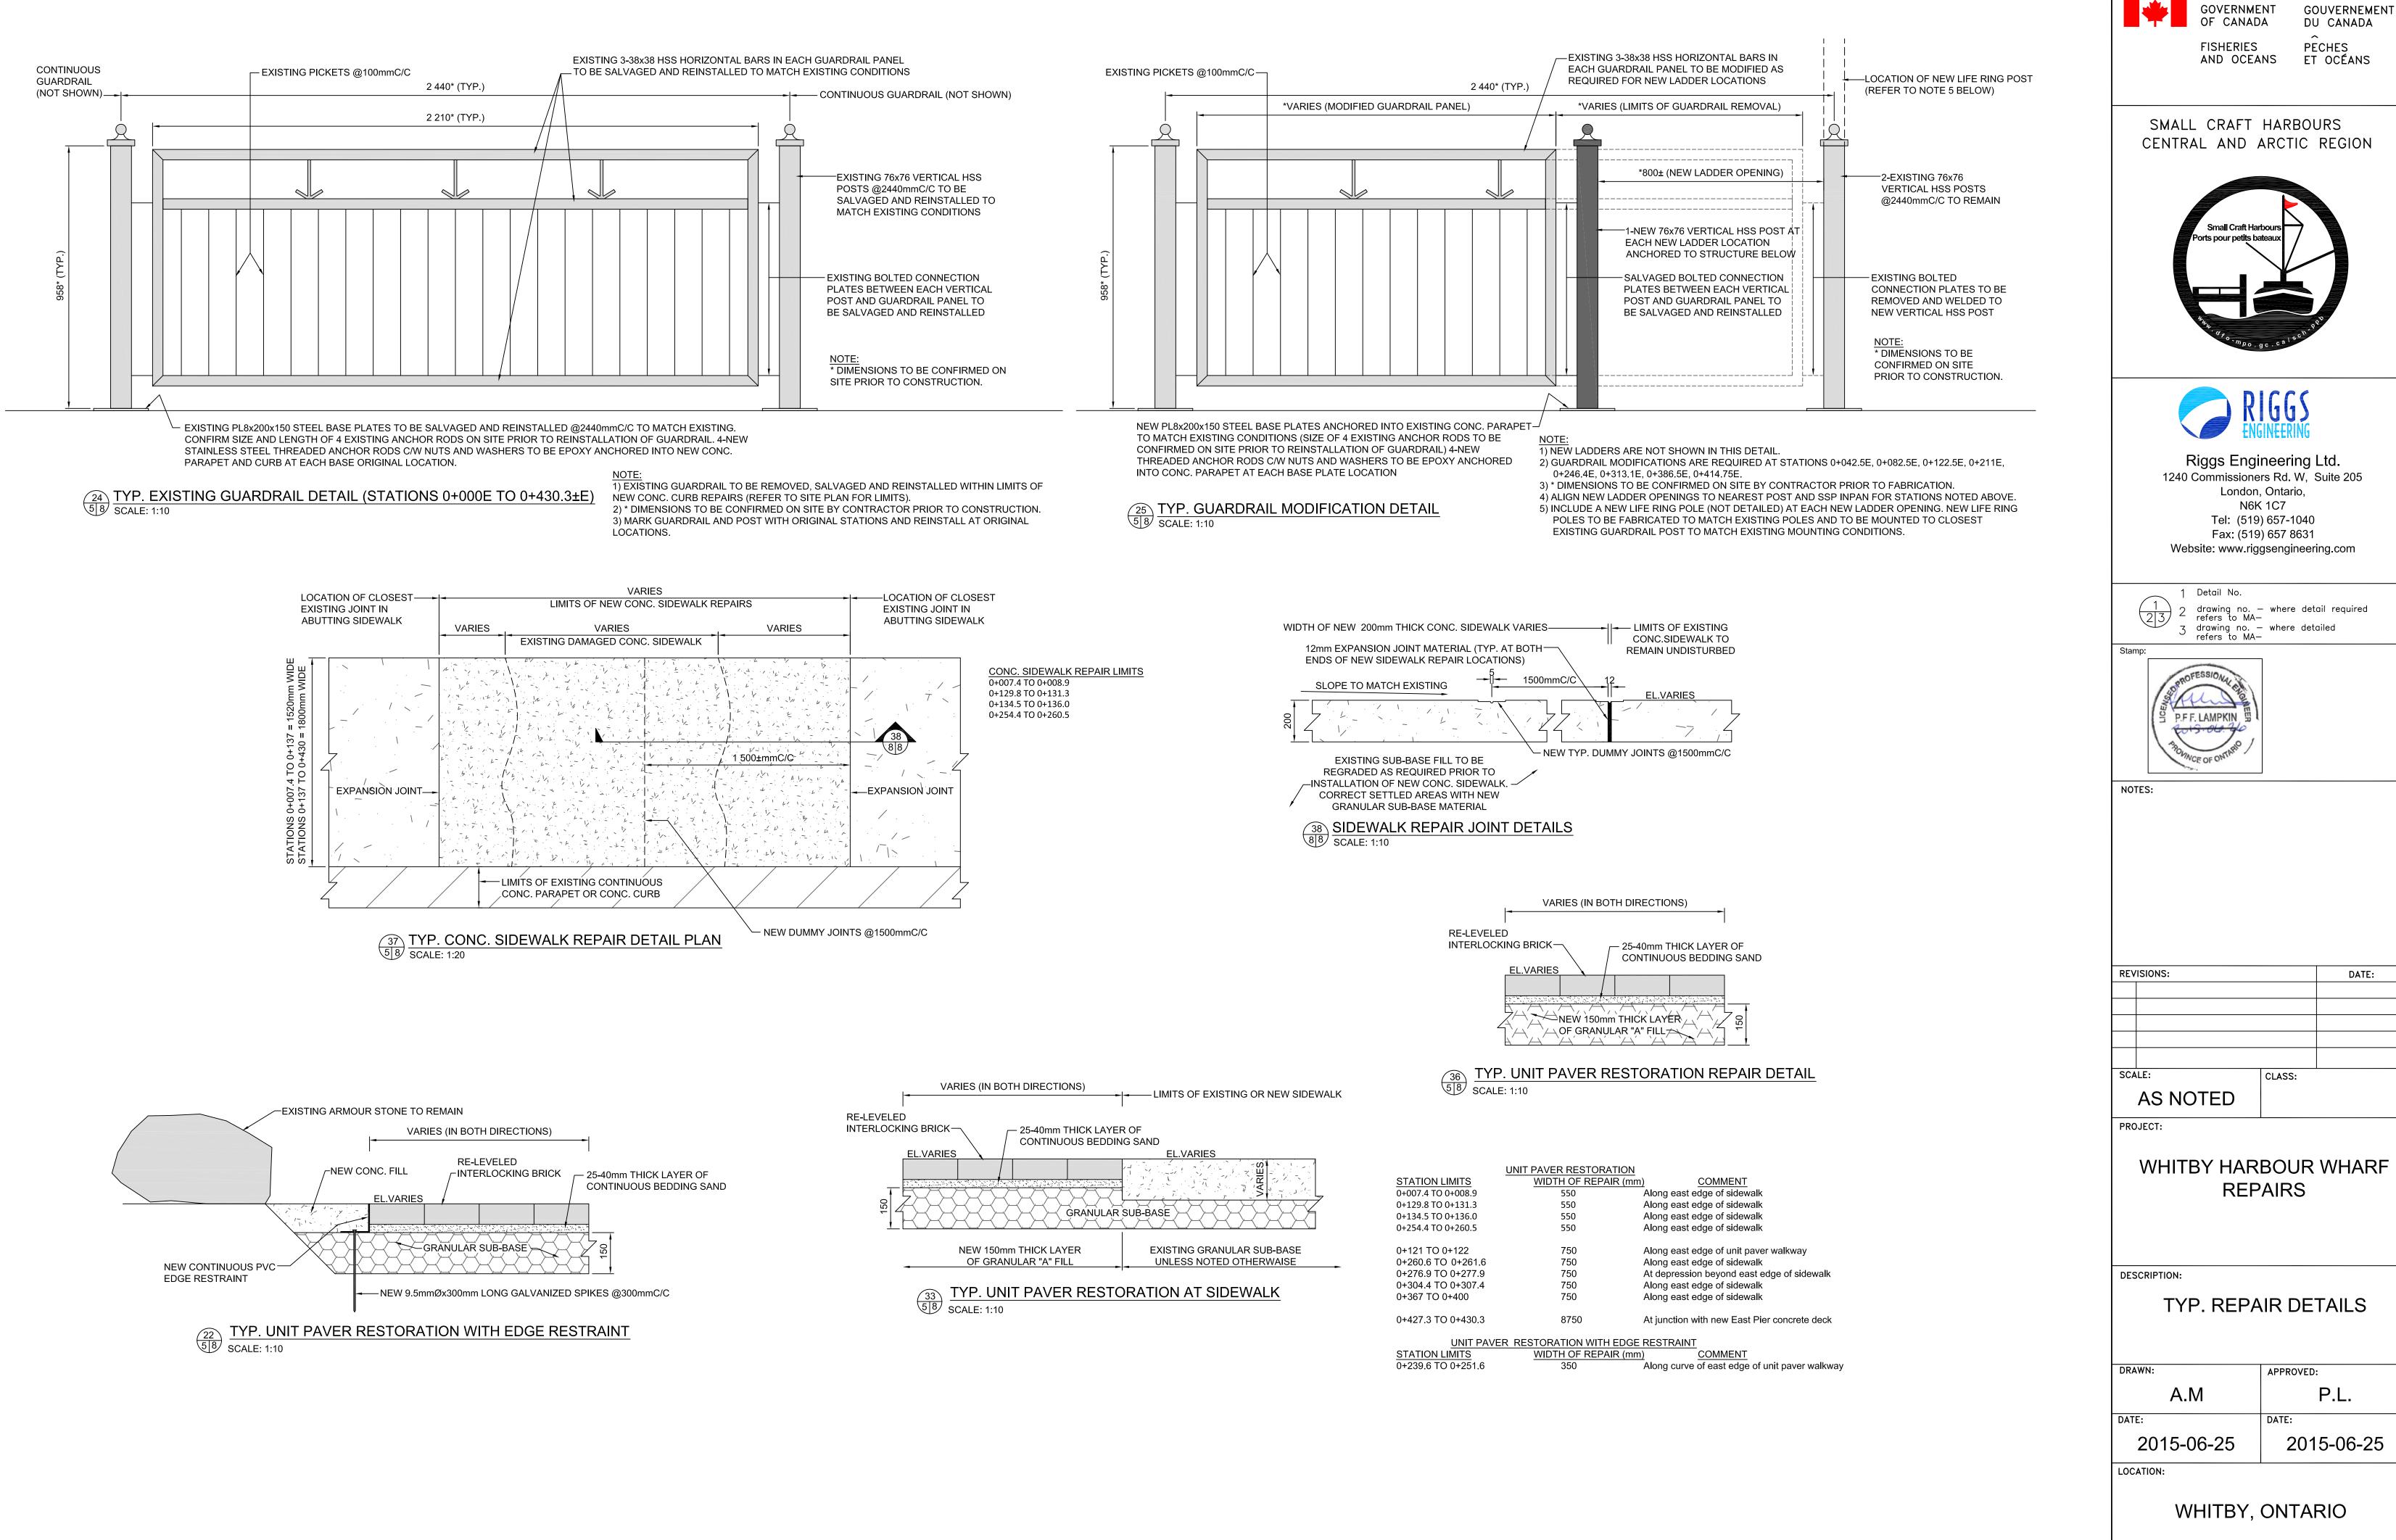

DU CANADA PECHES

ET OCÉANS

SMALL CRAFT HARBOURS



1240 Commissioners Rd. W, Suite 205

drawing no. — where detail required


REVISIONS:		DATE:
SCALE:	CLASS:	
AS NOTED		


WHITBY HARBOUR WHARF


DRAWN:	APPROVED:	
A.M	P.L.	
DATE:	DATE:	
2015-06-25	2015-06-25	
i i i i i i i i i i i i i i i i i i i		


WHITBY, ONTARIO


LOCATOR CODE: DRAWING NO.: 721422

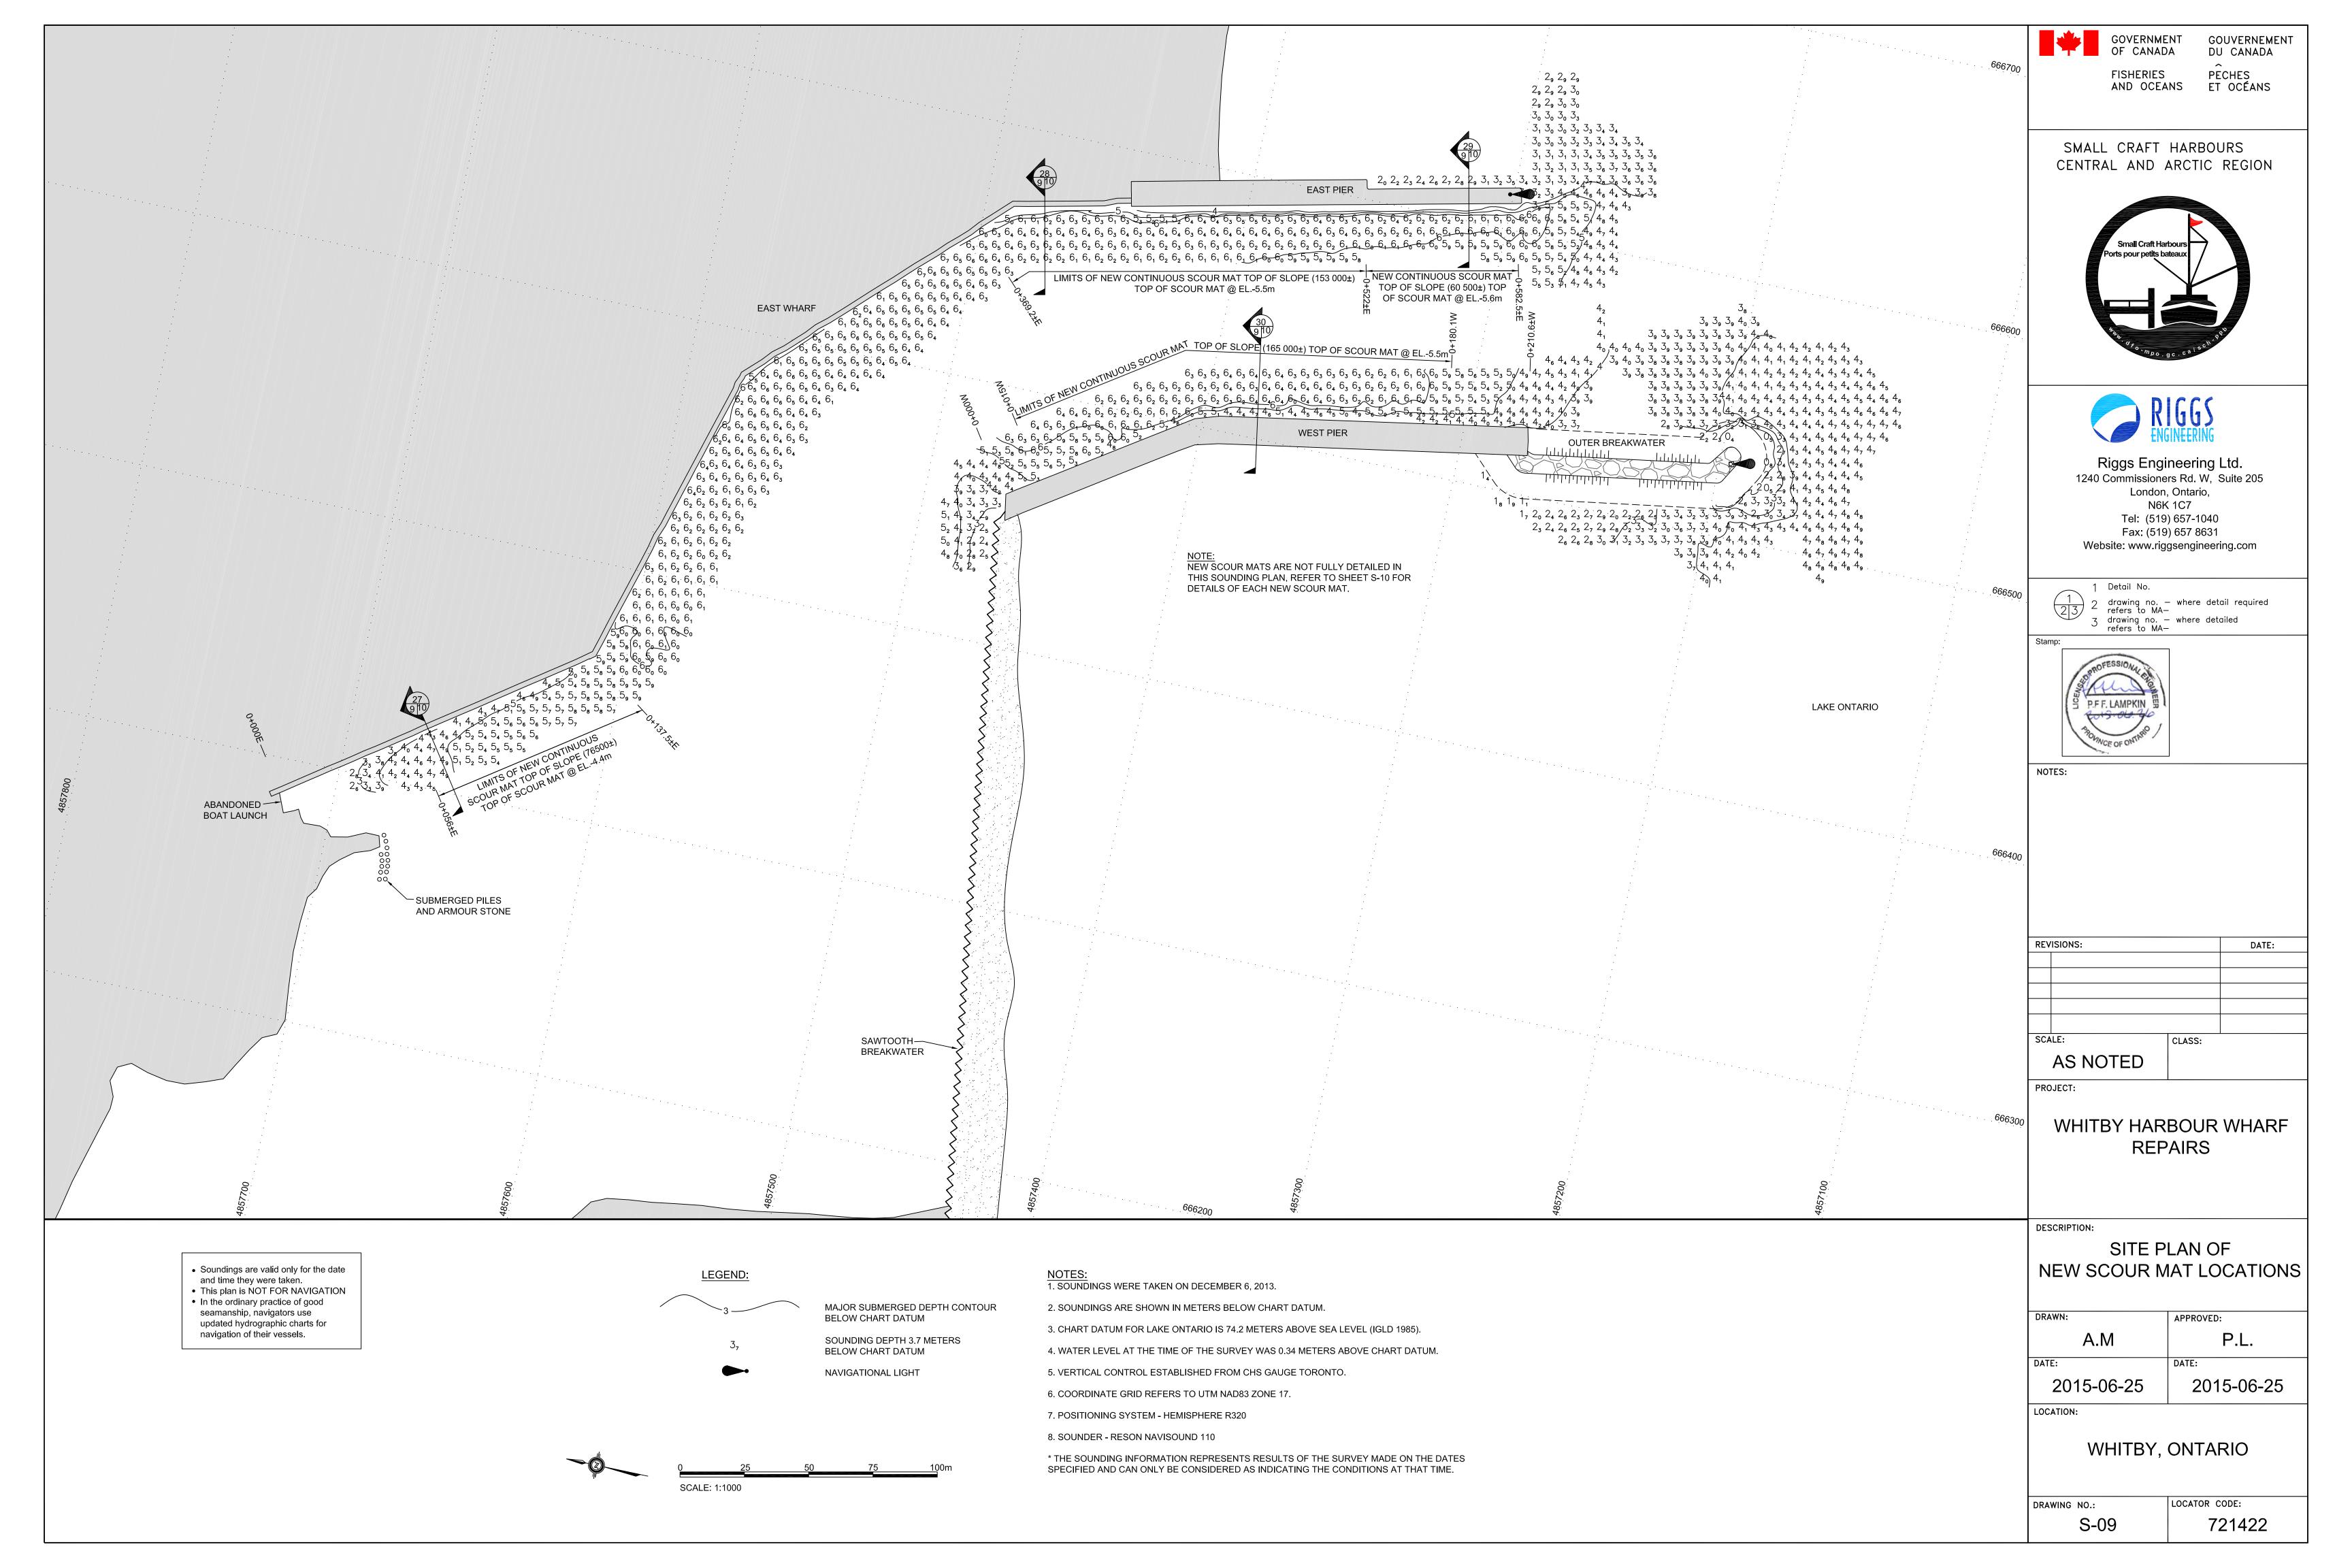

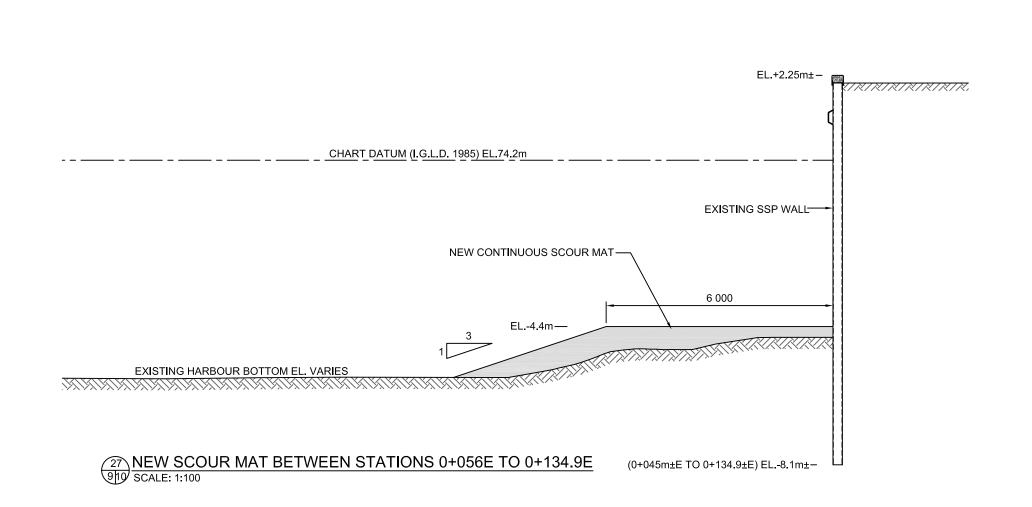

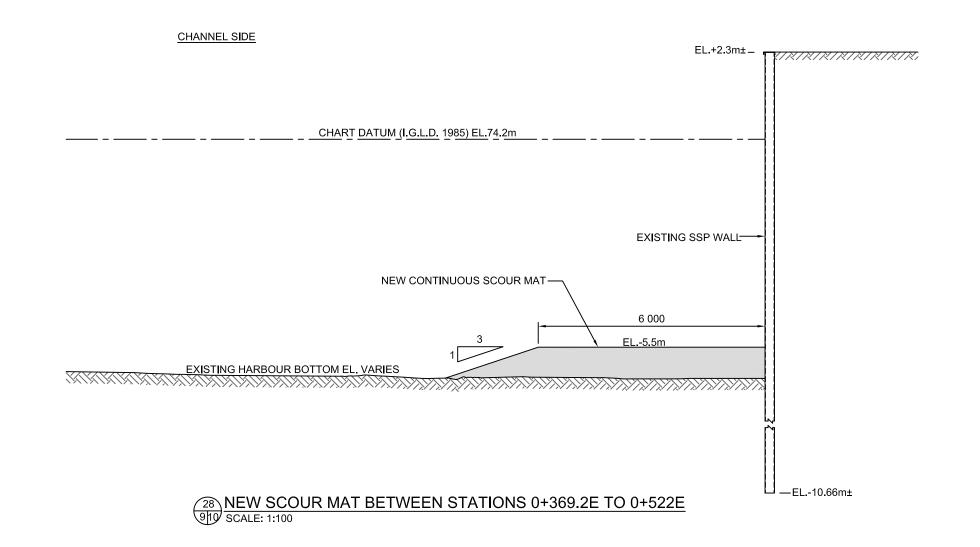

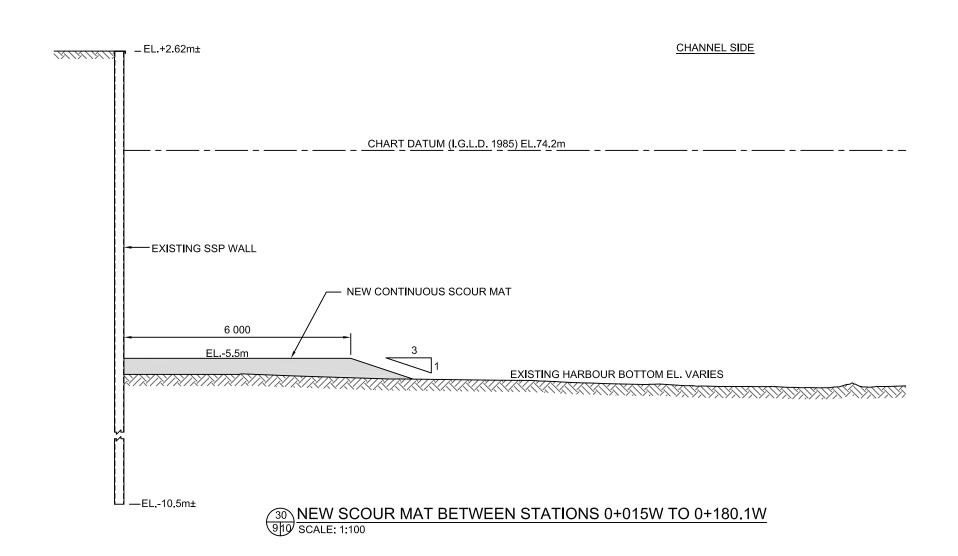

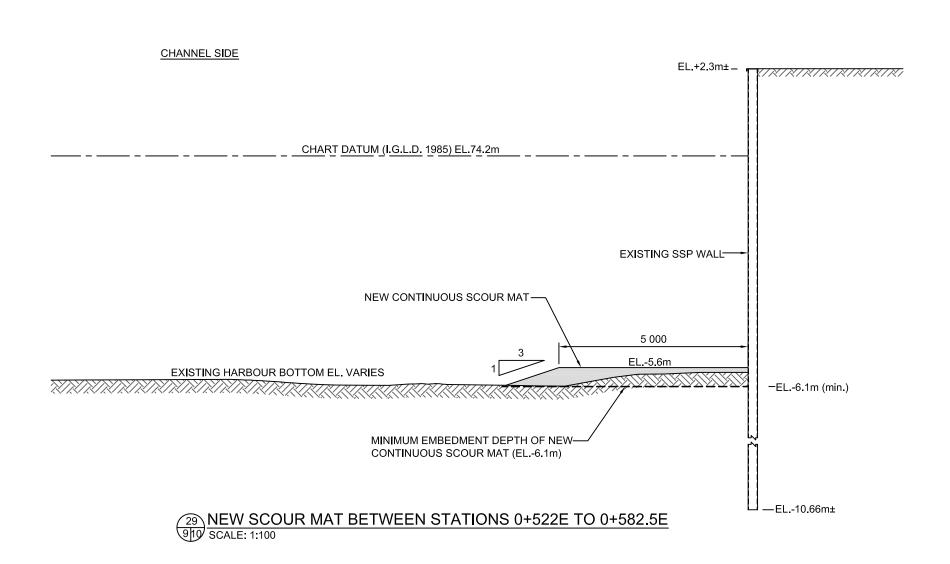



GOUVERNEMENT DU CANADA PECHES

FISHERIES PECHES AND OCEANS ET OCÉANS

SMALL CRAFT HARBOURS
CENTRAL AND ARCTIC REGION





Riggs Engineering Ltd.

1240 Commissioners Rd. W, Suite 205
London, Ontario,
N6K 1C7
Tel: (519) 657-1040
Fax: (519) 657 8631
Website: www.riggsengineering.com

1 Detail No.

1 2 drawing no.

2 drawing no. — where detail required refers to MA—
3 drawing no. — where detailed refers to MA—

P.F.F. LAMPKIN

NOTES:

REVISIONS:	DATE:	
SCALE:	CLASS:	•
AS NOTED		

PROJECT:

WHITBY HARBOUR WHARF REPAIRS

DESCRIPTION:

NEW SCOUR MAT TYP. SECTIONS

DRAWN:	APPROVED:
A.M	P.L.
DATE:	DATE:
2015-06-25	2015-06-25

LOCATION:

WHITBY, ONTARIO

DRAWING NO.: LOCATOR CODE: 721422