Parking Lot Expansion

Central District Building

BUILDING ANALYSIS BUILDING ADDRESS: 400 BRAND PLACE, SASKATOON, SK LEGAL DESCRIPTION: LOT 5, BLOCK 428, PLAN NO. 00SA01739 **BUILDING OWNER: GOVERNMENT OF CANADA BUILDING AREA:** 2471 SQ.M. STOREYS BELOW GRADE: STOREYS ABOVE GRADE: EXT'G EXT'G NUMBER OF STREET (as defined by 3.2.2.10): USE(s) OF THE BUILDING: EXT'G MAJOR OCCUPANCY CLASSIFICATIONS(s): EXT'G BUILDING CODE CLASSIFICATIONS(s): NORTH WALL (%) EAST WALL (%) WEST WALL (%) SOUTH WALL (%) EXT'G EXT'G EXT'G EXT'G REQUIRED EXTERIOR WALL FIRE RESISTANCE RATING: NORTH WALL (HR) SOUTH WALL (HR) EAST WALL (HR) WEST WALL (HR) EXT'G EXT'G EXT'G EXT'G W.C.'s PROVIDED - MALE: OCCUPANT LOAD: W.C.'s REQUIRED - MALE: EXT'G EXT'G **EXISTING** - FEMALE: EXT'G - FEMALE: EXT'G - UNISEX: EXT'G NUMBER OF EXITS REQUIRED: PUBLIC CORRIDOR SEPARATIONS: - FLOOR AREA(s): EXT'G - FIRE SEPARATION REQUIRED: EXT'G - FIRE RESISTANCE RATING REQUIRED: - MEZZANINE(s): EXT'G REQUIRED FIRE RESISTANCE RATING IN HOURS: FLOORS: **MEZZANINES:** ROOF: **EXISTING EXISTING EXISTING EXIT STAIRWAYS:** MECHANICAL ROOMS: SERVICE SHAFTS: **EXISTING EXISTING EXISTING** SUITE SEPARATIONS: REPAIR GARAGES: OCCUPANCY SEPARATIONS: **EXISTING EXISTING** STORAGE ROOMS: **BEARING ASSEMBLIES:** FIRE WALLS: **EXISTING EXISTING EXISTING** OTHER: (SPECIFY) STORAGE GARAGES: OTHER: (SPECIFY) **EXISTING EXISTING** EXIT SIGNS - REQ'D: EXT'G | EMERGENCY LIGHTING - REQ'D: EXT'G STANDPIPE & HOSE SYSTEM - REQ'D: | EXT'G | SMOKE ALARMS - REQ'D: EXT'G FIRE ALARM SYSTEM - REQ'D: BARRIER FREE ACCESS - REQ'D: EXT'G EXT'G SPRINKLER SYSTEM - REQ'D: EXT'G FIRE DAMPERS - REQ'D: EXT'G ATTIC FIRE STOPS - REQ'D: EXT'G PIPING FIRE STOPS - REQ'D: EXT'G NAME OF QUALIFIED DESIGNER THAT JUSTIN L. WOTHERSPOON - ARCHITECT HAS COMPLETED THIS FORM:

Saskatoon, SK

ZONING REQUIREMENTS				
ZONED: AM - AUT	O MALL DISTRICT			
SETBACKS	FRONT YARD	REAR YARD	SIDE Y	/ARD
(MINIMUM)	9.0 M	9.0 M	9.0	М
MIN. LOT AREA:	0.75 HA.	MIN. SITE COVER	AGE:	N/A
MAX. FLOOR ARE	A RATIO: N/A	MAX. BUILDING H	EIGHT:	12 M
PARKING REQUIREMENTS: 138 PARKING STALLS ARE EXISTING = 0 ADDITIONAL STALLS REQUIRED				

BUILDING SUMMARY	
FLOOR AREA SUMMARY:	EXISTING
SITE COVERAGE:	EXISTING
TOTAL BUILDING AREA:	EXISTING
BUILDING HEIGHT:	EXISTING
PARKING PROVIDED:	138 EXISTING + 39 NEW =
	177 STALLS PROVIDED

DRA	WING LIST	
ARCHI	TECTURAL	
A0.1 A1.1	COVER PAGE, BUILDING ANALYSIS SITE PLAN	
ELECT	RICAL	
E1	SITE PLAN	
E2	DRAWING NOTES / DETAILS	
<u>CIVIL</u>		
C1.1	SITE GRADING PLAN	
C1.2	DETAILS	
LANDS	LANDSCAPE	
L-1	IRRIGATION	
L-2	LANDSCAPE REPAIR	

GENERAL NOTES

1. STANDARDS & MANUFACTURER'S LITERATURE

ALL WORK SHALL CONFORM TO THE 2010 NATIONAL BUILDING CODE & ALL APPLICABLE LOCAL BY-LAWS. IN THE ABSENCE OF OTHER STANDARDS BEING REQUIRED BY THE CONTRACT DOCUMENTS, ALL WORK IS TO CONFORM TO, OR EXCEED, THE MINIMUM STANDARDS OF THE CANADIAN GOVERNMENT SPECIFICATIONS BOARD, THE CANADIAN STANDARDS ASSOCIATION, THE SASKATCHEWAN WORKER'S COMPENSATION BOARD, & MANUFACTURERS OF MATERIAL SUPPLIED FOR THIS PROJECT, WHICHEVER IS/ARE APPLICABLE.

2. SAFETY REQUIREMENTS

1. OBSERVE & ENFORCE ALL CONSTRUCTION SAFETY MEASURES BY THE NBC, APPLICABLE WORKER'S COMPENSATION BOARDS & LOCAL STATUTES & BY-LAWS.

3. PROTECTION OF PUBLIC WORK & PROPERTY

- 1. PROTECT ALL WORK UNAFFECTED BY THE WORK, COMPLETED OR IN PROGRESS. ALL WORK DAMAGED DUE TO FAILURE TO PROVIDE SUCH PROTECTION SHALL BE REMOVED & REPLACED OR REPAIRED AS DIRECTED BY THE CONSULTANT AT NO INCREASE TO THE CONTRACT PRICE.
- 2. PREVENT OVERLOADING OF ANY PART OF THE BUILDING. DO NOT CUT, DRILL OR MODIFY ANY EXISTING STRUCTURE WITHOUT WRITTEN APPROVAL BY THE **CONSULTANTS**
- 3. THE CONTRACTOR SHALL ASSUME RESPONSIBILITY FOR ANY DAMAGE TO EXISTING PAVING, WALKS, ADJACENT BUILDINGS, ADJACENT SUITES & PROPERTY, SERVICES, ETC. CAUSED BY CONSTRUCTION OPERATIONS. THE CONTRACTOR SHALL MAKE GOOD SAME OR BEAR THE EXPENSE OF ALL
- 4. THE CONTRACTOR SHALL CONDUCT CONSTRUCTION OPERATIONS WITH MIN. INTERFERENCE TO ADJACENT PROPERTY ROADWAYS, SIDEWALKS, & ACCESS TO FACILITIES IN GENERAL. KEEP ALL AREAS FREE FROM MATERIALS, DEBRIS & EQUIPMENT AT ALL TIMES. CONFINE OPERATIONS TO AREAS DESIGNATED BY THE CONSULTANT AND/OR OWNER, MAINTAIN FIRE ACCESS AT ALL TIME.

4. LOCATION OF FIXTURES & EQUIPMENT ON ARCHITECTURAL

1 LOCATION OF FOUIPMENT, FIXTURES AND OUTLIETS INDICATED OR SPECIFIED ARE TO BE CONSIDERED AS APPROXIMATE, LOCATION OF SERVICE RUNS, DUCTS, CONDUITS, PIPING, SYSTEMS AD OTHER ITEMS SHOWN ON THE DRAWING ARE DIAGRAMMATIC.

2. LOCATE EQUIPMENT, FIXTURES AND DISTRIBUTIONS SYSTEMS TO PROVIDE MINIMUM INTERFERENCE & MAX. USABLE SPACE IN ACCORDANCE WITH MANUFACTURER'S RECOMMENDATIONS.

5. CUTTING & PATCHING

- 1. EXECUTE CUTTING, FITTING, & PATCHING REQUIRED TO MAKE THE WORK FIT TOGETHER.
- 2. OBTAIN THE CONSULTANTS APPROVAL BEFORE ANY MODIFICATION TO EXISTING STRUCTURAL.
- 3. MAKE ALL CUTS CLEAN, TRUE & SMOOTH.
- 4. FIT ALL WORK AIRTIGHT TO PIPES, SLEEVES, DUCTS & CONDUITS.

6. PROJECT CLOSE OUT

1. DISPOSAL: CONDUCT CLEANING & DISPOSAL OPERATIONS TO COMPLY WITH CODES, ORDINANCES, REGULATIONS & WASTE MATERIAL AT PERIODIC INTERVALS AWAY FROM THE SITE & IN A LEGAL MANNER.

7. ADDITIONAL REQUIREMENTS

- 1. PATCH & REPAIR ALL ADJACENT SURFACES TO MATCH EXISTING OR TO RECEIVE FINISHES AS SCHEDULED. IF ANY PORTION OF WORK IS TO BE PAINTED, REPAIR OR REPLACED, REPAIR OR REPLACE ENTIRE LENGTH.
- 2. COORDINATE ALL WORK WILL ALL TRADES AS WELL AS MECHANICAL AND FLECTRICAL
- 3. PATCH, REPAIR AND MAKE GOOD ALL SURFACES WITHIN THE SCOPE OF THE PROJECT. INCLUDING, BUT NOT LIMITED TO SITE, TREES, FLOORS, PARTITIONS, CURBS, RAILS, CASEWORK, CEILING, MECHANICAL, AND ELECTRICAL.
- 4. ALL DIMENSIONS ARE TO THE CENTER OF STUD AND NOT PARTITION TYPE. CONTRACTOR TO VERIFY ALL PARTITION LOCATIONS WITH EXISTING COLUMNS, CEILINGS, PARTITIONS, MECHANICAL & ELECTRICAL LOCATIONS.
- 5. PROVIDE 10MM± SHIM SPACE AT EXISTING SURFACES AS REQUIRED TO ACHIEVE LEVEL, PLUMB & SQUARE FINAL SURFACE CONDITIONS.
- 6. CONTINUOUS FIRE/SMOKE STOP SEALANT TO TOP OF PARTITIONS @ U/S OF DECK, FLOOR & AT ALL MECHANICAL & ELECTRICAL PENETRATIONS, BOTTOM & WALL JUNCTIONS.
- 7. RETURN GWB AT ALL WINDOWS & DOOR FRAMES.
- 8. SEALANT REQUIRED AT ALL LOCATIONS WHERE GWB MEETS EXISTING CONSTRUCTION.
- 9. PATCH & REPAIR ALL PARTITIONS & WALLS WITHIN SCOPE OF WORK AREA THAT ARE TO RECEIVE NEW FINISH.
- 10. ALL EXPOSED MILLWORK SURFACES TO BE HIGH PRESSURE LAMINATE.
- 11. ALL EDGE BANDING TO BE MM PVC UNLESS OTHERWISE NOTED.



PARKING LOT EXPANSION CENTRAL DISTRICT BUILDING **400 BRAND PLACE** SASKATOON, SK

DRAWING TITLE


COVER PAGE, BUILDING ANALYSIS


DATE PROJECT NO. 2015.07.31 S-19-2015 **SCALE** DRAWING NO. **AS SHOWN** DRAWN


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JMM

JLW



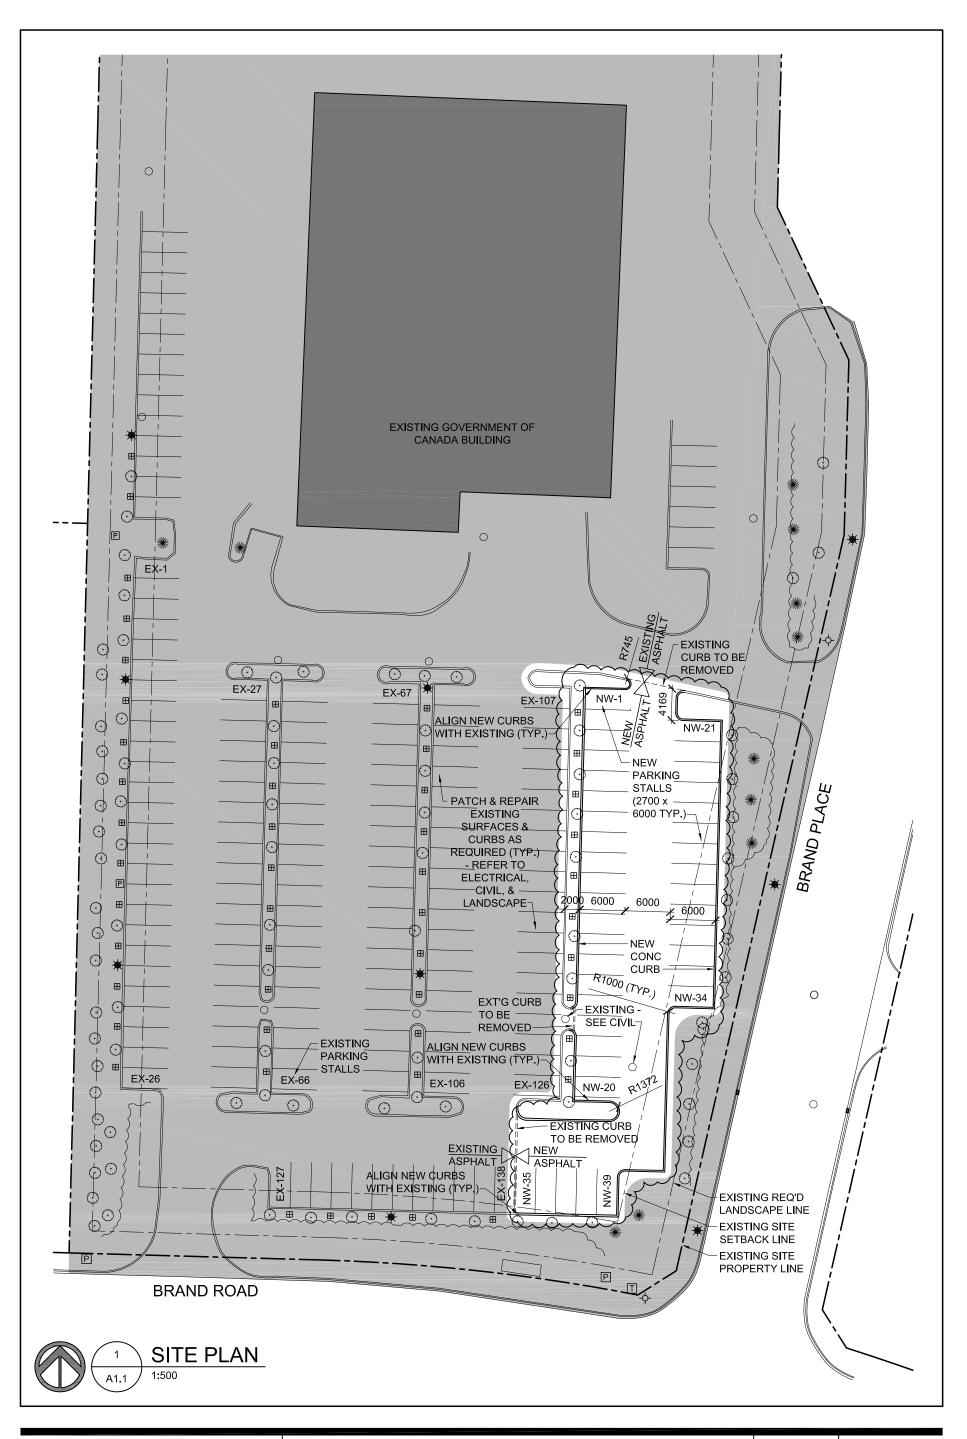

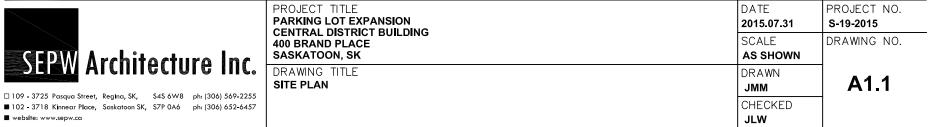

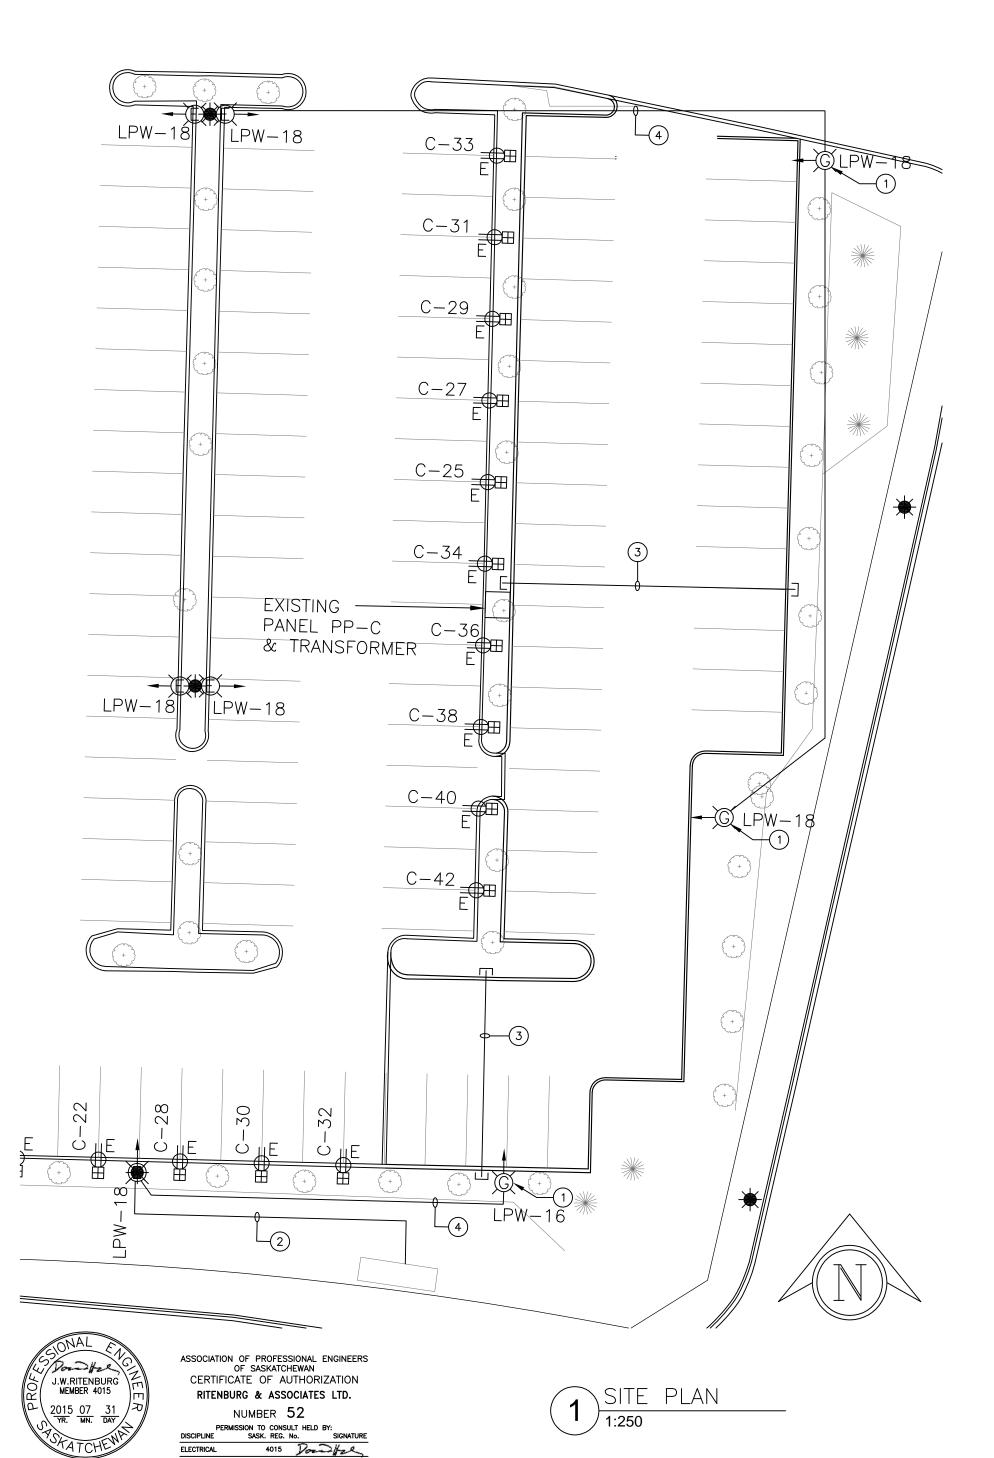

SEPW Architecture Inc.

ELECTRICAL

PROJECT TITLE PARKING LOT EXPANSION **CENTRAL DISTRICT BUILDING 400 BRAND PLACE** SASKATOON, SK

DRAWING TITLE

4015 Postoly

SITE PLAN

Ritenburg & Associates Ltd. Consulting Electrical Engineers

DATE PROJECT NO. 2015.07.31 S-19-2015 SCALE DRAWING NO. **AS SHOWN DRAWN E1** DCH **CHECKED**

DCH

■ 102 - 3718 Kinnear Place, Saskatoon SK, S7P 0A6 ph: (306) 652-6457 website: www.sepw.ca

SYMBOL SCHEDULE


- PARKING LIGHT STANDARD. FIXTURE TYPE G INDICATES NEW STANDARD TO MATCH EXISTING, ARROW INDICATES DIRECTION OF HEAD. FIXTURE TYPE E IS EXISTING TO REMAIN.
- EXISTING RECEPTACLE FOR CAR PARKING. CAR PEDESTALS SHOWN FOR REFERENCE ONLY.

DRAWING NOTES

- 1 NEW LIGHT FIXTURE 2, INSTALLED TO MATCH EXISTING. CONNECT TO EXISTING 347V EXTERIOR LIGHTING CIRCUIT SHOWN. EXCAVATE AROUND EXISTING LIGHT POLE AS REQUIRED TO CONNECT TO EXISTING CIRCUIT.
- (2) EXISTING FEED TO SIGN TO REMAIN.
- 3 PROVIDE 53mm RIGID PVC SLEEVE BETWEEN PARKING CURBS TO FACILITATE FUTURE EXPANSION OF CAR PARKING. SLEEVE SHALL RUN 1 METERE BELOW FINISHED GRADE. STUB CONDUITS UP ON EITHER END TO 300mm ABOVE FINAL LANDSCAPING. PROVIDE PULL STRING AND CAP FOR FUTURE USE.
- (4) LOCATE EXISTING CONDUCTORS AND PROVIDE DIRECTIONAL BORING BETWEEN LIGHT STANDARDS TO AVOID DAMAGE TO THE EXISTING ASPHALT.

GENERAL NOTES

ONTRACTOR SHALL LOCATE ALL EXISTING FEEDER RUNS WHICH MAY CONFLICT WITH THE INSTALLATION OF THE NEW LIGHTING CONDUCTORS. CONTRACTOR SHALL DIRECTIONAL BORE IN AREAS OF EXISTING ASPHALT. CONTRACTOR SHALL ALLOW FOR HYDROVACING AROUND EXISTING CABLES AT LIGHT POLE AS REQUIRED.

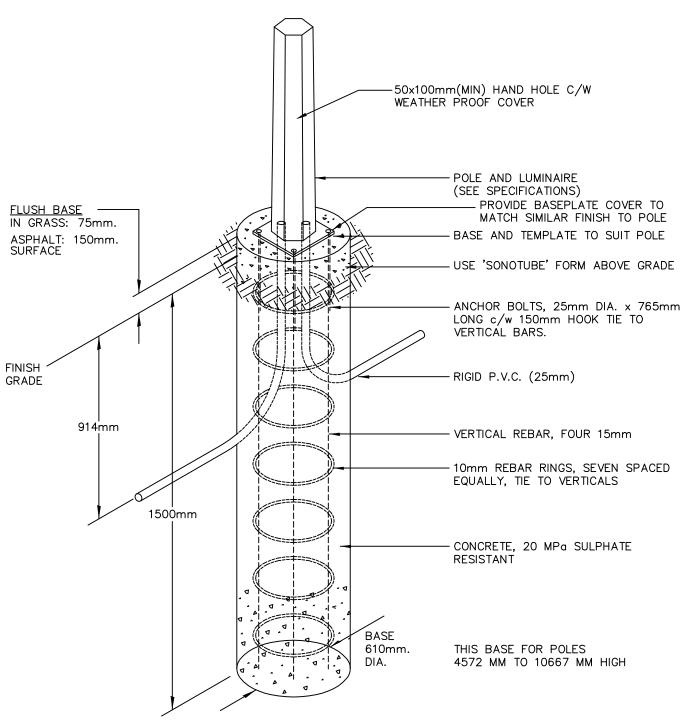





website: www.sepw.ca

ASSOCIATION OF PROFESSIONAL ENGINEERS OF SASKATCHEWAN CERTIFICATE OF AUTHORIZATION RITENBURG & ASSOCIATES LTD.

NUMBER 52

PERMISSION TO CONSULT HELD BY:
DISCIPLINE SASK. REG. No. SIGNATURE
ELECTRICAL 4015



■ 102 - 3718 Kinnear Place, Saskatoon SK, S7P 0A6 ph: (306) 652-6457

PROJECT TITLE
PARKING LOT EXPANSION
CENTRAL DISTRICT BUILDING
400 BRAND PLACE
SASKATOON, SK

DRAWING TITLE

DRAWING NOTES/DETAILS

Ritenburg & Associates Ltd. Consulting Electrical Engineers	DATE 2015.07.31	
#517 - 601 1st Avenue North Saskatoon, Saskatchewen S7K 1X7 P: (306) 244-1303 F: (306) 244-1307 Emait: ni@pritenburg.com	SCALE AS SHOWN	
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DATE
2015.07.31


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PROJECT NO.
S-19-2015


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E2




SITE GRADING PLAN ERL CHECKED ■ 102-3718 Kinnear Place, Saskatoon SK, S7P 0A6 ph: (306) 652-6457 website: www.sepw.ca BAL


CW 504-00801

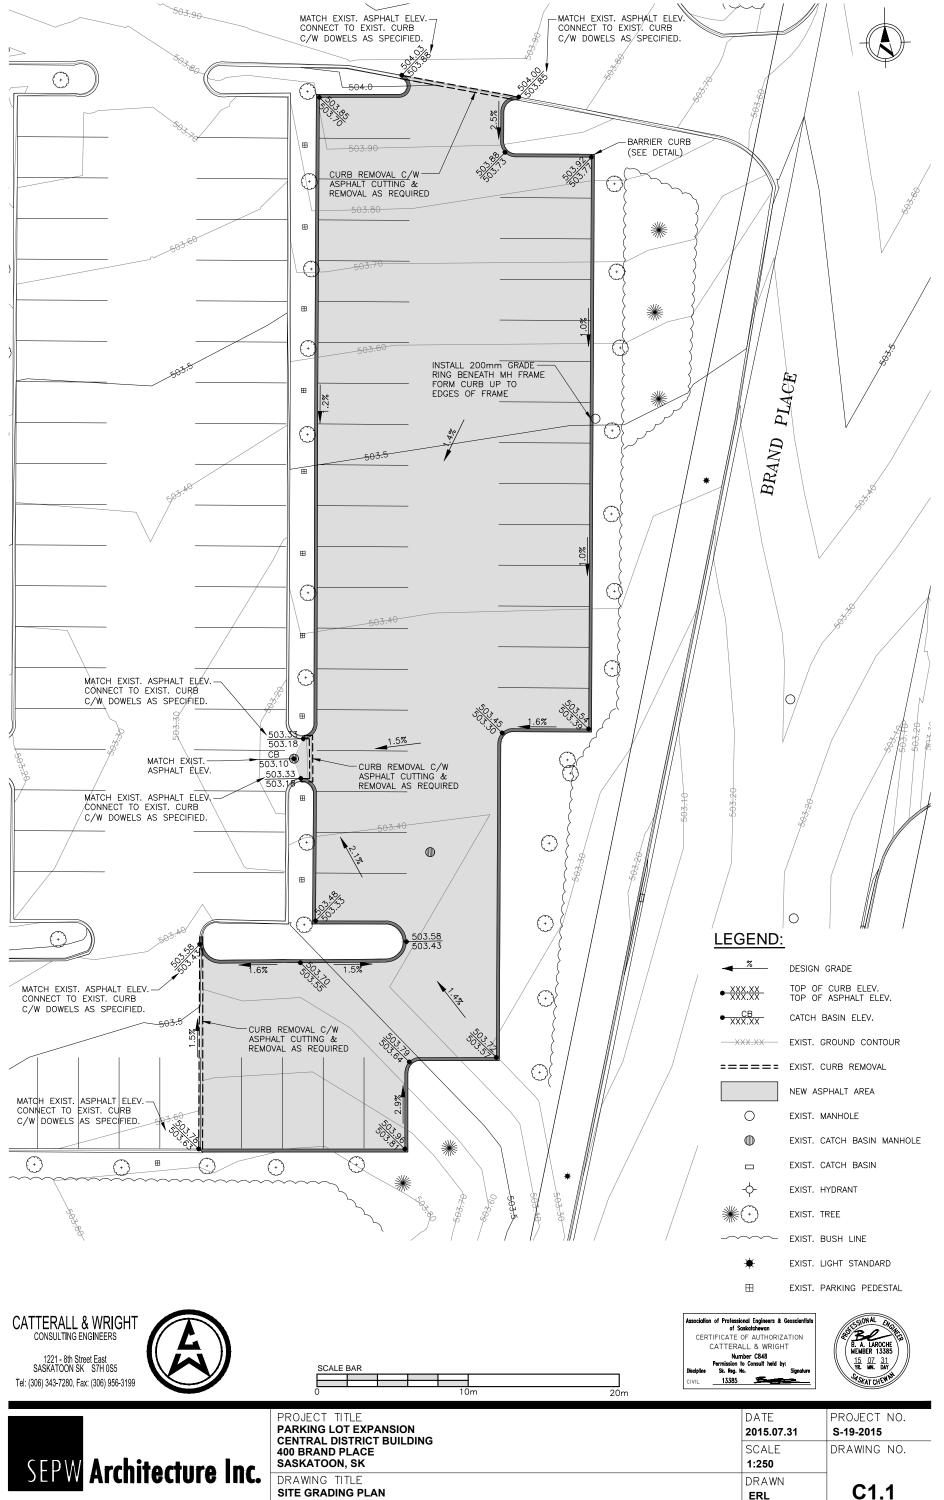

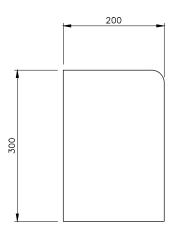BARRIER CURB DETAIL SCALE: N.T.S.

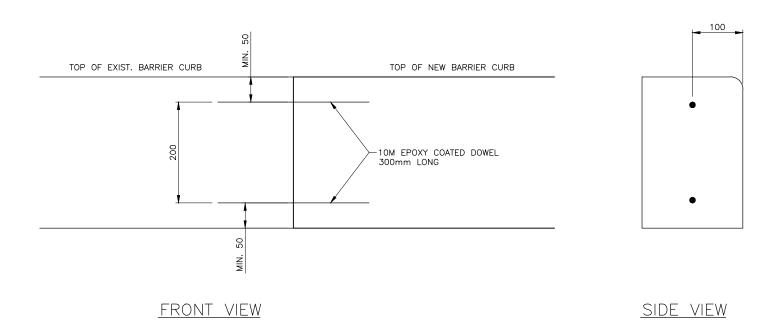


CURB JOINT DETAIL SCALE: N.T.S.

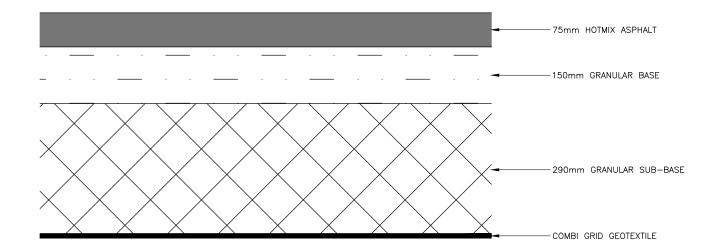

ASPHALT STRUCTURE SCALE: N.T.S.



	PROJECT TITLE PARKING LOT EXPANSION CENTRAL DISTRICT BUILDING	DATE 2015.07.31	PROJECT NO. S-19-2015
SEPW Architecture Inc.	400 BRAND PLACE	SCALE AS SHOWN	DRAWING NO.
Sti W Altilletiole Illt.	DRAWING TITLE DETAILS	DRAWN ERL	C1.2
□ 109-3725 Pasqua Street, Regina, SK, S4S 6W8 ph: (308) 569-2255 ■ 102-3718 Kinnear Place, Saskatoon SK, S7P 0A6 ph: (308) 652-6457 ■ website: www.sepw.ca		CHECKED BAL	CW 504-00802

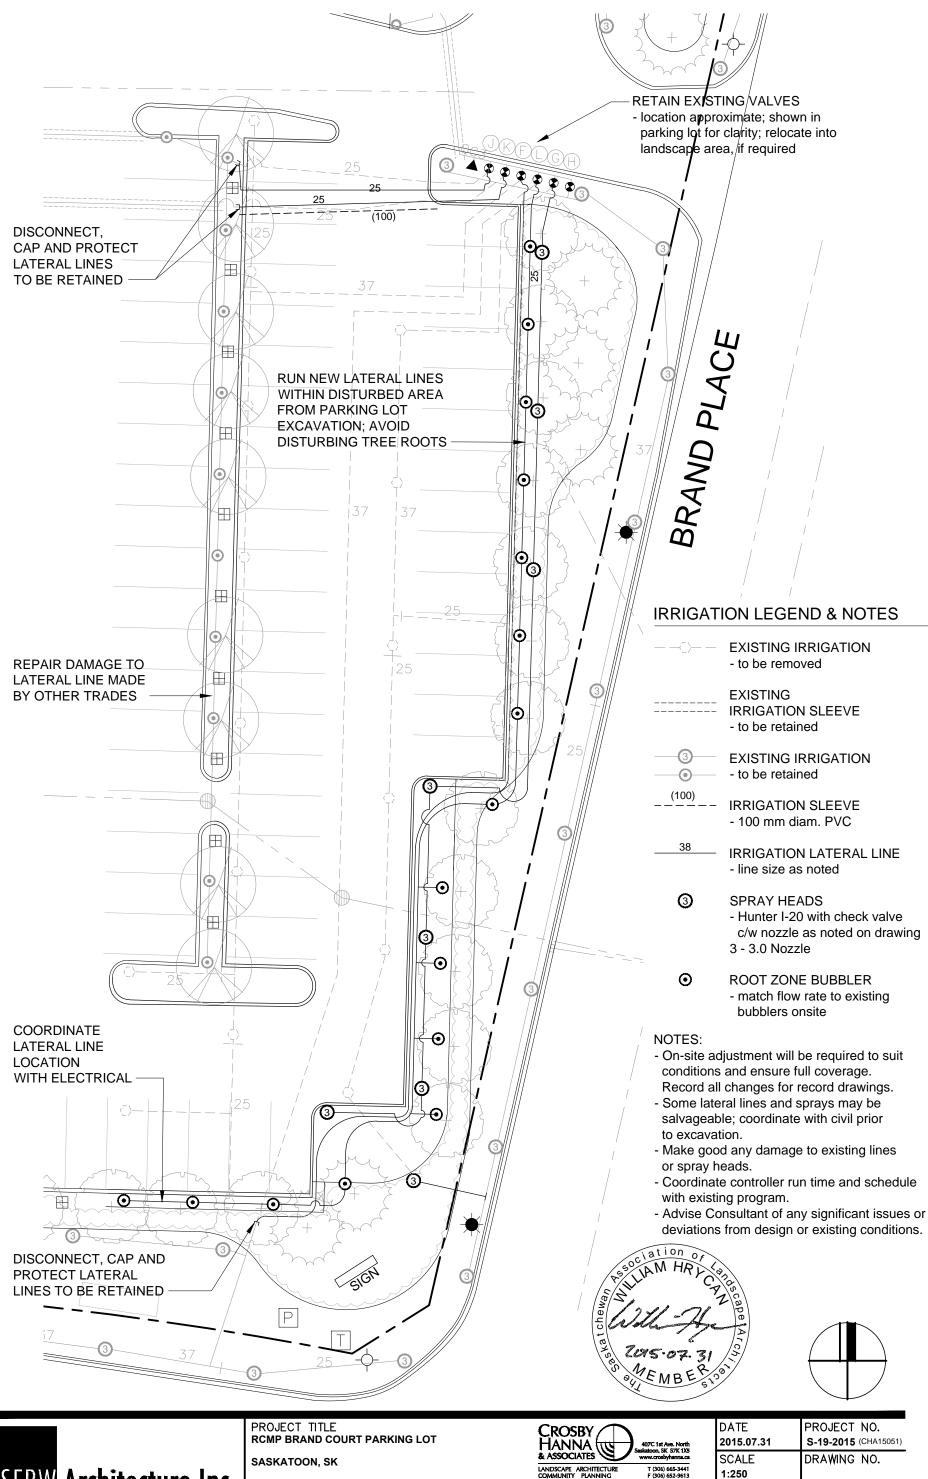

SEPW Architecture Inc.

Saskatoon SK,

S7P 0A6

■ 102 - 3718 Kinnear Place,

website: www.sepw.ca


ph: (306) 652-6457

DRAWING TITLE **IRRIGATION**

LANDSCAPE ARCHITECTURE COMMUNITY PLANNING

DATE 2015.07.31	PROJECT NO. S-19-2015 (CHA150)
SCALE 1:250	DRAWING NO.
DRAWN KS/SD	L-1
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WH



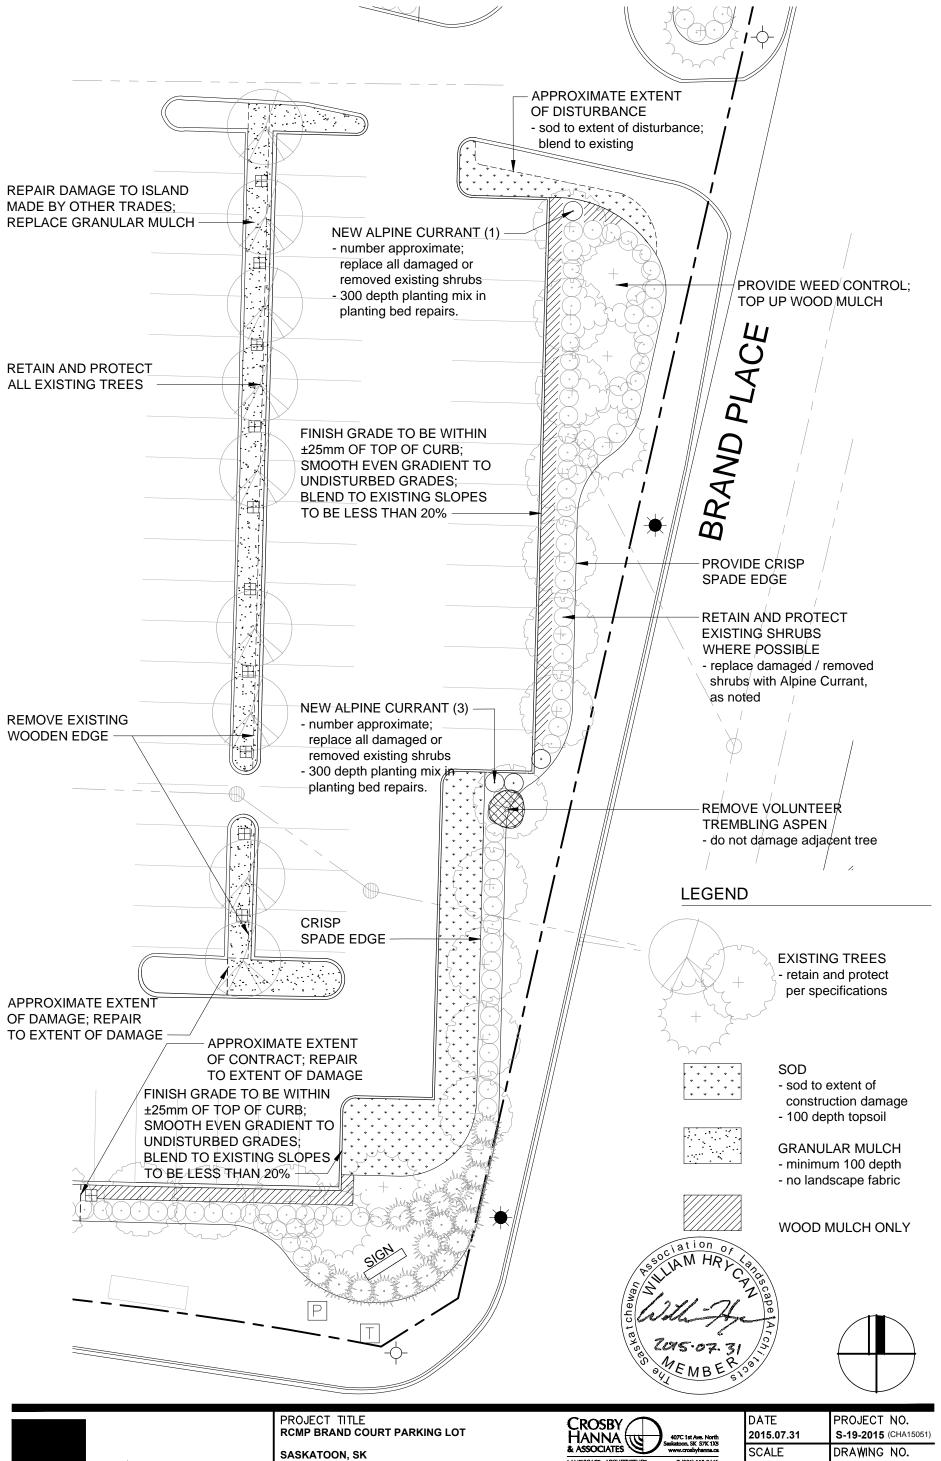

■ 102 - 3718 Kinnear Place,

website: www.sepw.ca

Saskatoon SK, S7P 0A6 ph: (306) 652-6457 DRAWING TITLE

LANDSCAPE REPAIR

LANDSCAPE ARCHITECTURE COMMUNITY PLANNING

	DATE
st Ave. North SK S7K 1X5	2015.0
osbyhanna.ca 06) 665-3441 06) 652-9613	SCAL
	1:250
	DRAW
	L/C/C

CHECKED

WH

MΝ L-2 KS/SD