


PLAN - NEW LIFT STATION
SCALE: 1:30
SCALE: 1:30
0mm 500mm 1000mm 1500mm 2000mm 2500mm 3000mm

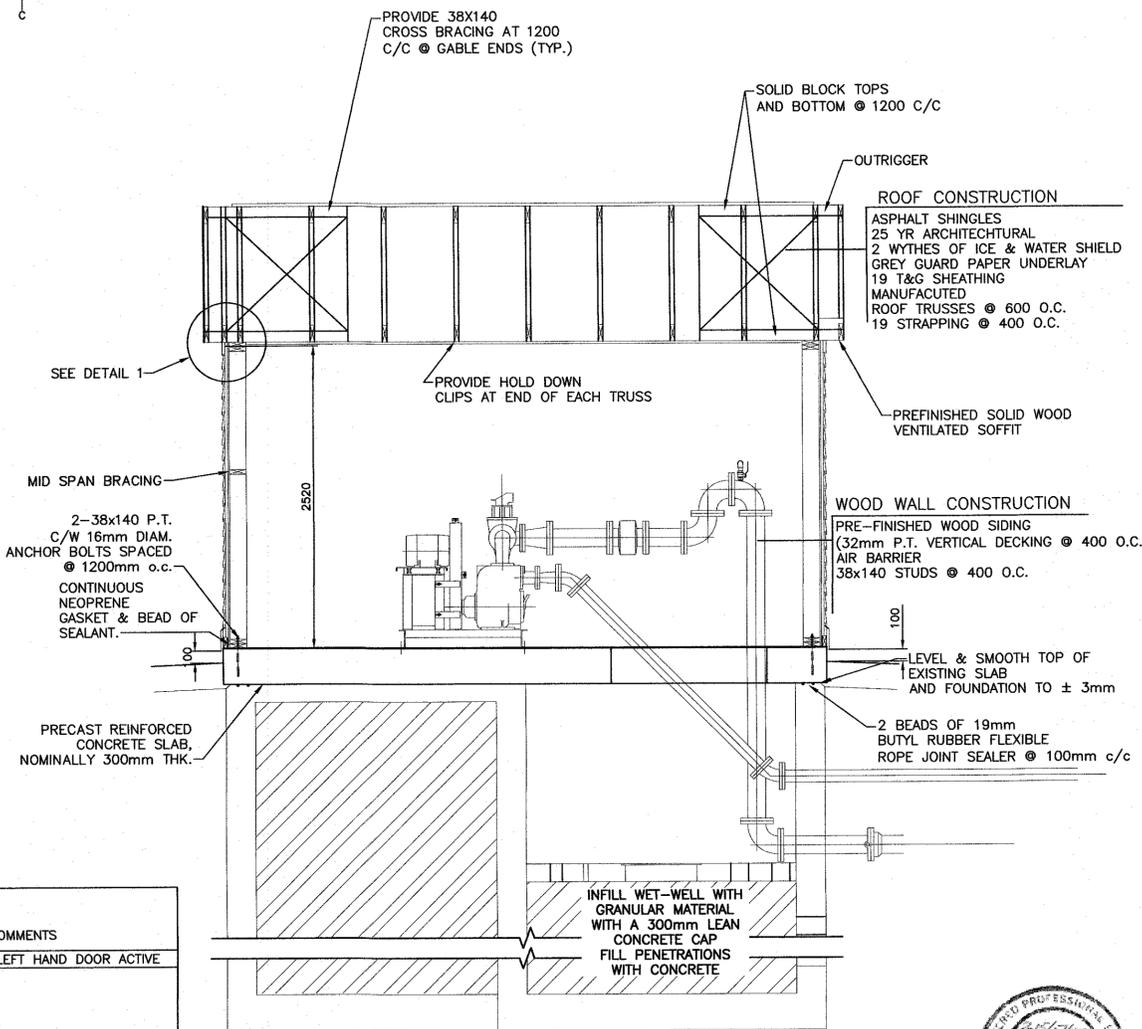


SECTION - NEW LIFT STATION
SCALE: 1:30
SCALE: 1:30
0mm 500mm 1000mm 1500mm 2000mm 2500mm 3000mm


DOOR, FRAME & HARDWARE SCHEDULE

DOOR No.	ROOM NAME	DOOR						DOOR No.	FIRE RATING	FRAME					COMMENTS
		TYPE	MATERIAL	GLASS	SIZE	FINISH	HARDWARE			TYPE	MATERIAL	GLASS	DETAIL	FINISH	
102	LIFT STATION BLDG.	1	PS/IN	-	2-900 x 2150 x 45	P	1	102	-	1	TB/PS	-	-	P	LEFT HAND DOOR ACTIVE


LEGEND
HMD = HOLLOW METAL DOOR
N = NATURAL WOOD FINISH
P = PAINT
VC = VINYL CLAD
PS = PRESSED STEEL DOOR
SCW = SOLID CORE WOOD DOOR
SW = SOLID WOOD
TB/PS = THERMALLY BROKEN PRESSED STEEL
IN = INSULATED
HCW = HOLLOW CORE WOOD DOOR PAINT GRADE - 6 PANEL

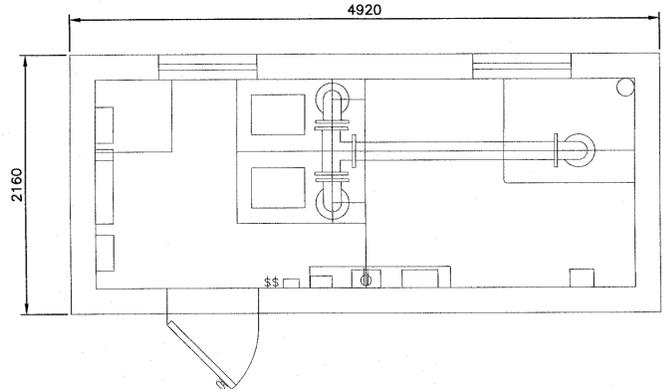


PLAN - EXISTING LIFT STATION
SCALE: 1:30
SCALE: 1:30
0mm 500mm 1000mm 1500mm 2000mm 2500mm 3000mm

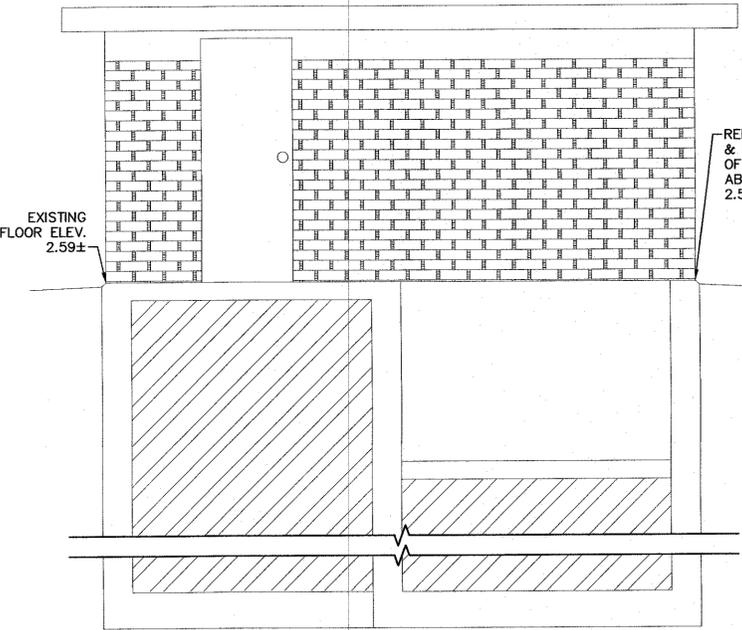

EXIST. WEST ELEVATION - EXISTING LIFT STATION BUILDING
SCALE: 1:30
SCALE: 1:30
0mm 500mm 1000mm 1500mm 2000mm 2500mm 3000mm

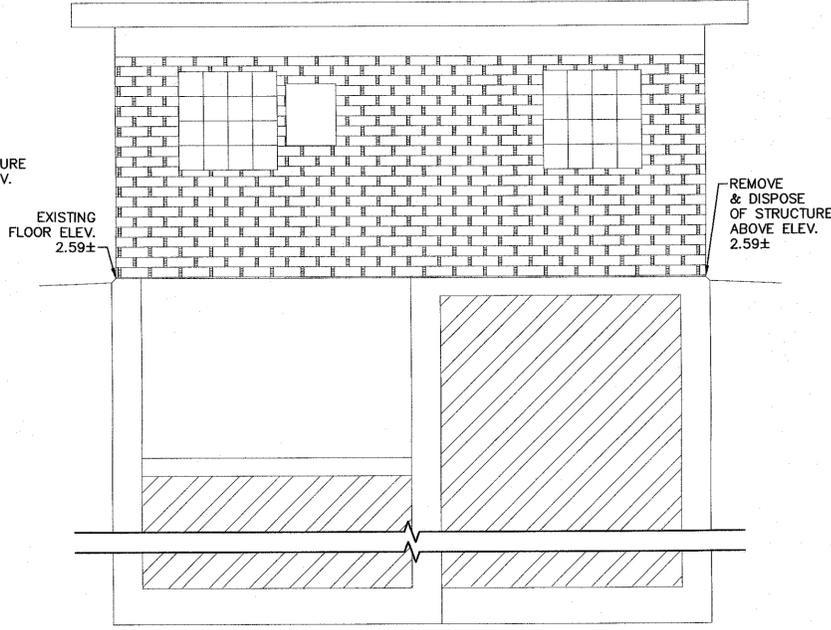

EXIST. EAST ELEVATION - EXISTING LIFT STATION BUILDING
SCALE: 1:30
SCALE: 1:30
0mm 500mm 1000mm 1500mm 2000mm 2500mm 3000mm

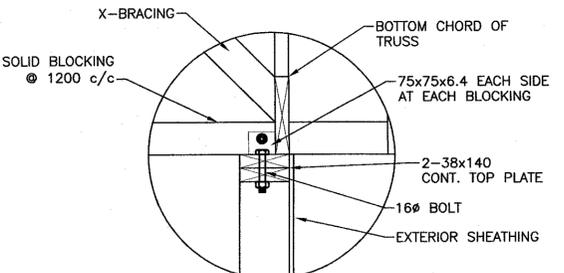

DETAIL - TRUSS HOLD DOWN
SCALE: N.T.S.
1



DESIGN LOADS:

ROOF TOP CHORD	DL=0.7kPa LL=2.7kPa
BOTTOM CHORD	DL=0.3kPa LL=0.5kPa
UPLIFT	AS PER NBCC 2010

NOTE: SUPPLIER IS TO SIZE, SUPPLY AND INSTALL TIE DOWN ANCHORS AT EACH END OF TRUSS. PROPOSED TIE DOWN ANCHORS TO BE SUBMITTED WITH TRUSS SHOP DRAWINGS.

NOTES:

- SEE DRAWING A01 FOR GENERAL NOTES.
- FASTEN PLYWOOD SHEATHING WITH 75MM NAILS AT 150MM C/C AT PANEL EDGES & 300 C/C AT INTERMEDIATE MEMBERS.
- PROVIDE PRECAST CONCRETE SLAB. C/W DRY-SHAKE FLOOR HARDENER.
- THE EXISTING BUILDING INTERIOR CLADDING CONTAINS ASBESTOS.



revisions	date
O	ISSUED FOR TENDER JULY 27 2015
B	ISSUED FOR 80% REVIEW JULY 20 2015
A	ISSUED FOR RS2 REVIEW JUNE 26 2015

project
**PARKS CANADA
CAVENDISH/BRACKLEY
SEWAGE PUMP STATION
UPGRADES**

CAVENDISH SEWAGE PUMP STATION UPGRADE PLANS, SECTIONS & DETAILS

designed	P.SCOTT	conçu
date	JUNE 2015	
drawn	P.SCOTT	dessiné
date	JUNE 2015	
approved		approuvé
date		
Tender	TIM CHANDLER	Submission
PWGS&C Project Manager	Administrateur de projets TPSC	
project number	R.075015.001	no. du projet
drawing no.	A03	no. du dessin