




PLOT

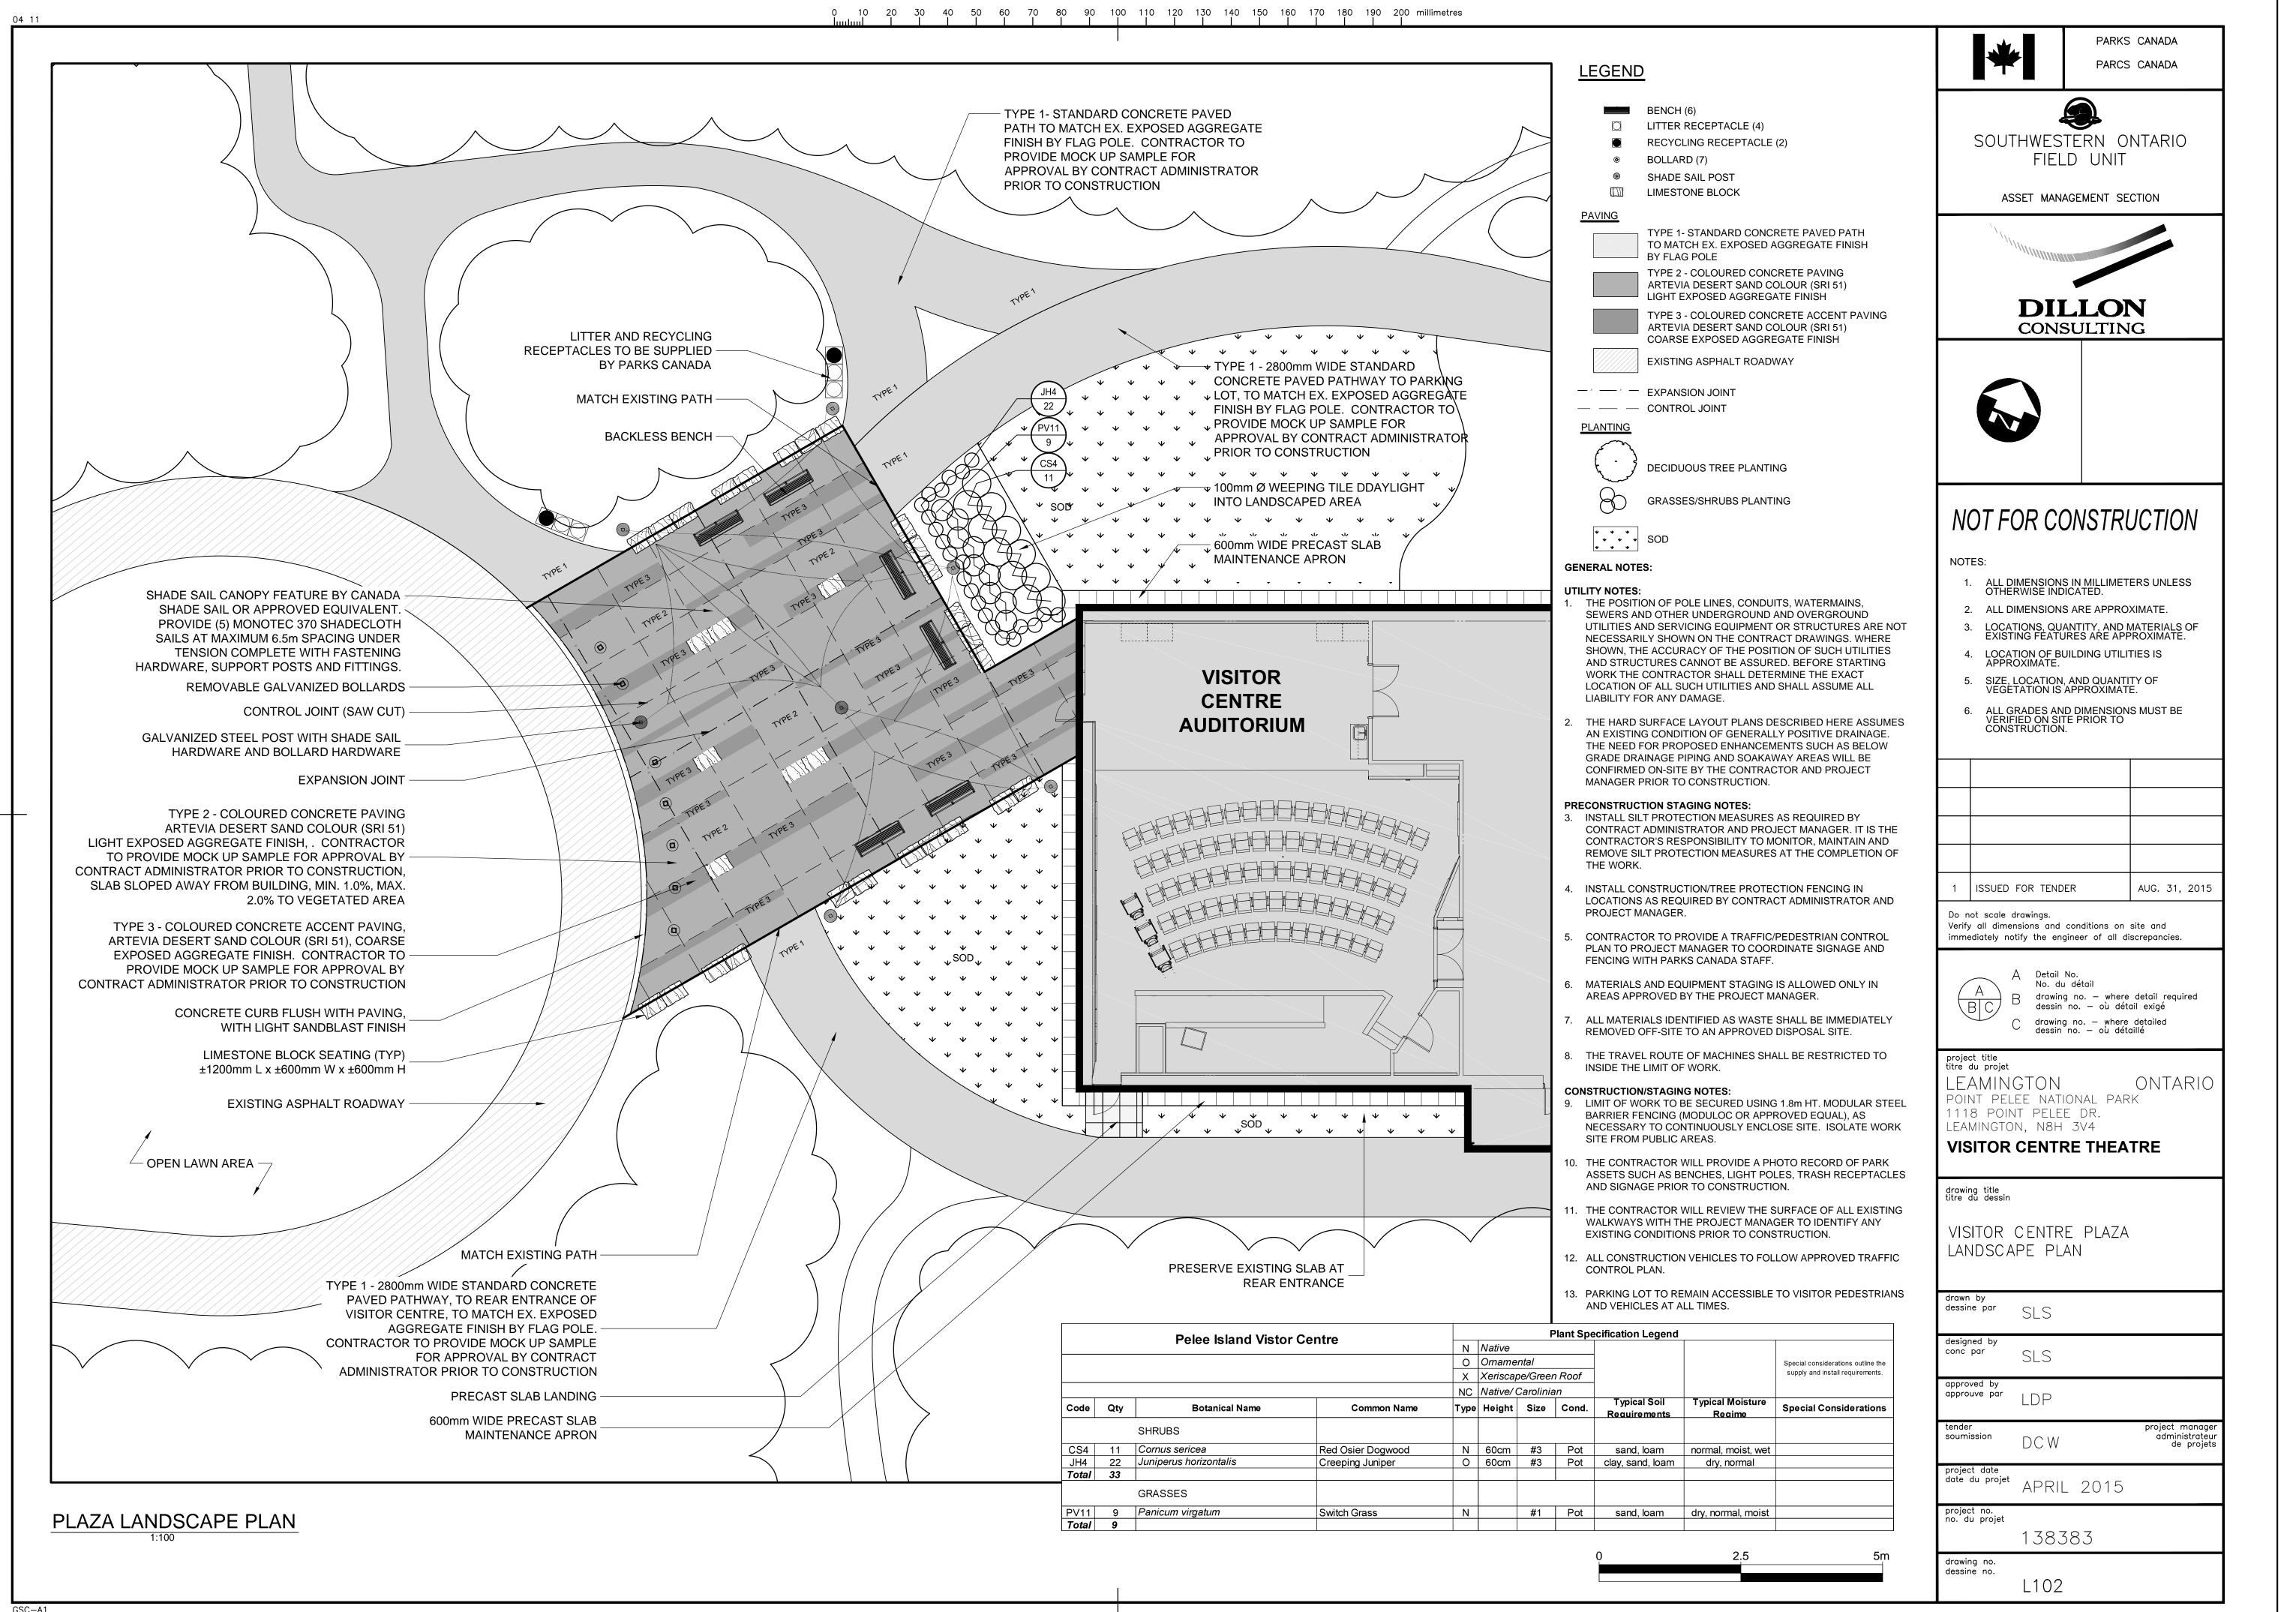

PELEE POINT SCALE: 38383 PLOT Ž₹ 24 -09-02 @ ME: DATE: **PLOT**

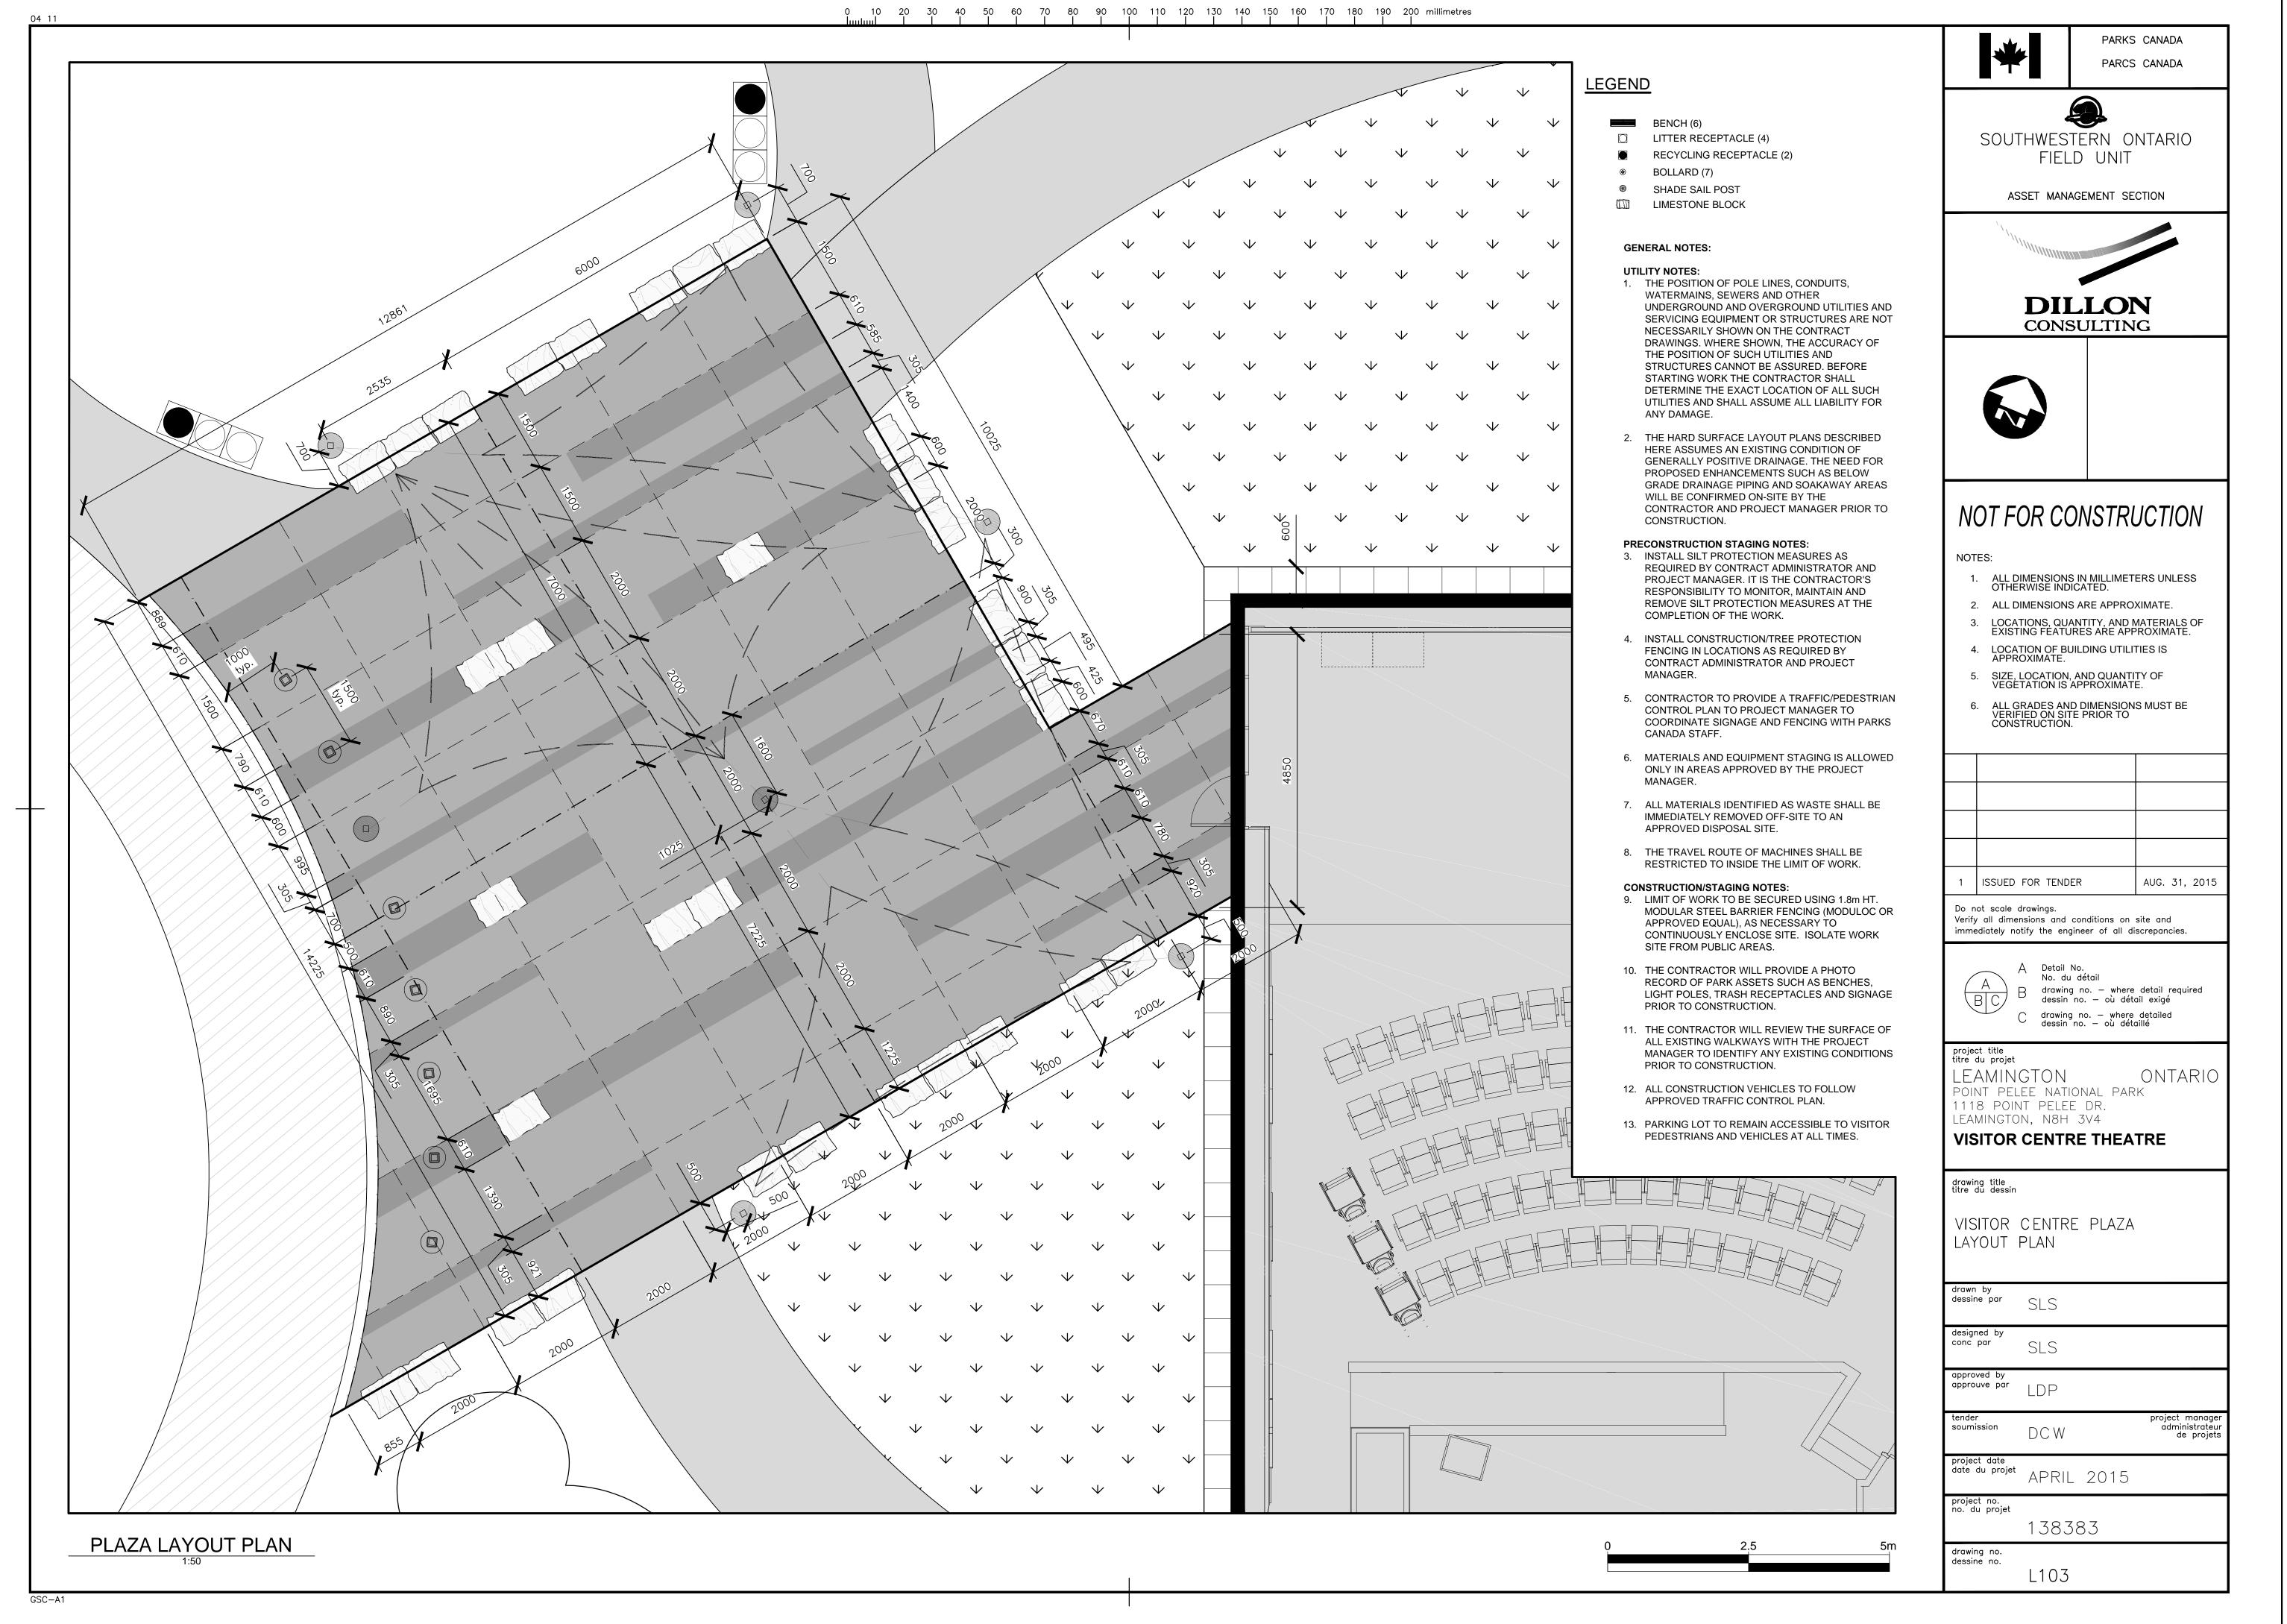





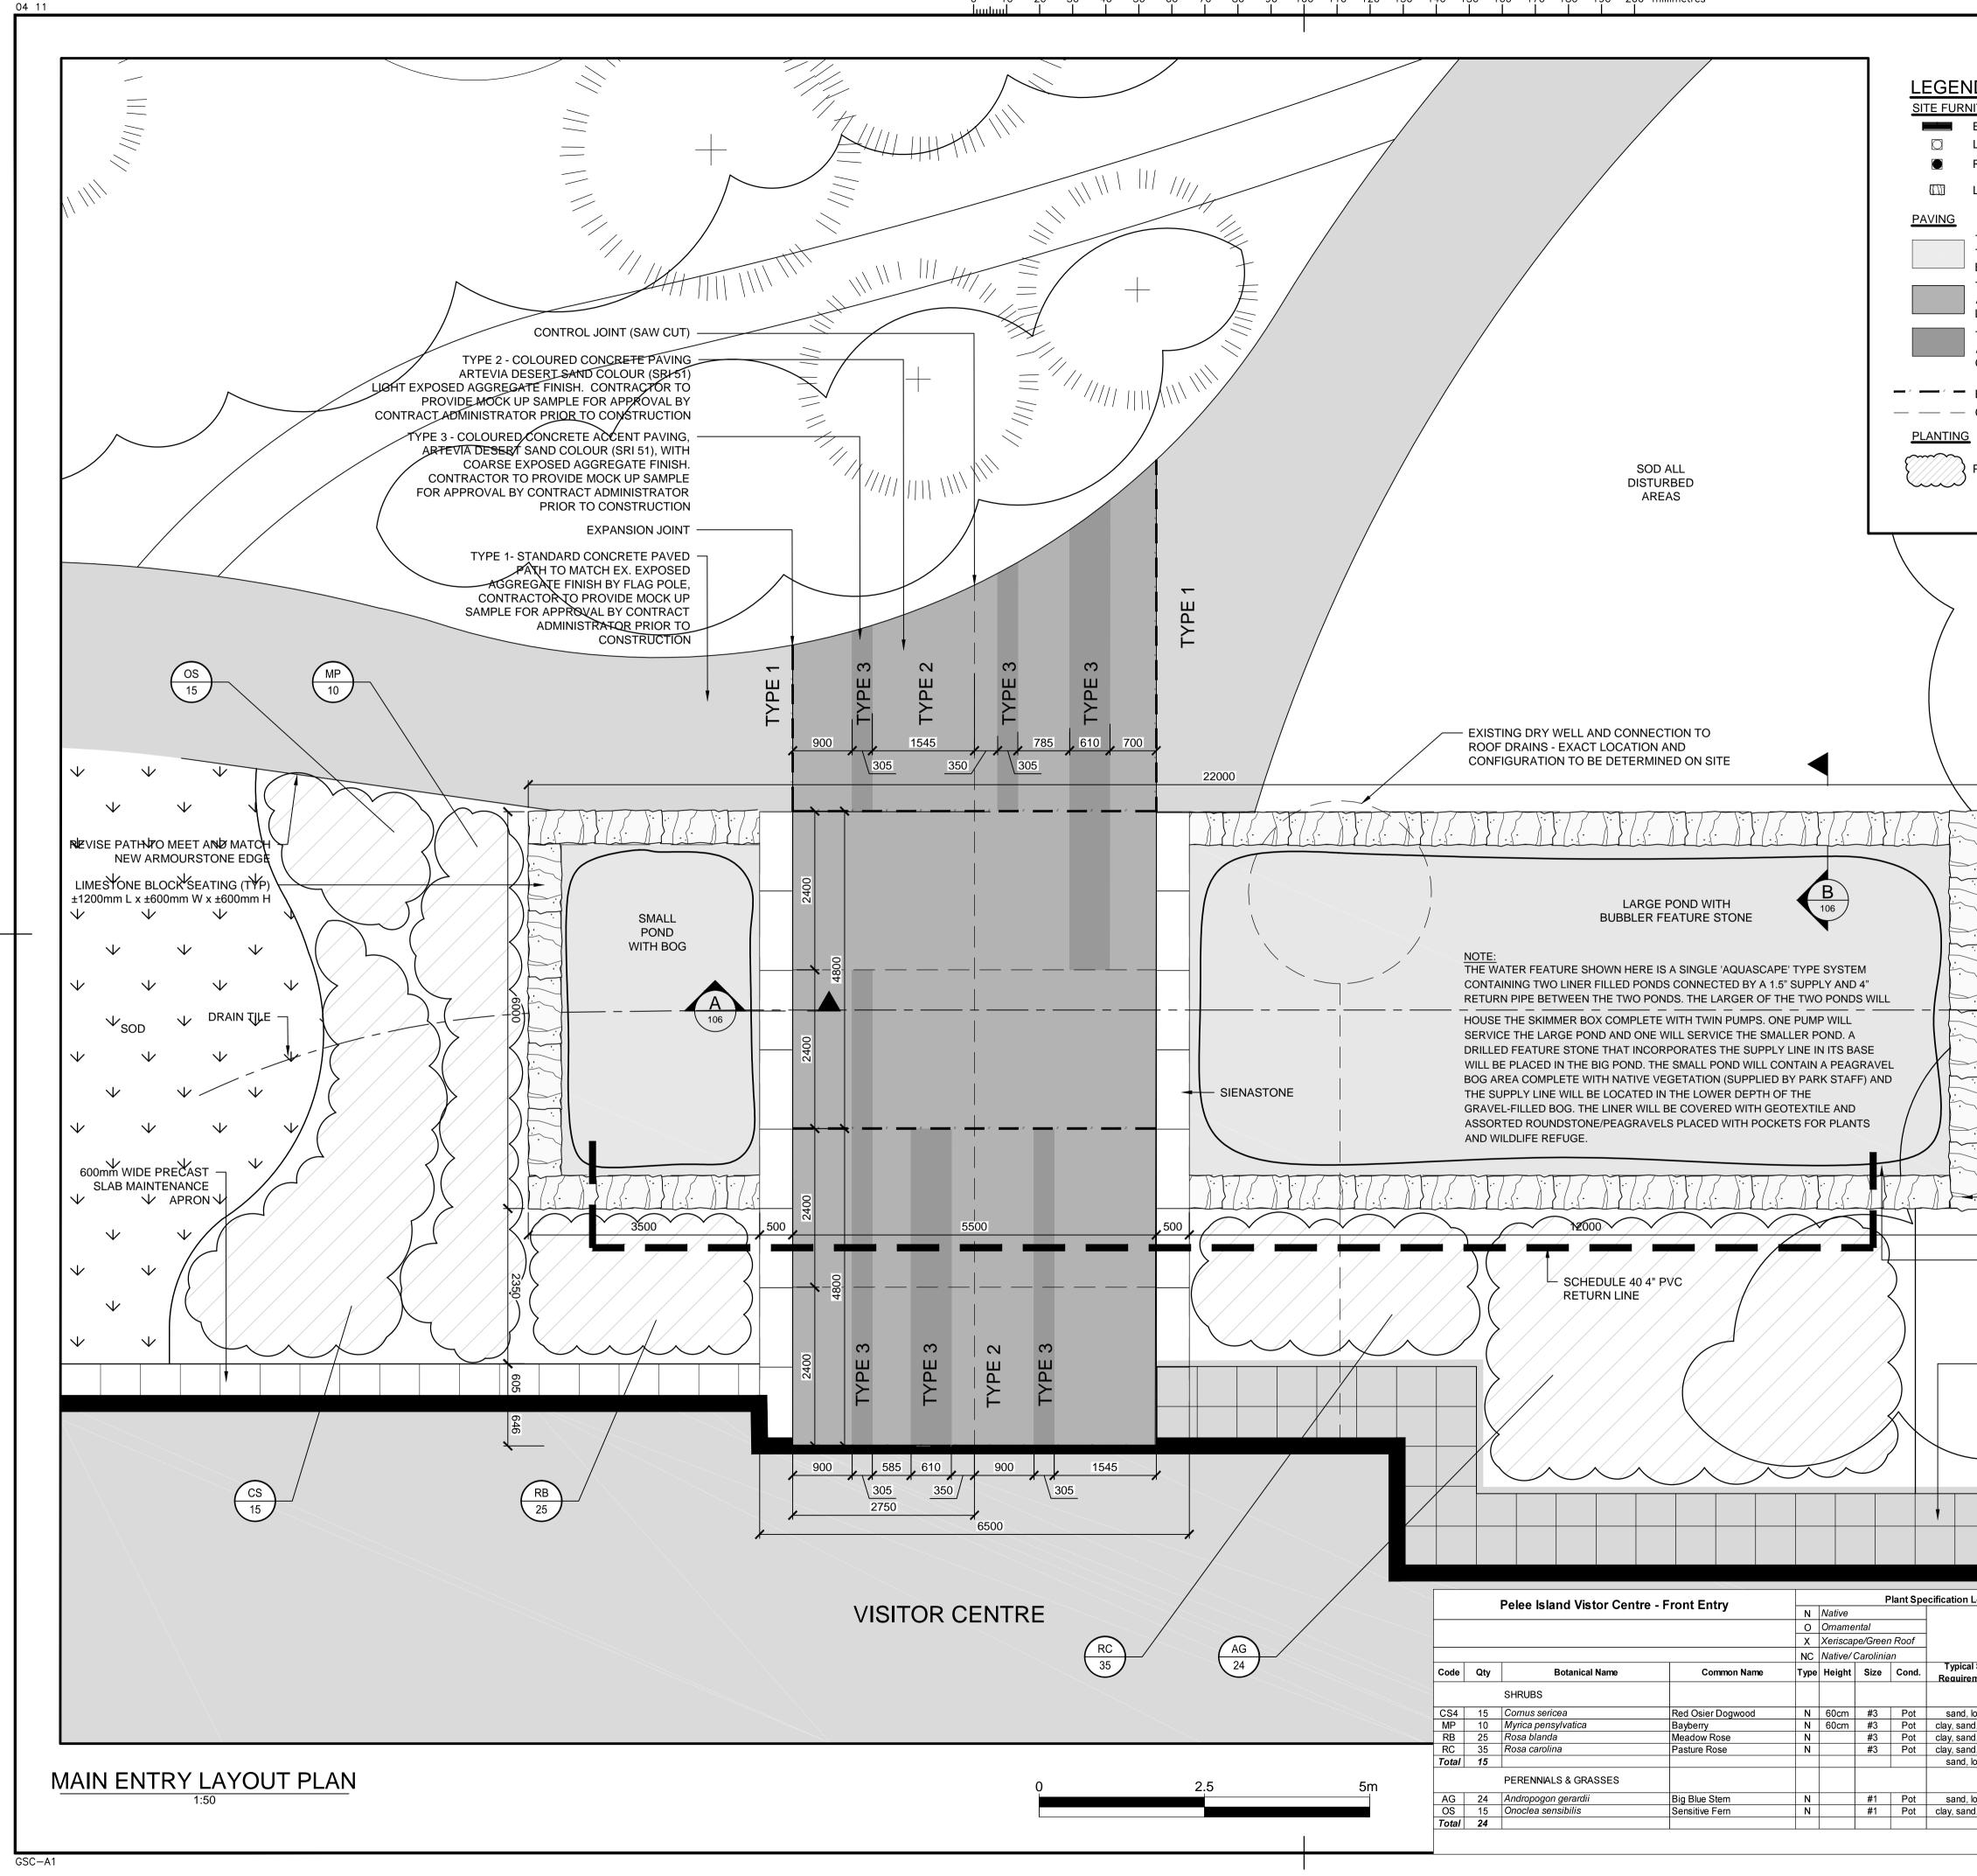

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	PARKS CANADA PARCS CANADA
ID BENCH (8) LITTER RECEPTACLE (4) RECYCLING RECEPTACLE (2) LIMESTONE BLOCK 51)	SOUTHWESTERN ONTARIO FIELD UNIT
TYPE 1- STANDARD CONCRETE PAVED PATH TO MATCH EX. EXPOSED AGGREGATE FINISH BY FLAG POLE TYPE 2 - COLOURED CONCRETE PAVING ARTEVIA DESERT SAND COLOUR (SRI 51) LIGHT EXPOSED AGGREGATE FINISH TYPE 3 - COLOURED CONCRETE ACCENT PAVIN	
ARTEVIA DESERT SAND COLOUR (SRI 51) COARSE EXPOSED AGGREGATE FINISH EXPANSION JOINT CONTROL JOINT	G DILLON CONSULTING
PLANTING BED	
	NOT FOR CONSTRUCTION
DRAIN TILE - ROUTE NEW DRAIN TILE TO EXISTING DRY WELL, CONTRACTOR TO CONFIRM LOCATION WITH CONTRACT ADMINISTRATOR	Image:
ARMOURSTONE SEE DETAIL 2, L106 SKIMMER PUMP MECHANICALS. PROVIDE ELECTRICAL SERVICE COMPLETE WITH LOCKABLE ENCLOSURE	A Detail No. No. du détail drawing no. – where detail required dessin no. – où détail exigé drawing no. – where detailed dessin no. – où détaillé project title titre du projet LEAMINGTON ONTARIO POINT PELEE NATIONAL PARK 1118 POINT PELEE DR. LEAMINGTON, N8H 3V4 VISITOR CENTRE THEATRE
1200mm WIDE PRECAST SLAB MAINTENANCE APRON	drawing title titre du dessin VISITOR CENTRE MAIN ENTRY
	drawn by dessine par SLS designed by conc par SLS
Legend Special considerations outline the	approved by approuve par LDP
al Soil Typical Moisture Special Considerations	tender project manager soumission DCW administrateur de projets
loam normal, moist, wet nd, loam dry, normal nd, loam dry, normal nd, loam dry, moist, wet	project date date du projet APRIL 2015
loam dry, normal, moist	no. du projet 138383 drawing no.
id, loam moist, wet	drawing no. dessine no. L104




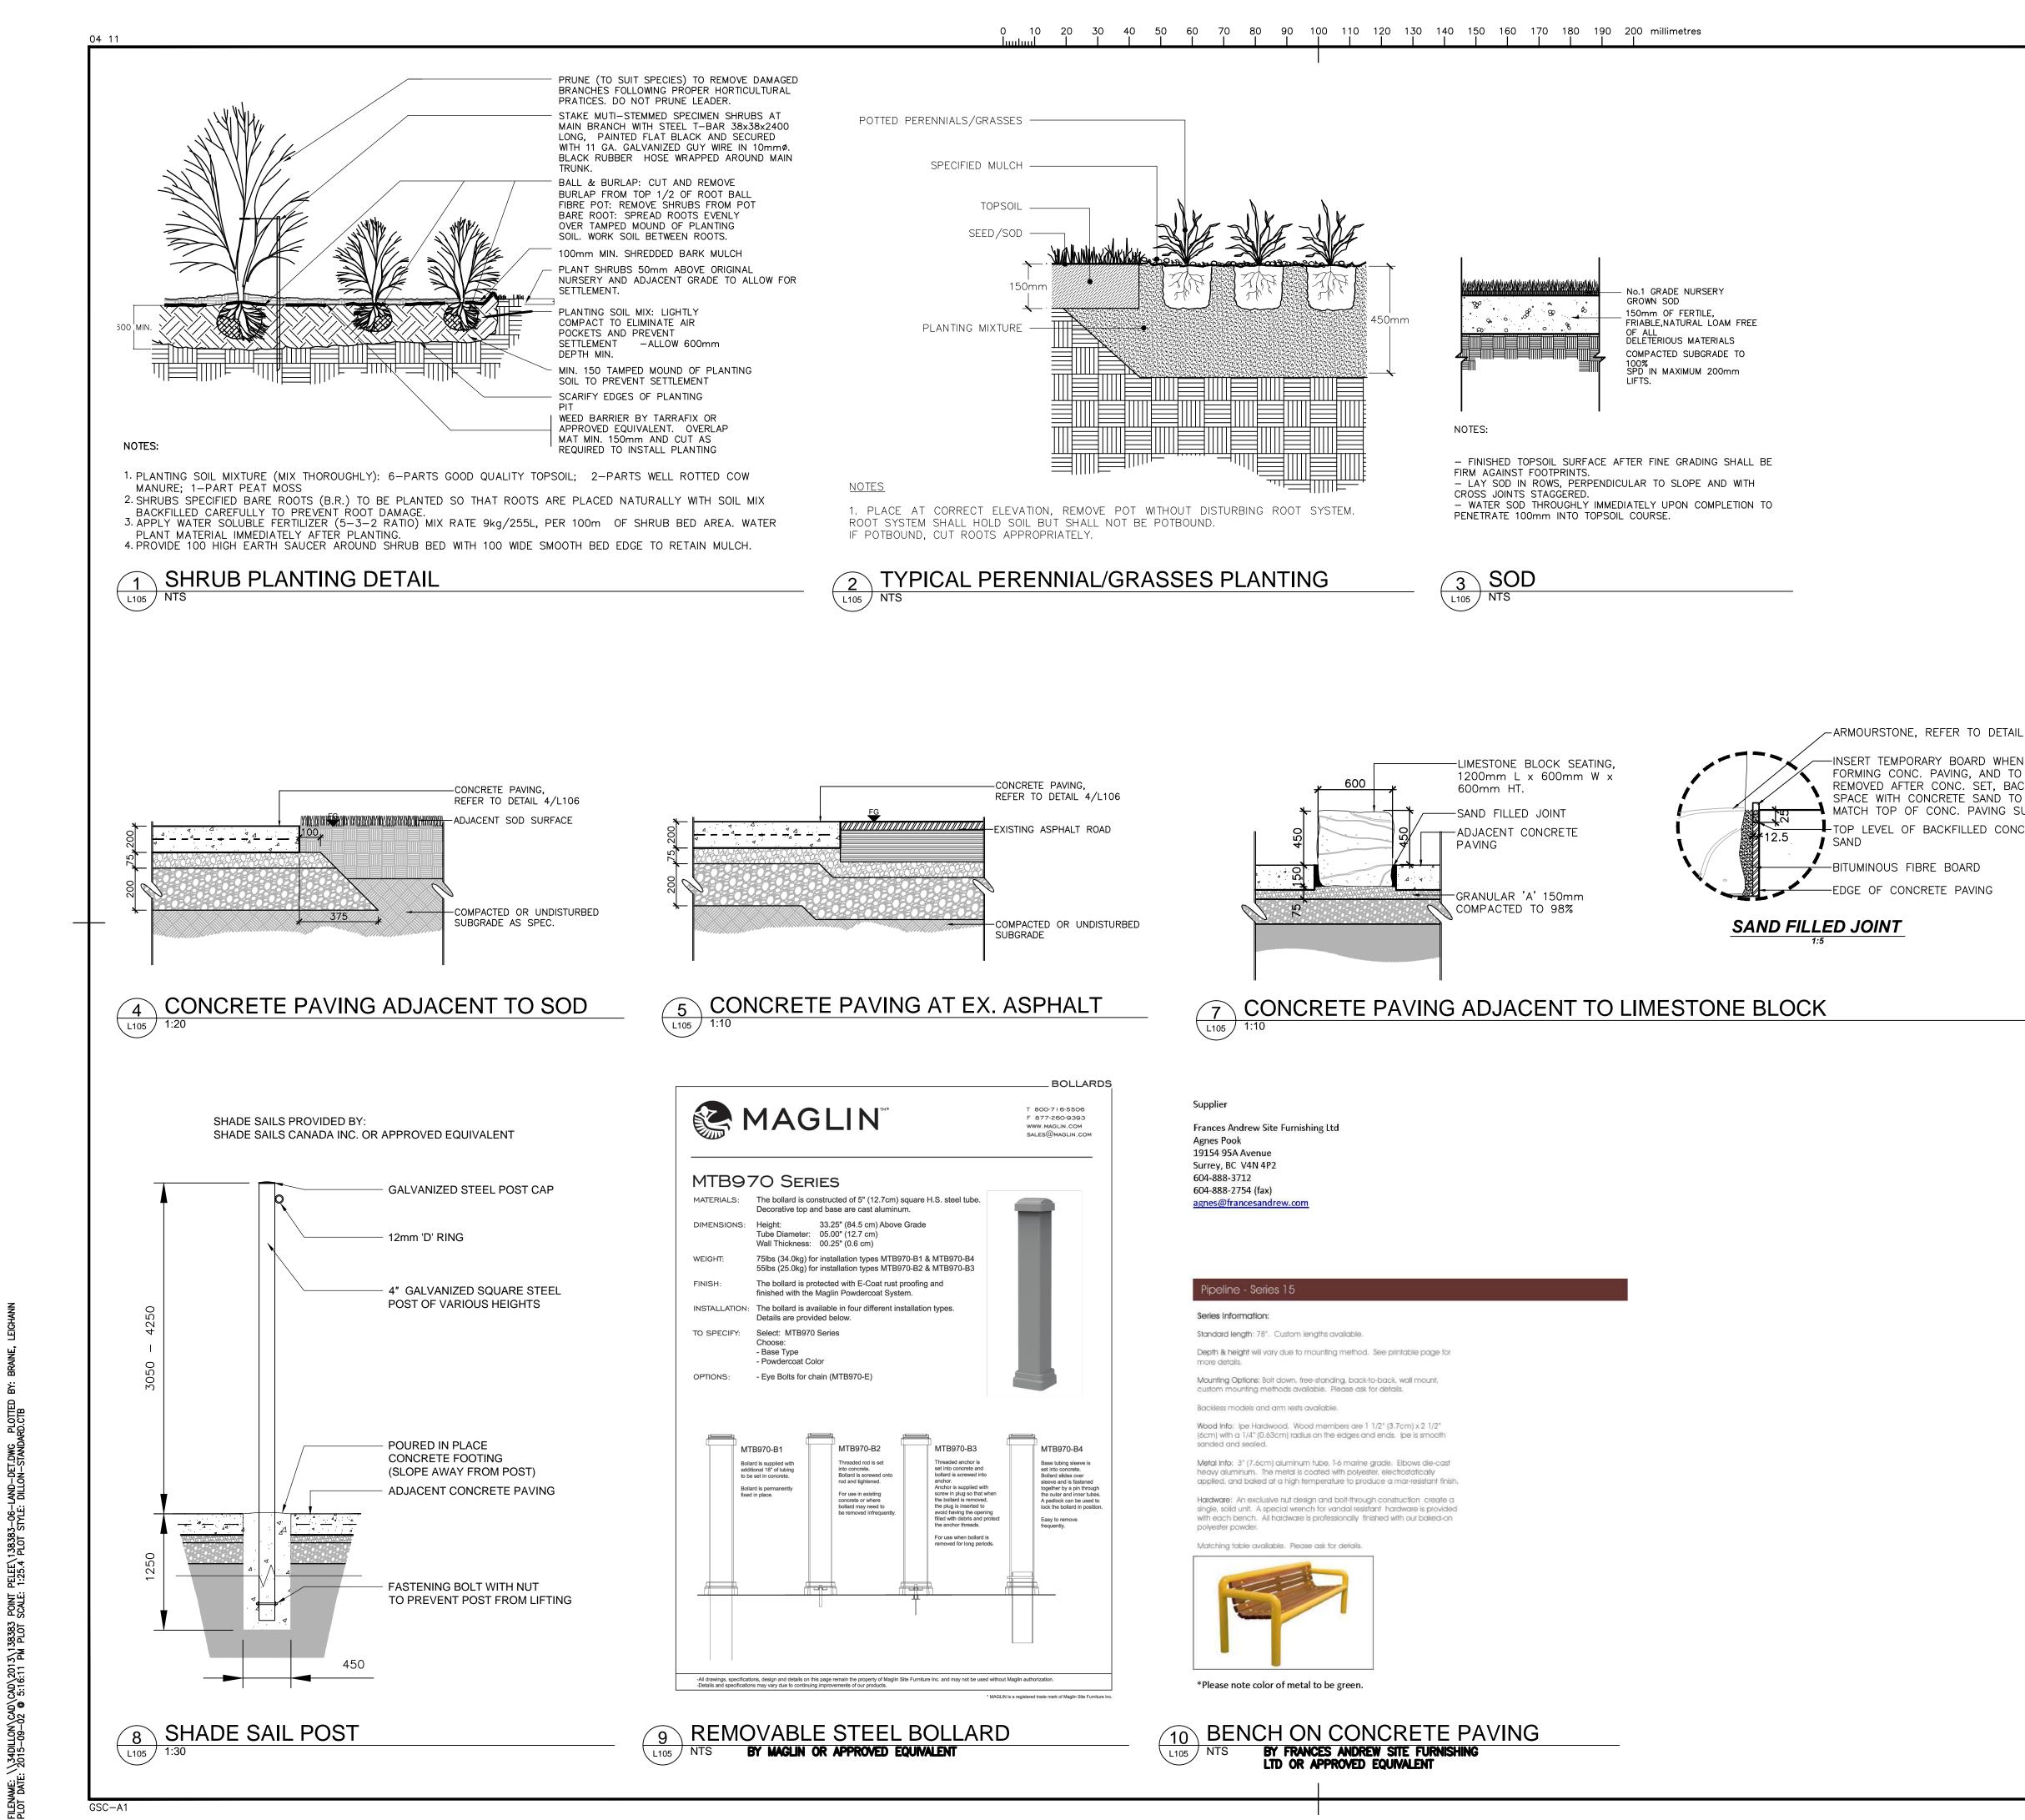
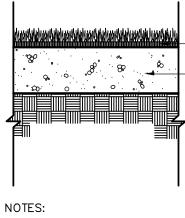
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LEAMINGTON, VISITOR CE		ATRE
drawing title titre du dessin		
LANDSCAP	e details	5
drawn by dessine par S	LS	
designed by	LS	
approved by approuve par)P	
	CW	project manager administrateur de projets
	PRIL 201	5
project no. no. du projet 1 drawing no.	38383	

FORMING CONC. PAVING, AND TO BE REMOVED AFTER CONC. SET, BACKFILL SPACE WITH CONCRETE SAND TO A MATCH TOP OF CONC. PAVING SURFACE TOP LEVEL OF BACKFILLED CONCRETE

-BITUMINOUS FIBRE BOARD -EDGE OF CONCRETE PAVING

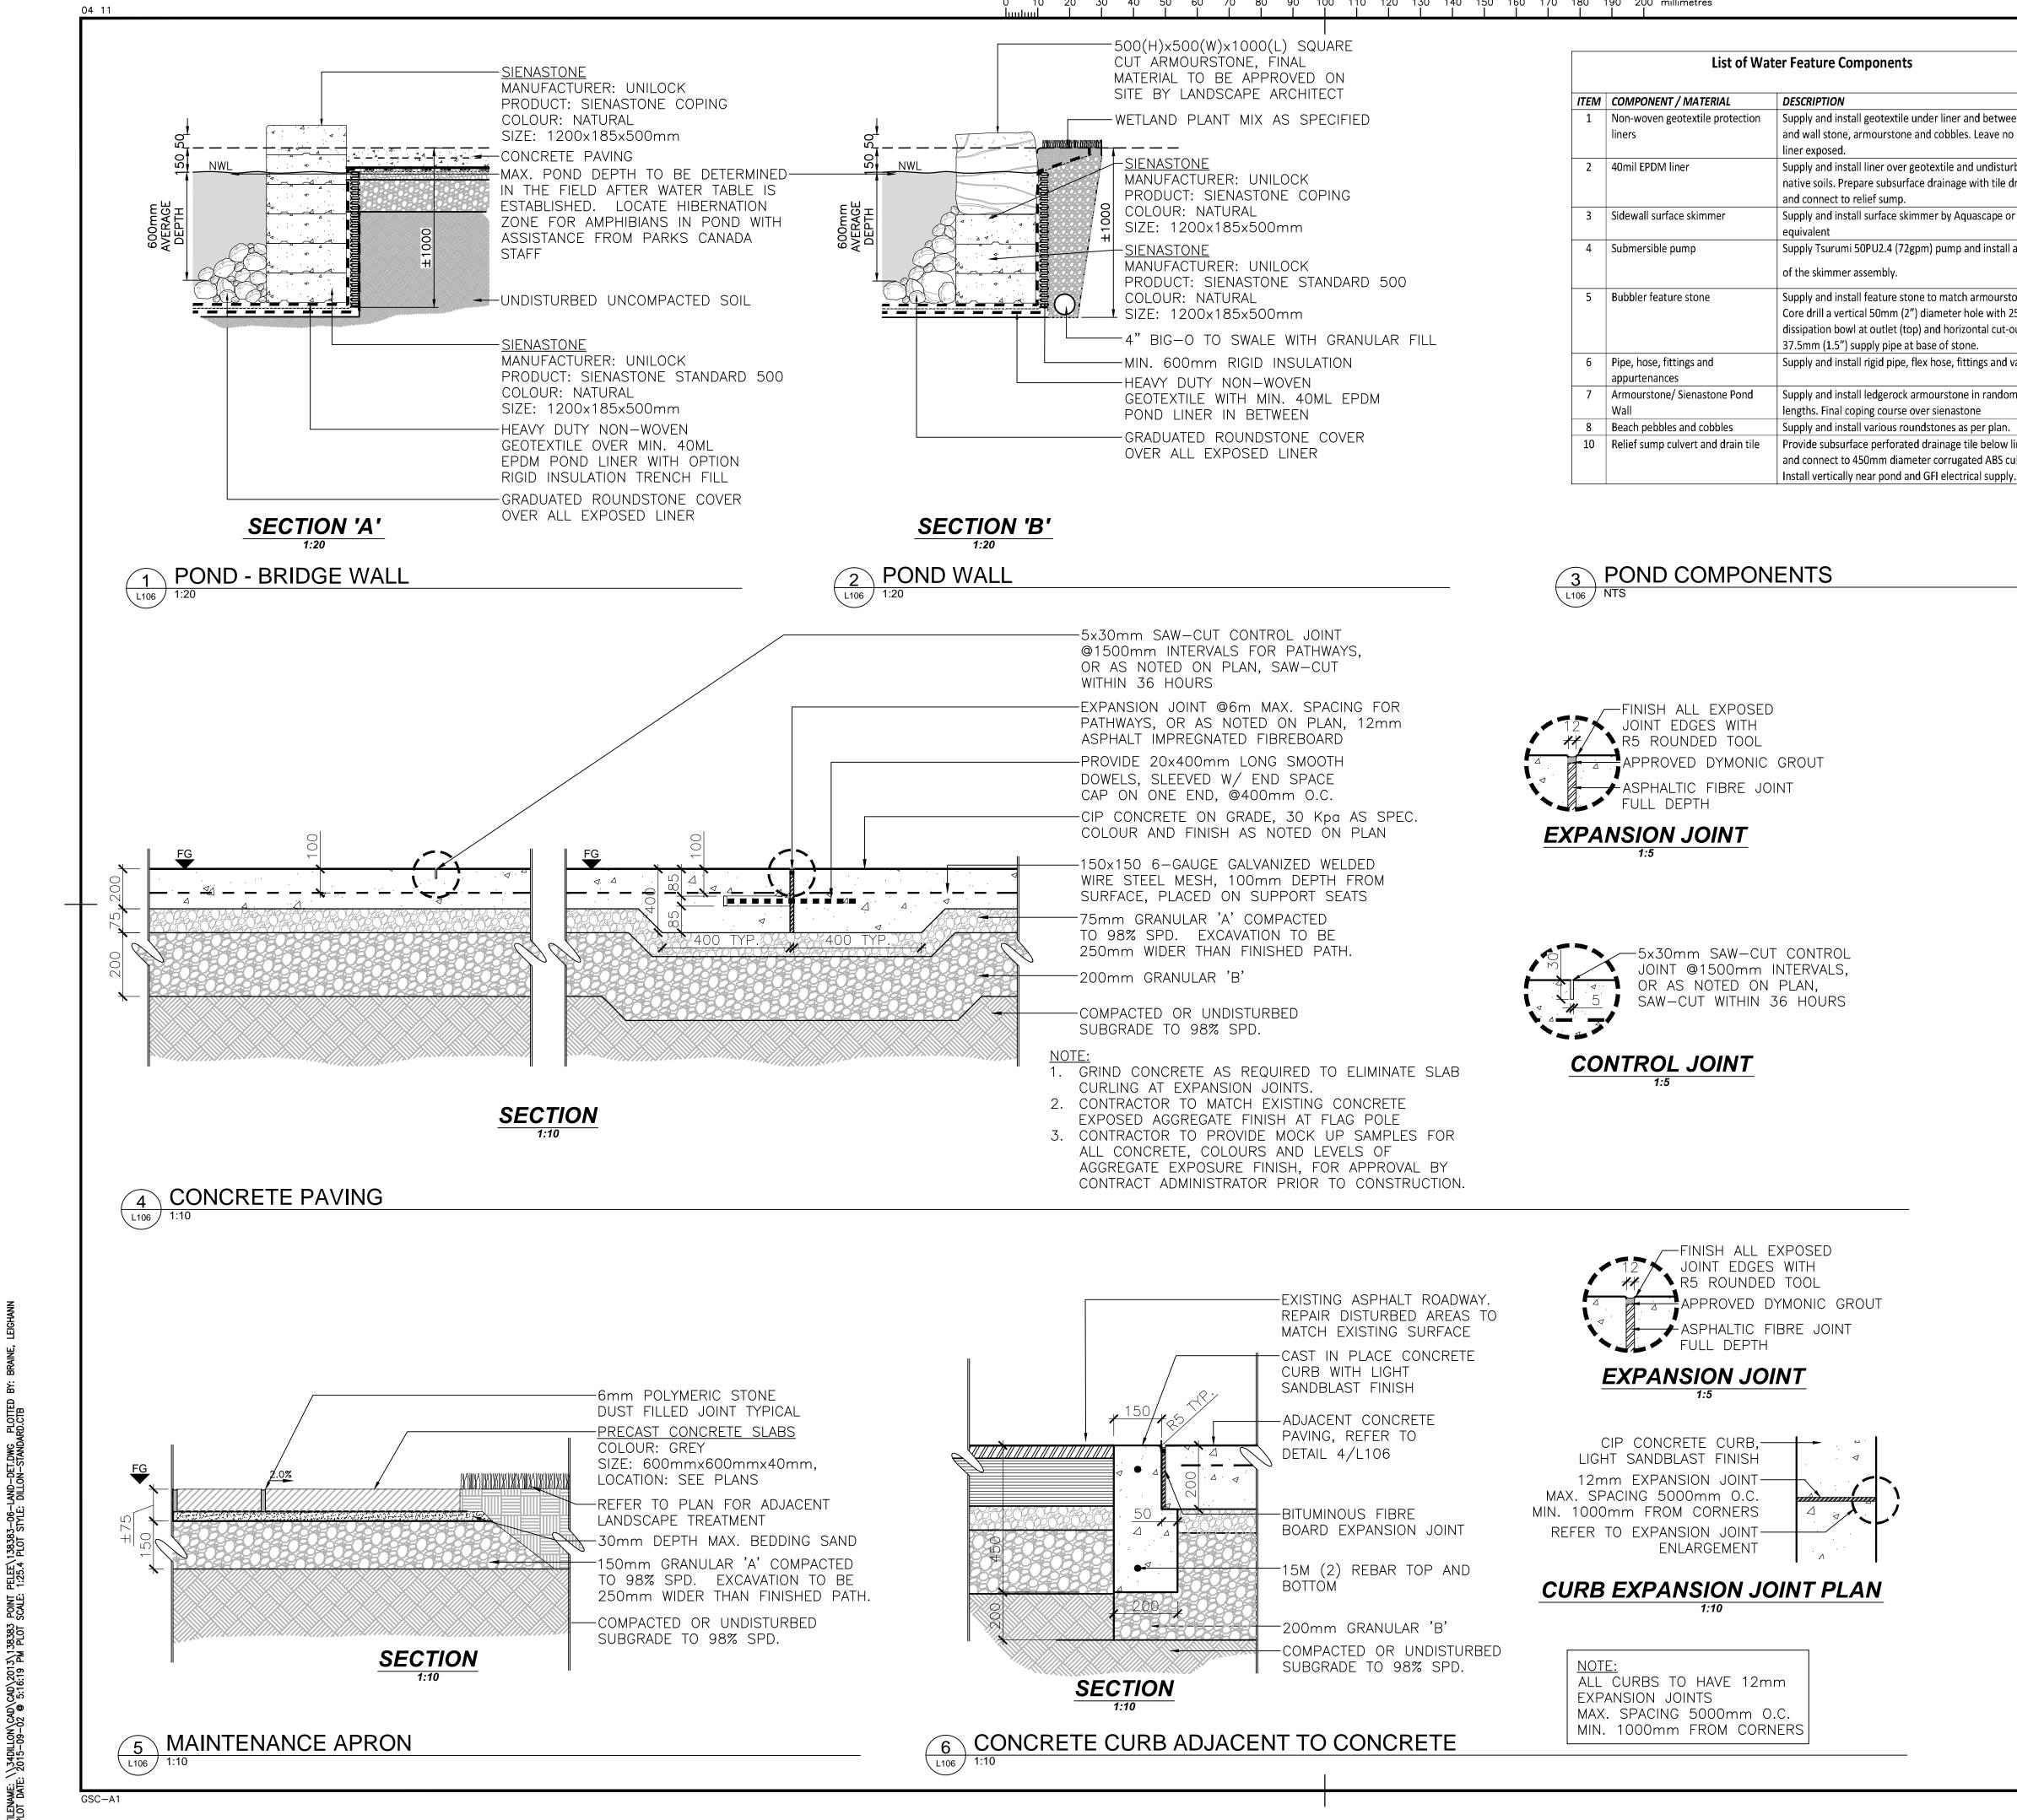


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FILEN

		500(H)x500(W)x1000(L) SQUARE CUT ARMOURSTONE, FINAL MATERIAL TO BE APPROVED ON		List of Wa	ter Feature Component
		SITE BY LANDSCAPE ARCHITECT	ITEM	COMPONENT / MATERIAL	DESCRIPTION
		WETLAND PLANT MIX AS SPECIFIED	1	Non-woven geotextile protection	Supply and install geotextile
				liners	and wall stone, armourstor liner exposed.
NWL		- <u>SIENASTONE</u> MANUFACTURER: UNILOCK PRODUCT: SIENASTONE COPING	2	40mil EPDM liner	Supply and install liner over native soils. Prepare subsur and connect to relief sump.
	±1000	COLOUR: NATURAL SIZE: 1200x185x500mm	3	Sidewall surface skimmer	Supply and install surface sl equivalent
		– <u>SIENASTONE</u> MANUFACTURER: UNILOCK PRODUCT: SIENASTONE STANDARD 500	4	Submersible pump	Supply Tsurumi 50PU2.4 (7. of the skimmer assembly.
		COLOUR: NATURAL L SIZE: 1200x185x500mm —4" BIG—0 TO SWALE WITH GRANULAR FILL	5	Bubbler feature stone	Supply and install feature s Core drill a vertical 50mm (dissipation bowl at outlet (1 37.5mm (1.5") supply pipe
		-MIN. 600mm RIGID INSULATION -HEAVY DUTY NON-WOVEN	6	Pipe, hose, fittings and appurtenances	Supply and install rigid pipe
		GEOTEXTILE WITH MIN. 40ML EPDM POND LINER IN BETWEEN	7	Armourstone/ Sienastone Pond Wall	Supply and install ledgerock lengths. Final coping course
		-GRADUATED ROUNDSTONE COVER	8	Beach pebbles and cobbles	Supply and install various re
		OVER ALL EXPOSED LINER	10	Relief sump culvert and drain tile	Provide subsurface perfora and connect to 450mm dia






ts
le under liner and between liner
ne and cobbles. Leave no EPDM
er geotextile and undisturbed
Irface drainage with tile drains
).
skimmer by Aquascape or
72gpm) pump and install as part
stone to match armourstone.
(2") diameter hole with 250mm
(top) and horizontal cut-out for

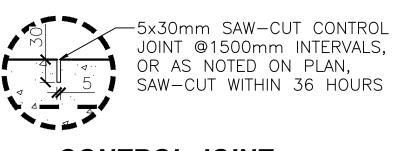ipe at base of stone. pipe, flex hose, fittings and valves. rock armourstone in random

urse over sienastone s roundstones as per plan. prated drainage tile below liner and connect to 450mm diameter corrugated ABS culvert.

*	PARKS CANADA PARCS CANADA
	TERN ONTARIO _D UNIT
	AGEMENT SECTION
	LLON SULTING
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1 ISSUED FOR TEND	ER AUG. 31, 2015
Verify all dimensions and immediately notify the eng	conditions on site and gineer of all discrepancies.
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project title titre du projet LEAMINGTON POINT PELEE NATI	
1118 POINT PELE LEAMINGTON, N8H	E DR. 3V4
drawing title titre du dessin	
LANDSCAPE [DETAILS
drown by	
drawn by dessine par SLS	
designed by conc par SLS approved by	
approuve par LDP tender	project manager
soumission DCW project date	administrateur de projets
	_ 2015
no. du projet 1383 drawing no.	383
dessine no. L106	



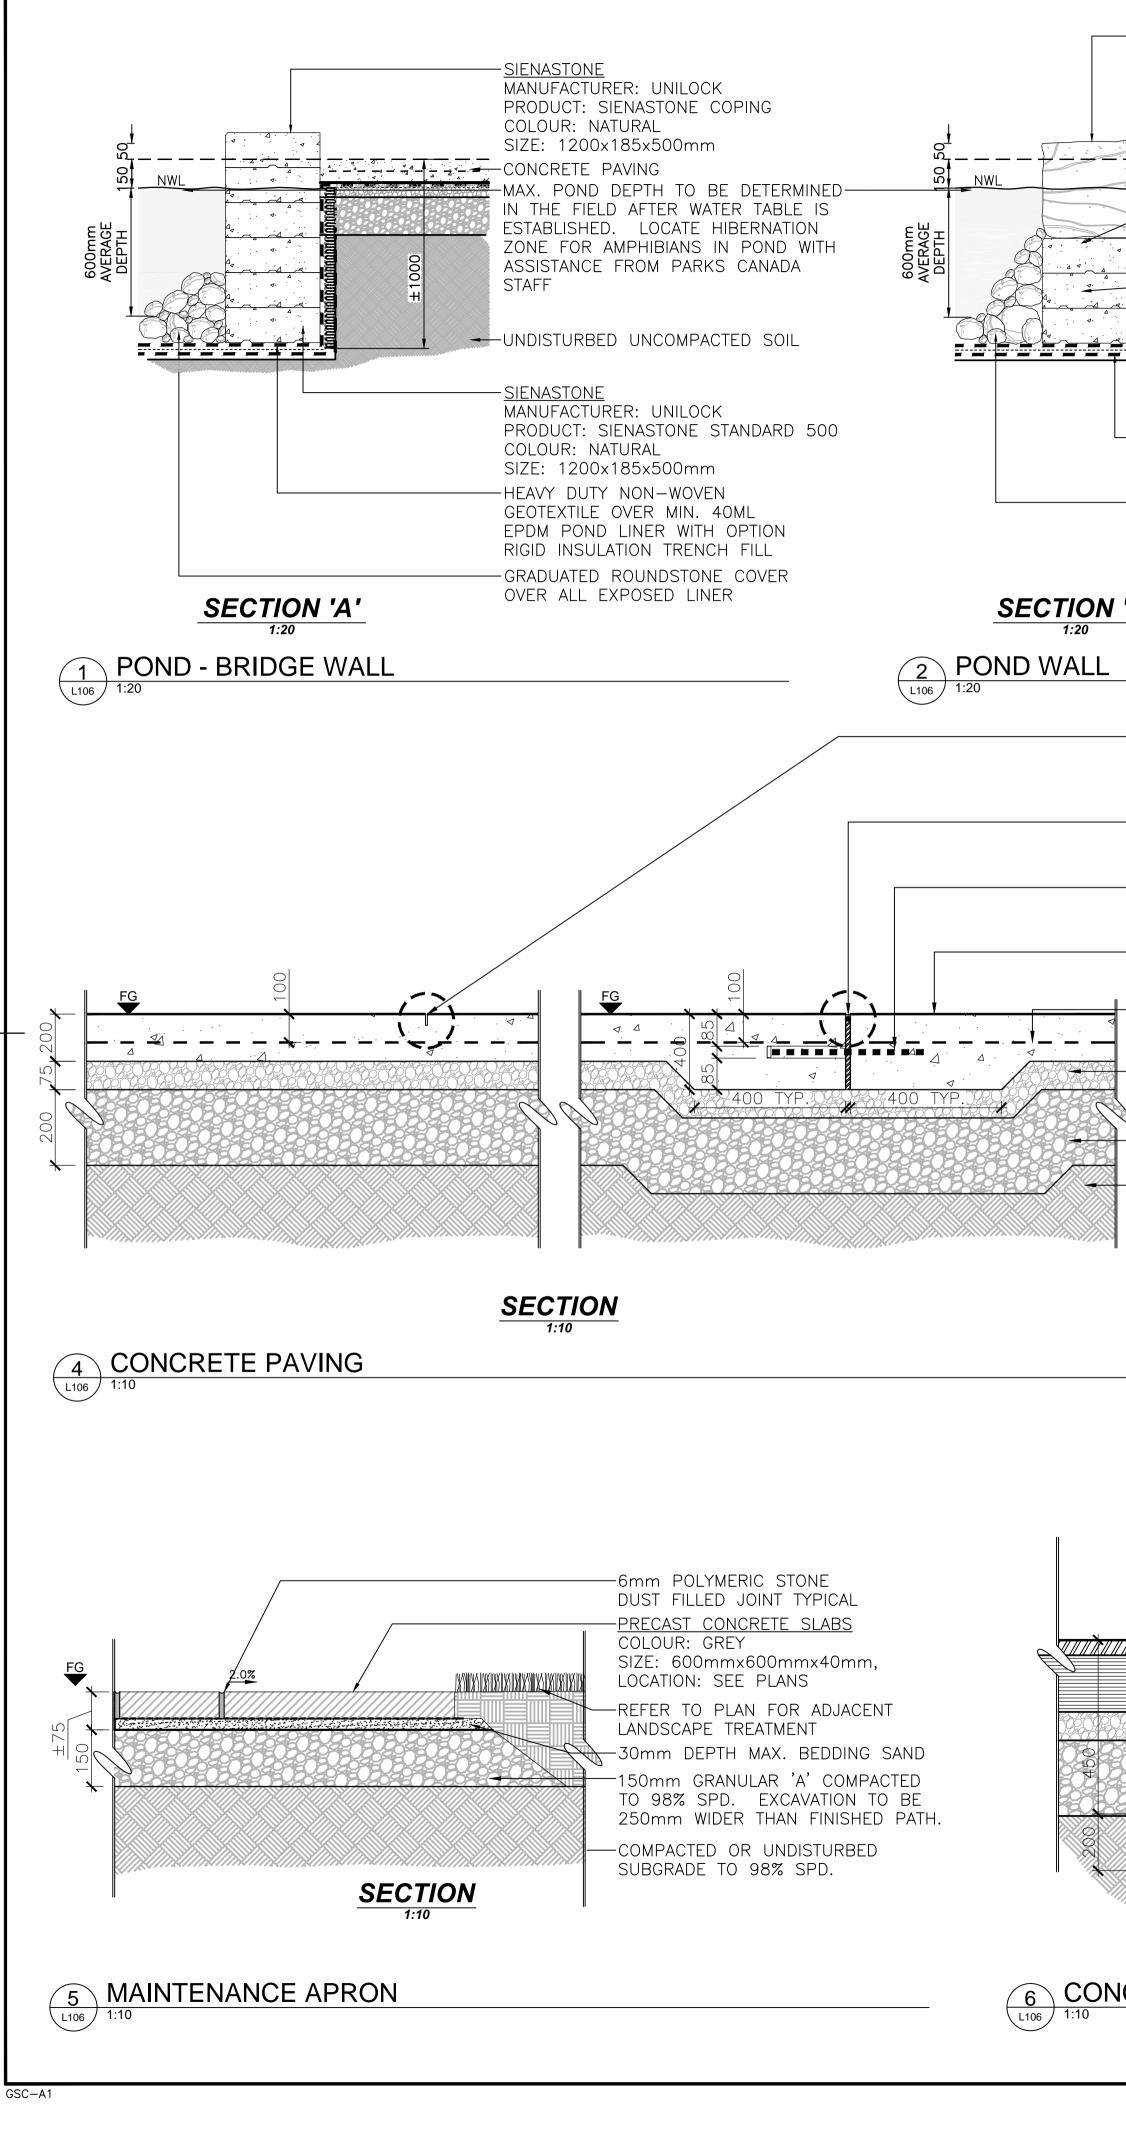

500(H)x500(W)x1000(L) SQUARE CUT ARMOURSTONE, FINAL MATERIAL TO BE APPROVED ON		List of Wa	ter Feature Components
SITE BY LANDSCAPE ARCHITECT	ITEM	COMPONENT / MATERIAL	DESCRIPTION
	1	Non-woven geotextile protection liners	Supply and install geotextile und and wall stone, armourstone an liner exposed.
SIENASTONE MANUFACTURER: UNILOCK PRODUCT: SIENASTONE COPING	2	40mil EPDM liner	Supply and install liner over geo native soils. Prepare subsurface and connect to relief sump.
COLOUR: NATURAL SIZE: 1200x185x500mm	3	Sidewall surface skimmer	Supply and install surface skimm equivalent
COLOUR: NATURAL SIZE: 1200x185x500mm SIENASTONE MANUFACTURER: UNILOCK PRODUCT: SIENASTONE STANDARD 500	4	Submersible pump	Supply Tsurumi 50PU2.4 (72gpn of the skimmer assembly.
COLOUR: NATURAL SIZE: 1200x185x500mm 4" BIG-0 TO SWALE WITH GRANULAR FILL	5	Bubbler feature stone	Supply and install feature stone Core drill a vertical 50mm (2") d dissipation bowl at outlet (top) a 37.5mm (1.5") supply pipe at ba
MIN. 600mm RIGID INSULATION	6	Pipe, hose, fittings and appurtenances	Supply and install rigid pipe, flex
GEOTEXTILE WITH MIN. 40ML EPDM POND LINER IN BETWEEN	7	Armourstone/ Sienastone Pond Wall	Supply and install ledgerock arm lengths. Final coping course ove
	8	Beach pebbles and cobbles	Supply and install various round
GRADUATED ROUNDSTONE COVER OVER ALL EXPOSED LINER	10	Relief sump culvert and drain tile	Provide subsurface perforated d and connect to 450mm diameter

SECTION 'B' 1:20

1:20		
ND WALL		3 POND COMPONENTS
		L106 NTS
	— EXPANSION JOINT @6m MAX. SPACING FOR PATHWAYS, OR AS NOTED ON PLAN, 12mm ASPHALT IMPREGNATED FIBREBOARD	12 JOINT EDGES WITH R5 ROUNDED TOOL APPROVED DYMONIC GROUT
	PROVIDE 20x400mm LONG SMOOTH DOWELS, SLEEVED W/ END SPACE CAP ON ONE END, @400mm O.C.	ASPHALTIC FIBRE JOINT
	 CIP CONCRETE ON GRADE, 30 Kpa AS SPEC. WITH LIGHT SANDBLAST FINISH, OR AS NOTED ON PLAN 150×150 6-GAUGE GALVANIZED WELDED WIRE STEEL MESH, 100mm DEPTH FROM SURFACE, PLACED ON SUPPORT SEATS 	EXPANSION JOINT 1:5
		5x30mm SAW-CUT CONTROL JOINT @1500mm INTERVALS,
	200mm GRANULAR 'B'	OR AS NOTED ON PLAN, 5 SAW-CUT WITHIN 36 HOURS
	COMPACTED OR UNDISTURBED SUBGRADE TO 98% SPD.	
	<u>NOTE:</u> 1. GRIND CONCRETE AS REQUIRED TO ELIMINATE	CONTROL JOINT
	SLAB CURLING AT EXPANSION JOINTS.	

-EXISTING ASPHALT ROADWAY.

MATCH EXISTING SURFACE


CAST IN PLACE CONCRETE

CURB WITH LIGHT

SANDBLAST FINISH

REPAIR DISTURBED AREAS TO

SLAB CURLING AT EXPANSION JUINTS. MATCH EXISTING CONCRETE AT FLAG POLE 2. 3. CONTRACTOR TO PROVIDE SAMPLES FOR COLOUR AND LEVELS OF EXPOSURE FINISH

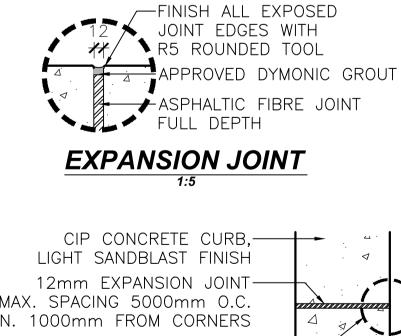

Supply and install geotextile under liner and between liner

and wall stone, armourstone and cobbles. Leave no EPDM

Supply and install liner over geotextile and undisturbed

native soils. Prepare subsurface drainage with tile drains

Supply Tsurumi 50PU2.4 (72gpm) pump and install as part

Supply and install feature stone to match armourstone.

Core drill a vertical 50mm (2") diameter hole with 250mm dissipation bowl at outlet (top) and horizontal cut-out for

Supply and install rigid pipe, flex hose, fittings and valves.

Supply and install ledgerock armourstone in random

Provide subsurface perforated drainage tile below liner

and connect to 450mm diameter corrugated ABS culvert. Install vertically near pond and GFI electrical supply.

37.5mm (1.5") supply pipe at base of stone.

lengths. Final coping course over sienastone Supply and install various roundstones as per plan.

Supply and install surface skimmer by Aquascape or

- ADJACENT CONCRETE PAVING, REFER TO DETAIL 4/L106 MAX. SPACING 5000mm O.C. MIN. 1000mm FROM CORNERS -BITUMINOUS FIBRE REFER TO EXPANSION JOINT-BOARD EXPANSION JOINT ENLARGEMENT -15M (2) REBAR TOP AND CURB EXPANSION JOINT PLAN BOTTOM 1:10 -200mm GRANULAR 'B' -COMPACTED OR UNDISTURBED <u>NOTE:</u> SUBGRADE TO 98% SPD. ALL CURBS TO HAVE 12mm EXPANSION JOINTS MAX. SPACING 5000mm O.C.

6 CONCRETE CURB ADJACENT TO CONCRETE

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SECTION

1:10


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MIN. 1000mm FROM CORNERS


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Report any discrepancies to I	-
than those intended at the tim	e it, or use it for purposes other ne of its preparation without prior
written permission from Dillon	Consulting Limited.
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Do not scale drawings. Verify all dimensions and immediately notify the end	conditions on site and gineer of all discrepancies.
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1118 POINT PELE LEAMINGTON, N8H VISITOR CENTE	3V4
drawing title titre du dessin	
LANDSCAPE [DETAILS
drawn by dessine par	
designed by	
conc par SLS approved by	
approuve par LDP	project menser
soumission DCW	project manager administrateur de projets
	_ 2015
project no. no. du projet 1383	383
drawing no. dessine no. L106	




*	PARKS CANADA Parcs canada
	TERN ONTARIO _D UNIT
ASSET MAN	NAGEMENT SECTION
Building Engineers 130 Dufferin Avenu Phone: (519) 438	LLON g Design Ltd. and Architects re, London, Ontario, N6A 5R2 B-6192, Fax (519) 672-8209 london@dillon.ca
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project title titre du projet LEAMINGTON POINT PELEE NAT 1118 POINT PELE LEAMINGTON, N8H	IONAL PARK
VISITOR CENTR	
drawing title titre du dessin	
drawing title titre du dessin	
drawing title titre du dessin SITE PLAN	
drawing title titre du dessin SITE PLAN drawn by dessine par MGS	
VISITOR CENTR drawing title titre du dessin SITE PLAN drawn by dessine par MGS designed by conc par LDP approved by approved by approved par	
VISITOR CENTR drawing title titre du dessin SITE PLAN drawn by dessine par MGS designed by conc par LDP approved by approved by approved by approved par tender soumission MARK	Project manager
VISITOR CENTR drawing title titre du dessin SITE PLAN drawn by dessine par MGS designed by conc par LDP approved by approved by approved by approved par tender soumission MARK	K MAJOR project manager administrateur de projets 3/11/18

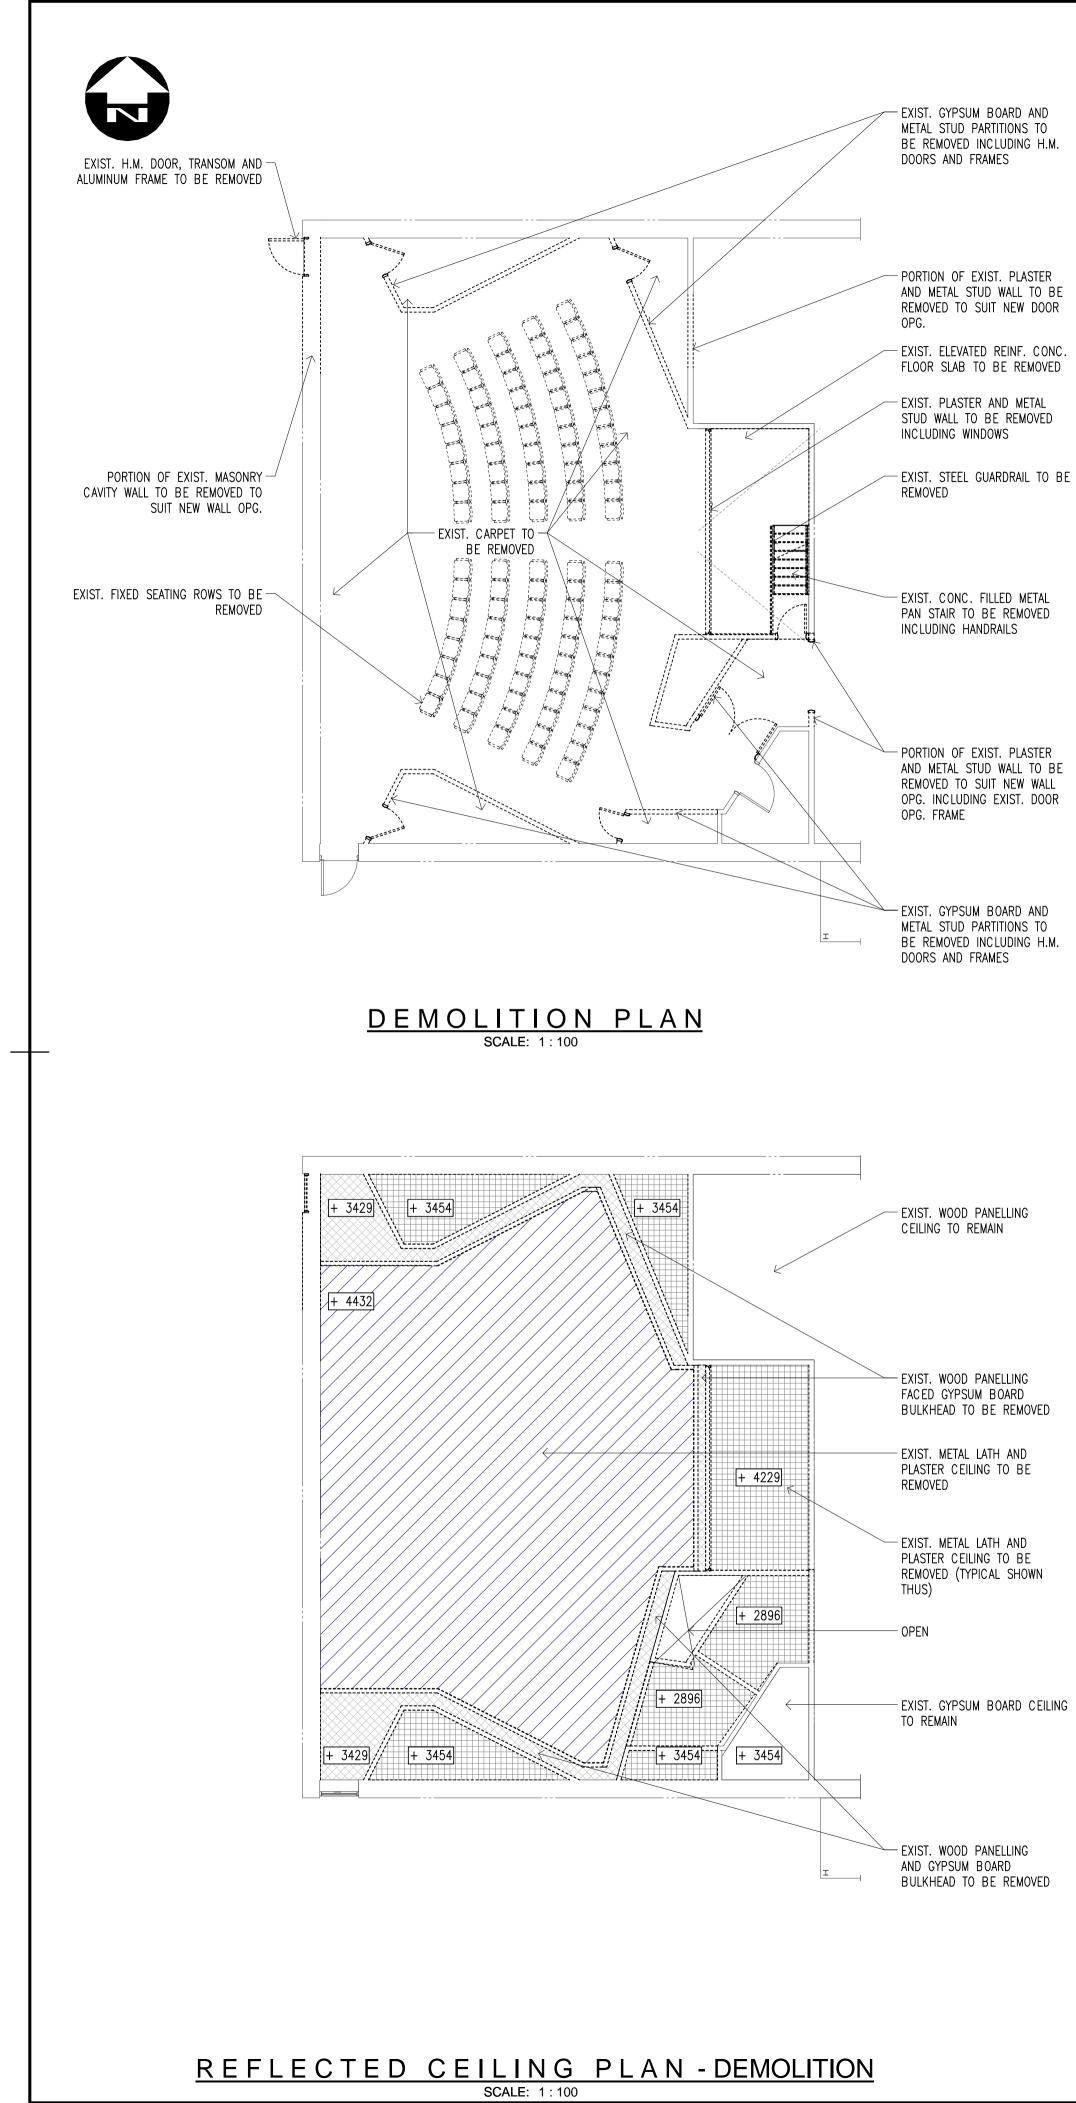


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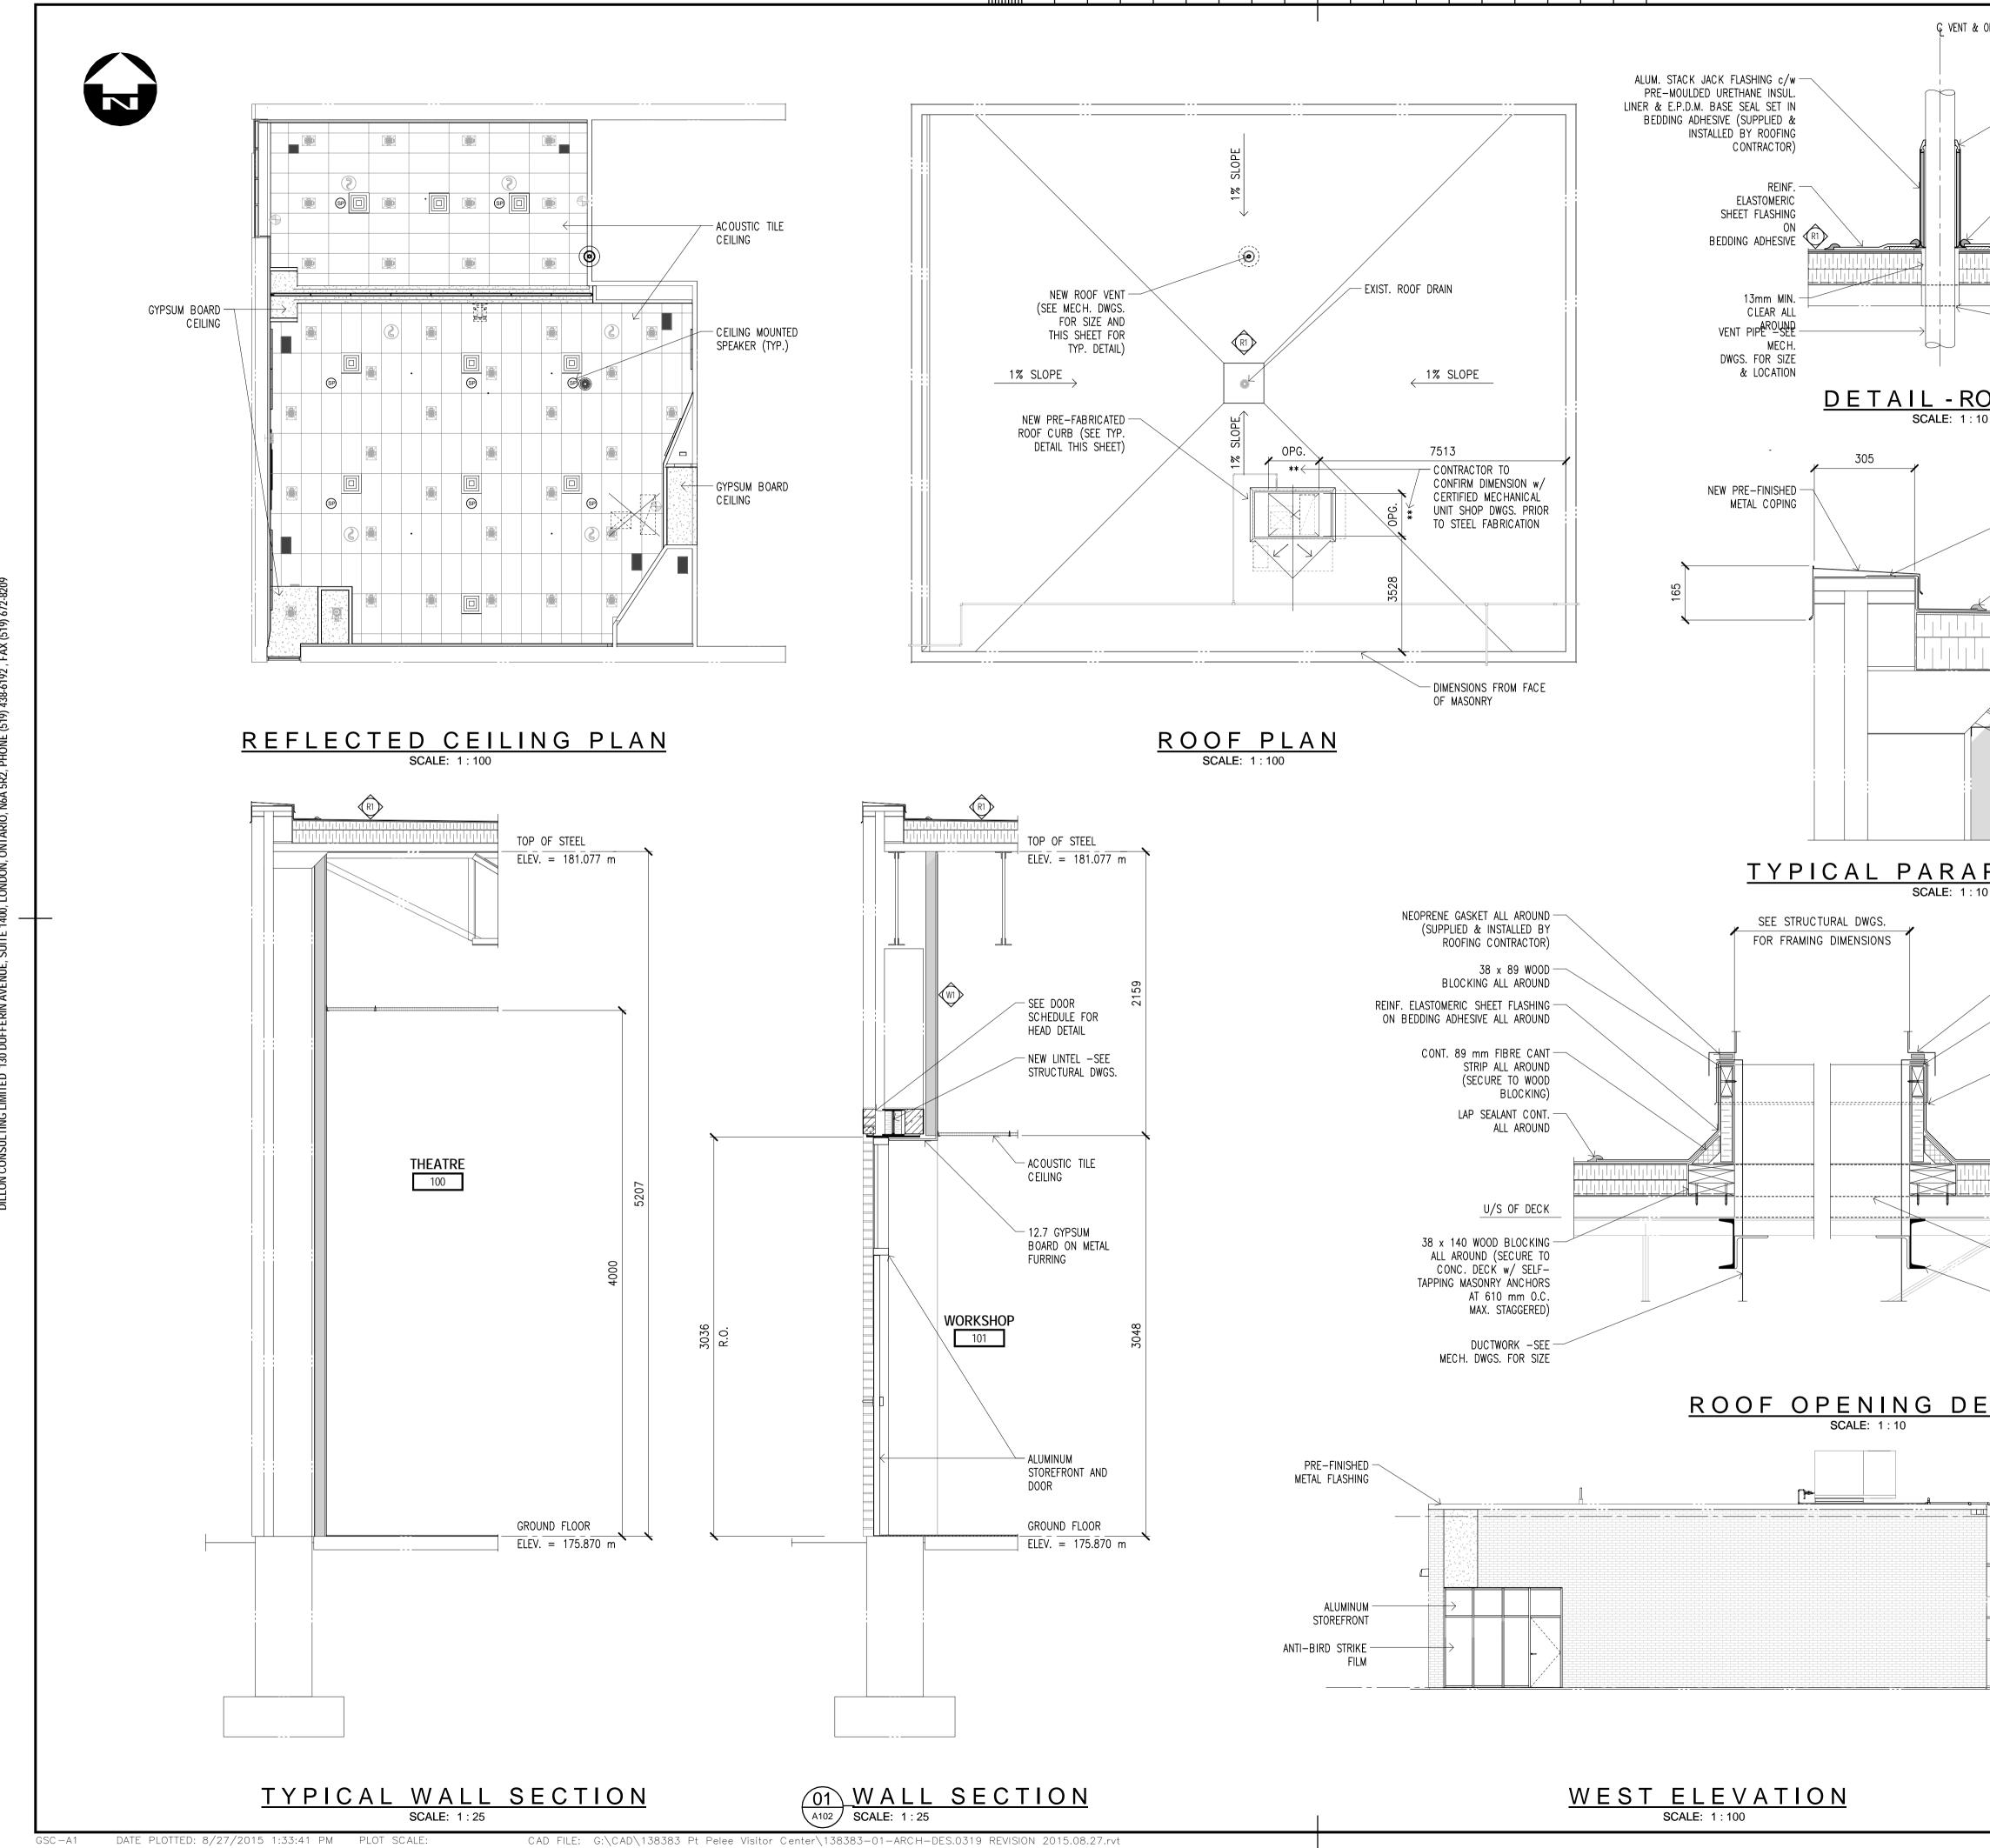
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	Building Engineers a 130 Dufferin Avenue, Phone: (519) 438-6	LON Design Ltd. and Architects London, Ontario, N6A 5R2 192, Fax (519) 672-8209 ndon@dillon.ca
		DNSTRUCTION
	Conditions of Use Verify elevations and/or dimensions discrepancies to Dillon Consulting L Do not scale dimensions from draw	s on drawing prior to use. Report any .imited.
	intended at the time of its preparation from Dillon Consulting Limited.	
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TOP OF STEEL ELEV. = 181.077 m	titre du projet LEAMINGTON POINT PELEE NATIO 1118 POINT PELEE LEAMINGTON, N8H VISITOR CENTRI	DNAL PARK DR. 3V4
GROUND FLOOR ELEV. = 175.870 m	drawing title titre du dessin ARC HITECTURA DEMOLITION PI ELEVATION ANI CROSS—SECTIO drawn by dessine par MGS	LAN, D
	designed by conc par LDP approved by approuve par tender soumission	project manager administrateur de projets
	project date date du projet 2013, project no. no. du projet 1383	/11/18
	drawing no. dessine no. A101	

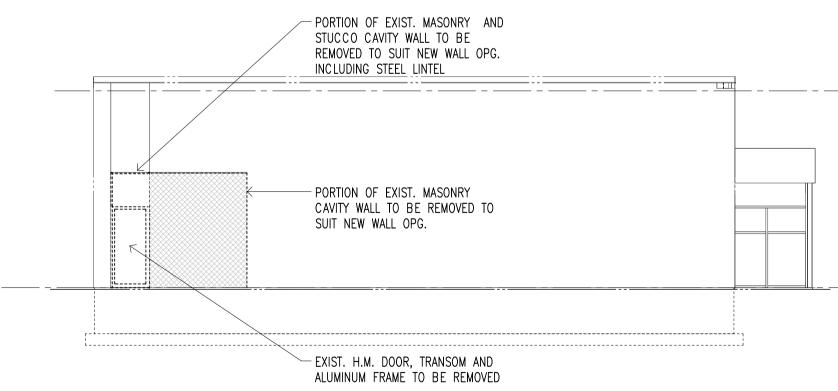

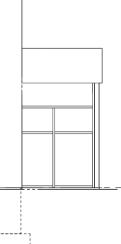


		FURNITURE SCHEDULE			
	NUMBER REQ'D	ТҮРЕ	SIZE	DESCRIPTION	
<u>GROUND FLOOR PLAN</u>	4 54	FREESTANDING STORAGE UNIT STACKABLE CHAIR	908 mm W x 610 mm D -	3048 mm HIGH TALL STORAGE UNIT WITH CANTILEVER	
SCALE: 1:50 CAD FILE: G:\CAD\138383 Pt Pelee Visitor Center\138383-01-ARCH-DES.0319 REVISION 2015.08.27.rvt	10	STACKABLE FOLDING TABLE	1600 mm x 800 mm		

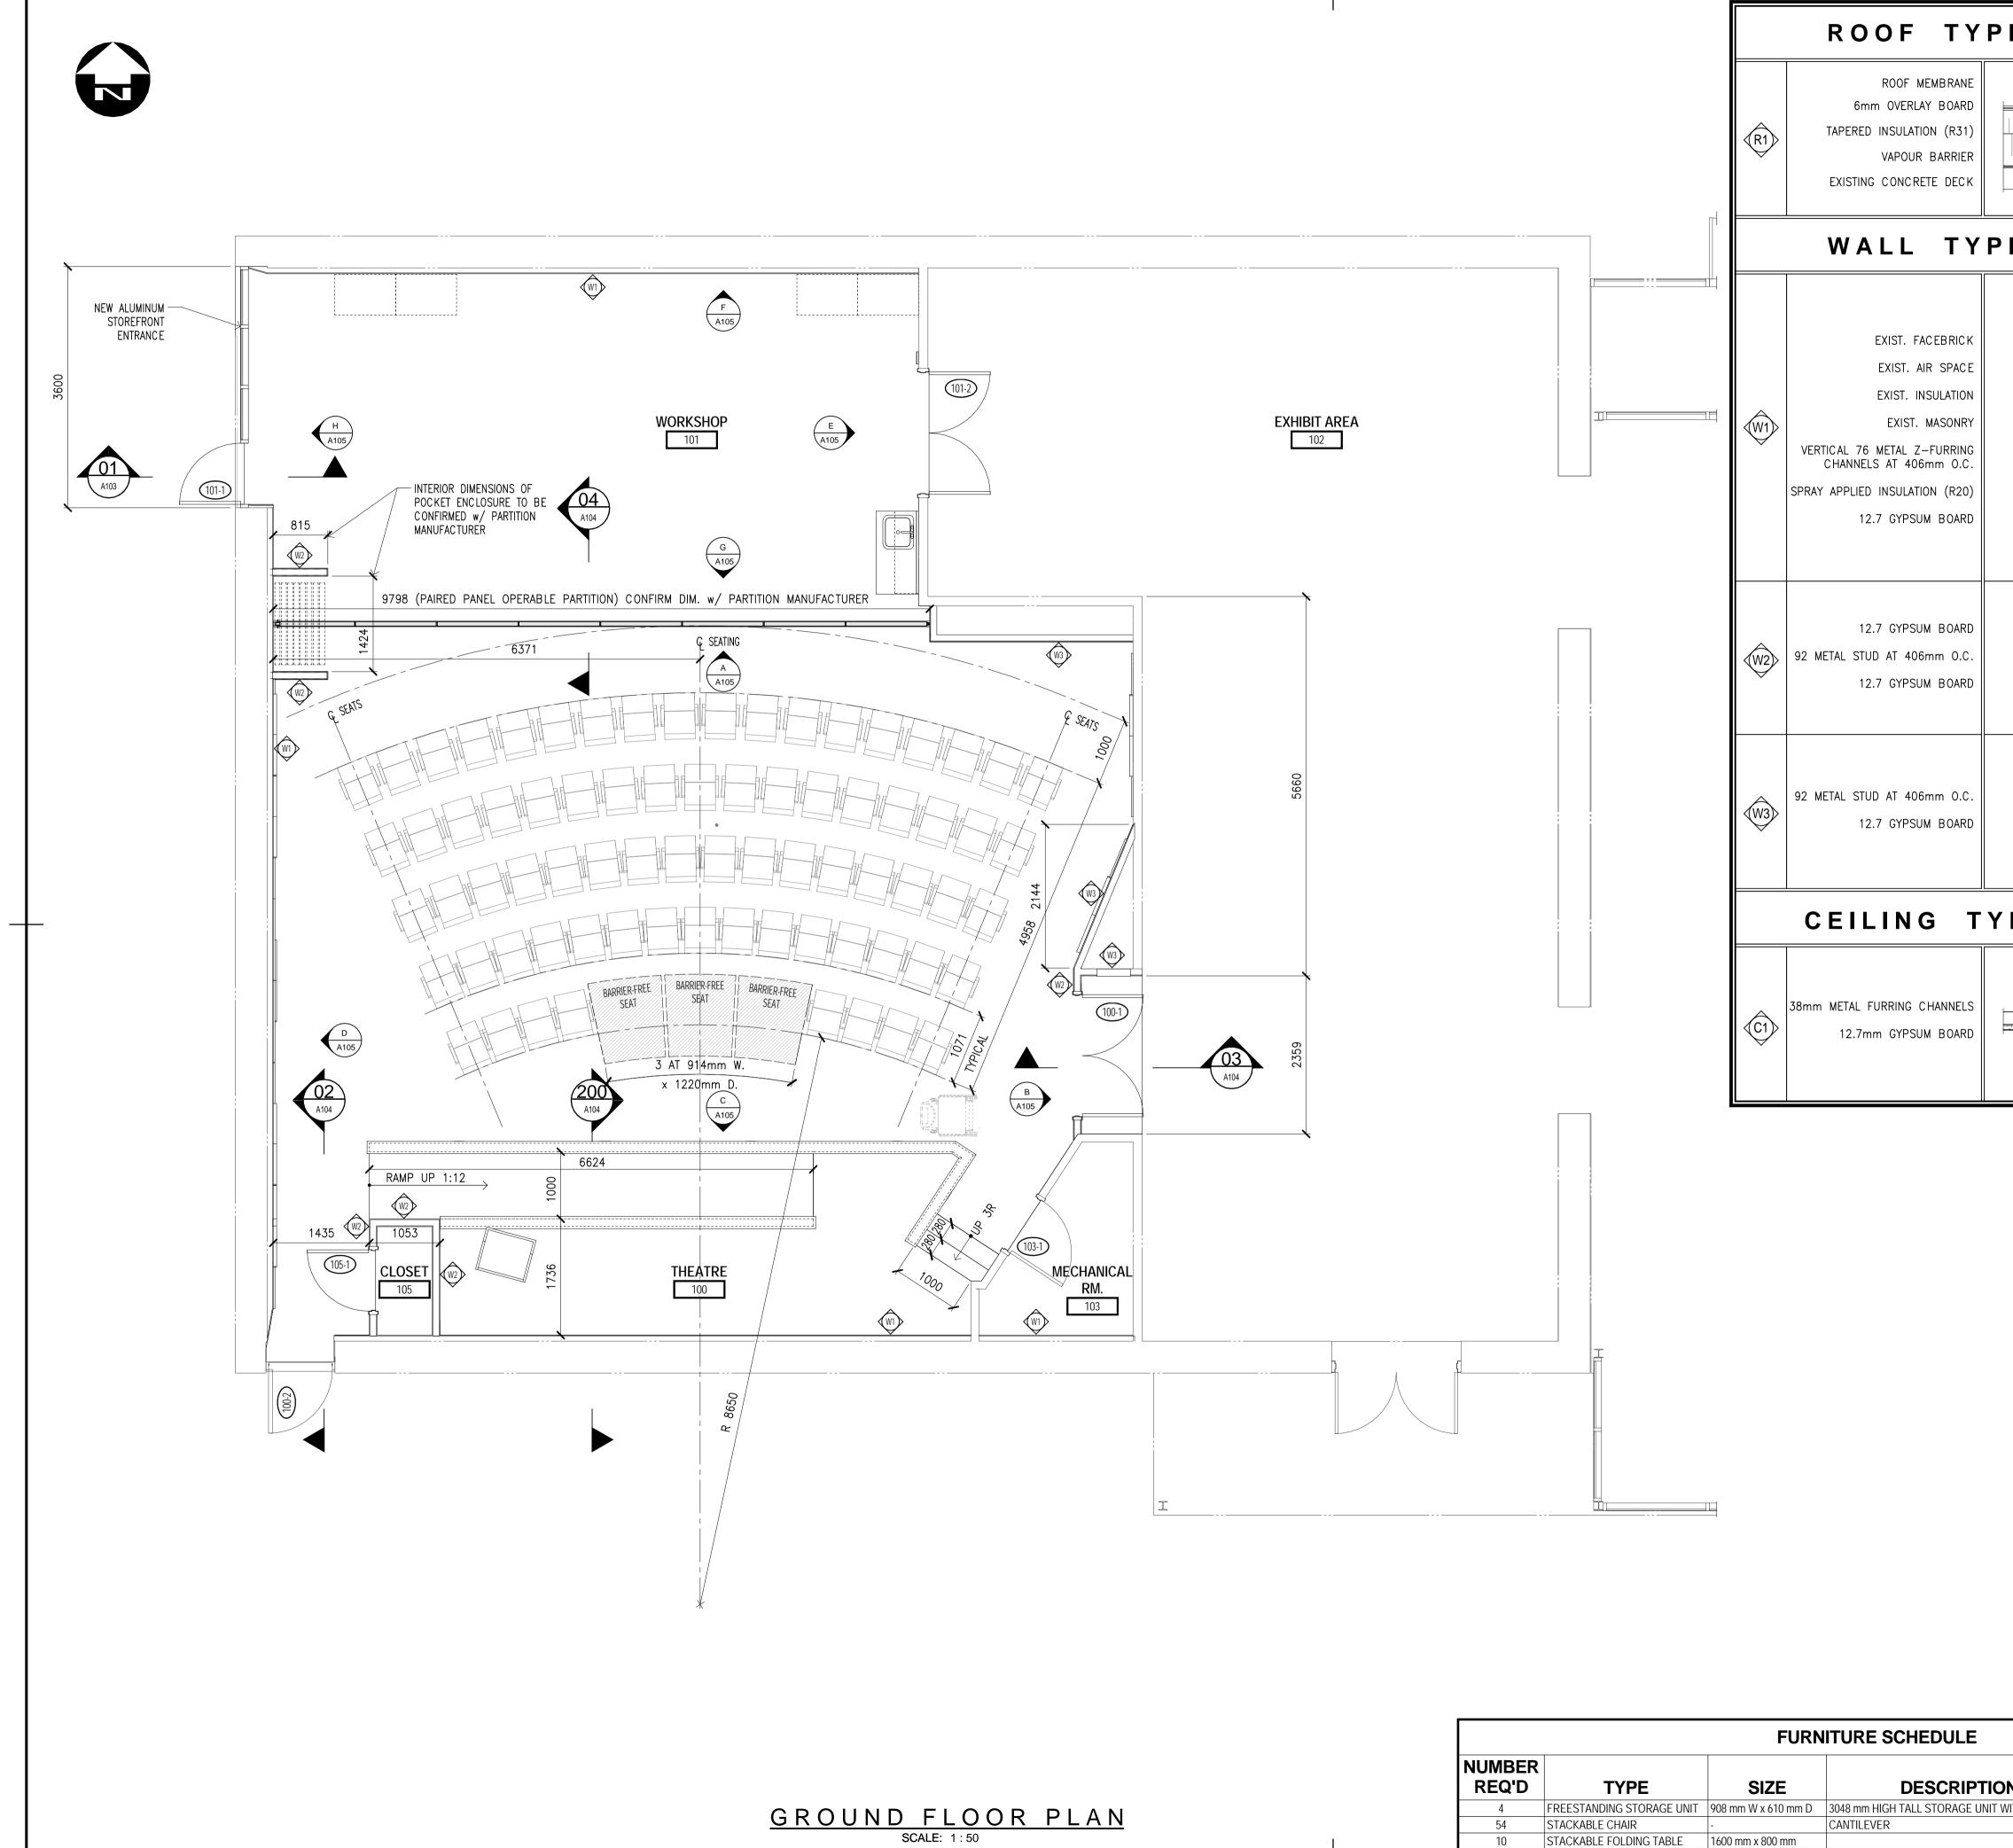E SC	HEDULE	PARKS CANADA PARCS CANADA	
		SOUTHWESTERN ONTARIO FIELD UNIT ASSET MANAGEMENT SECTION	
		DILLON Building Design Ltd. Engineers and Architects 130 Dufferin Avenue, London, Ontario, N6A 5R2 Phone: (519) 438-6192, Fax (519) 672-8209 E-mail: london@dillon.ca	
		Conditions of Use Verify elevations and/or dimensions on drawing prior to use. Report any discrepancies to Dillon Consulting Limited. Do not scale dimensions from drawing. Do not modify drawing, re-use it, or use it for purposes other than those intended at the time of its preparation without prior written permission from Dillon Consulting Limited.	
PE S	SCHEDULE	1 ISSUED FOR TENDER 2015-0 revision dat Do not scale drawings. verify all dimensions and conditions on site and immediately notify the engineer of all discrepancies.	
		A Detail No. No. du detail drawing no. – where detail required dessin no. – ou detail exige C drawing no. – where detailed dessin no. – ou detaille project title titre du projet LEAMINGTON ONTARI POINT PELEE NATIONAL PARK 1118 POINT PELEE DR. LEAMINGTON, N8H 3V4 VISITOR CENTRE THEATRE	
		titre du dessin ARC HITEC TURAL FLOOR PLAN AND SC HEDULES drawn by dessine par MGS designed by conc par LDP approved by approved by approved par	
		tender soumission project date date du projet 2013/11/18	ateur
N ITH 2 DRAWERS	COMMENTS	project no. no. du projet 138383 drawing no.	





0PG.		*	PARKS CANADA Parcs canada
	– E.P.D.M. GROMMET SEAL (SUPPLIED & INSTALLED		
	BY ROOFING CONTRACTOR) - LAP SEALANT ALL AROUND		FERN ONTARIO D UNIT
		ASSET MAN	AGEMENT SECTION
	- CORE-DRILL AND	Building Engineers 130 Dufferin Avenue	LON Design Ltd. and Architects e, London, Ontario, N6A 5R2 6192, Fax (519) 672-8209
	REMOVE PORTION OF CONCRETE DECK		ondon@dillon.ca
OF VEN	<u>Γ</u>		
	– ROOF MEMBRANE FLASHING (EXTEND OVER PARAPET) – LAP SEALANT		
		NOT FOR CO	ONSTRUCTION
	– EXIST. CONCRETE ROOF DECK		
		Conditions of Use Verify elevations and/or dimension	s on drawing prior to use. Report any
		discrepancies to Dillon Consulting Do not scale dimensions from drav Do not modify drawing, re-use it, o	Limited.
PET D	ETAIL		
_	- MECH. UNIT -SEE MECH. DWGS.		
	PRE-FABRICATED BENT PLATE ROOF CURB c/w RIGID INSUL. (SUPPLIED BY MECH. CONTRACTOR &	1 ISSUED FOR TENDER	2015-08-26
	INSTALLED BY ROOFING CONTRACTOR) – 1.9 THK. GALV. COUNTER FLASHING (SUPPLIED & INSTALLED BY	Do not scale drawings. Verify all dimensions and	
	ROOFING CONTRACTOR)	immediately notify the end A Detail	No.
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		project title titre du projet LEAMINGTON	
	 PORTION OF EXIST. ROOFING SYSTEM & CONCRETE DECK TO BE REMOVED ROOF OPENING FRAMING -SEE 	POINT PELEE NATH 1118 POINT PELEE LEAMINGTON, N8H VISITOR CENTR	E DR. 3V4
<u>NOTE</u> : - TAIL	STRUCT. DWGS. FOR SIZE & LOCATION CONTRACTOR TO PROVIDE TAPERED WOOD BLOCKING AS REQUIRED TO SET TOP OF ROOF CURBS LEVEL	drawing title titre du dessin ARCHITECTUR PLANS, SECTI DETAILS	
	TOP OF STEEL	drawn by dessine par MGS	
	ELEV. = 181.077 m	designed by conc par LDP	
		approved by approuve par tender	project manager
	GROUND FLOOR	soumission MARK project date	MAJOR administrateur de projets
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		no. du projet 1383 drawing no.	383
		dessine no. A103	

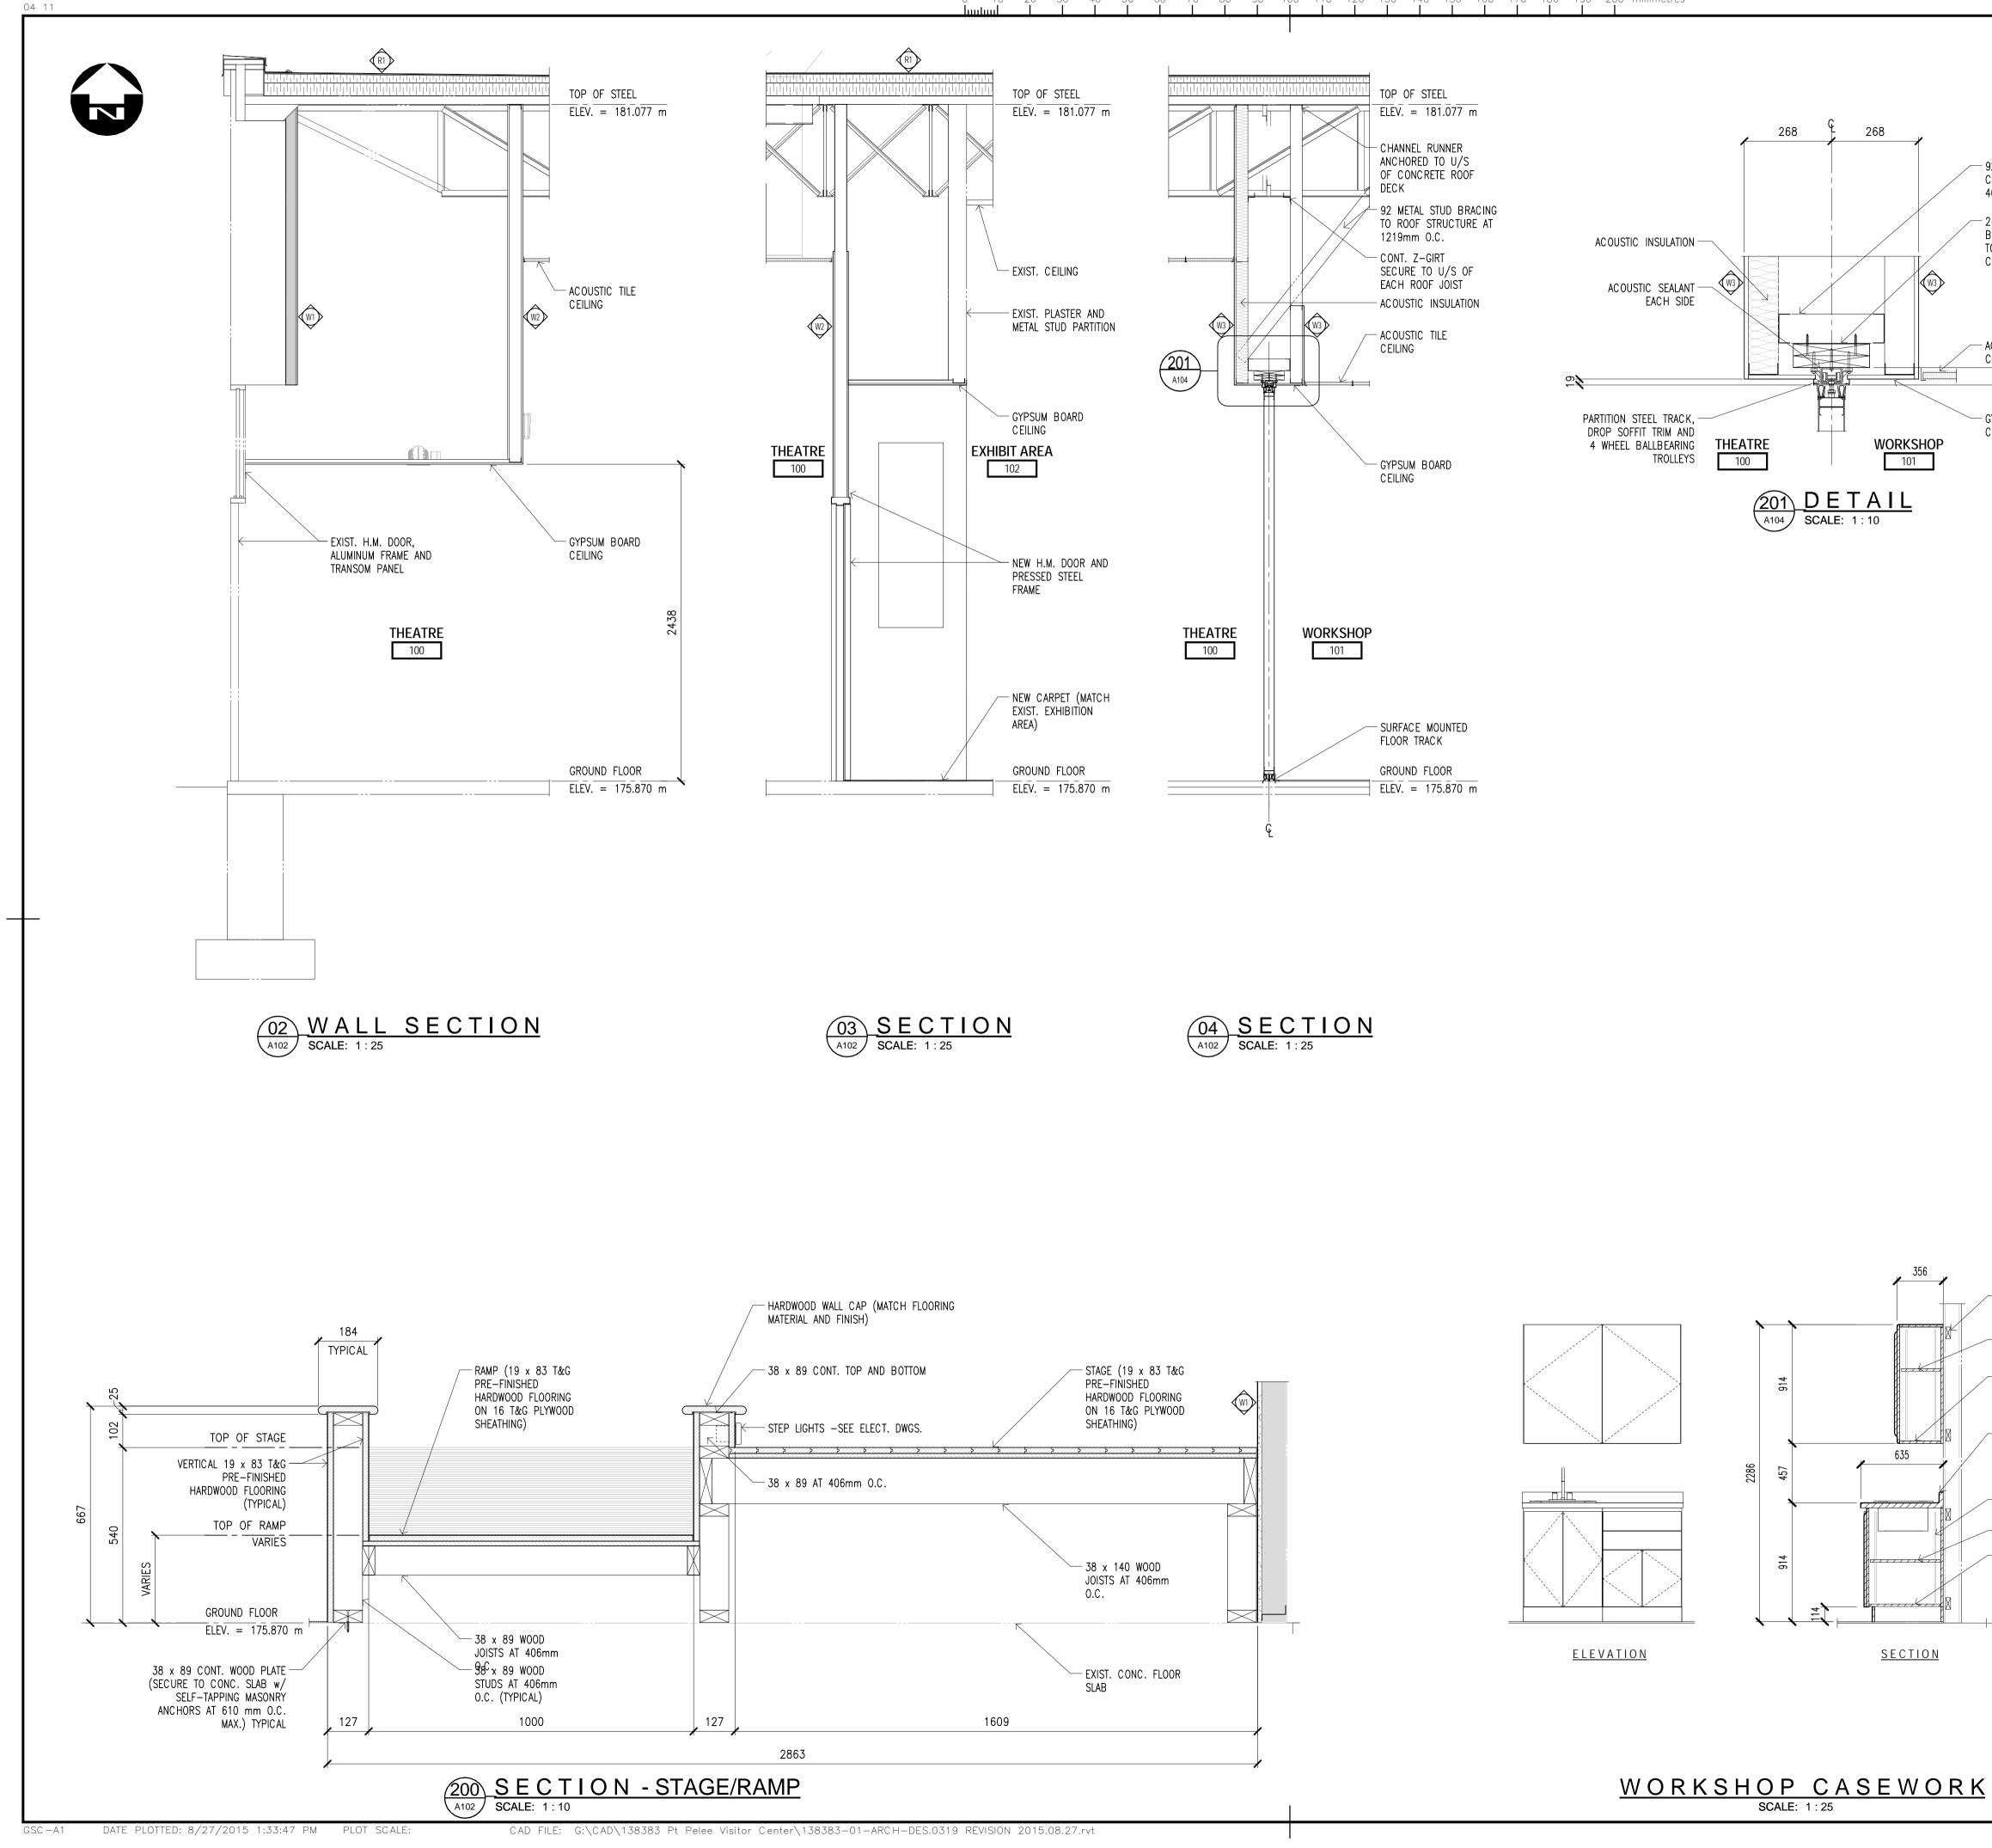




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Ţ	Building Engineers 130 Dufferin Avenue Phone: (519) 438-	LION Design Ltd. and Architects , London, Ontario, N6A 5R2 6192, Fax (519) 672-8209 ondon@dillon.ca	
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	approved by approuve par		
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	project date date du projet 2013	/11/18	
	project no. no. du projet 1383	383	
	drawing no. dessine no.		
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- 92 METAL STUDS CROSS TIES AT 406mm 0.C.

-2-38 x 240 CONT. BLOCKING SECURED TO METAL STUDS CROSS TIES

- ACOUSTIC TILE CEILING

- GYPSUM BOARD CEILING (EACH SIDE)

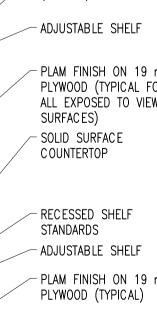


ELEV. = 175.870

GROUND FLOOR

- SUPPORT BLOCKING (TYPICAL)




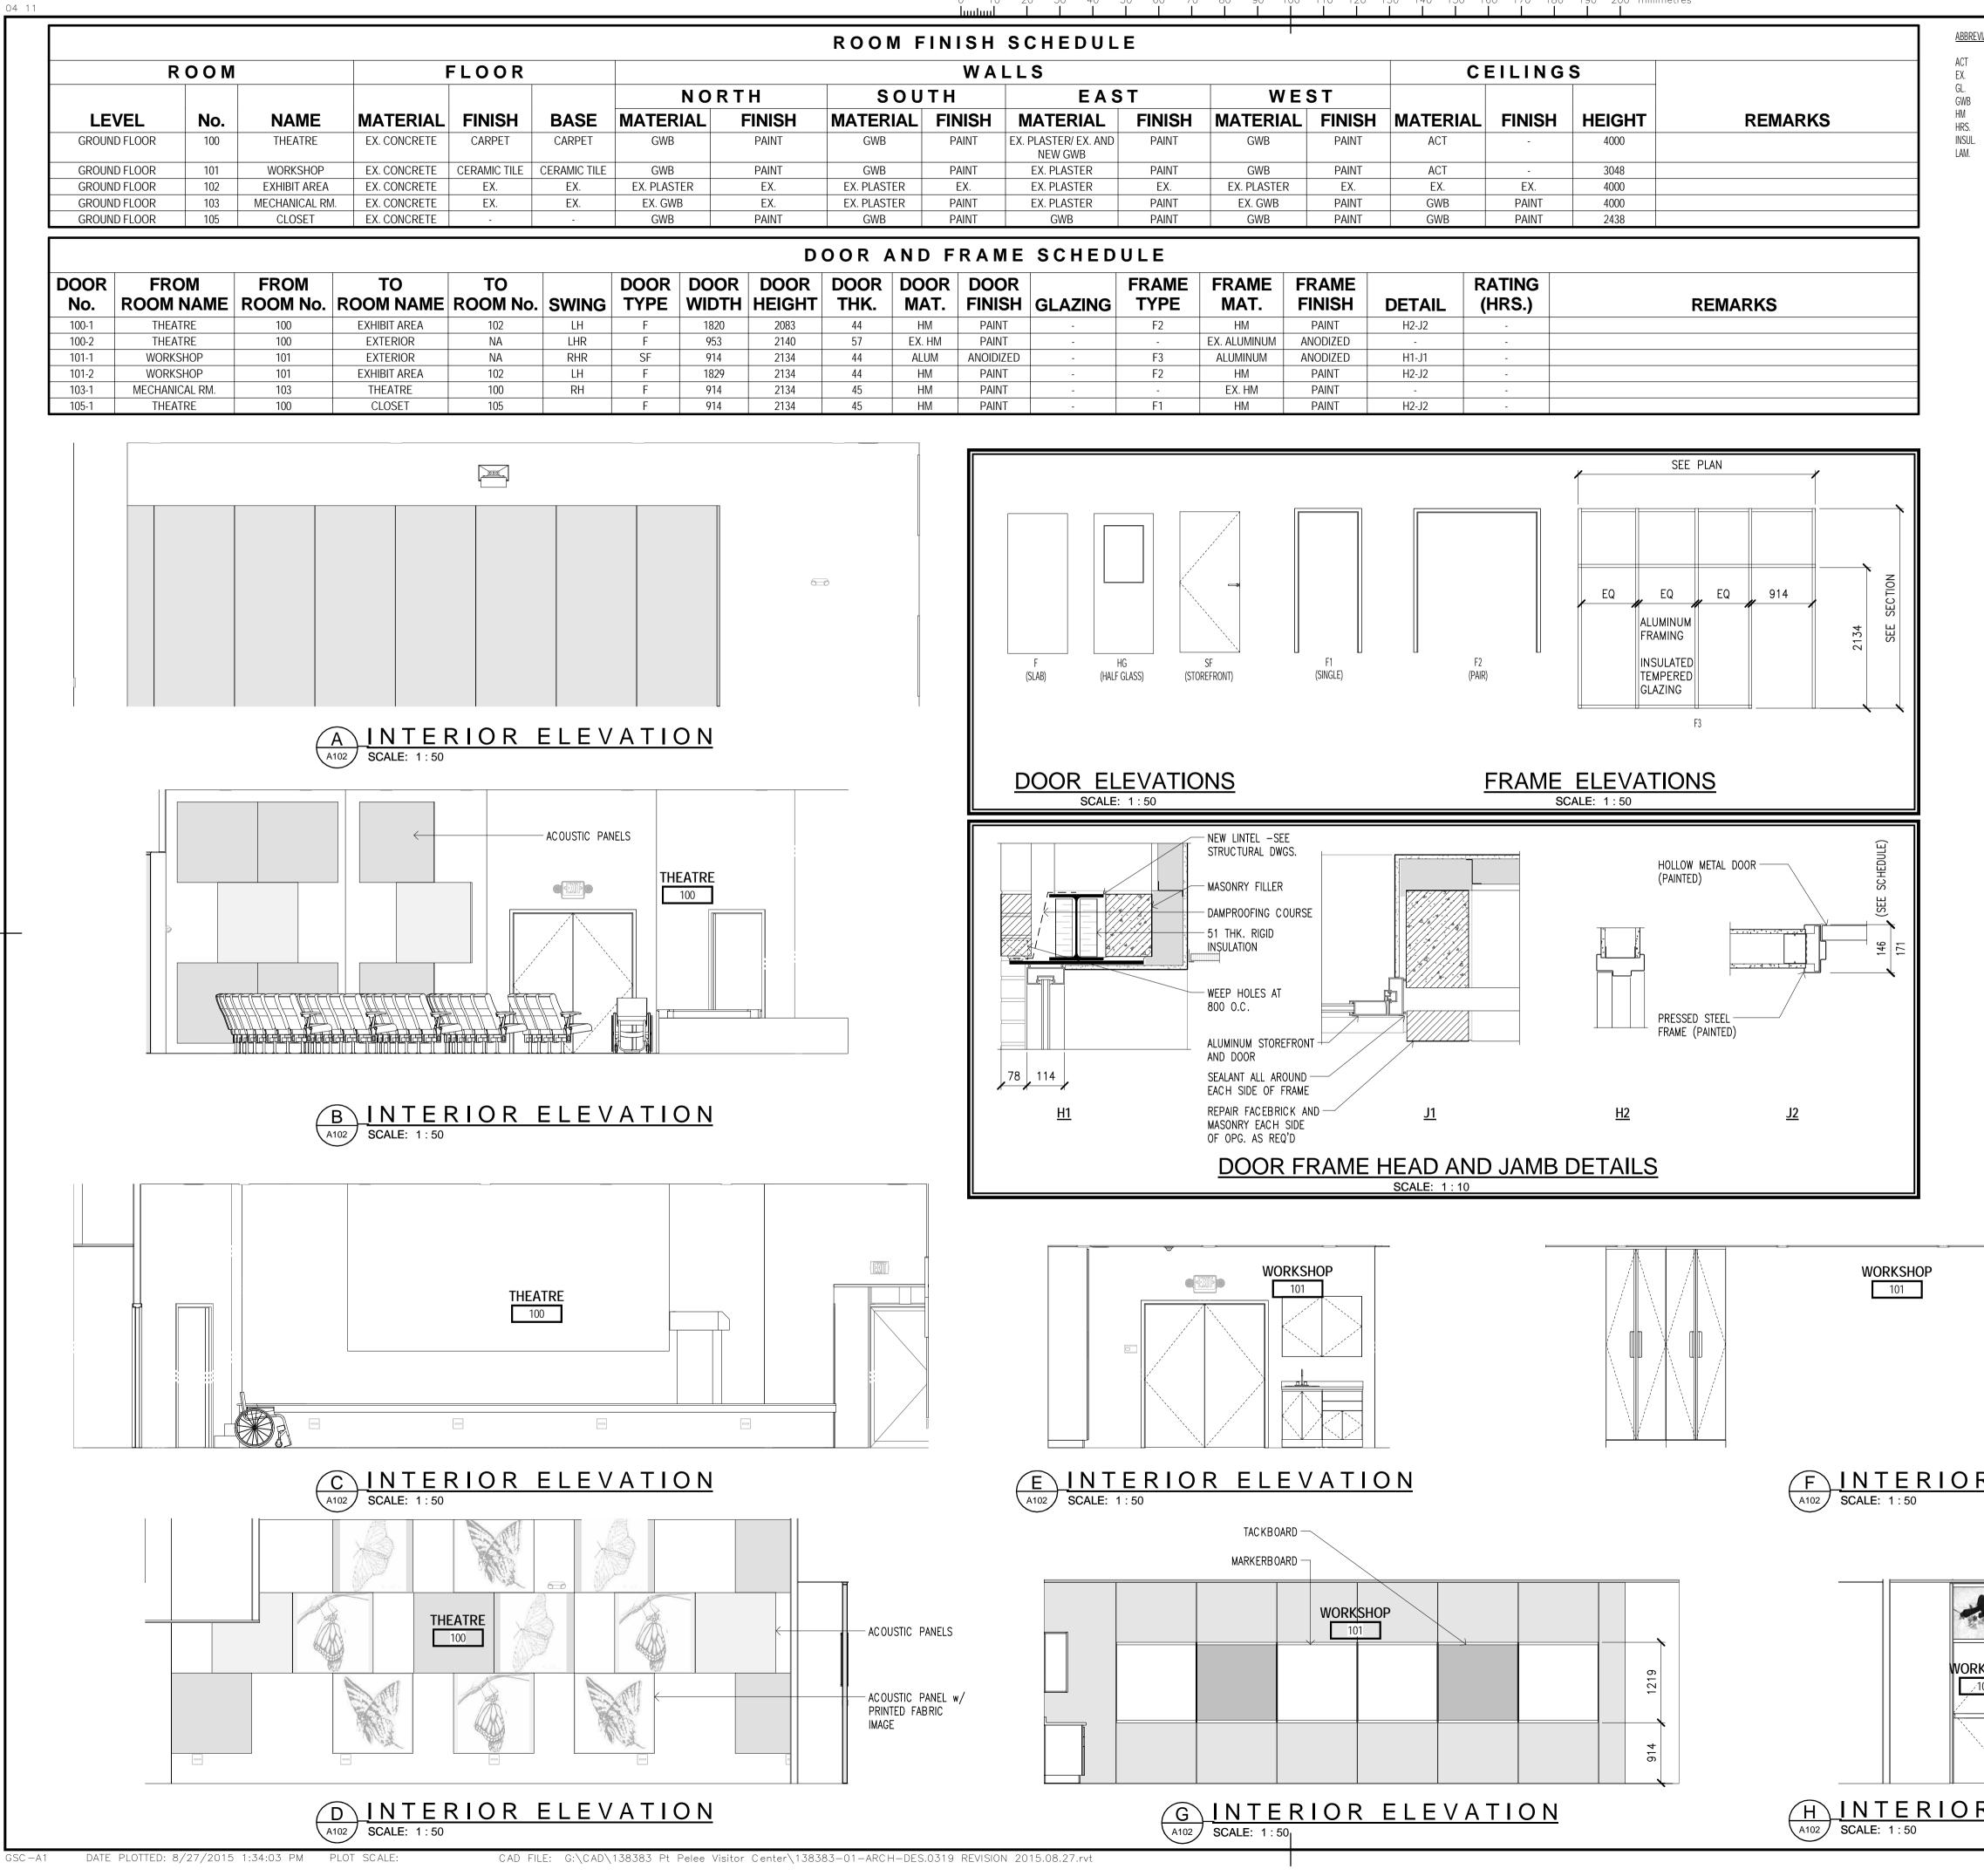

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				SWING CONTRACTOR	KSHOP				WORI

ABBREVIAT			LEFT HAND		*		PARKS CA Parcs ca	
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							EMENT SECTION	NC
					В	uilding D	LON Design Ltd.	
					130 Duf	ferin Avenue, Lo	nd Architec	5R2
					Phone		2, Fax (519) 672-820 on@dillon.ca	9
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				Do not sc Do not mo	ale dimensio odify drawing		i. e it for purposes othe	
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<u>0 R</u>	ELEV	ΑΤΙ	<u>O N</u>	drawn I dessine	-			
		AI	NTI-BIRD STRIKE	designe	d by	MGS		
		FI	LM	approve	ed by	LDP		
A BA		Visitor Co	and the second s	tender				oject manager administrateur
	accueil POH	Centre d'		project	date	MARK		de projets
				project no. du	no.	2013/	11/18	
				drawing		13838	33	
	ELEV			dessine		A105		

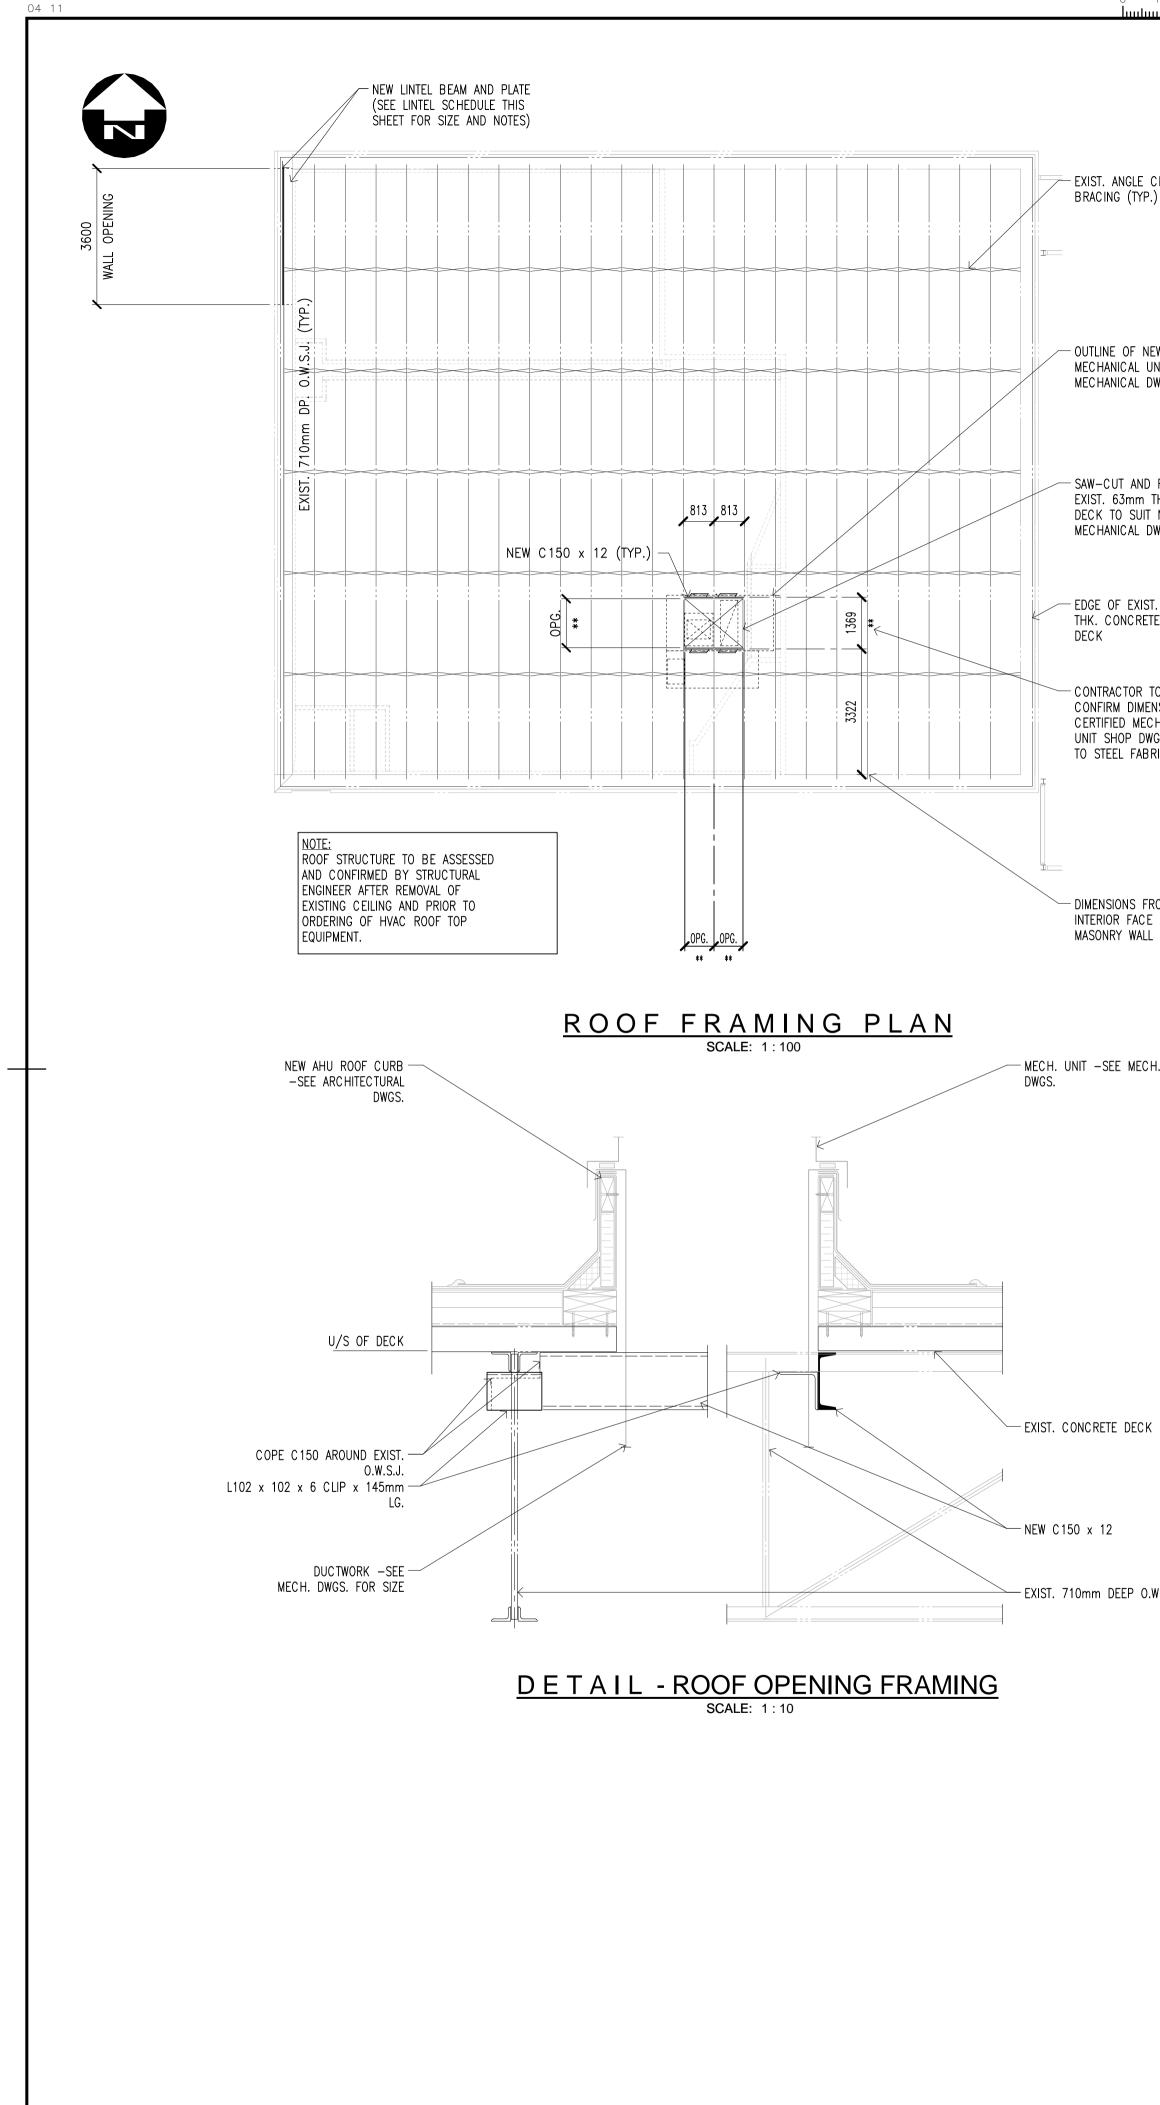

- EXIST. ANGLE CROSS-BRACING (TYP.)

- OUTLINE OF NEW MECHANICAL UNIT -SEE MECHANICAL DWGS.

- SAW-CUT AND REMOVE PORTION OF EXIST. 63mm THK. CONCRETE ROOF DECK TO SUIT NEW DUCTWORK -SEE MECHANICAL DWGS. FOR SIZES

EDGE OF EXIST. 63mm THK. CONCRETE ROOF DECK

- CONTRACTOR TO CONFIRM DIMENSION w/ CERTIFIED MECHANICAL UNIT SHOP DWGS. PRIOR

TO STEEL FABRICATION

- DIMENSIONS FROM INTERIOR FACE OF MASONRY WALL

-MECH. UNIT -SEE MECH.

– EXIST. 710mm DEEP O.W.S.J.

LO	O S E	LINTE	LSCHED
OPENING WIDTH (mm)	MATERIAL	ARRANGEMENT	NOTES
0 – 1200	L89 x 89 x 7.9 HOT DIPPED GALV.	90 EXTERIOR WYTHE	 THIS SCHEDULE IS TO BE READ IN CON ARCHITECTURAL, MECHANICAL AND ELEC A SUITABLE LINTEL IS TO BE SUPPLIED
1200 - 2400	L127 x 89 x 9.5 LLV HOT DIPPED GALV.	90 EXTERIOR WYTHE	 A SONABLE LINTLE IS TO BE SOPPLIED THIS SCHEDULE IS TO BE USED AS A C TO WALL SIZE AND OPENING WIDTH FOR SPECIFICALLY NOTED
2400 - 4900	L152 x 89 x 9.5 LLV HOT DIPPED GALV.	90 EXTERIOR WYTHE	 PROVIDE A MINIMUM END BEARING OF 2 ON 2 COURSES OF SOLID FILLED BLOCH
0 - 1200	2 - L127 x 89 x 9.5 LLV	240 INTERIOR WYTHE	 10mm PLATE WELDED TO UNDERSIDE OF (INCLUDING EXTERIOR WYTHE ANGLE) WIT CONTINUOUS FILLET WELDS EACH SIDE (FLANGE. CENTER PLATE ON CENTERLINE
1200 - 3600	HOT DIPPED GALVAINZED W200 x 36 + 290 x 10 THK. PLATE	300 EXTERIOR WYTHE	– BACK TO BACK ANGLE LINTELS TO BE

<u>NOTES</u>

GENERAL:

- 1. THE NATIONAL BUILDING CODE REQUIREMENTS REGARDING SAFE HEALTH AND SAFETY ACT AND SHALL BE THE BASIS OF ALL
- 2. ARRANGE AND PAY FOR ALL PI WORK. SUBMIT ALL DRAWINGS MAY BE REQUIRED BY PROVINC AUTHORITIES. COPIES OF DRAW UPON REQUEST FOR SUBMISSION APPROVALS.
- 3. FIELD CHECK AND VERIFY ALL EXECUTION OF WORK AND REPO 4. SAFEGUARD AND PROTECT ALL WHICH MAY BE AFFECTED BY

MATERIALS:

- GENERAL
- 1. ANCHORS (INTO CONCRETE): 'RE500' WITH 'HIT HY MAX ADH = 19mm UNLESS NOTED OTHER UNLESS NOTED OTHERWISE.

STRUCTURAL STEEL

- 1. STRUCTURAL STEEL SHAPES:
- 2. STRUCTURAL STEEL PLATES: 3. HIGH TENSILE BOLTS, NUTS AND 4. WELDING ELECTRODES: TO BE
- COMPATIBLE WITH STEEL TO BE 5. METAL DECK: TO BE WELDED RECOMMENDATIONS. CONNECT
- WITH 20mm PUDDLE WELDS AT ADJACENT SURFACES TO BE R 6. ALL NON-GALVANIZED STRUCTU RUST INHIBITIVE METAL PAINT

CONSTRUCTION: (STRUCTURAL STEEL)

- 1. ALL FABRICATION AND WELDING PERFORMED BY A COMPANY C CSA W47.1-09 FOR DIVISION 2. ALL CONNECTIONS (INCLUDING
- DESIGNED AND CERTIFIED BY / OF ONTARIO. 3. FILLET WELDS SHALL NOT BE I 4. HOT DIP GALVANIZING SHALL B
- 5. PLUG RELIEF VENTS AIRTIGHT PROPER SIZE AND RE-TAP THRE
- 6. DO NOT PAINT SURFACES AT AREAS OF CONNECTIONS ETC. WHICH ARE TO BE FIELD PAINTED AFTER TORQUE AND WELD CONNECTION APPROVALS. DO NOT PAINT SURFACES IN CONTACT WITH CONCRETE. DO NOT PAINT HOT DIPPED GALVANIZED STEEL SURFACES.

	*	PARKS CANADA Parcs canada
DULE	SOUTHWEST FIEL	ERN ONTARIO D UNIT
CONJUNCTION WITH THE ECTRICAL DRAWINGS ED FOR ALL OPENINGS	DIL Building	AGEMENT SECTION
A GUIDE WITH REGARD OR ANY LINTELS NOT 5 200mm EACH END DCK OF LINTELS	130 Dufferin Avenue, Phone: (519) 438-6	and Architects , London, Ontario, N6A 5R2 5192, Fax (519) 672-8209 ondon@dillon.ca
WITH 5mm E OF BOTTOM NE OF WALL E WELDED TOGETHER		
	NOT FOR CC	DNSTRUCTION
	discrepancies to Dillon Consulting I Do not scale dimensions from draw	ring. use it for purposes other than those
	1 ISSUED FOR TENDER	
	Do not scale drawings. Verify all dimensions and o immediately notify the eng	ineer of all discrepancies.
OF CANADA (LATEST EDITION) AND THE TETY AS OUTLINED UNDER THE OCCUPATIONAL REGULATIONS FOR CONSTRUCTION PROJECTS WORK. ERMITS AND INSPECTIONS REQUIRED FOR NEW S AND DOCUMENTS FOR OFFICIAL APPROVAL AS CIAL, MUNICIPAL OR FIRE UNDERWRITING WINGS MAY BE OBTAINED FROM THE CONSULANT ON WITH APPLICATION FOR PERMITS OR OFFICIAL	A B C drawing dessin	
EXISTING CONDITIONS AND DIMENSIONS PRIOR TO PORT ANY DISCREPANCIES TO THE CONSULTANT. EXISTING STRUCTURES, SERVICES AND UTILITIES THE WORK OF THIS CONTRACT.	LEAMINGTON POINT PELEE NATIO 1118 POINT PELEE LEAMINGTON, N8H VISITOR CENTR	DNAL PARK DR. 3V4
UNLESS NOTED OTHERWISE TO BE STAINLESS STEEL HESIVE' ALL BY HILTI. MINIMUM ANCHOR DIAMETER ERWISE. MINIMUM ANCHOR EMBEDMENT = 175mm	drawing title titre du dessin STRUCTURAL ROOF FRAMINO DETAILS	g plan and
TO CSA G40.20/G40.21-04, 350W. TO CSA G40.21-04 GRADE 300W (MINIMUM). ND WASHERS TO ASTM A325-00. E 'BASIC' LOW HYDROGEN TYPE TO CSA W48 SERIES, E WELDED. TO FRAME IN ACCORDANCE WITH MANUFACTURER'S	drawn by dessine par MGS	
T EXISTING DECK PANELS TO NEW SUPPORT BEAMS T EVERY SECOND FLUTE OR 300mm O.C. WELDS AND REFINISHED WITH ZINC RICH PAINT. JRAL STEEL SHALL HAVE A PRIME COAT OF GREY C.G.S.B. 1-GP-40-M-1979.	designed by conc par GM approved by approuve par	
EL) G SHALL CONFORM TO CSA W59-03 (R2008) AND BE ERTIFIED BY AND WELDERS QUALIFIED IN ACCORDANCE WITH 1 OR DIVISION 2.1.	project date	project manage administrateu de projets
FIELD FABRICATED), BASE AND ANCHOR DETAILS SHALL BE A PROFESSIONAL ENGINEER IN REGISTERED IN THE PROVINCE LESS THAN 5 mm. BE PERFORMED AFTER FABRICATION. PRIOR TO GALVANIZING, REMOVE PLUGS, REAM HOLES TO DEADS AFTER CALVANIZING	date du projet 2013, project no. no. du projet 1383	/11/18 583
READS AFTER GALVANIZING.		


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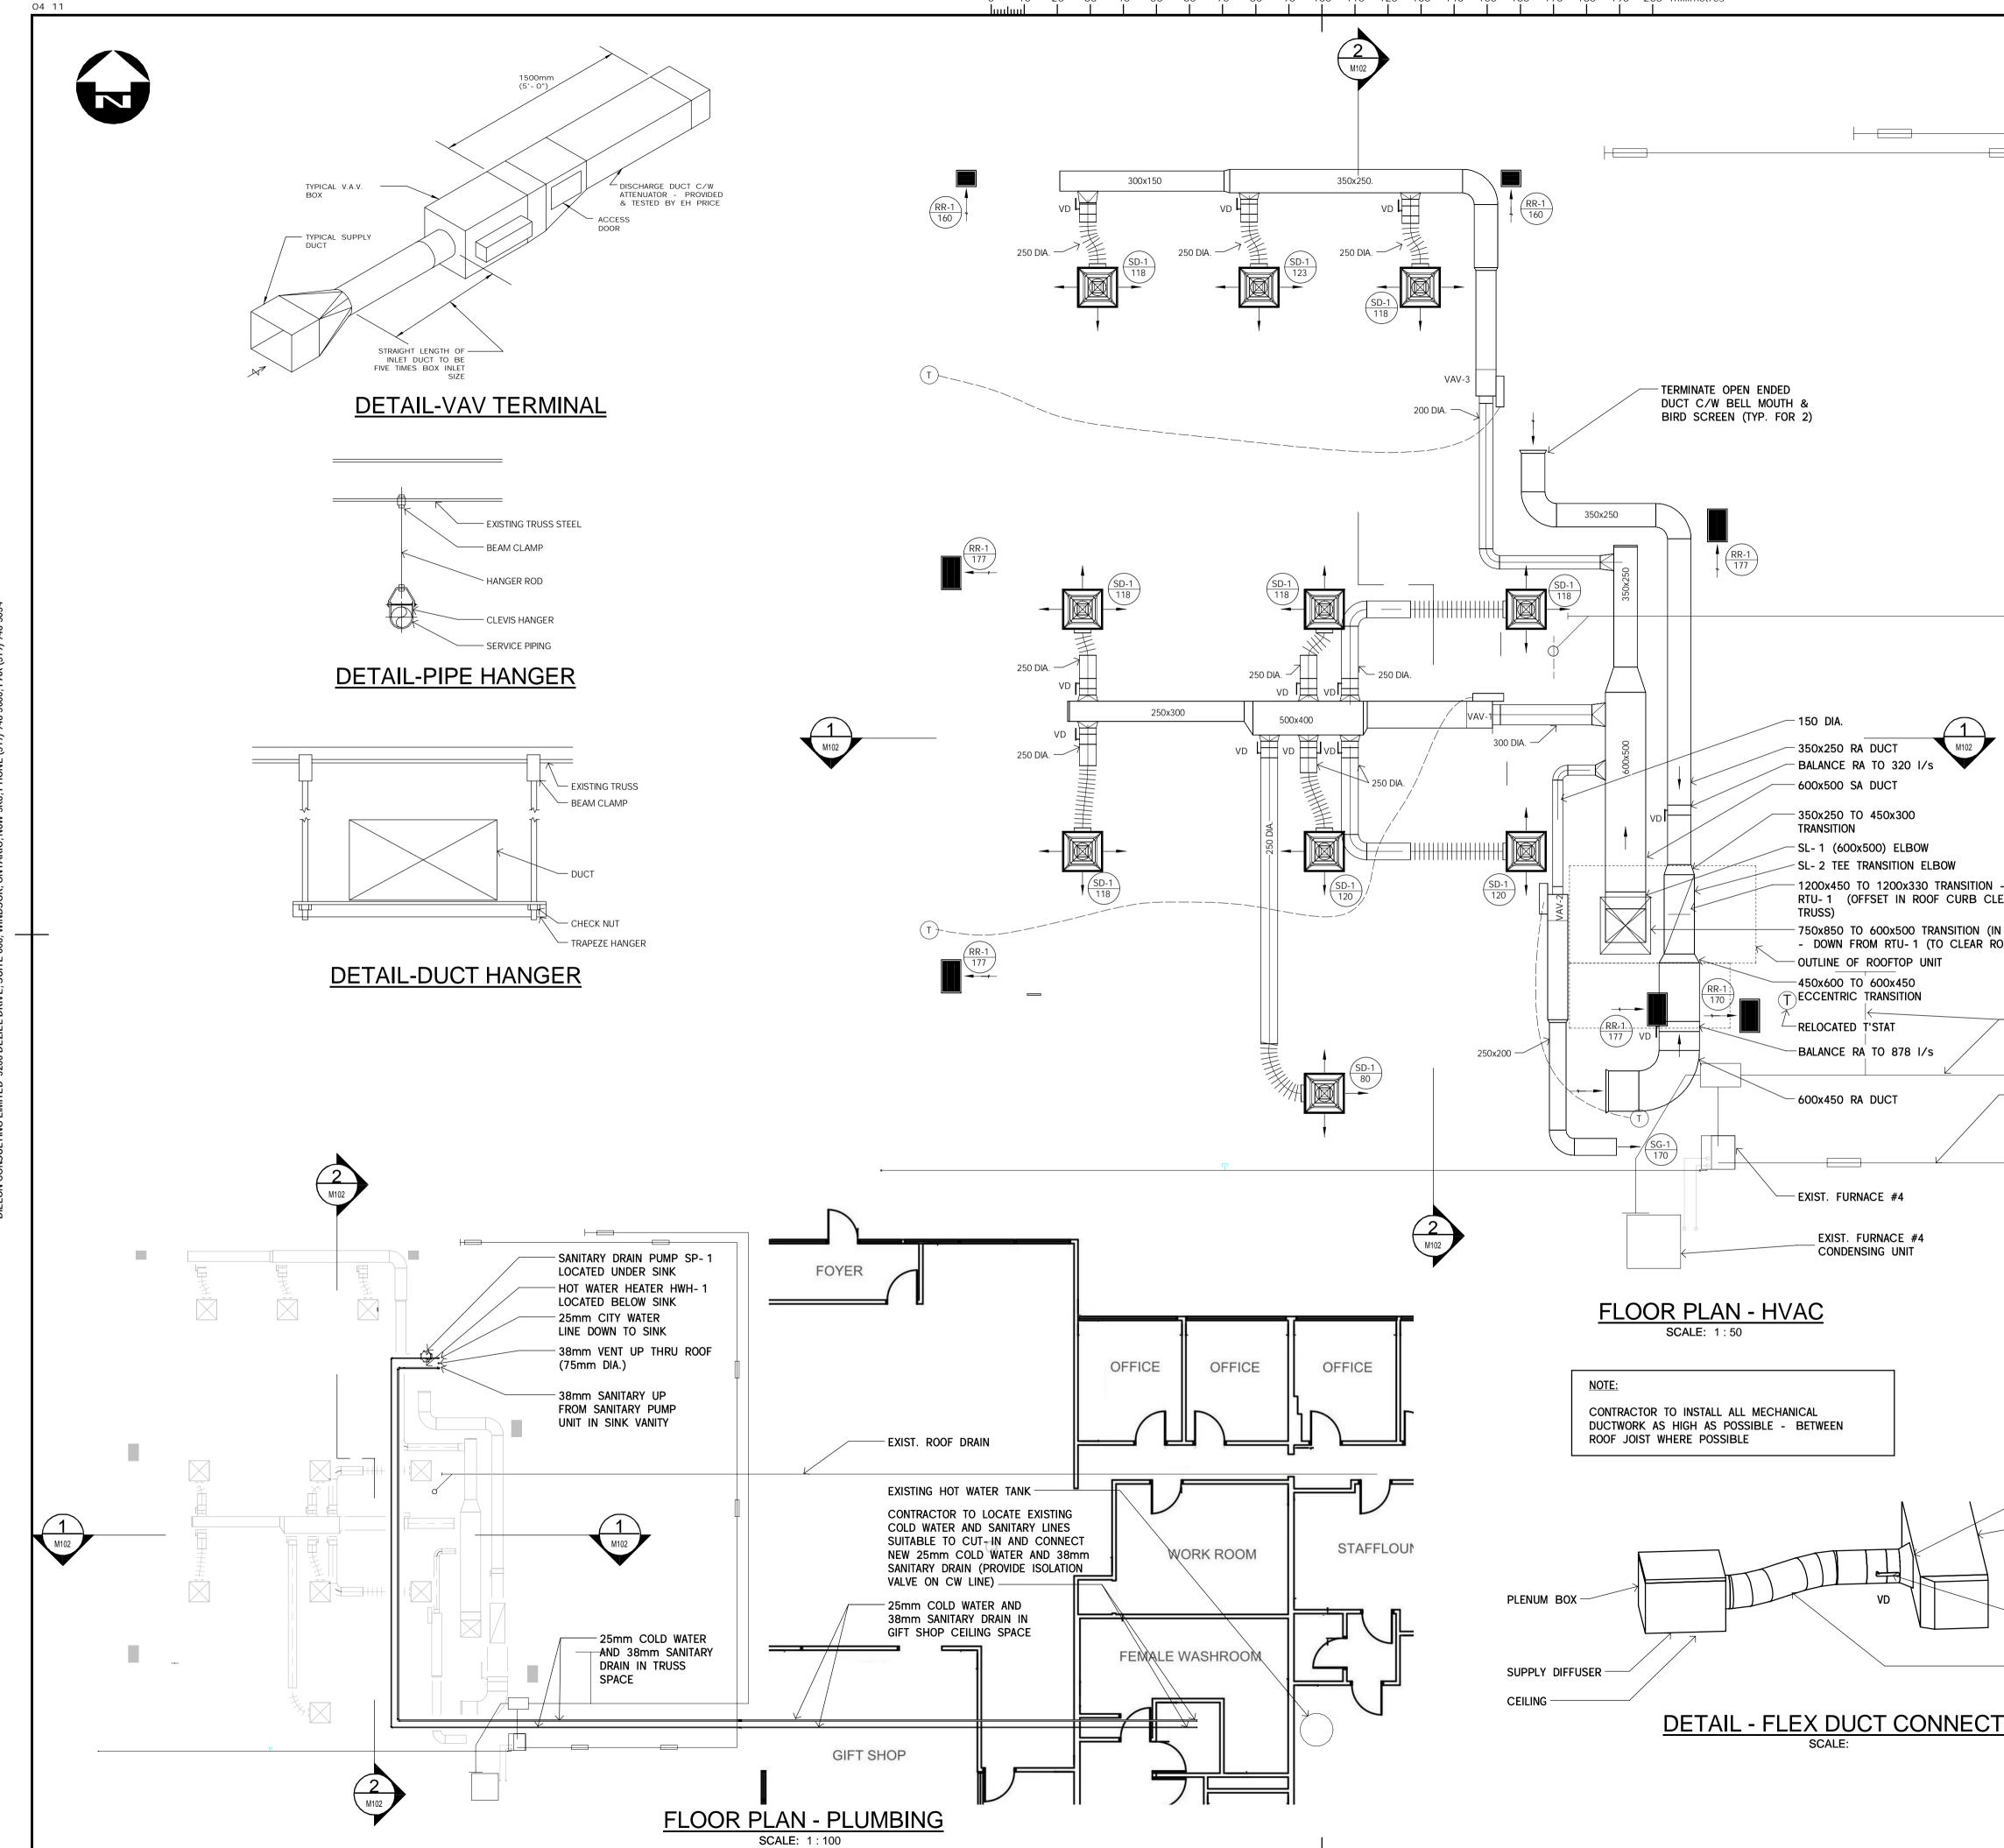
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revision		date

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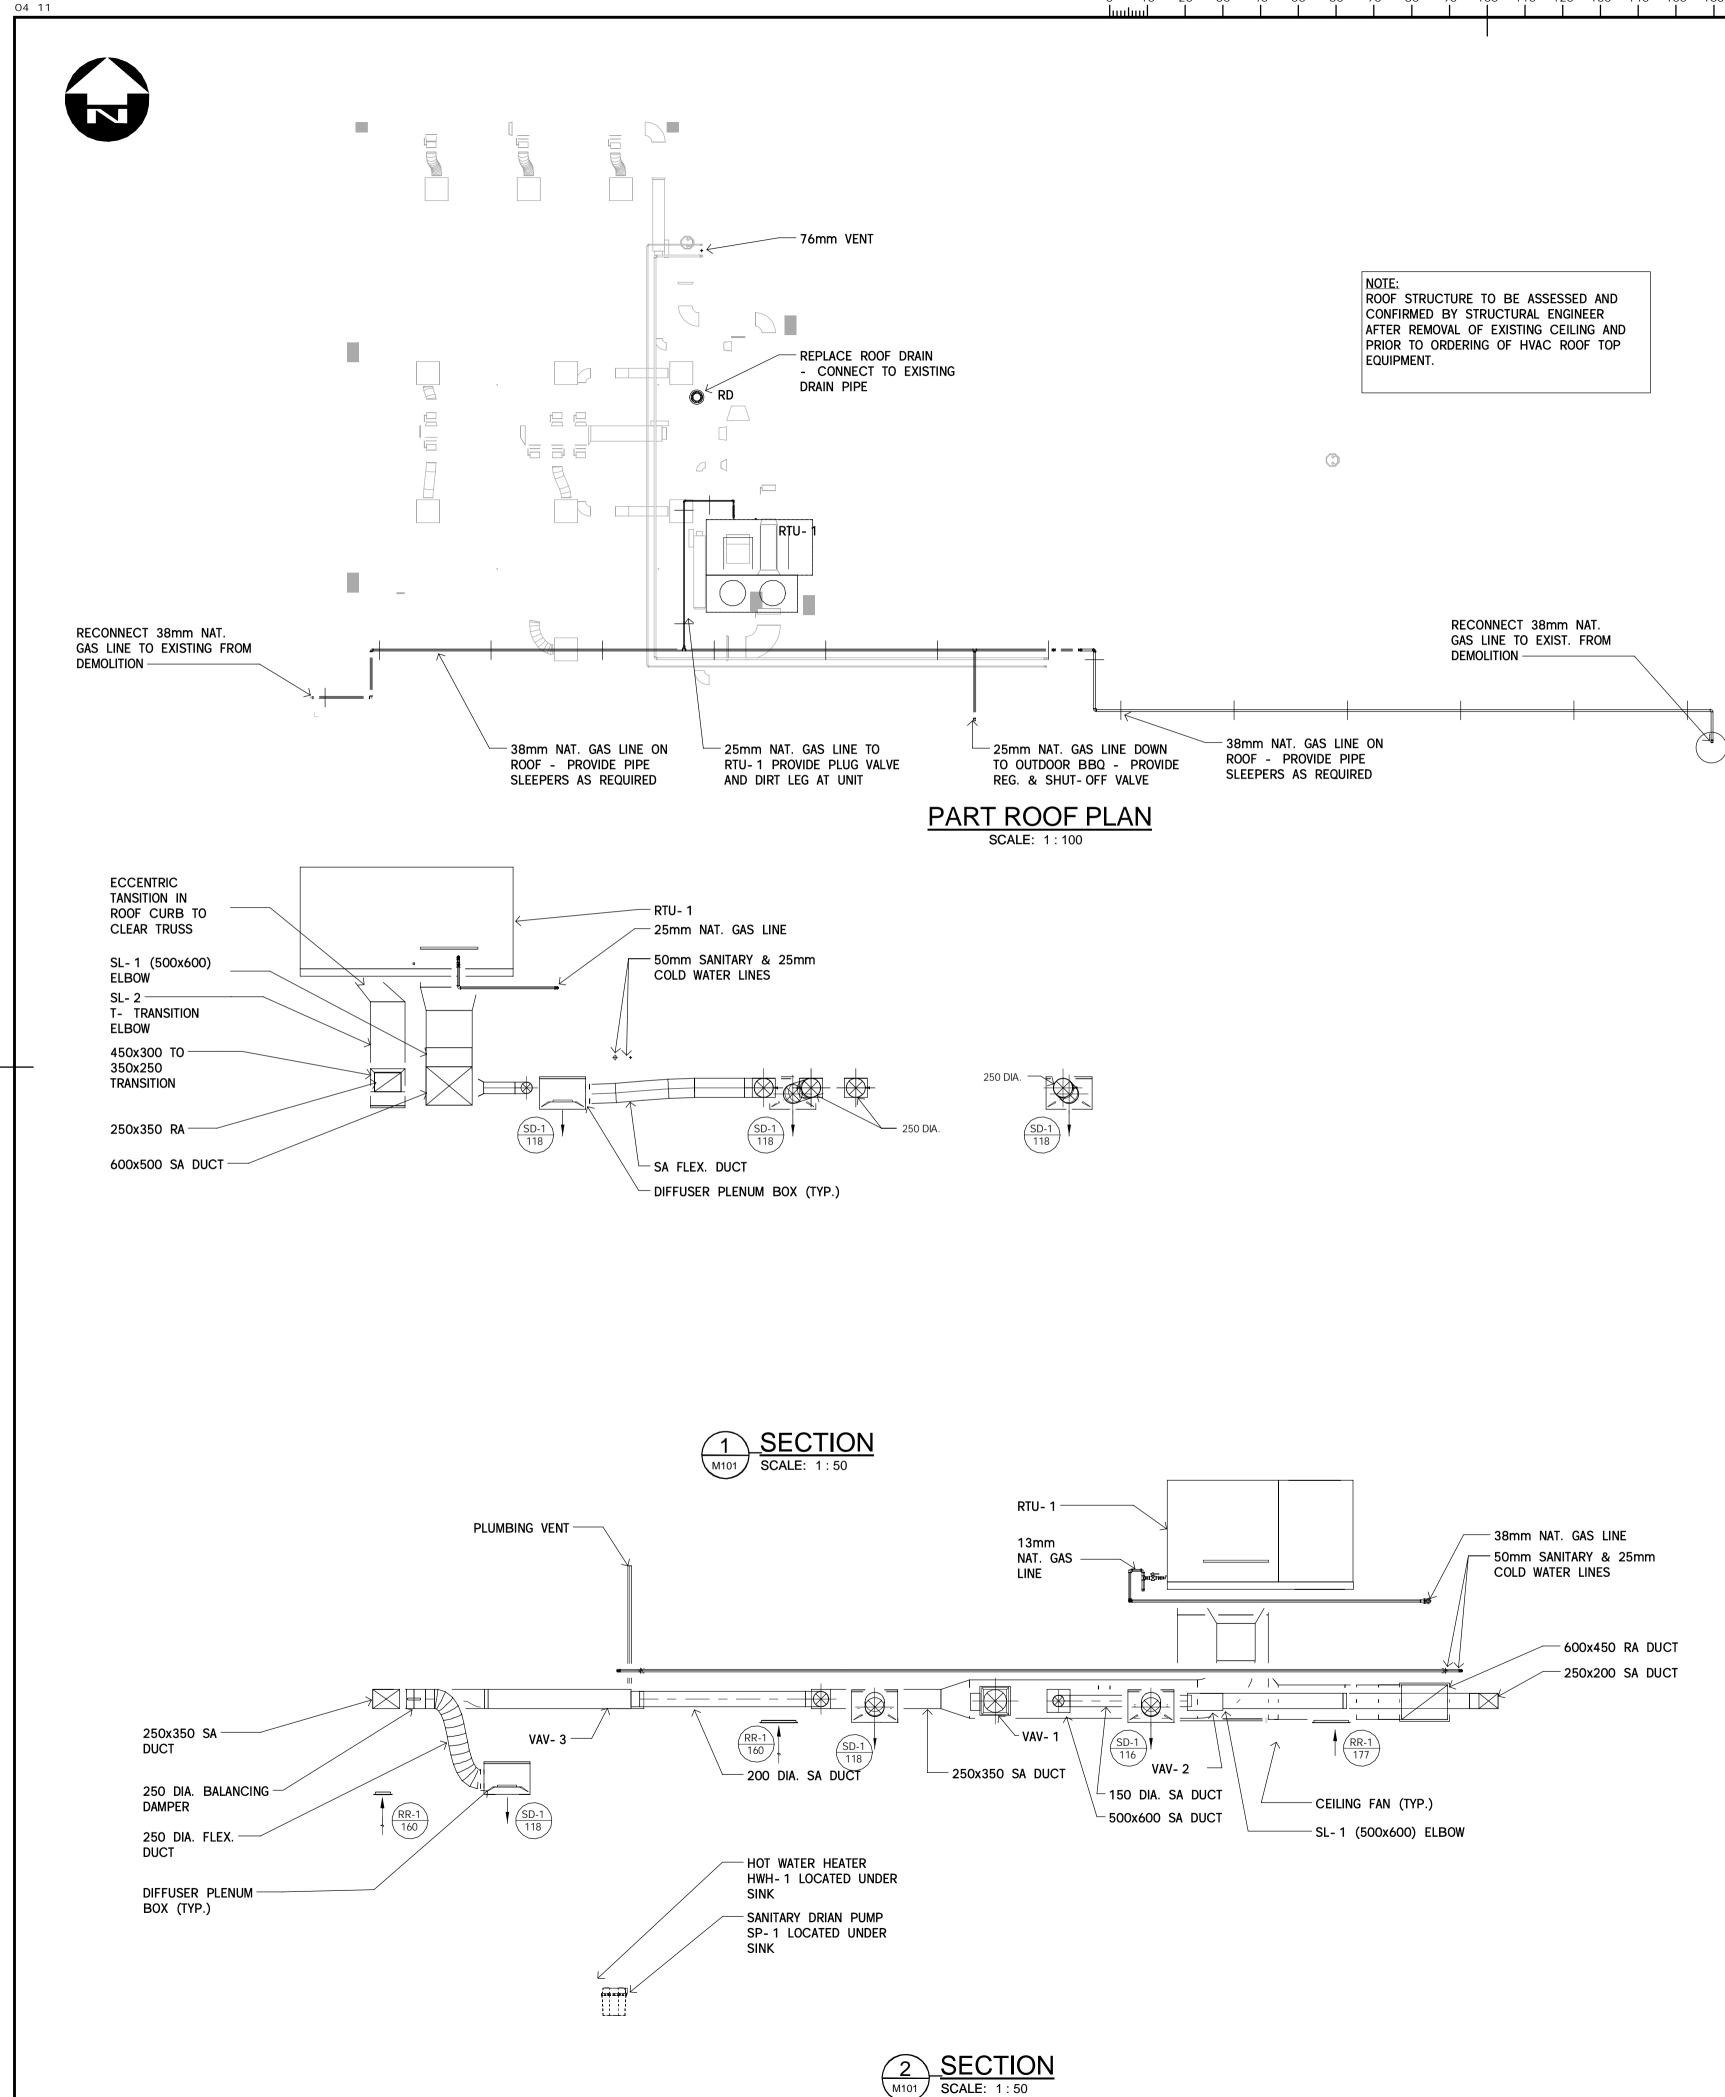
*	PARKS CANADA PARCS CANADA						
SOUTHWESTERN ONTARIO							
FIELD UNIT							
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	M						
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NOT FOR CO	ONSTRUCTION						
Conditions of Use Verify elevations and/or dimension discrepancies to Dillon Consulting	ns on drawing prior to use. Report any						
Do not scale dimensions from dra							
intended at the time of its prepara from Dillon Consulting Limited.	tion without prior written permission						
1 ISSUED FOR TENDER	2015-08-26 date						
Do not scale drawings. Verify all dimensions and immediately notify the en	conditions on site and gineer of all discrepancies.						
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PARKS CANADA 1118 POINT PELE LEAMINGTON, N8H							
VISITOR CENTR							
drawing title titre du dessin							
MECHANICAL	ROOF PLANS						
DEMOLITION							
drawn by dessine par TKD							
designed by conc par CWW							
approved by approuve par LDP							
tender soumission MARK	K MAJOR project manager administrateur de projets						
project date date du projet 2014	/02/21						
project no. no. du projet 138 3	383						



GSC-A1 DATE PLOTTED: 8/28/2015 9:47:03 AM PLOT SCALE:

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	Conditions of Use	
	Verify elevations and/or dimension discrepancies to Dillon Consulting	•
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	from Dillon Consulting Limited.	
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	1118 POINT PELE LEAMINGTON, N8H	3V4
	VISITOR CENT	RE THEATRE
	drawing title titre du dessin MECHANICAL	
	FLOOR PLANS	S - HVAC &
- EXTENSION DUCT COLLAR	drawn by dessine par TKD	
	designed by conc par CWW	,
	approved by approuve par LDP	
	tender soumission MARI	project manage administrateu de projets
N	project date date du projet 2014	1/02/21
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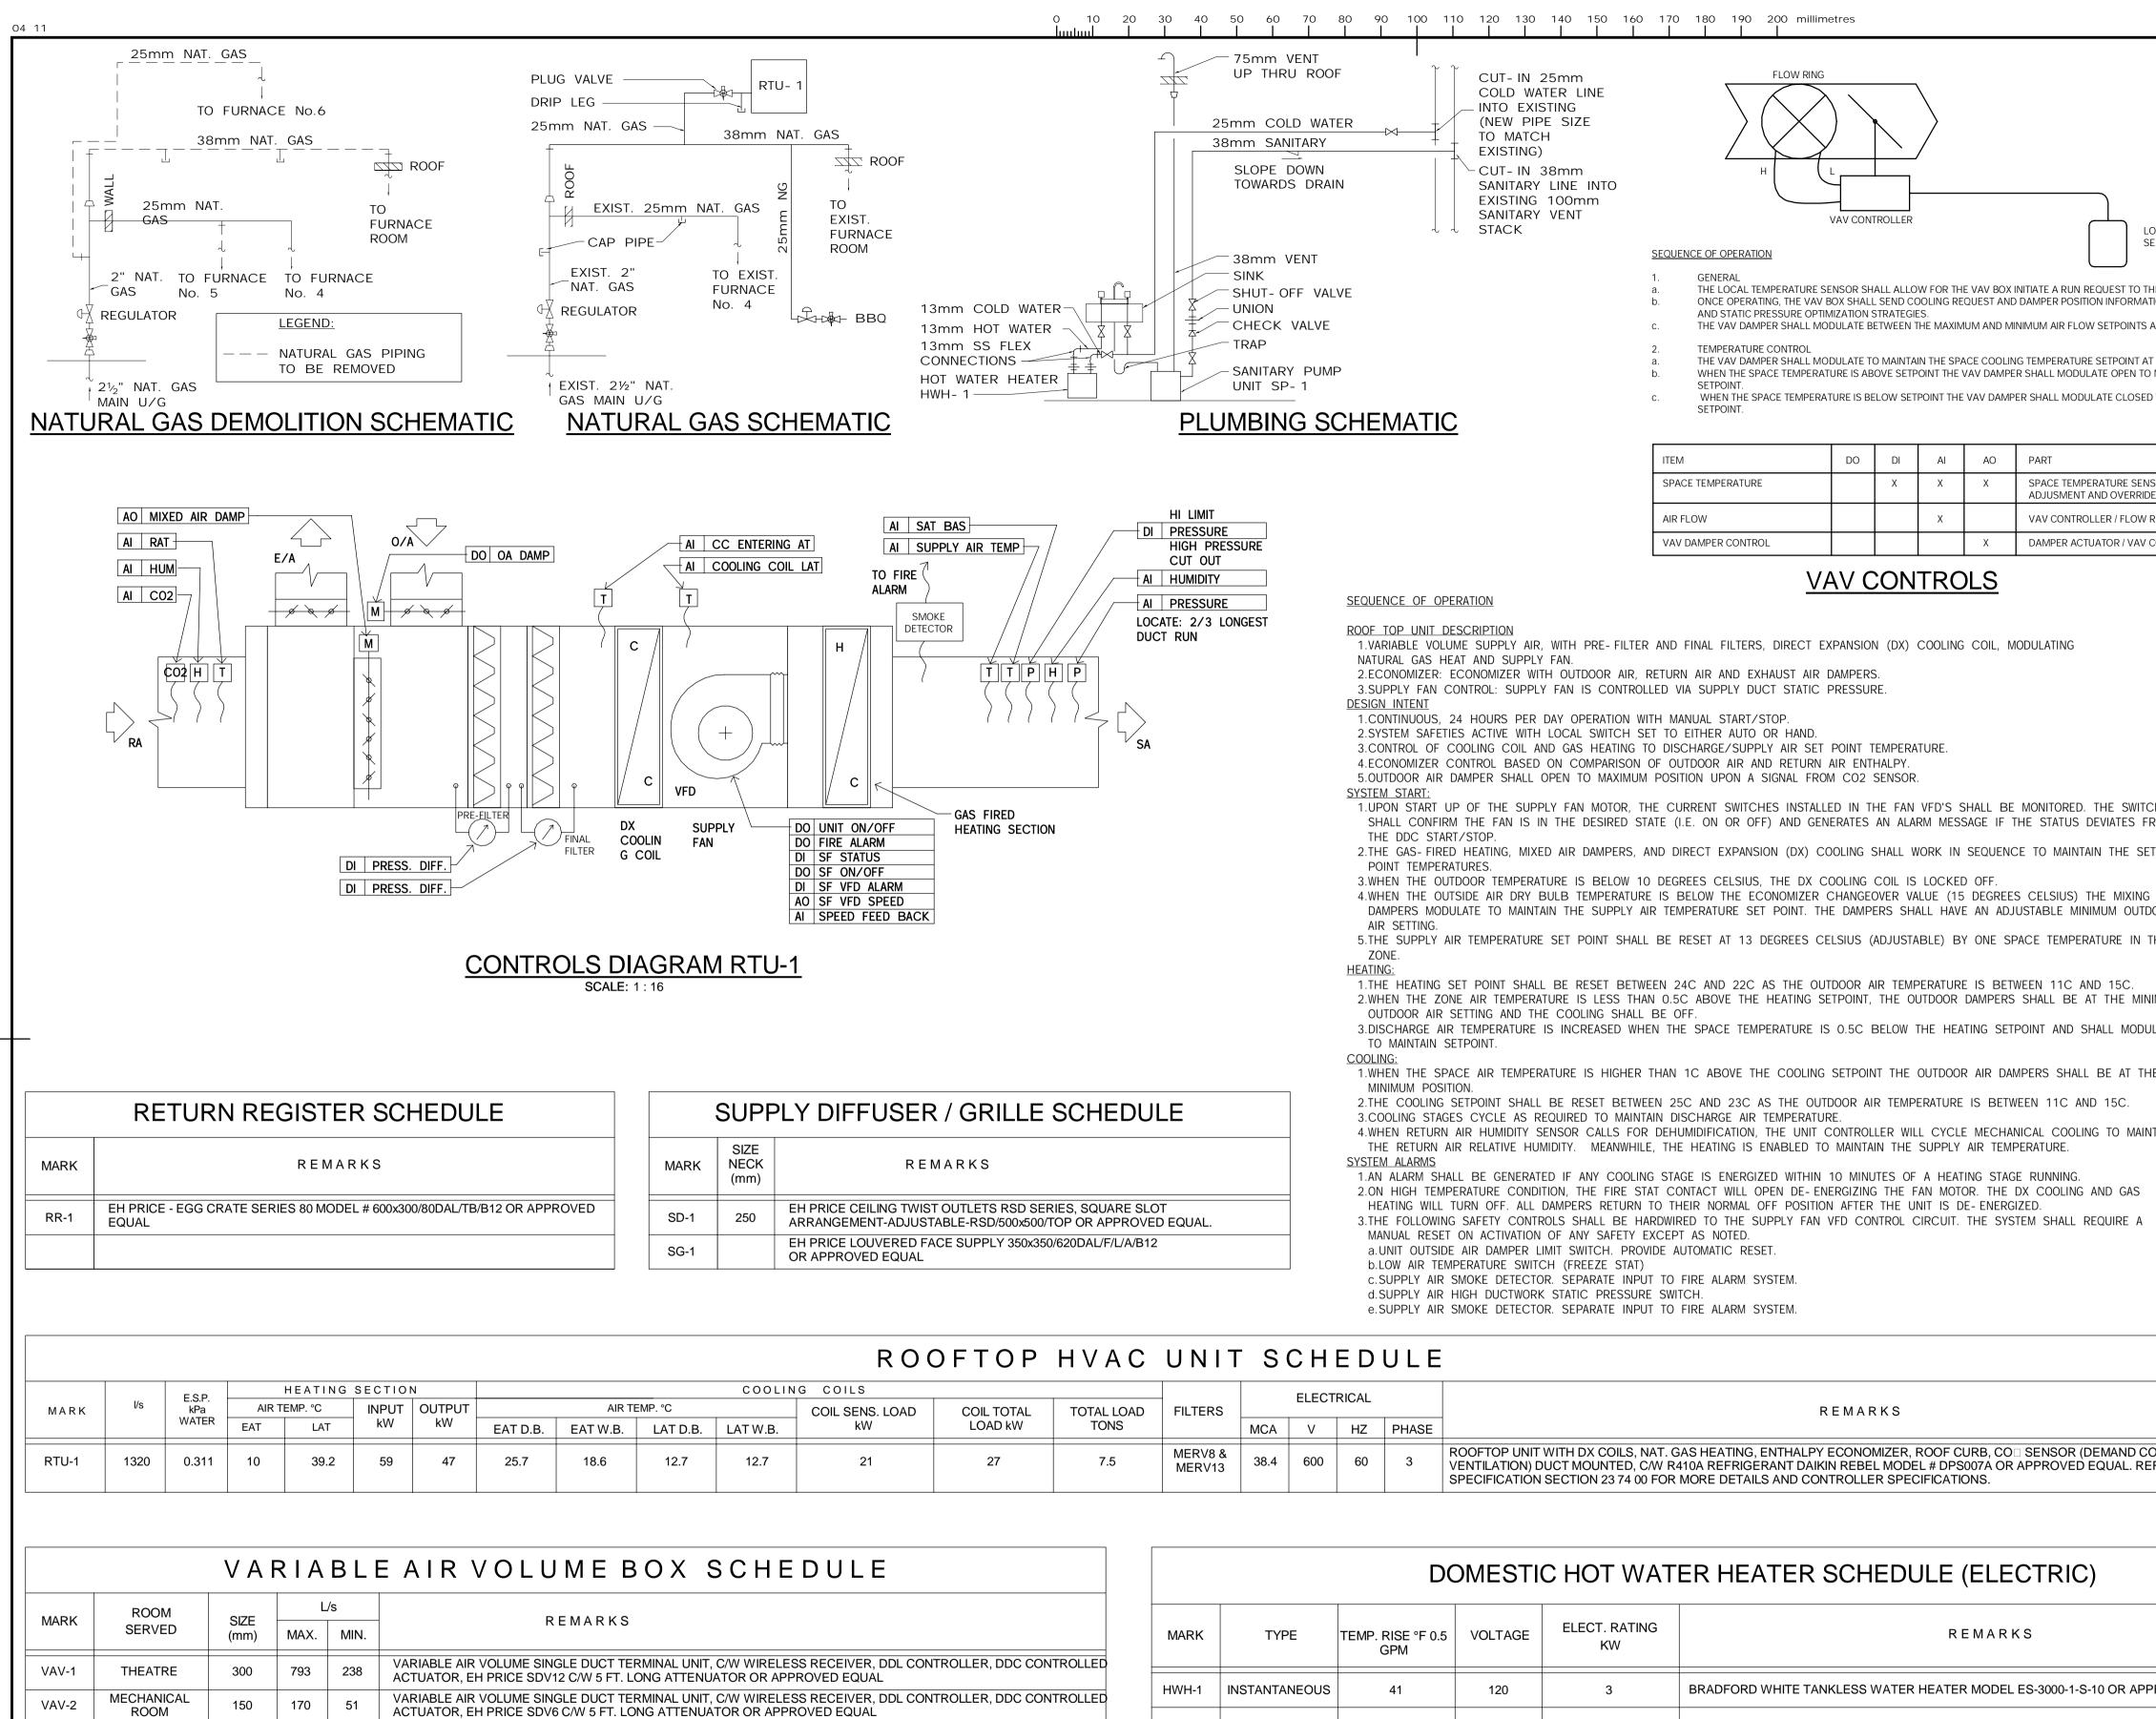
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N CONSULTING LIMITED 3200 DEZIEL DRIVE, SUITE 608, WINDSOR, ONTARIO, N8W 5K8, PHONE (519) 948-5000, FAX (519) 948

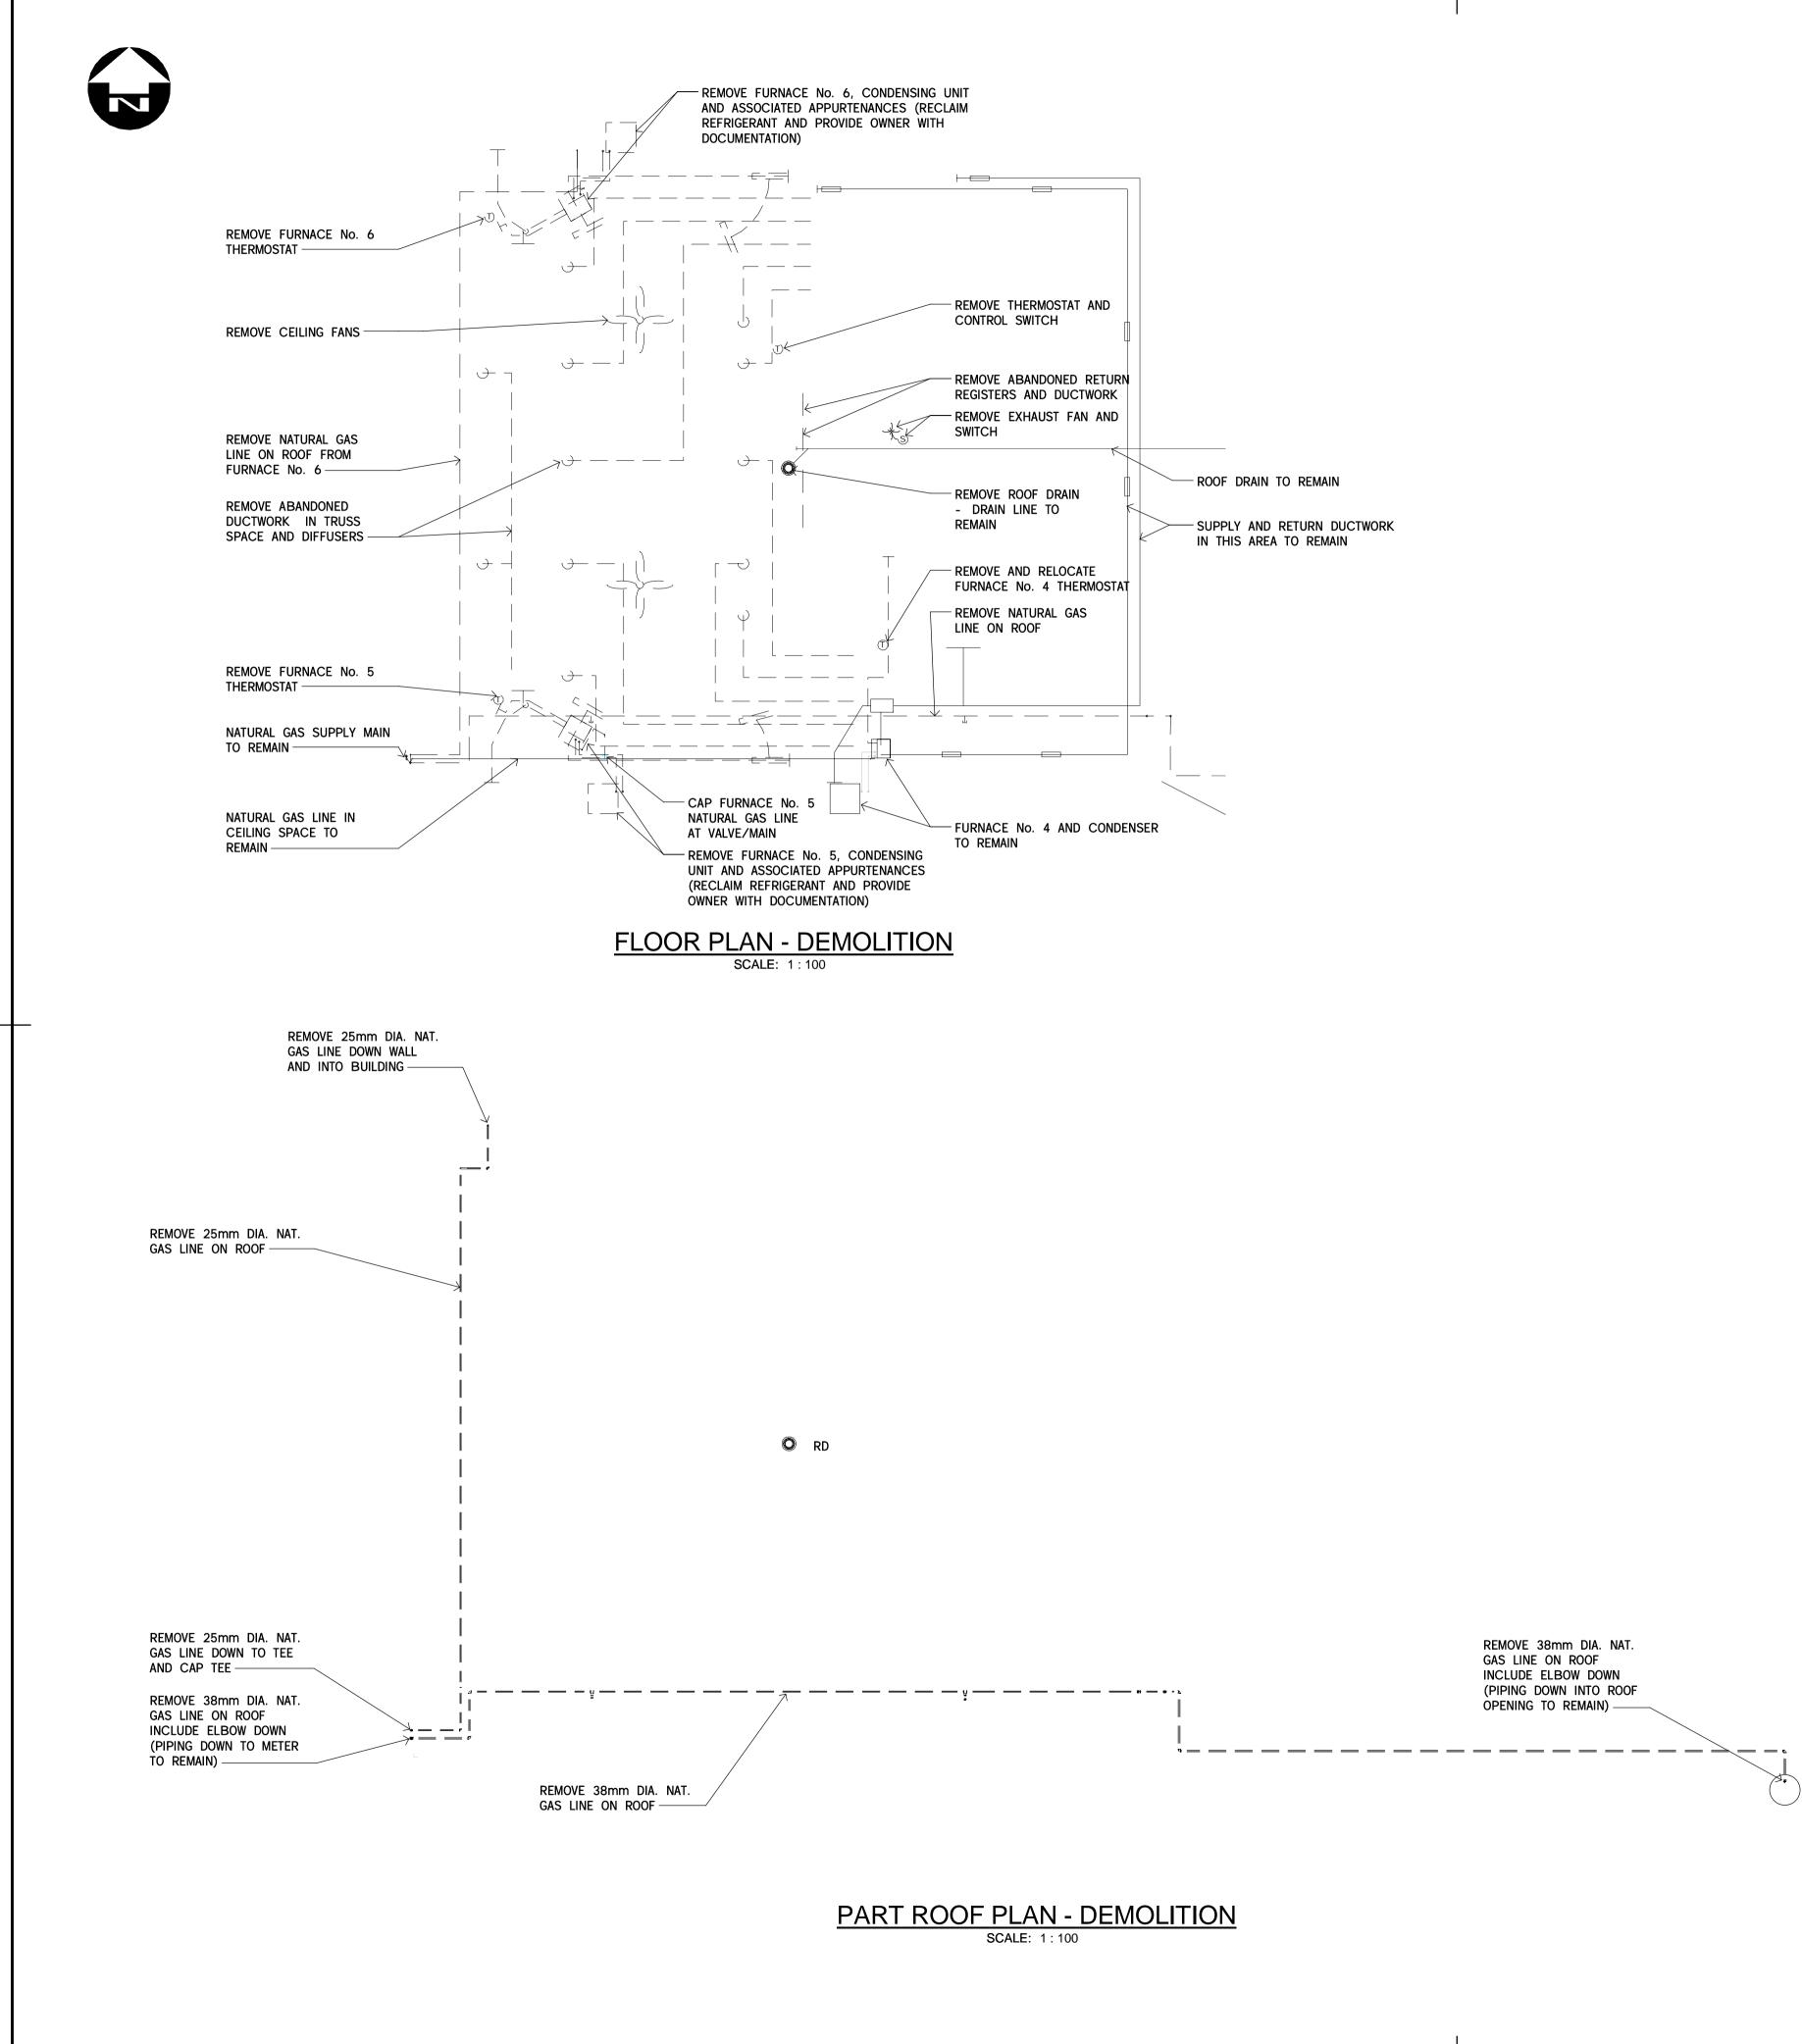

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PARKS CANADA 1118 POINT PELEE LEAMINGTON, N8H 3	DR. 3V4 E THEATRE
PARKS CANADA 1118 POINT PELEE LEAMINGTON, N8H 3 VISITOR CENTRE drawing title titre du dessin MECHANICAL ROOF PLAN AN	DR. 3V4 E THEATRE
PARKS CANADA 1118 POINT PELEE LEAMINGTON, N8H 3 VISITOR CENTRE drawing title titre du dessin MECHANICAL ROOF PLAN AN drawn by dessine par TKD designed by conc par CWW	DR. 3V4 E THEATRE
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SL-2	RTU-1	1198	450	600	1500	ELBOW	0.022	6	8	14	19	32	27	24	19	T-RE

ACTUATOR, EH PRICE SDV8 C/W 5 FT. LONG ATTENUATOR OR APPROVED EQUAL

VAV-3

WORKSHOP

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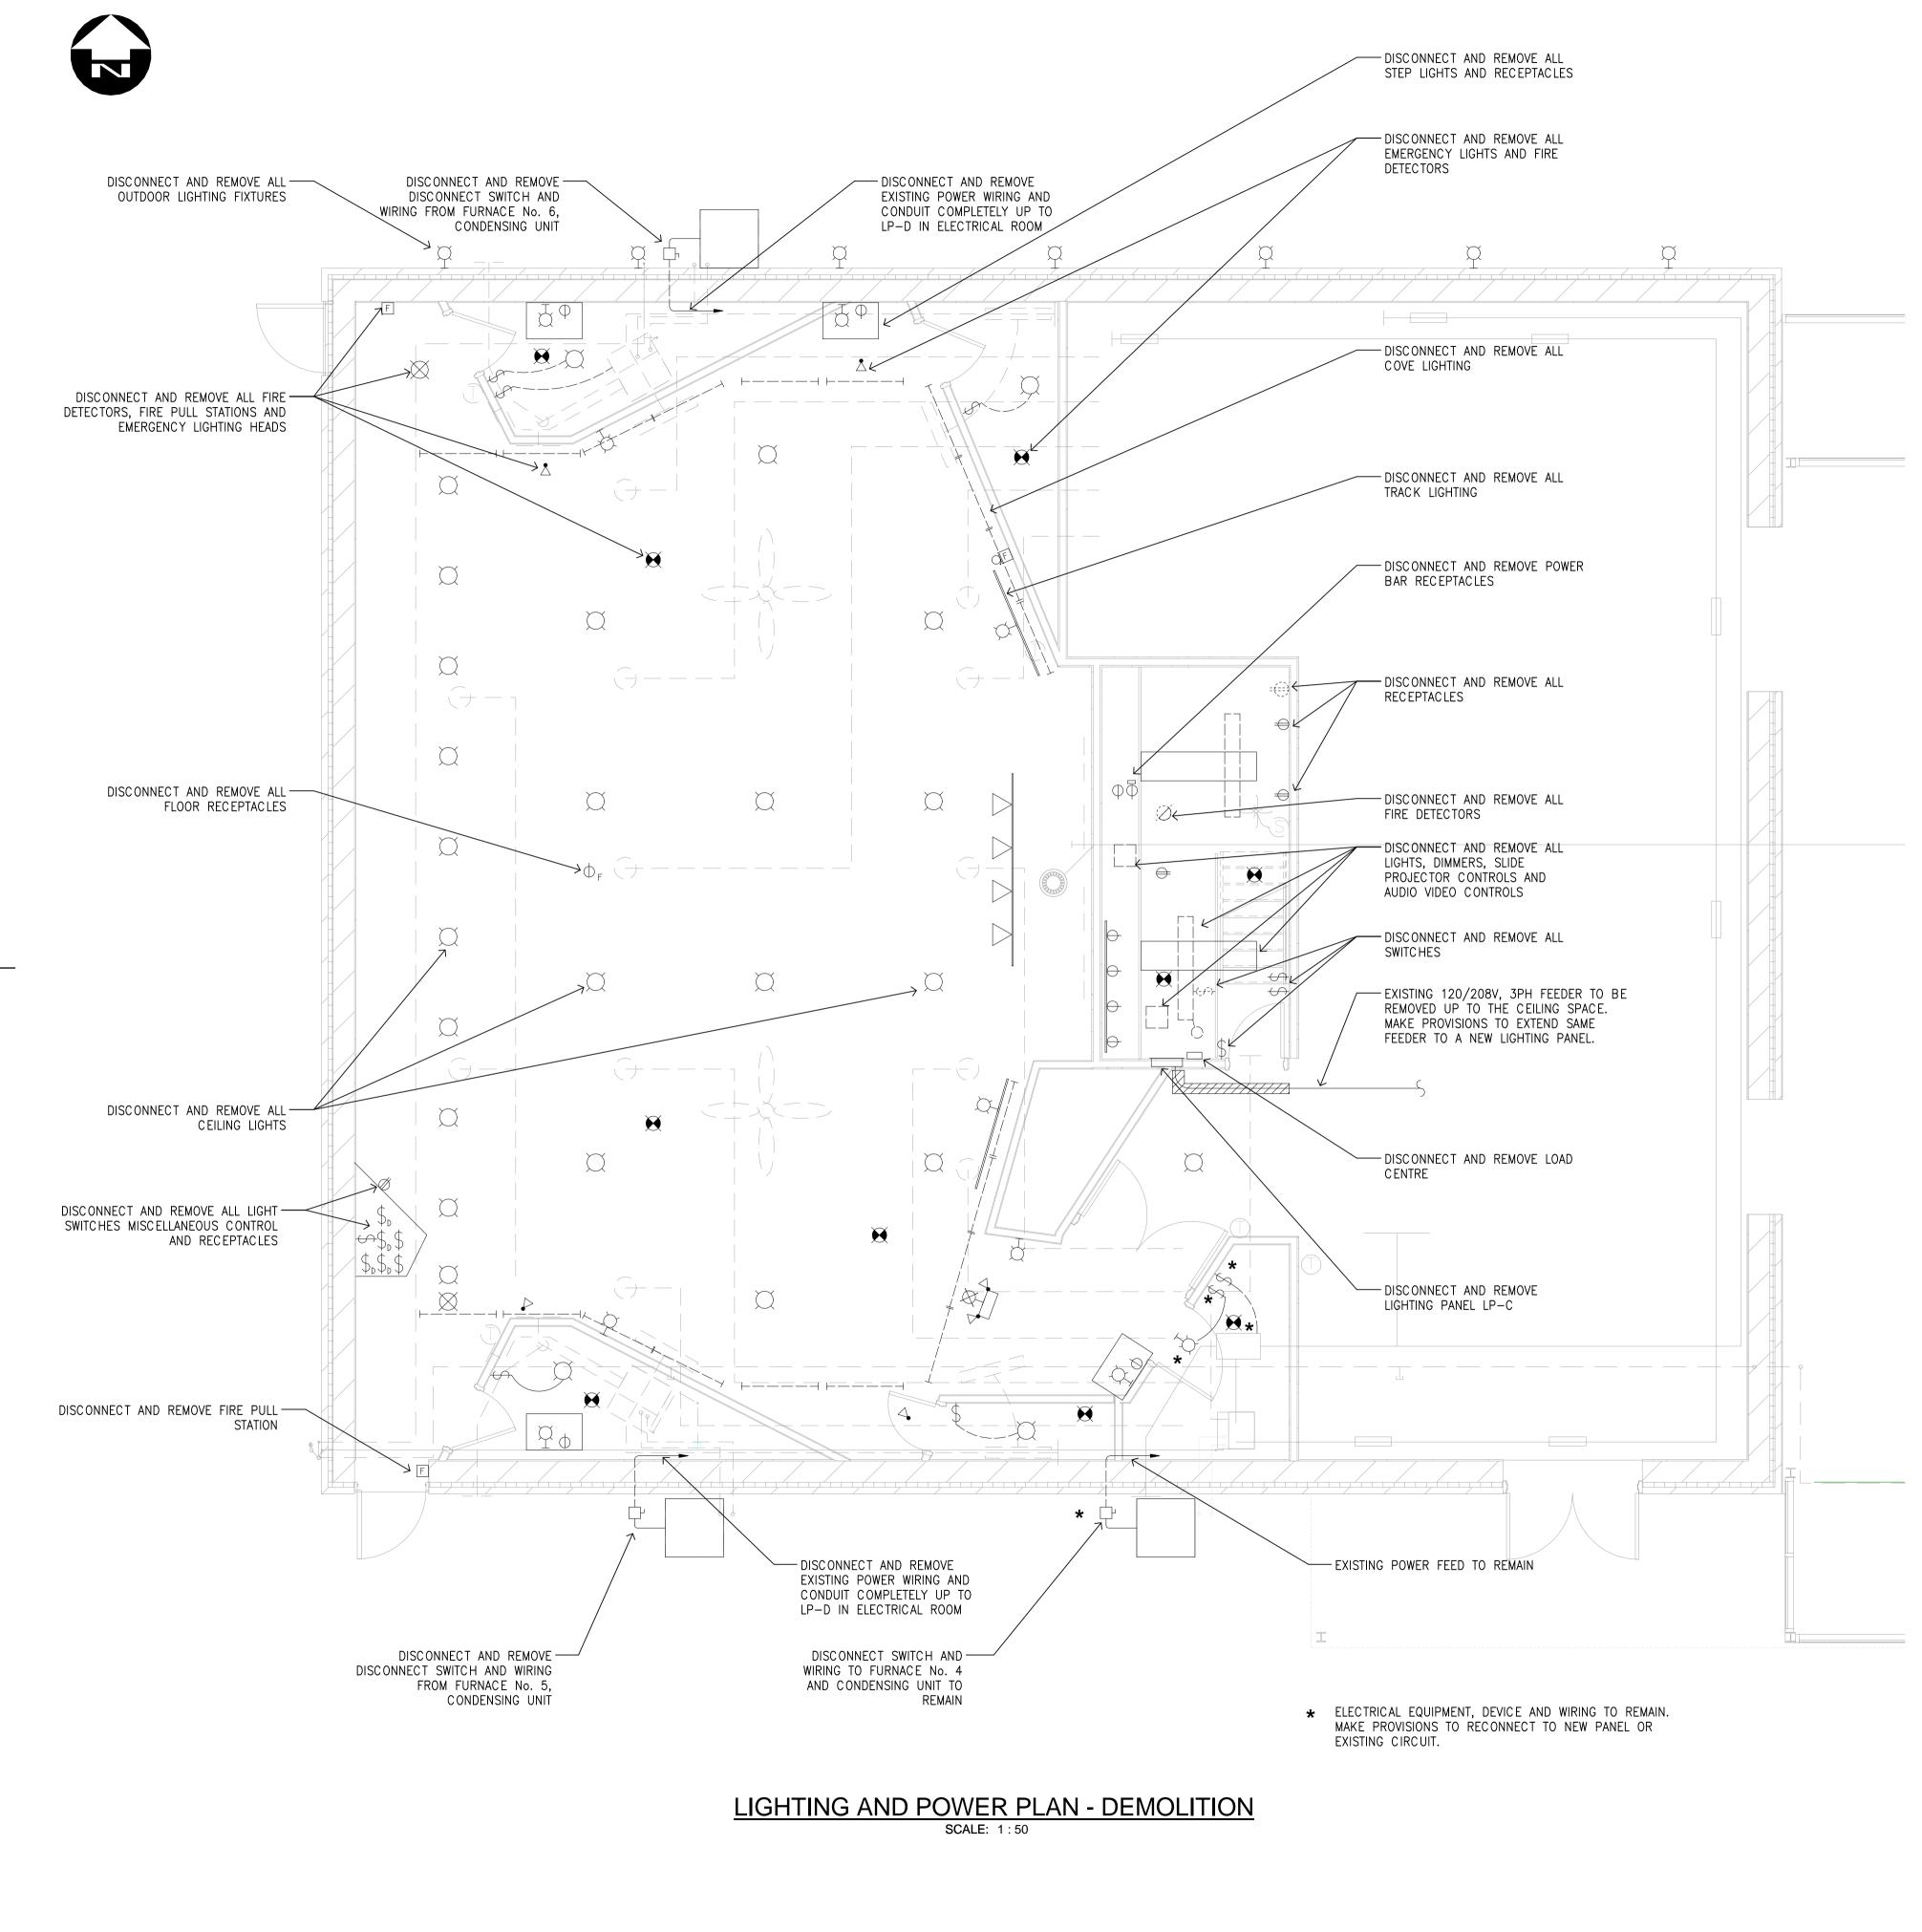
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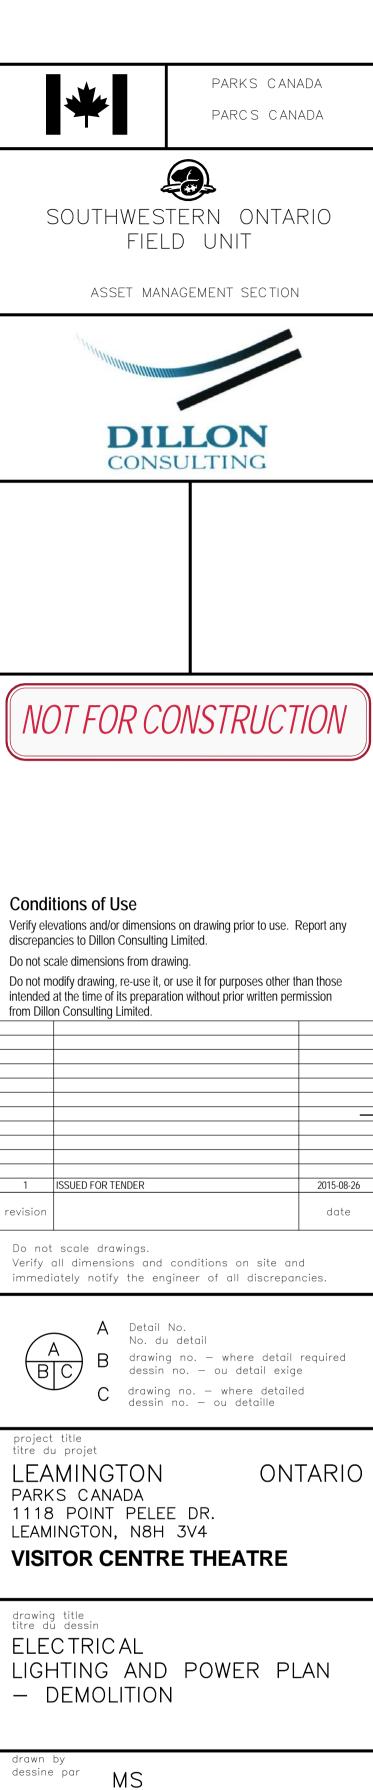
VARIABLE AIR VOLUME SINGLE DUCT TERMINAL UNIT, C/W WIRELESS RECEIVER, DDL CONTROLLER, DDC CONTROLLED

MODEL	REMARKS
RED-L-18027	CASING TO BE HTL EQUIVALENT TO 14 GAUGE DUCT WALL TO CONTROL BREAKOUT. TRANSITIONAL ELBOW SILENCER. INLET 864x762, OULET: 457x864
	CASING TO BE HTL EQUIVALENT TO 18 GAUGE DUCT WALL TO CONTROL BREAKOUT.
T-RED-L-18027	TRANSITIONAL T-ELBOW SILENCER. INLET 457x457 AND 254x457, OULET: 1200x457

FLO			_						1	*	PARKS CA PARCS CA	
	\times)		$\langle \rangle$							-		
H		CONTROL							SC		TERN ONTA .D UNIT	ARIO
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	[DI AI	AO	PART							
JRE		×	(X	Х	SPACE TEMPE ADJUSMENT A	RATURE SENSOR W/ DISPLAY, ND OVERRIDE						
TROL			X	X		LER / FLOW RING	-					
		/ CO			I							
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AND RE		ENTHAL	PY.									
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,					ENCE TO MAINTA				Verify elevation	ns of Use ons and/or dimensior	ns on drawing prior to use.	Report any
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					DAMPERS SHALL ETWEEN 11C ANI							0045 65 51
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		SA	ΝΙΤΑ	RY F	PUMP SC	CHEDULE			soumissior project da			administrateur de projets
MARK		FULL LOAD AMPS	HEAD kpa	HP	ELECTRICAL	REMARKS		-	date du p project no	2014	/02/21	
SP-1	0.2	5	60	0.3	120V/1PH	LIBERTY PUMPS MODI APPROVED EQUAL	EL 404 OR		no. du pr	1383	383	
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CEILING FIXTURE SPOT LIGHT WALL MOUNTED FIXTURE EXIT LIGHT FIRE ALARM BELL FIRE ALARM PULL STATION FIRE / SMOKE DETECTOR EMERGENCY LIGHT HEAD

EMERGENCY LIGHT UNIT C/W EXIT LIGHT

DUPLEX RECEPTACLE SINGLE RECEPTACLE SWITCH DIMMER SWITCH

DISCONNECT SWITCH

drawing title titre du dessin ELECTRICAL

dessine par

designed by conc par

approved by approuve par


project manag soumission administrate MARK MAJOR de projets

^{date du projet} 2013/11/18 project no. no. du projet

138383 drawing no. dessine no.

VNC

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	LIGHTING FIXTURE SCHE	DULE	
-	DESCRIPTION	MANUFACTURER *	MODEL NUMBER
	LITHONIA COMMERCIAL DOWNLIGHTING - DOM LED SERIES, 16-GAUGE GALVANIZED STEEL MOUNTING/PLASTER FRAME WITH TORSION SPRINGS, RUGGED, ONE-PIECE. DIE-CAST HOUSING WITH WHITE INTERIOR DOME REFLECTOR. POST- INSTALLATION ADJUSTMENT POSSIBLE FROM ABOVE OR BELOW THE CEILING. THERMAL PROTECTION PROVIDED. HIGH EFFICIENCY ELECTRONIC LED DRIVER (DIMMABLE) MOUNTED IN THE JUNCTION BOX. DIMMING SHALL BE COMPATIBLE WITH THE LUTRON GRAFIK EYE SYSTEM.	LITHONIA LIGHTING	DOM8-LED-1500L-120
	JUNO MINI LEDSTEP LIGHTS – BLACK FINISH WALL MOUNT FIXTURE.	JUNO LIGHTING	LMS-3K-H-BK
	JUNO MINI LEDSTEP LIGHTS – BLACK FINISH WALL MOUNT FIXTURE.	JUNO LIGHTING	LMS-3K-L-BK
	JUNO MINI LEDSTEP LIGHTS – BLACK FINISH WALL MOUNT FIXTURE.	JUNO LIGHTING	LMS-3K-C-BK
	LED WALL PACK LIGHTING FIXTURE, 120V.	LITONIA LIGHTING	OLW14
	LED ILLUMINATED UNIVERSAL MOUNT COMBINATION UNIT PICTOGRAM WITH TWO LED LIGHTING HEADS	LUMAC ELL	LAC 1W640 2 LD1 AT LAMP: 6V-4W MR16 LED
	EMERGENCY LIGHTING UNIT C/W BATTERY, CHARGER UNIT, TO LED LIGHTING HEADS WITH PROVISIONS FOR REMOTE WIRING OF EXIT PICTOGRAM.	LUMAC ELL	GRA 72 2 LD1 W AT LC LAMP: 6V-6W MR16 LED
	LED UNIVERSAL MOUNT PICTOGRAM EXIT SIGHN SHALL OPERATE WITH UNIVERSAL 120V AC AND 6V DC INPUTS.	LUMAC ELL	LA 1 W U
_	152mm CLEAR DIFFUSE OPEN REFLECTOR WITH MEDIUM-BASE PORCELAIN SOCKET	LITONIA LIGHTING	13W MEDIUM-BASED SELF BALLANCED CFL

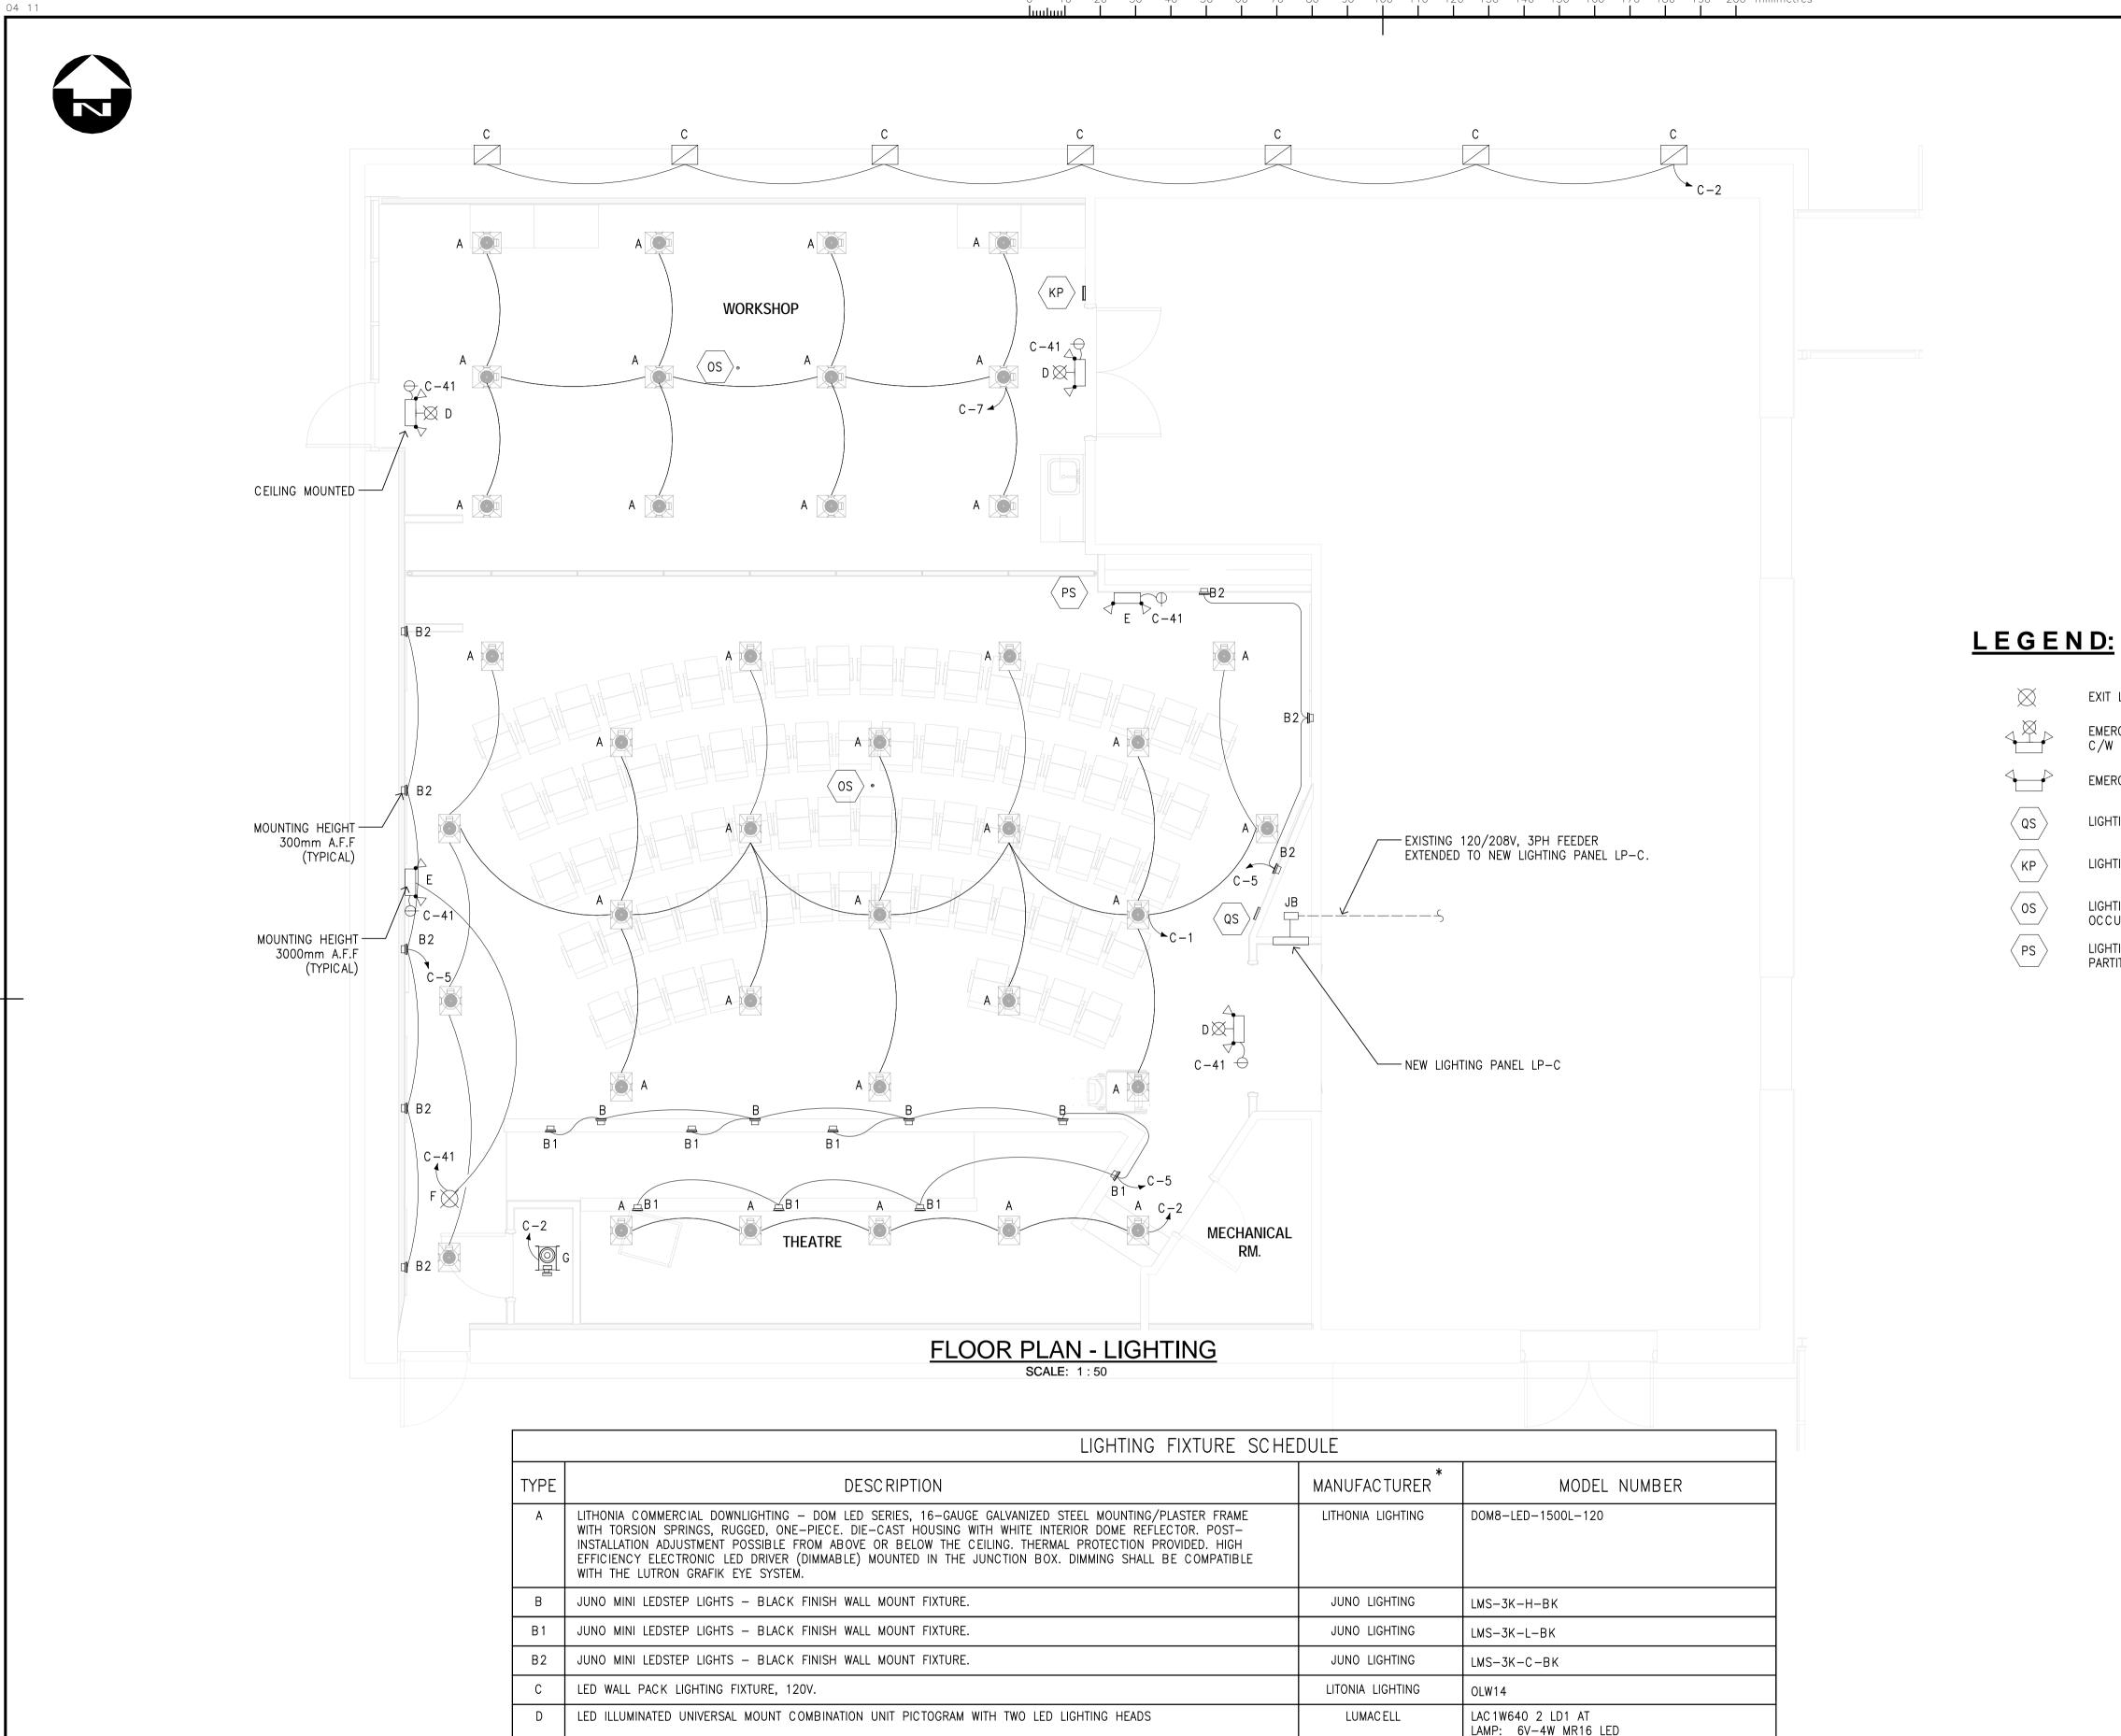LIGHTING FIXTURE SCHEDULE SCALE: NOT TO SCALE

* OR DEPARTMENT REPRESENTATIVE APPROVED EQUAL

	PARKS CANADA					
*	PARCS CANADA					
SOUTHWESTERN ONTARIO FIELD UNIT						
	GEMENT SECTION					
	LON					
	NSTRUCTION					
Conditions of Use						
Conditions of Use Verify elevations and/or dimensions	on drawing prior to use. Report any					
discrepancies to Dillon Consulting Li Do not scale dimensions from drawir	mited.					
Do not modify drawing, re-use it, or ι	use it for purposes other than those					
intended at the time of its preparation from Dillon Consulting Limited.	n without prior written permission					
1 ISSUED FOR TENDER	2015-08-26					
revision	date					
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project title titre du projet						
LEAMINGTON parks canada	ONTARIO					
1118 POINT PELEE						
LEAMINGTON, N8H						
VISITOR CENTRE						
drawing +i+12						
drawing title titre du dessin FIFCTPICAI						
ELECTRICAL FLOOR LIGHTIN	G PLAN					
drawn by						
dessine par MS						
designed by						
concipar VNC						
approved by						
approuve par						
tender soumission MARK	project manage administrate de projet					
project date date du projet						
2013/	/11/18					
project no. no. du projet	/11/18					
project no. no. du projet 1383						
project no. no. du projet						

EXIT LIGHT

EMERGENCY LIGHT UNIT C/W EXIT LIGHT

EMERGENCY LIGHT UNIT

LIGHTING CONTROLLER

LIGHTING CONTROL OCCUPANCY SENSOR

LIGHTING CONTROL PARTITION SENSOR

LIGHTING CONTROL KEYPAD

 \bigotimes


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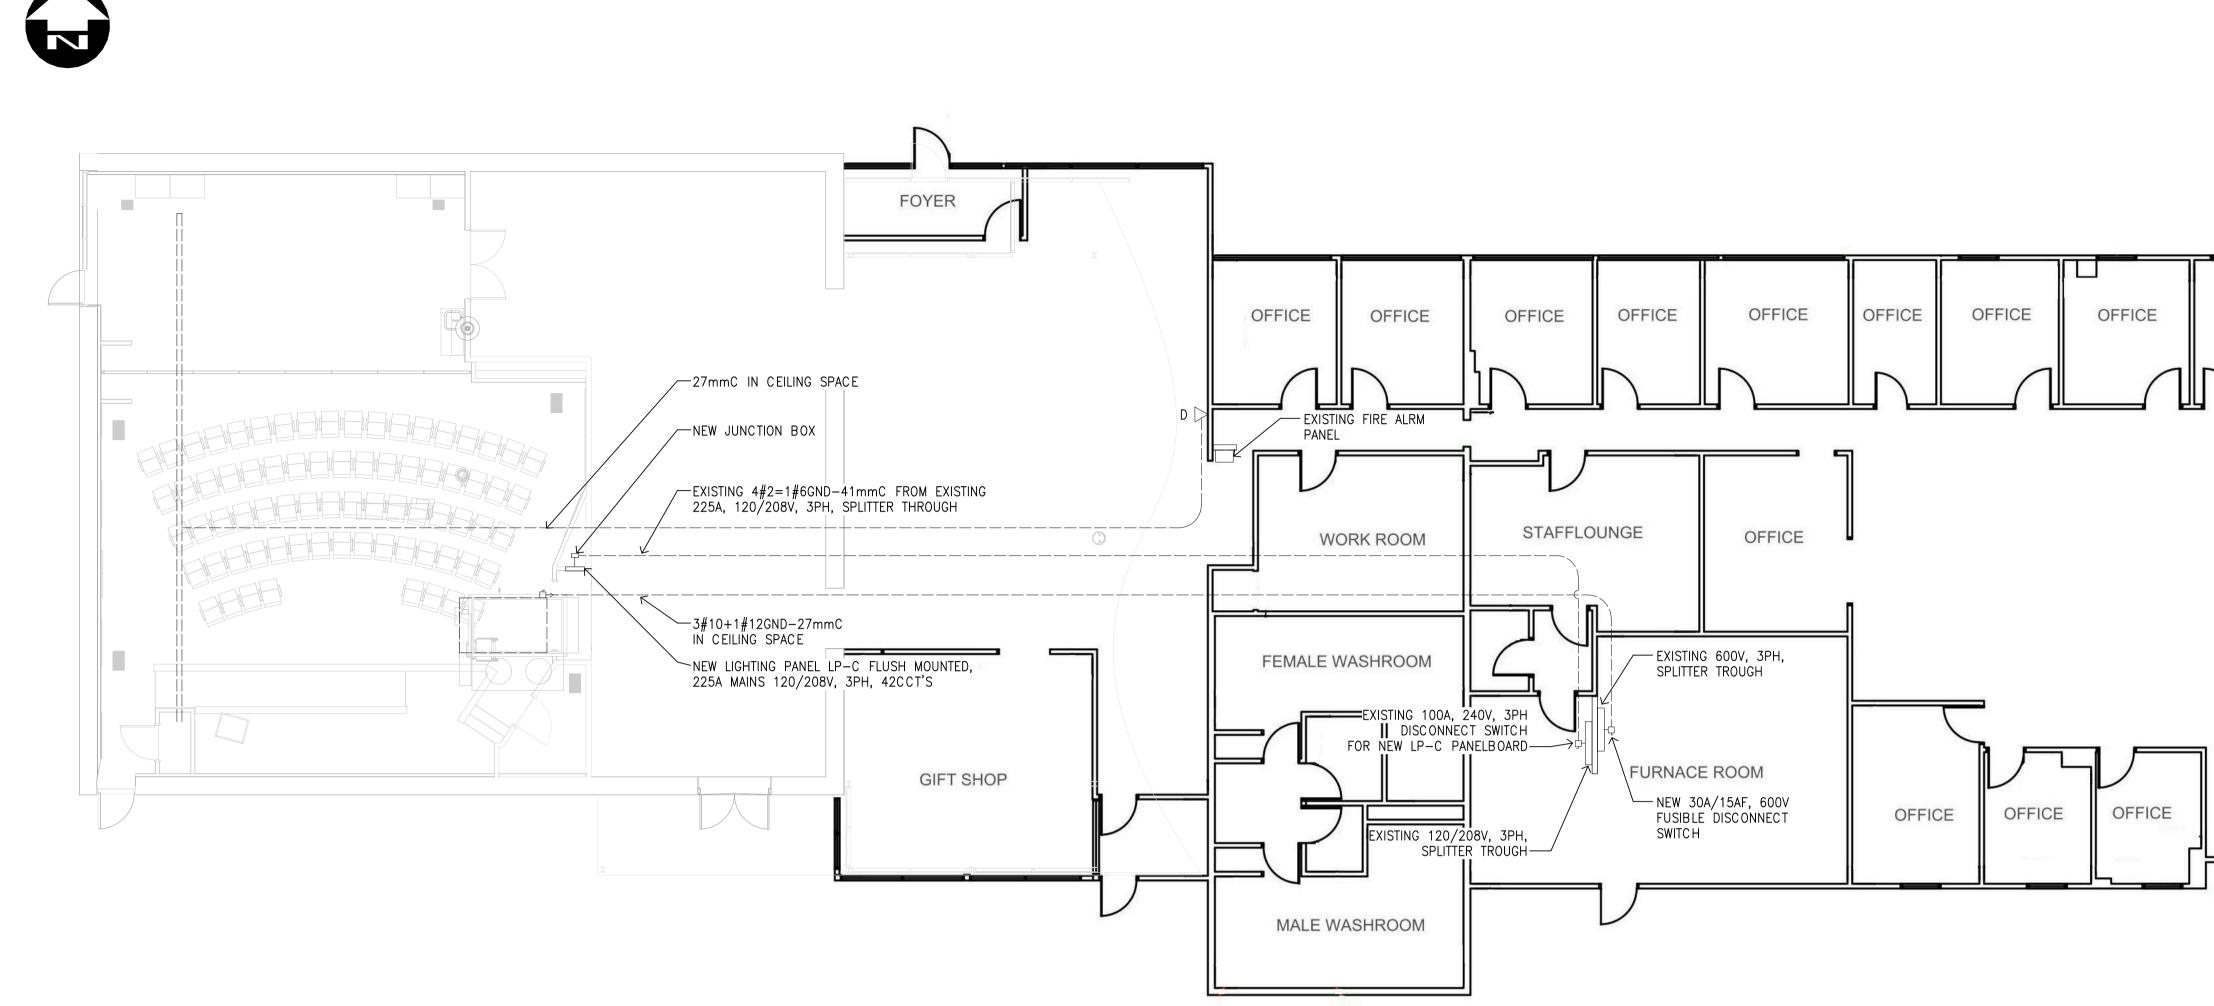


SHALL BE IN ACCORDANCE WITH THE AUDIO VISUAL SPECIFICATIONS

*	PARKS CANADA Parcs canada					
	ERN ONTARIO D UNIT					
ASSET MAN	AGEMENT SECTION					
DIL	LON					
NOT FOR CO	DNSTRUCTION					
Conditions of Use Verify elevations and/or dimensions discrepancies to Dillon Consulting I	s on drawing prior to use. Report any Limited.					
Do not scale dimensions from draw Do not modify drawing, re-use it, or	ring. • use it for purposes other than those					
intended at the time of its preparation from Dillon Consulting Limited.	on without prior written permission					
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Do not scale drawings. Verify all dimensions and o immediately notify the eng						
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project title titre du projet LEAMINGTON	ONTARIO					
PARKS CANADA 1118 POINT PELEE						
LEAMINGTON, N8H						
denvie a titla						
drawing title titre du dessin ELECTRICAL						
POWER PLAN	LAYOUT					
drawn by dessine par MS						
designed by conc par VNC						
approved by approuve par						
tender soumission MARK	project manager administrateur de projets					
project date						
project no. no. du projet	/11/18					
1383	83					
drawing no. dessine no. E102						

SMOKE DETECTOR HEAT DETECTOR, RATE-OF RICE CEILING MOUNTED SPEAKER DUPLEX RECEPTACLE WEATHERPROOF DUPLEX RECEPTACLE WITH IN-USE COVER ↔WPF WEATHERPROOF DUPLEX RECEPTACLE GFCI WITH IN-USE COVER AND WITH GROUND FAULT CIRCUIT INTERRUPTER SINGLE RECEPTACLE TV OUTLET MICROPHONE OUTLET DATA OUTLET SPEAKER OUTLET FIRE ALARM HORN AND STROBE LIGHT COMBINATION UNIT FIRE ALARM MANUAL PULL STATION



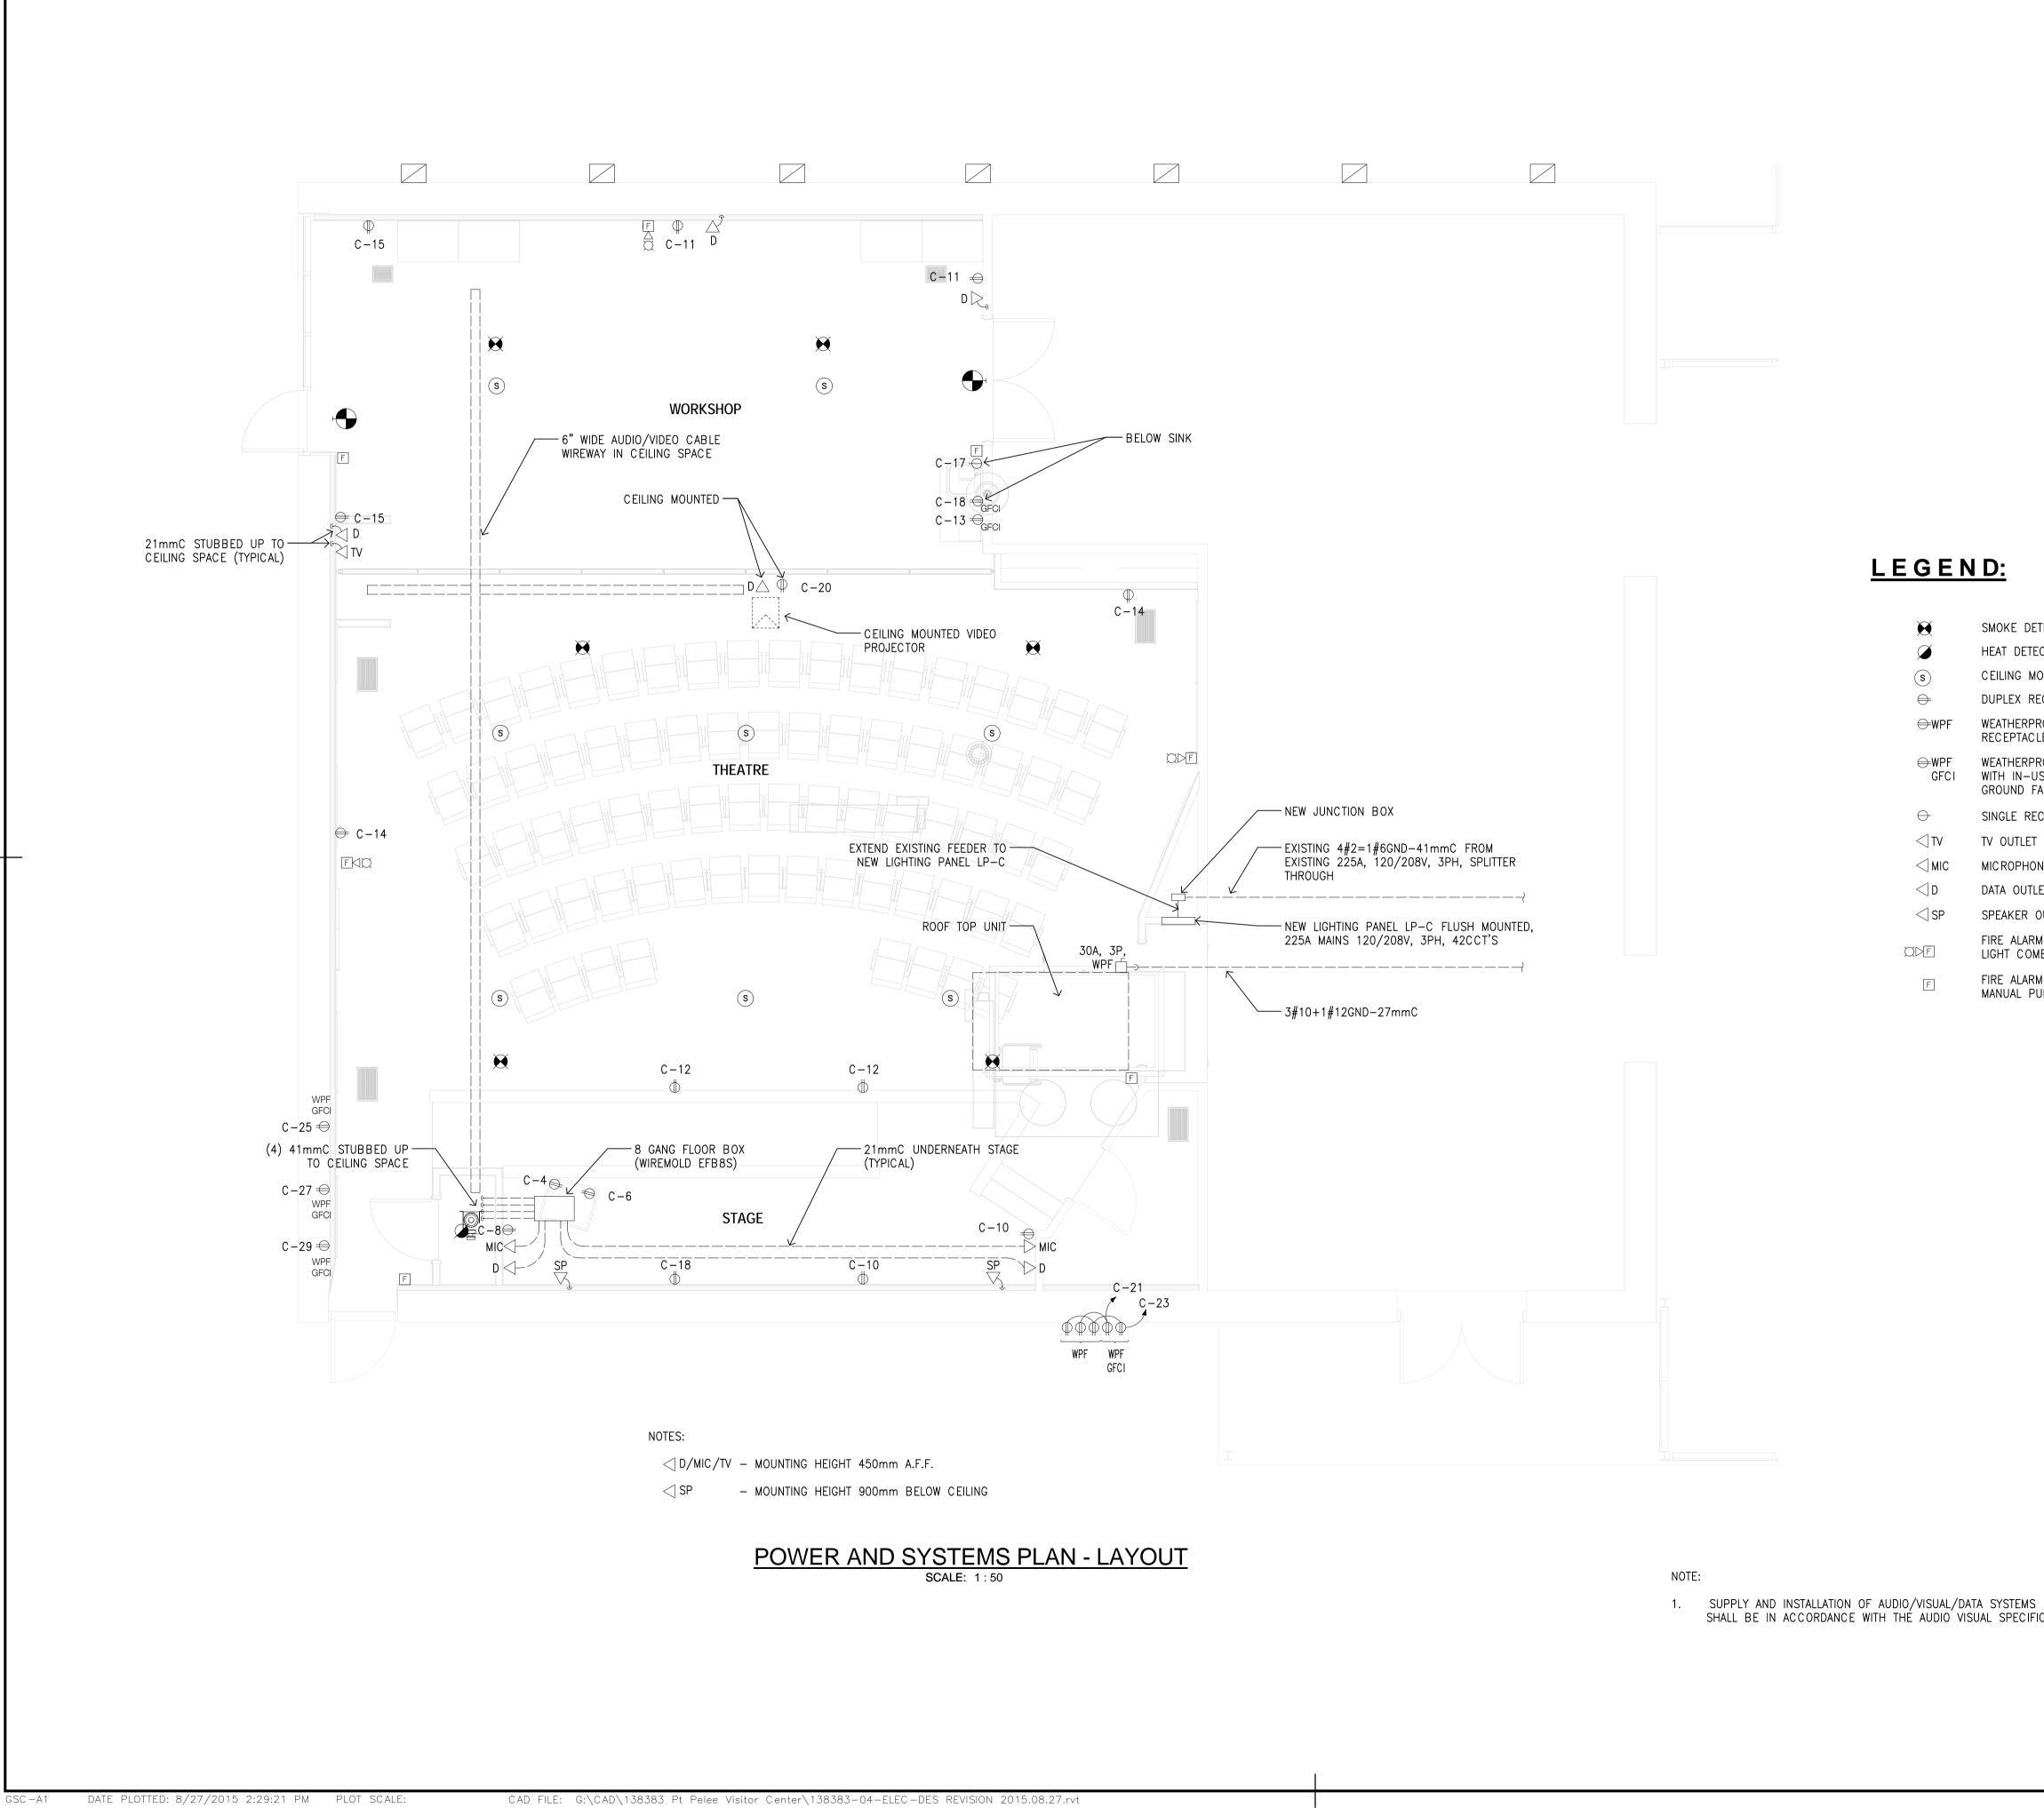

Ν	IEW PANELBOARD LP-C	200A, MA	INS	120/20	8V, 3PH, 4W 42CCT'	S
LOAD	DESCRIPTION				DESCRIPTION	LOAD
	THEATRE LIGHTS			15A 2	EXTERIOR WALL LIGHTS	
	THEATRE LIGHTS	<u>3</u> 15A	_	20A 4	THEATRE PODIUM RECEPTACLES	
	THEATRE STEP LIGHTS	5 15A		20A 6		
	WORKSHOP LIGHTING	7 <u>15A</u>		20A 8		
	WORKSHOP RECEPTACLES	<u>9</u> 20A	_	20A 10		
	WORKSHOP RECEPTACLES	$\begin{array}{c c} 11 \\ \hline 20A \\ \hline 17 \\ \hline 20A \\ \hline \end{array}$		20A 12		
	WORKSHOP RECEPTACLES	13 20A		20A 14		
	DRAIN PUMP	$\begin{array}{c c} 15 \\ \hline 17 \\ \hline 70 \\ \hline \end{array}$	_	20A <u>16</u>		
	WATER HEATER	- 17 - 30A		15A <u>18</u>		
	CEILING FANS	19 15A		20A20	SPARE	
	SOUTH OUTSIDE WALL RECEPTACLES	$\begin{array}{c c} 21 \\ \hline 15A \\ \hline 77 \\ 15A \end{array}$	_	20A 22	SPARE	
	SOUTH OUTSIDE WALL RECEPTACLES	$\begin{array}{c c} 23 \\ \hline 15A \\ $		20A 24	SPARE	
	WEST OUTSIDE WALL RECEPTACLES	<u>25 15A</u>		20A 26	SPARE	
	WEST OUTSIDE WALL RECEPTACLES	$\begin{array}{c c} 27 \\ \hline 15A \\ \hline 15A \\ \hline 15A \\ \hline \end{array}$	_	10A - 28	SPARF	
	WEST OUTSIDE WALL RECEPTACLES	$\begin{array}{c c} 29 \\ \hline 15A \\ \hline 74 \\ \hline 15A \\ \hline \end{array}$		15A <u>30</u>	SPARE	
	SPARE	<u>31 15A</u> 33		10A 32	SPARE	
	S Р А С Е		_	34		
	SPACE	35		36	JSPACE	
	SPACE	37 39		38	JSPACE	
	SPACE		_	40		
	EMERGENCY / EXIT LIGHTS	<u>41 15A</u>		42	SPACE	

PANELBOARD SCHEDULE

04 11

POWER PLAN - BUILDING LAYOUT SCALE: 1:100

