

ISSUED FOR TENDER

2015/09/30

OPERATIONS ZONE REDEVELOPMENT
PHASE 1A BUILDING DEMOLITION

OTTAWA, ONTARIO

SITE PLAN GENERAL NOTES:

- A. REFER TO SPECIFICATIONS AND HAZARDOUS MATERIALS REPORTS.
- B. CONTRACTOR IS TO PROVIDE SECURITY HOARDING AND SIGNAGE. HOARDING IS TO BE PROVIDED TO MEET STANDARDS. REFER TO DETAIL 2/A-0.0.
- C. SEE SOIL REMOVAL PLAN FOR ALL OTHER SITE WORKS.
- D. PROTECT ALL ADJACENT BUILDINGS, TREES AND LANDSCAPING FROM DAMAGE DURING PROJECT.
- E. CONTRACTOR RESPONSIBLE FOR COORDINATION AND BRINGING BELL TO SITE PRIOR TO DEMOLITION TO REROUTE ALL BELL LINES. COORDINATE WITH NCC TO ENSURE ADJACENT BUILDING PHONE SYSTEMS ARE NOT AFFECTED.
- F. LAYOUT OF SITE HOARDING IS SCHEMATIC. COORDINATE FINAL LAYOUT WITH NCC REPRESENTATIVE PRIOR TO INSTALLATION AND SOIL REMOVALS PACKAGE OF WORK.

DEMOLITION NOTES:


- 1 REMOVE CONCRETE PROTECTION BARRIERS AND DELIVER TO OWNER'S OFF SITE STORAGE FACILITY.
- 2 DISMANTLE FENCE. TURN OVER ABOVE GRADE COMPONENTS TO CLIENT. DISPOSE OF BELOW GRADE COMPONENTS SEE ELECTRICAL FOR REMOVAL OF ELECTRICAL DEVICES.
- 3 DEMOLITION OF WATER TAPS BY OTHERS.
- 4 BUILDING TO BE DEMOLISHED. SEE A-1.0 THROUGH A-2.3.
- 5 REMOVE ASPHALT.

SITE PLAN NOTES:

- 1 MAINTAIN CLEARANCE OF EXISTING WALKWAY. INSTALL PROTECTIVE MEASURES FOR EXISTING LIMESTONE PATHWAY AND RETAINING WALL.
- 2 PROTECT OCTAGONAL HERITAGE BUILDING FROM DAMAGE DURING PROJECT.
- 3 PRE-FINISHED SHED ON PTW DECK REMOVED BY OTHER.
- 4 TREES ADJACENT TO PROJECT AREA - PROTECT. SEE SOIL REMOVAL PACKAGE.
- 5 SEMI-TRACKER GENERATOR TO BE REMOVED BY OTHER.
- 6 ACCESS STAIR AND PLATFORM TO BE REMOVED BY OTHER.
- 7 DIESEL TANK AND FLAMMABLE STORAGE CABINET TO BE RELOCATED BY OTHERS.
- 8 EXPOSED ELECTRICAL SERVICE FROM SITE OFFICE TO STORAGE SHED BUILDING. SEE ELECTRICAL.
- 9 FENCE WITH ELECTRICAL HOOK UPS AT EACH POST 190mm x 190mm. SEE ELECTRICAL.
- 10 LOCATION OF OCTAGONAL HERITAGE BUILDING.
- 11 MAINTAIN AREA OF SITE ACCESS FOR OWNER VEHICLES AT HEATING PLANT.
- 12 BAY OF STORAGE GARAGE CONNECTED TO OCTAGONAL HERITAGE BUILDING. SEE A-1.1.
- 13 ZONE OF WORK. COORDINATE WITH THE NCC REPRESENTATIVE FOR MOVEMENTS OUTSIDE THIS AREA.
- 14 AT ALL TIME, MAINTAIN CLEARANCE FOR SERVICE VEHICLES.
- 15 TREES REMOVED BY OTHER.




1 SITE PLAN
A-0.0 1:400

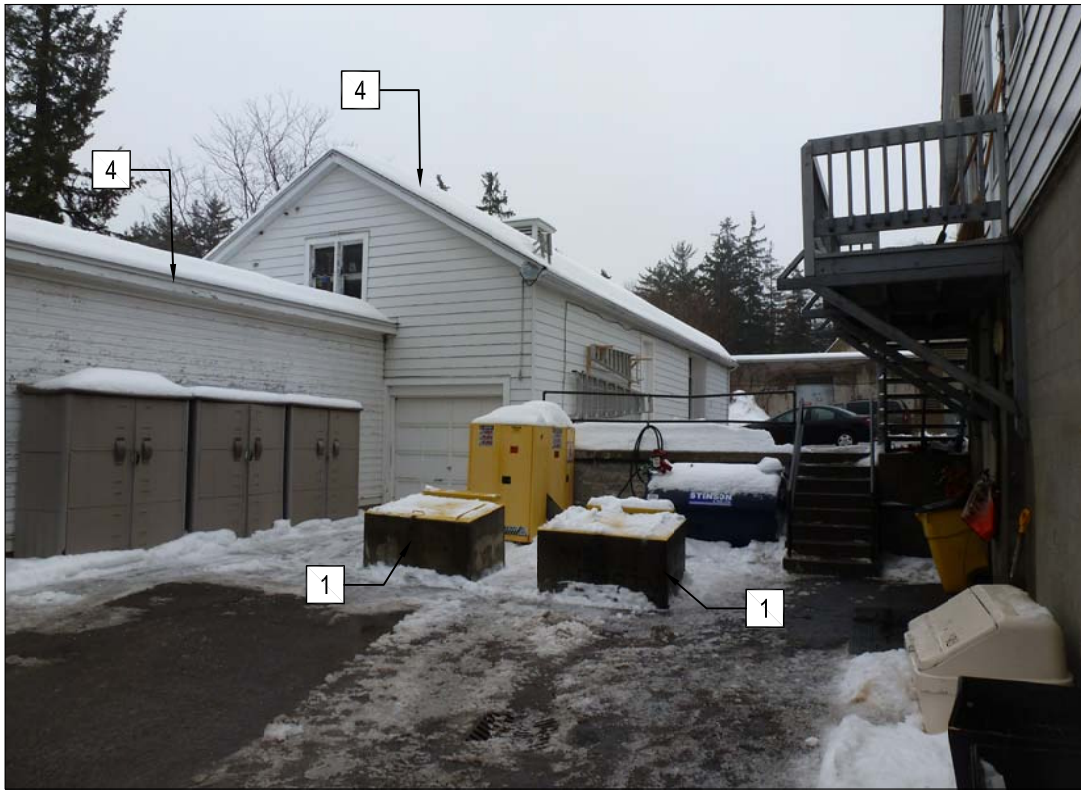

4 GARAGE AND STORAGE SHED DEMOLITION
A-0.0 N.T.S



3 FENCE TO BE DISMANTLED
A-0.0 N.T.S

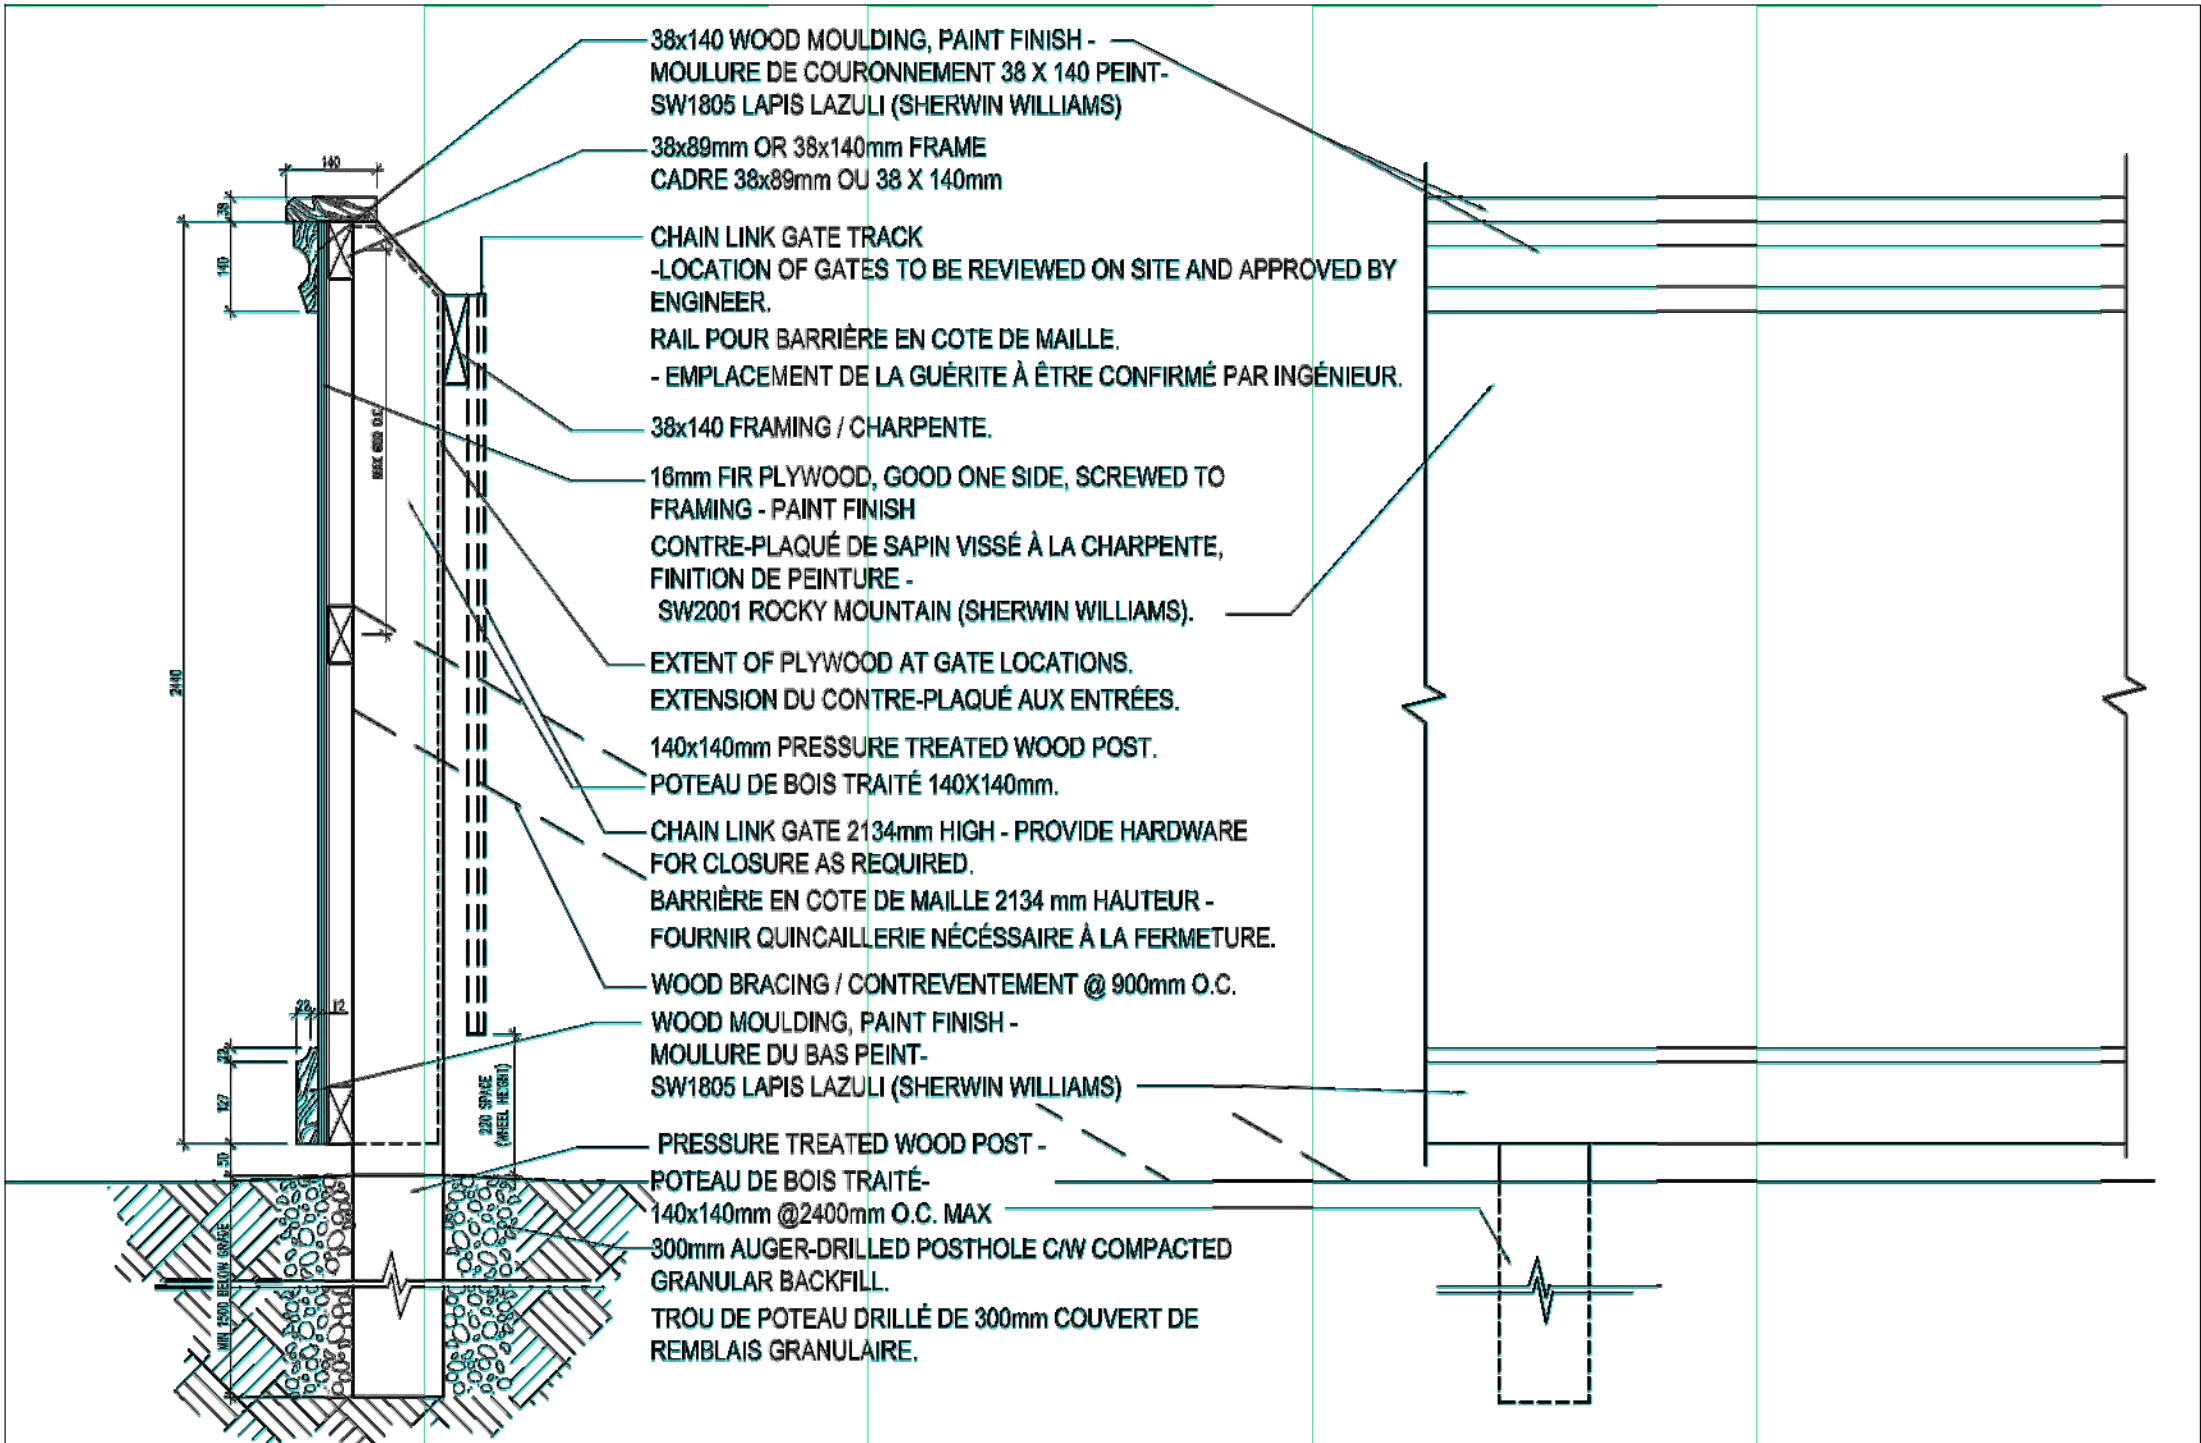

2 HOARDING
A-0.0 1:20



5 FUEL STORAGE AREA
A-0.0 N.T.S

- GENERAL NOTES:
- DO NOT SCALE DRAWINGS. CONFIRM ALL DIMENSIONS ON SITE.
 - THESE DRAWINGS ARE TO BE READ IN CONJUNCTION WITH THE DOCUMENTS OF THE STRUCTURAL, MECHANICAL, ELECTRICAL AND HAZARDOUS MATERIALS.
 - GENERAL CONTRACTOR IS RESPONSIBLE FOR ALL CUTTING, PATCHING AND MAKING GOOD SURFACES.
 - PROTECT EXISTING AND NEW SURFACES FROM DAMAGE AS REQUIRED DURING DEMOLITION AND CONSTRUCTION.
 - FOR ELECTRICAL AND MECHANICAL REMOVALS SEE ELECTRICAL AND MECHANICAL DOCUMENTS.
 - EXISTING CONDITIONS MAY VARY FROM WHAT IS SHOWN IN THESE DOCUMENTS. ADVISE THE NCC REPRESENTATIVE OF DIFFERING CONDITIONS. THE NCC REPRESENTATIVE WILL PROVIDE DIRECTION ON ACTION TO TAKE.
 - CONTRACTOR TO CONFIRM LOCATION OF UNDERGROUND SERVICES WITH CERTIFIED UNDERGROUND LOCATE PROFESSIONAL PRIOR TO DIGGING OR DRIVING POSTS.
 - CONTRACTOR TO COORDINATE WITH BELL, HYDRO AND ENBRIDGE PRIOR TO REMOVALS AND DEMOLITION. OBTAIN ALL REQUIRED PERMITS.

DRAWING LIST: / LISTE DE DESSINS

ARCHITECTURAL

- A-0.0 COVER PAGE AND SITE PLAN
A-1.0 GARAGE DEMOLITION
A-1.1 STORAGE SHED DEMOLITION
A-1.2 GARAGE AND SHOP BUILDING
A-2.0 SITE OFFICE BUILDING, BASEMENT AND LEVEL 1 DEMOLITION PLAN
A-2.1 SITE OFFICE BUILDING LEVEL 2 DEMOLITION PLAN
A-2.2 EXTERIOR ELEVATIONS
A-2.3 SITE BUILDING WALL SECTION INFORMATION

MECHANICAL

- M100 MECHANICAL SITE PLAN
M101 GARAGE BUILDING AND SHOP BUILDING - MECHANICAL DEMOLITION
M102 SHED PLANS - MECHANICAL DEMOLITION
M103 SITE OFFICE MECHANICAL DEMOLITION

ELECTRICAL

- E000 ELECTRICAL DRAWING LIST AND LEGEND
E002 ELECTRICAL DETAILS
E100 ELECTRICAL SITE PLAN
E200 ELECTRICAL SINGLE LINES
E301 GARAGE AND SHOP
E302 STORAGE SHED DEMOLITION PLANS
E303 OCTAGONAL HERITAGE BUILDING DEMOLITION
E304 SITE OFFICES LIGHTING DEMOLITION
E305 SITE OFFICES POWER DEMOLITION

SOIL REMOVAL

- SR-1 SITE PLAN
SR-2 TREE PROTECTION PLAN
SR-3 UNDERGROUND UTILITIES
SR-4 CROSS SECTION A-A' AND B-B'
SR-5 CROSS SECTION C-C' AND D-D'

LEGEND :

- XXXX ROOM NUMBER
WXXX WINDOW NUMBER
DXXX DOOR NUMBER
1 DEMOLITION NOTE
X CONSTRUCTION ASSEMBLY
1 NOTE NUMBER
1 AREA OF WORK
1 ELEVATION REFERENCE
2 SECTION REFERENCE
--- MATERIALS TO BE REMOVED
EXISTING ASSEMBLIES CUT THROUGH IN PLAN OR SECTION
DIRECTION OF DOWNWARDS SLOPE
XX.X SPOT ELEVATION
BUILDINGS TO BE DEMOLISHED

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OPERATIONS ZONE
REDEVELOPMENT - PHASE
1A BUILDING DEMOLITION

drawing
dessin

COVER PAGE AND SITE PLAN

approved by
approuvé par

RM

designed by
conçu par

RM, JM, SD

drawn by
dessiné par

CL, SS

date
SEPTEMBER 2015

scale
échelle
AS NOTED

sheet no.
no. de la feuille

A-0.0



- ## GENERAL DEMOLITION NOTES
- A. FOLLOW ALL REQUIREMENTS FOR HANDLING HAZARDOUS MATERIAL. SEE DESIGNATED SUBSTANCE SPECIFICATIONS.
 - B. COMPLETELY REMOVE ENTIRE STRUCTURE.
 - C. REFER TO WASTE AUDIT FOR DEMOLITION REQUIREMENTS.
 - D. SEE MECHANICAL AND ELECTRICAL FOR REMOVALS.
 - E. PROTECT ALL LANDSCAPING AND BUILDINGS OUTSIDE OF WORK AREA.
 - F. SALVAGE ALL STRUCTURAL FRAMING MEMBERS (WALL, ROOF AND FLOOR) FROM SHED. REMOVE ALL FASTENERS AND SORT BASED ON SIZING. STORE IN AREA INDICATED BY NCC REPRESENTATIVE.

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OPERATIONS ZONE
REDEVELOPMENT - PHASE
1A BUILDING DEMOLITION


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STORAGE SHED DEMOLITION

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drawn by dessiné par	SS

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A-1.1



1 SHOP BUILDING GROUND FLOOR DEMOLITION PLAN
A-1.2 1:50

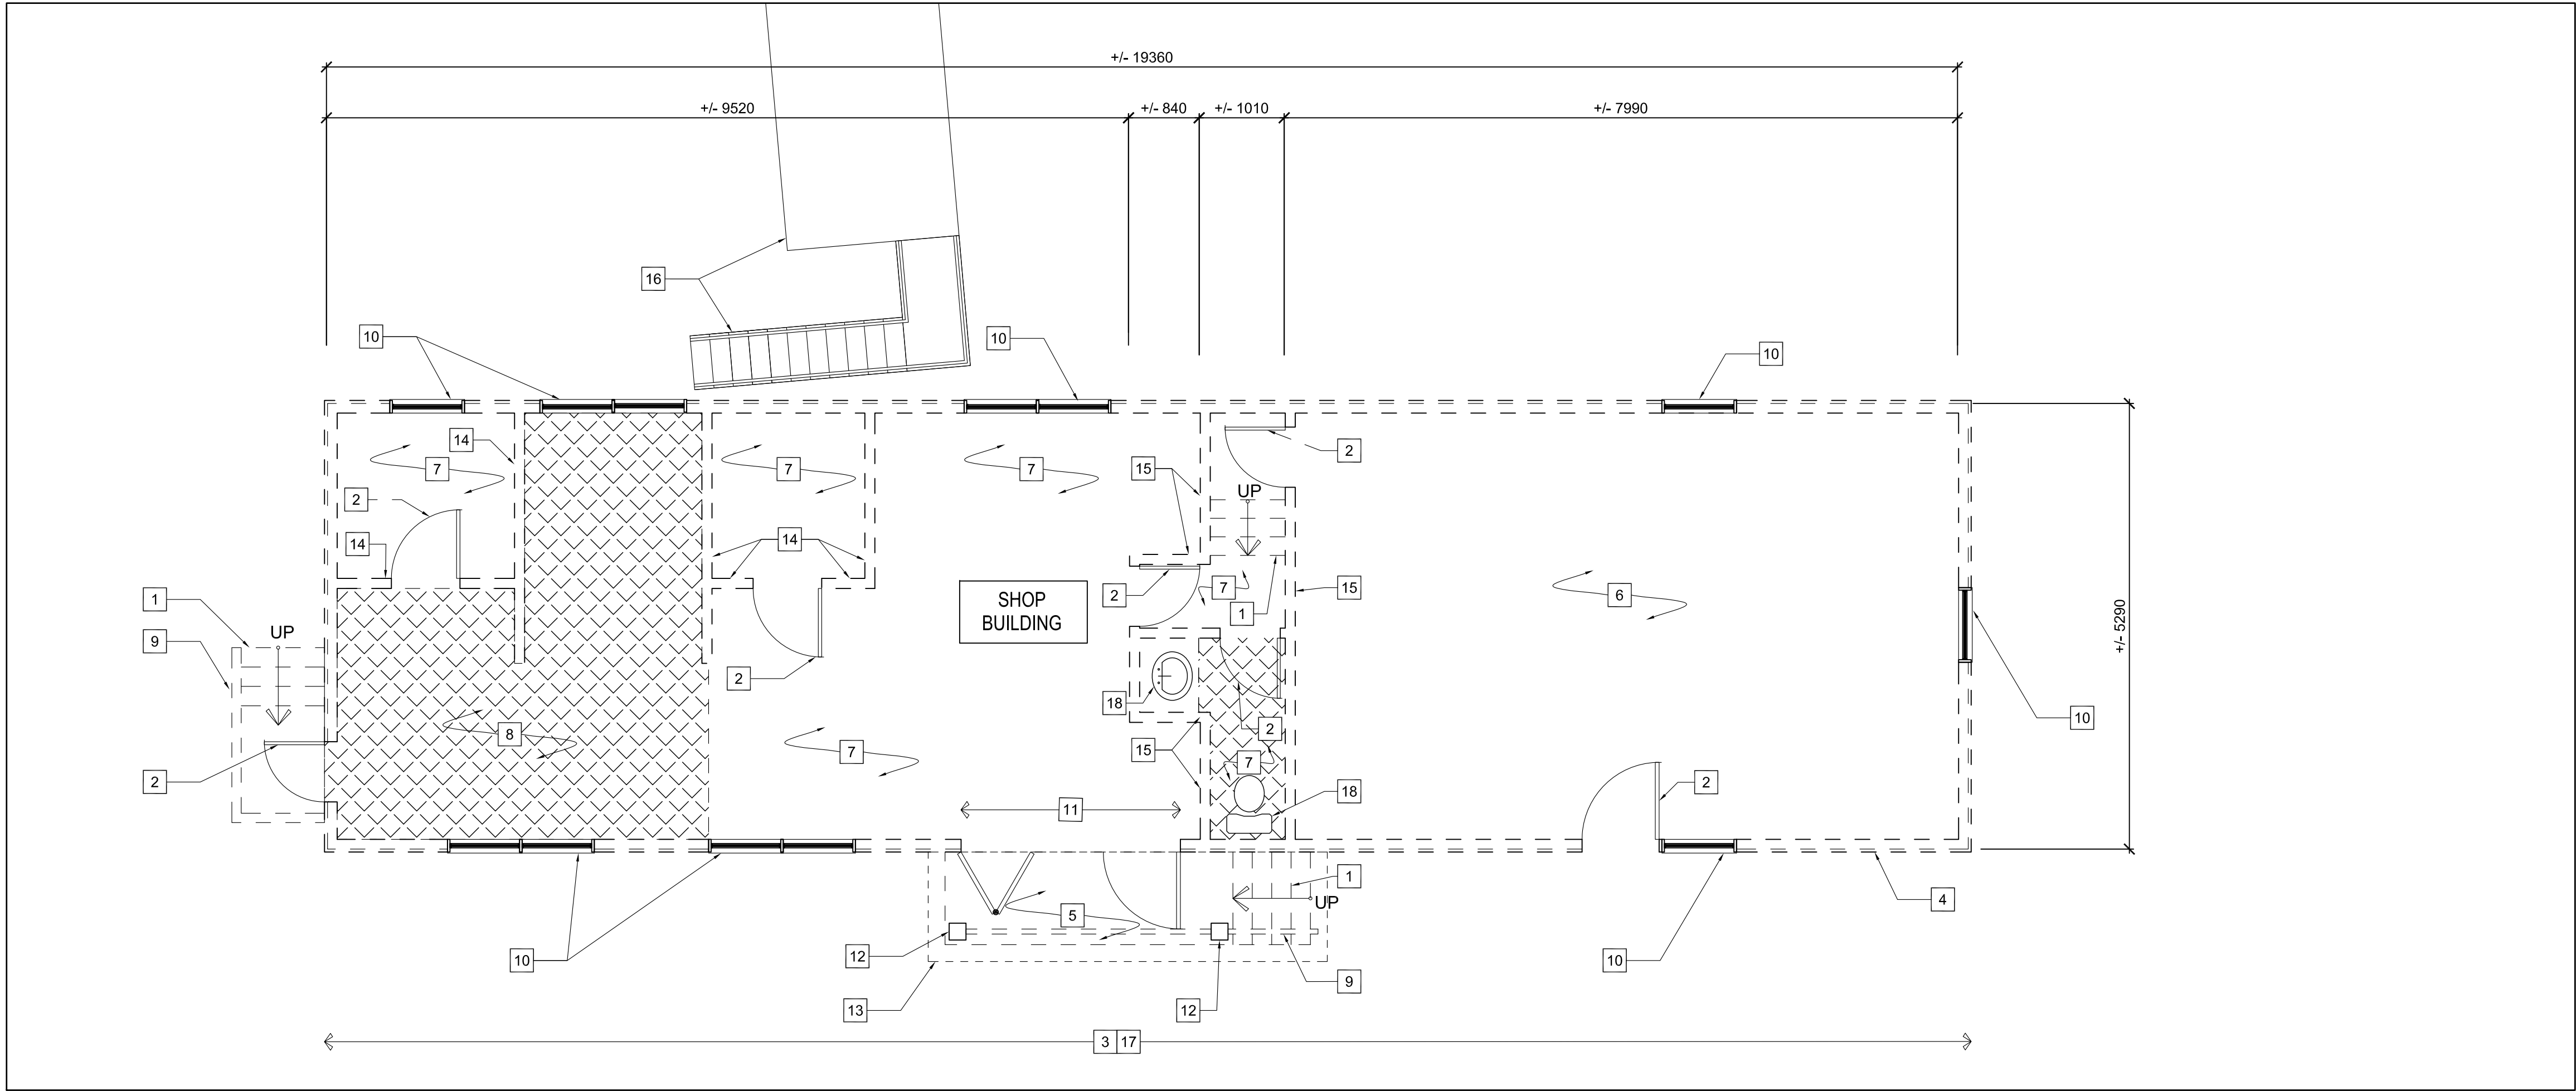

2 SHOP BUILDING - ELEVATION
A-1.2 N.T.S.




3 SHOP BUILDING - ELEVATION
A-1.2 N.T.S.



4 SHOP BUILDING - ELEVATION
A-1.2 N.T.S.



5 SHOP BUILDING - ELEVATION
A-1.2 N.T.S.

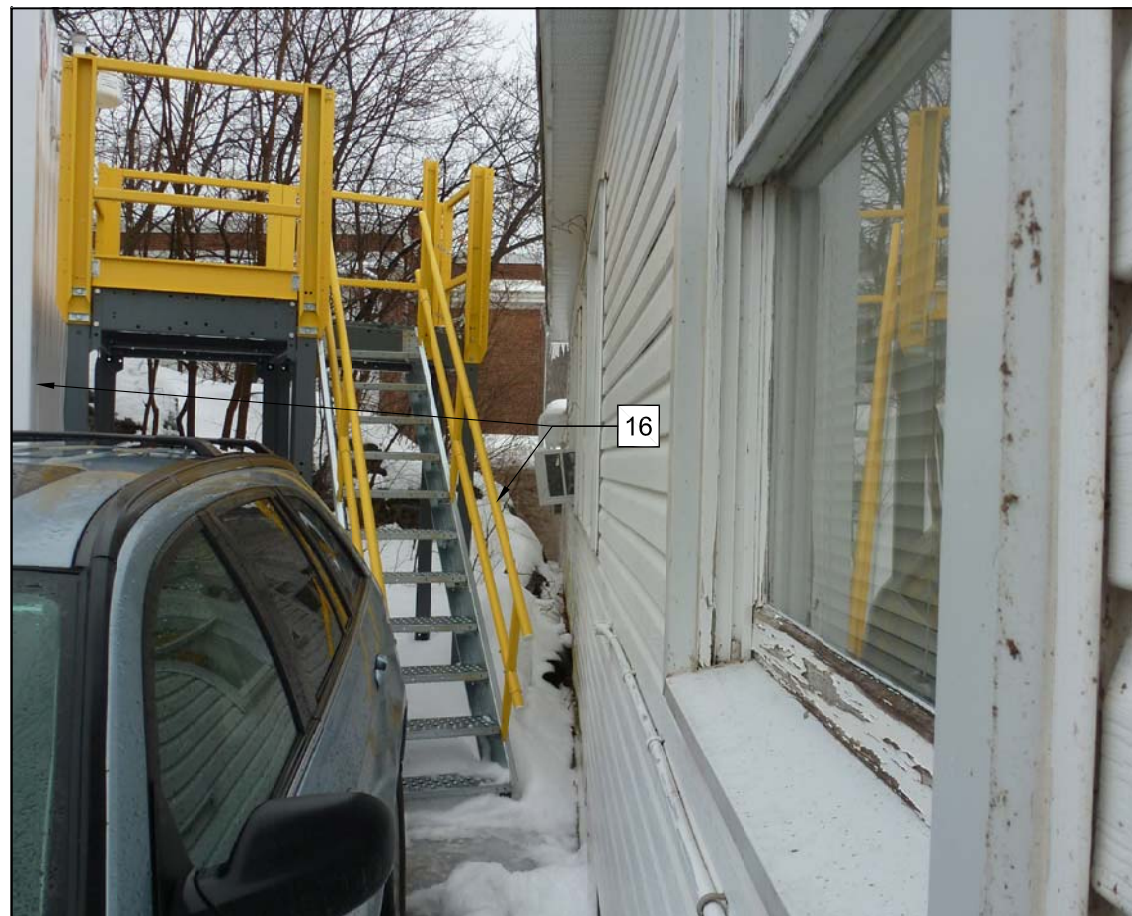

6 SHOP BUILDING - ELEVATION
A-1.2 N.T.S.



7 SHOP BUILDING - FOUNDATION
A-1.2 N.T.S.



8 SHOP BUILDING - INTERIOR VIEW
A-1.2 N.T.S.

NOTES

- 1 REMOVE WOOD STEPS.
- 2 REMOVE WOOD DOOR AND FRAME.
- 3 REMOVE WOOD STRUCTURE ON CONCRETE PIERS APPROXIMATELY 200mm X 200mm X 1800mm DEPTH.
- 4 VINYL SIDING ON TOP OF WOOD SIDING
REMOVE ALL CLADDING.
- 5 REMOVE WOOD PORCH.
- 6 REMOVE ALL INTERIOR ROOM FINISHES INCLUDING:
 - PLYWOOD CEILING
 - INSULATION
 - WALLS GYPSUM
 - VINYL SHEET FLOORING ON WOOD DECK AND WOOD JOISTS.
- 7 REMOVE ALL INTERIOR ROOM FINISHES INCLUDING:
 - CARPET FLOORING
 - WALLS GYPSUM
 - ELECTRICAL HEAT
 - WOOD BASEBOARDS
 - CEILING MOUNTED, FLUORESCENT LIGHT FIXTURES W/ SURFACE MOUNTED ELECTRICAL.
- 8 HATCHED AREA VINYL TILE FLOORING TO BE REMOVED.
- 9 REMOVE WOOD GUARD RAIL.
- 10 REMOVE WOOD WINDOW.
- 11 REMOVE TRIPLE DOOR W/ BI-FOLD PANEL.
- 12 REMOVE WOOD POST SUPPORTING AWNING STRUCTURE.
- 13 REMOVE WOOD AWNING.
- 14 REMOVE INTERIOR PARTITION WALLS, FREE STANDING.
- 15 REMOVE INTERIOR PARTITION TO U/S OF ROOF JOISTS.
- 16 EXISTING STAIRCASE AND GENERATOR.
- 17 REMOVE ROOF STRUCTURE ABOVE.
- 18 REMOVE LAVATORY AND WATER CLOSET.
- 19 TYPICAL, REMOVE CONCRETE PIER FOUNDATION.


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1A BUILDING DEMOLITION

GENERAL DEMOLITION NOTES


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- D. SEE MECHANICAL AND ELECTRICAL FOR REMOVALS.
- E. PROTECT ALL LANDSCAPING AND BUILDINGS OUTSIDE OF WORK AREA.

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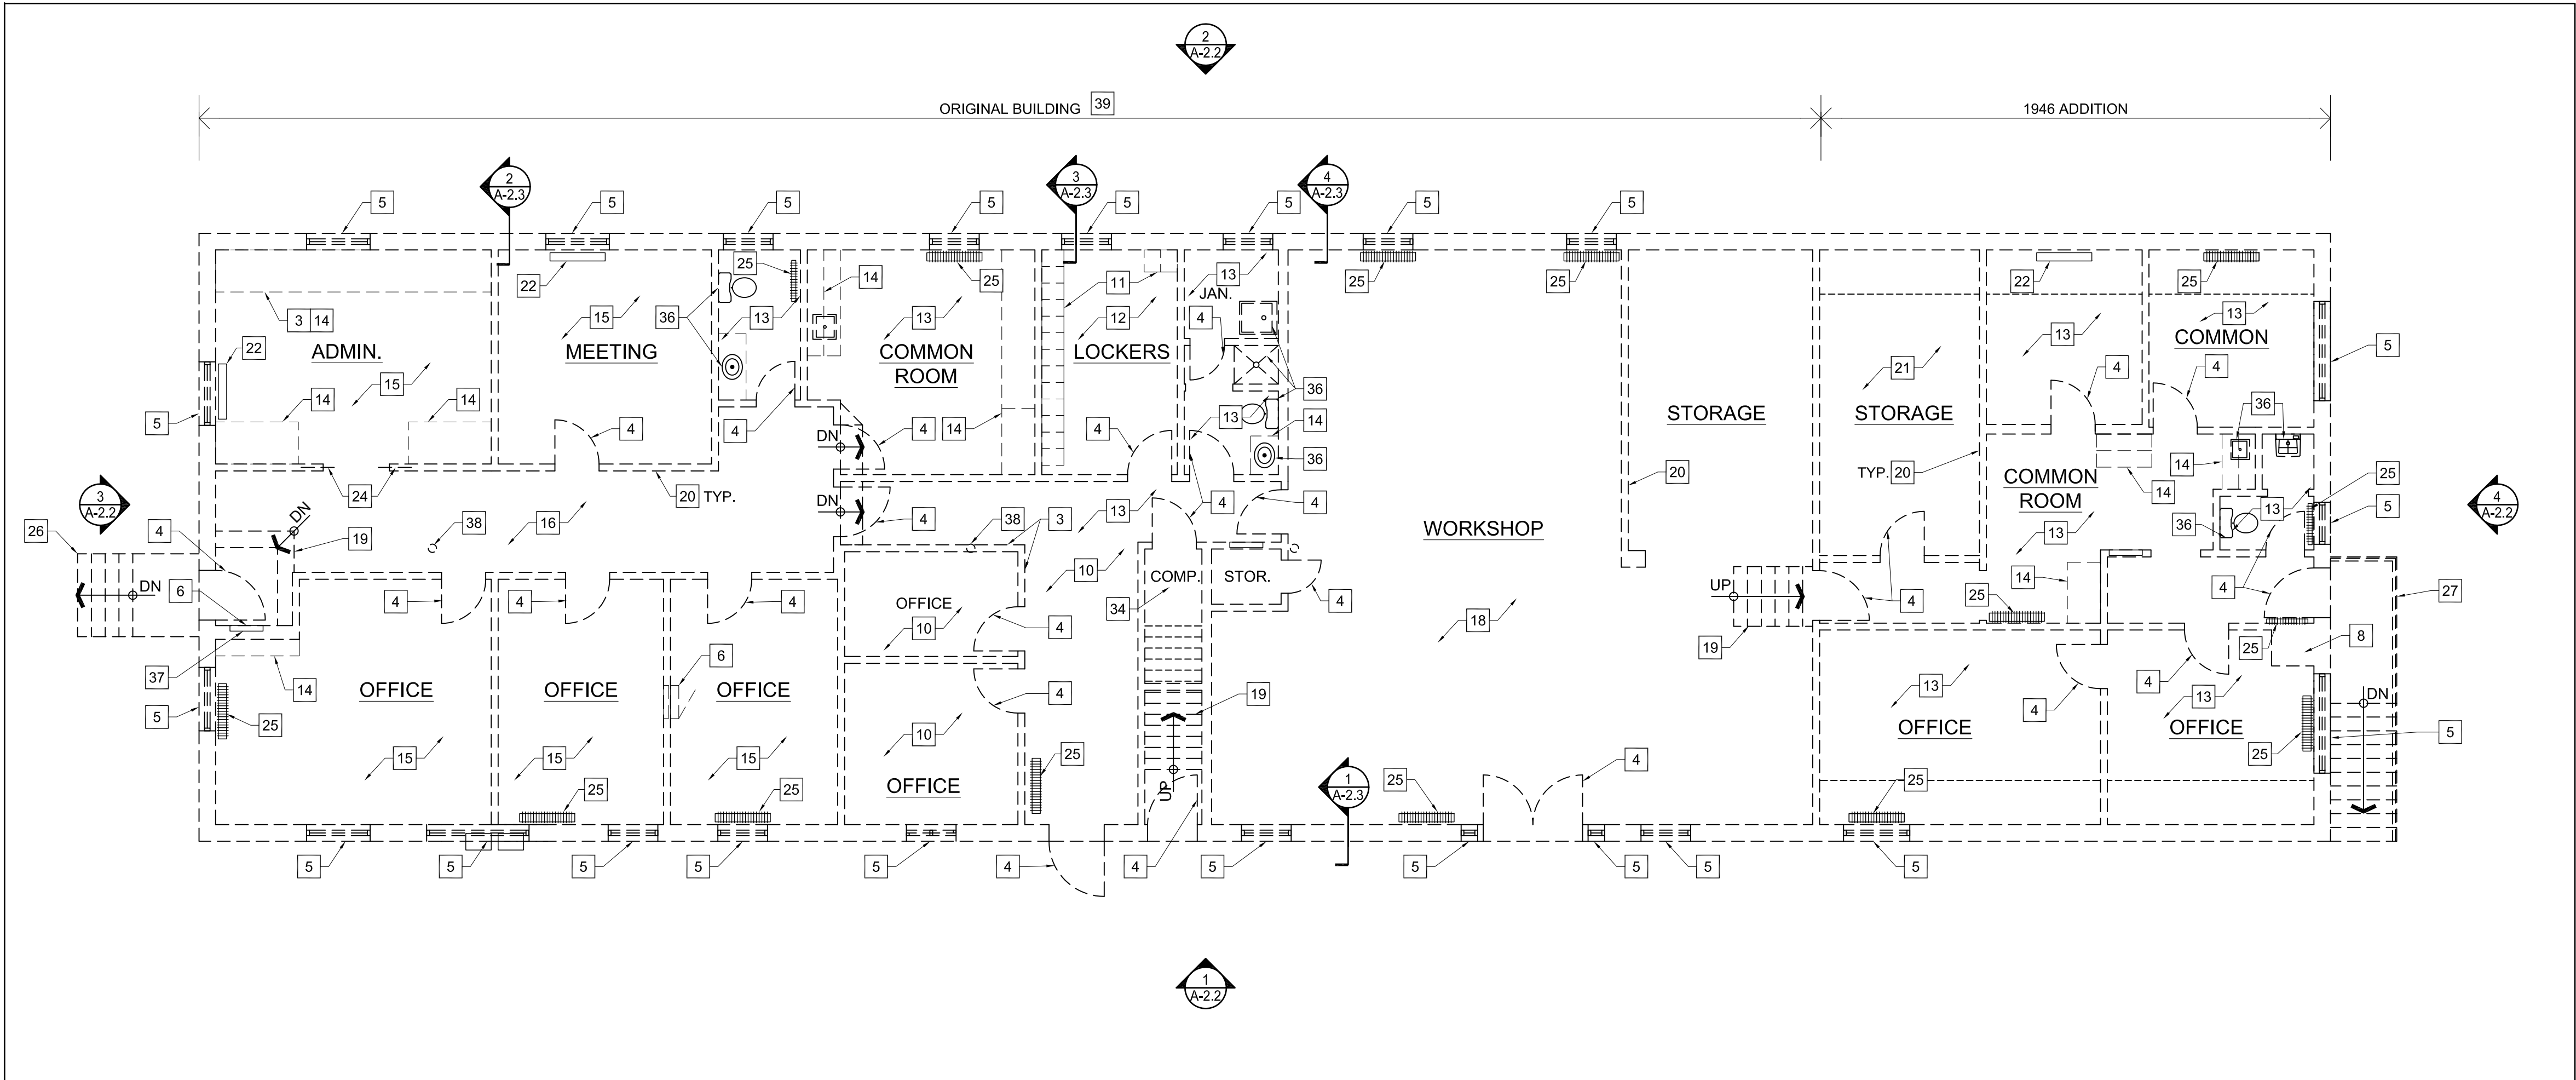
SHOP BUILDING
DEMOLITION

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A-1.2

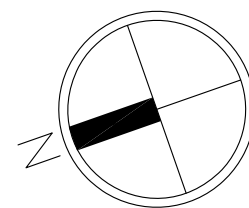

1 BASEMENT DEMOLITION PLAN
A-2.0 1:75

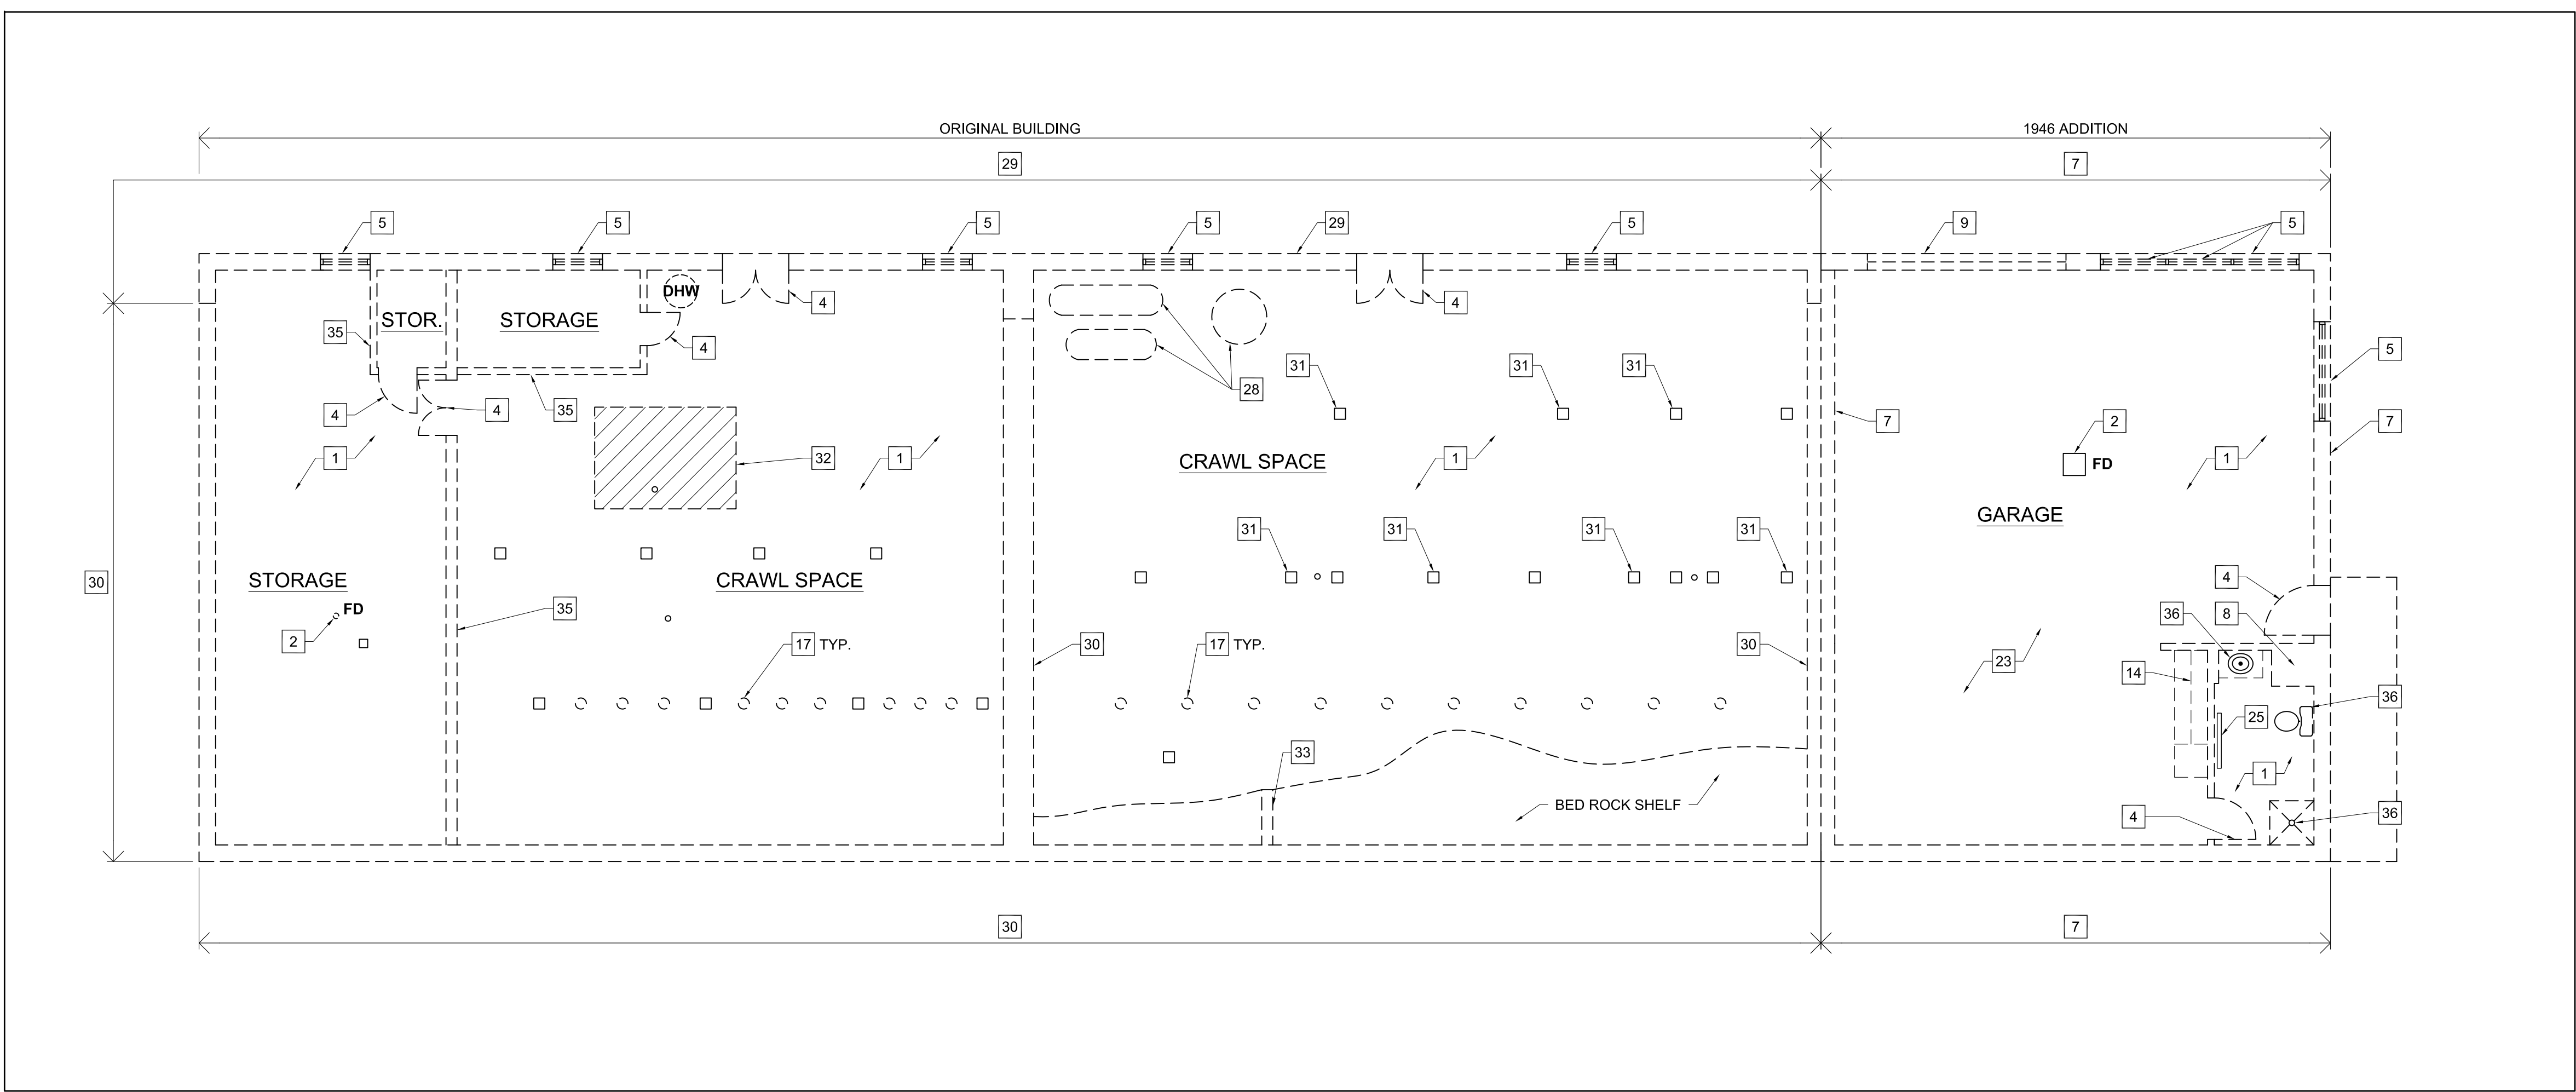

2 LEVEL 1 DEMOLITION PLAN
A-2.0 1:75

DRAWING NOTES

- 1 REMOVE SLAB ON GRADE.
- 2 REMOVE FLOOR DRAIN AND ASSOCIATED PIPING. REFER TO MECHANICAL DRAWINGS.
- 3 REMOVE VINYL PARTITION WALL.
- 4 REMOVE DOOR AND FRAME.
- 5 REMOVE WINDOW AND FRAME.
- 6 REMOVE ELECTRICAL SERVICE. REFER TO ELECTRICAL DRAWINGS.
- 7 REMOVE CONCRETE BLOCK FOUNDATION AND FOOTINGS.
- 8 REMOVE BRICK CHIMNEY.
- 9 REMOVE GARAGE DOOR AND FRAME.
- 10 REMOVE ROOM FINISHES
-ACOUSTICAL SUSPENDED CEILING
-VINYL SHEET FLOORING
- 11 REMOVE LOCKERS.
- 12 REMOVE ROOM FINISHES
-GYPSUM BOARD WALLS AND CEILING
-CARPET FLOORING
- 13 REMOVE ROOM FINISHES
-SHEET FLOORING
-GYPSUM BOARD WALLS AND CEILING
- 14 REMOVE MILLWORK.
- 15 REMOVE ROOM FINISHES
-WALL WOOD PANELS
-CARPET FLOORING
-300 x 300 ACOUSTIC CEILING TILE
- 16 REMOVE ROOM FINISHES
-WALL WOOD PANELS
-SHEET FLOORING
-DROP CEILING: 300 x 300 ACOUSTIC CEILING TILE
- 17 REMOVE TEMPORARY SHORING POSTS. HAND OVER ALL POSTS TO CLIENT.
- 18 REMOVE ROOM FINISHES
-PLYWOOD FLOORING
-GYPSUM BOARD CEILING AND WALLS
- 19 REMOVE WOOD STAIRS.
- 20 REMOVE INTERIOR WOOD STUD WALL AND GYPSUM BOARD.
- 21 REMOVE ROOM FINISHES
-WOOD STUD FRAMING
-GYPSUM CEILING
-PLYWOOD FLOORING
- 22 REMOVE RADIATOR.
- 23 REMOVE OPEN WEB STEEL JOIST AND CONCRETE SLAB ABOVE.
- 24 REMOVE SLIDING POCKET DOORS AND FRAME.
- 25 PROPERLY UNINSTALL CAST IRON RADIATOR AND RETURN TO CLIENT.
- 26 REMOVE CONCRETE STAIRS AND METAL HANDRAIL.
- 27 REMOVE WOOD STAIRS AND HANDRAILS.
- 28 COMPRESSORS TO BE REMOVED BY OTHERS.
- 29 REMOVE REPOURED CONCRETE WALL.
- 30 REMOVE STONE FOUNDATION WALL.
- 31 REMOVE CONCRETE BLOCK PIER.
- 32 AREA OF MECHANICAL PIPING, VALVES AND MOTORS FOR HEATING SYSTEM. REFER TO MECH. DRAWING.
- 33 REMOVE CONCRETE BUTTRESS WALL.
- 34 COMMUNICATION AND NETWORK SERVICES TO BE REMOVED BY OTHER.
- 35 REMOVE WOOD STUD WALL.
- 36 REMOVE FIXTURES. SEE MECH.
- 37 RESERVED.
- 38 REMOVE STEEL COLUMN.
- 39 CAREFULLY REMOVE 75mm x 254mm (3"x10") FLOOR JOISTS AND HAND OVER TO CLIENT.

DRAWING NOTES

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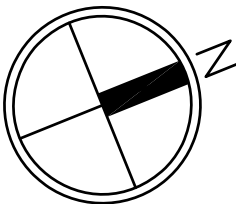
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1A BUILDING DEMOLITION

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SITE OFFICE BUILDING
BASEMENT AND LEVEL 1
DEMOLITION PLAN

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RM, JM, SD

drawn by
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JG, CL

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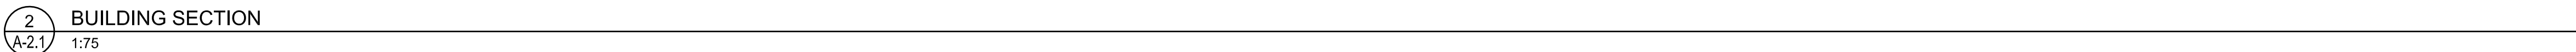
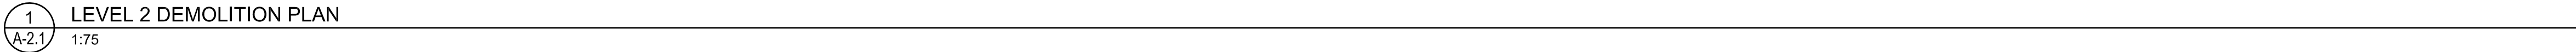
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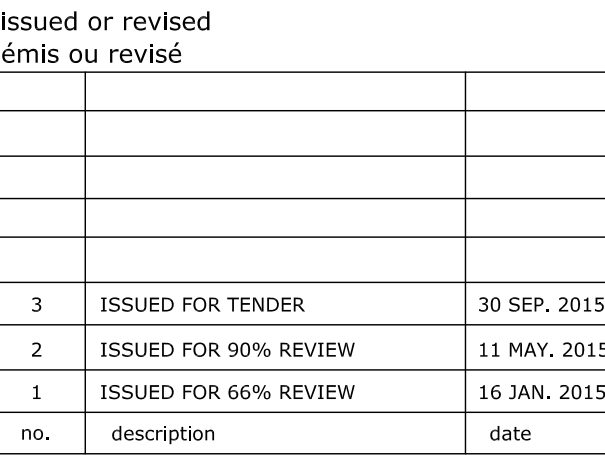
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A-2.0




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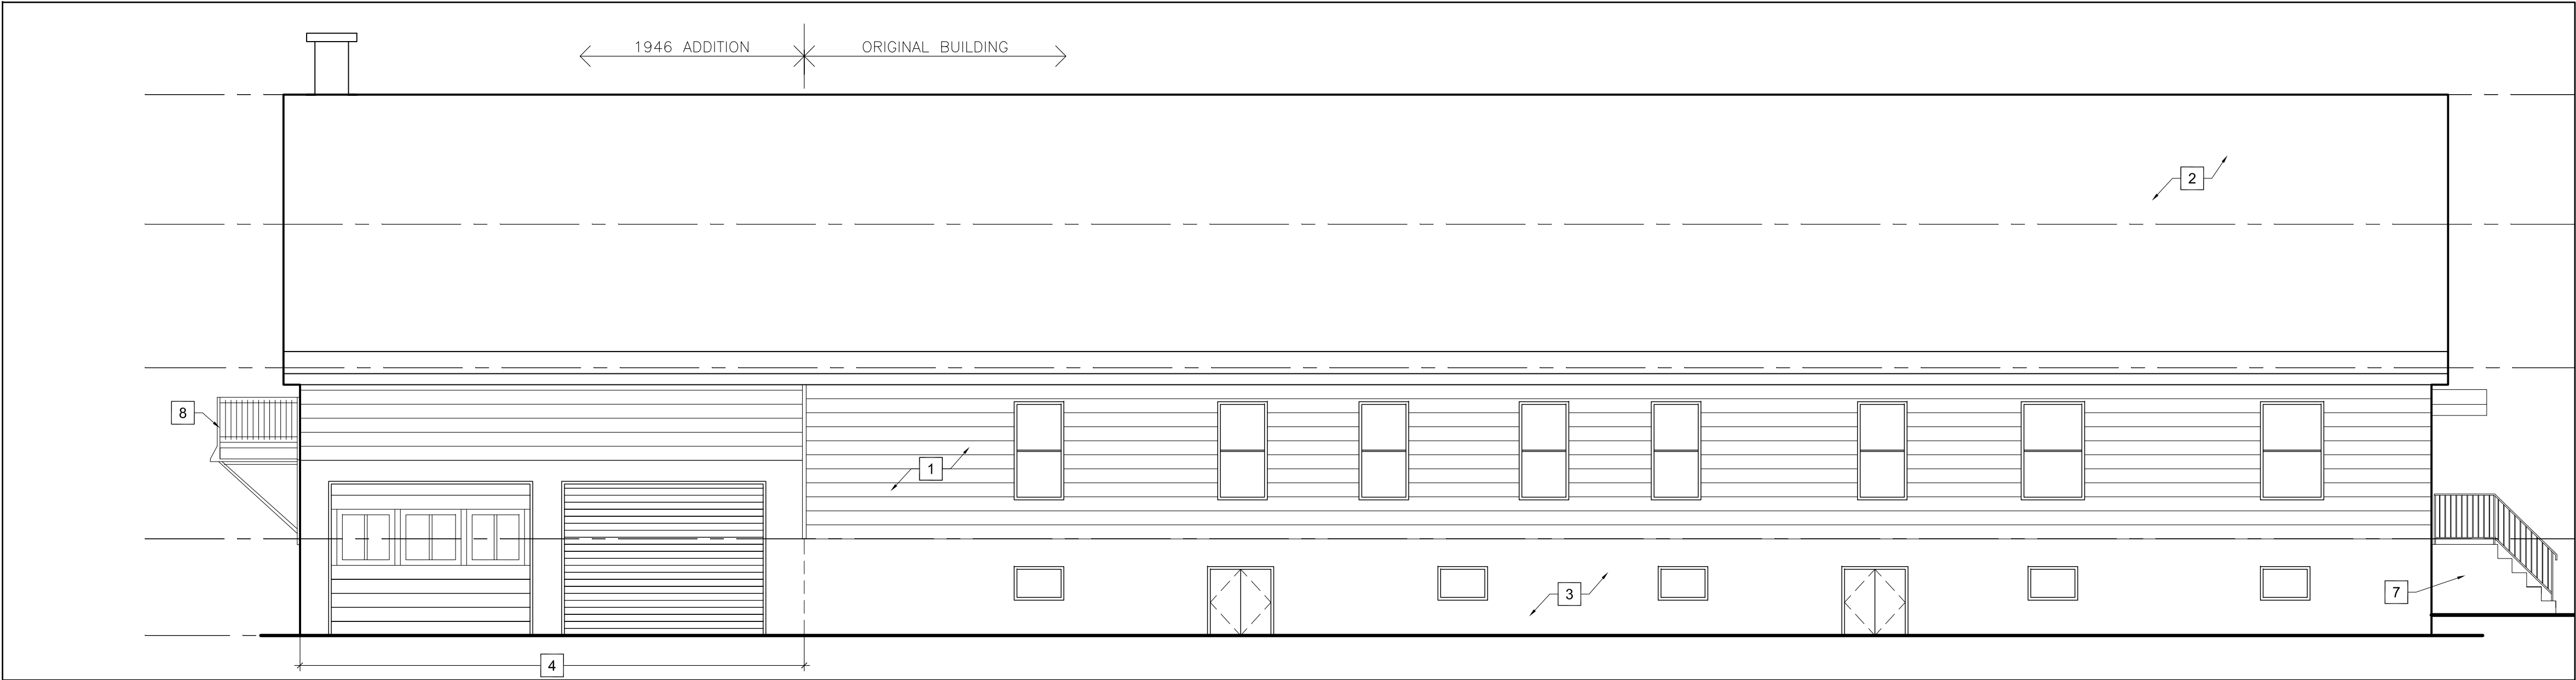
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- | DRAWING NOTES | |
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| D. | SEE MECHANICAL AND ELECTRICAL FOR REMOVALS. |
| E. | PROTECT ALL LANDSCAPING AND BUILDINGS OUTSIDE OF WORK AREA. |



1 EAST ELEVATION
A-2.2 1:75



2 WEST ELEVATION
A-2.2 1:75

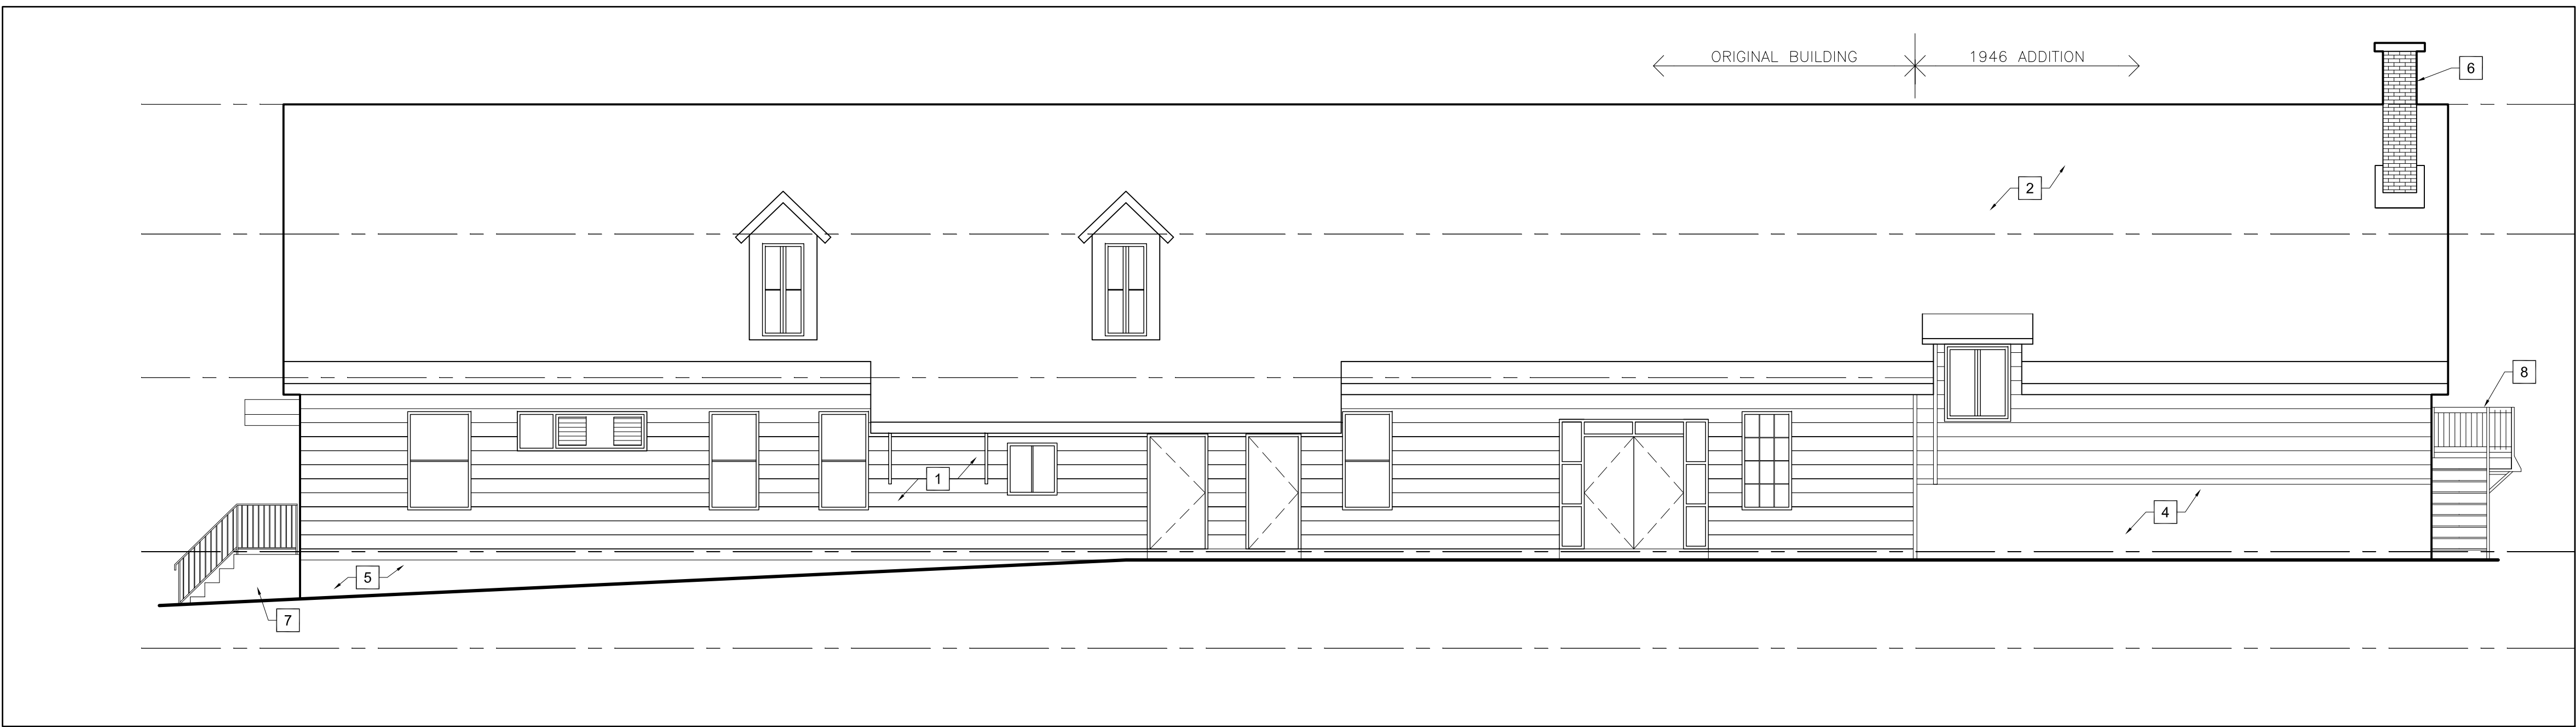

3 SOUTH ELEVATION
A-2.2 1:75



4 NORTH ELEVATION
A-2.2 1:75

DRAWING NOTES

- 1 MASONITE SIDING OVER STRAPPING AND ORIGINAL WOOD SIDING. REFER TO DRAWING A-2.3 FOR WALL COMPOSITION.
- 2 REMOVE ROOF STRUCTURE AND ASPHALT SHINGLES.
- 3 CONCRETE FOUNDATION.
- 4 PARGED CONCRETE BLOCK FOUNDATION.
- 5 PARGED STONE FOUNDATION.
- 6 REMOVE BRICK CHIMNEY.
- 7 CONCRETE STEPS AND METAL HANDRAIL.
- 8 WOOD STAIRS.

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EXTERIOR ELEVATIONS

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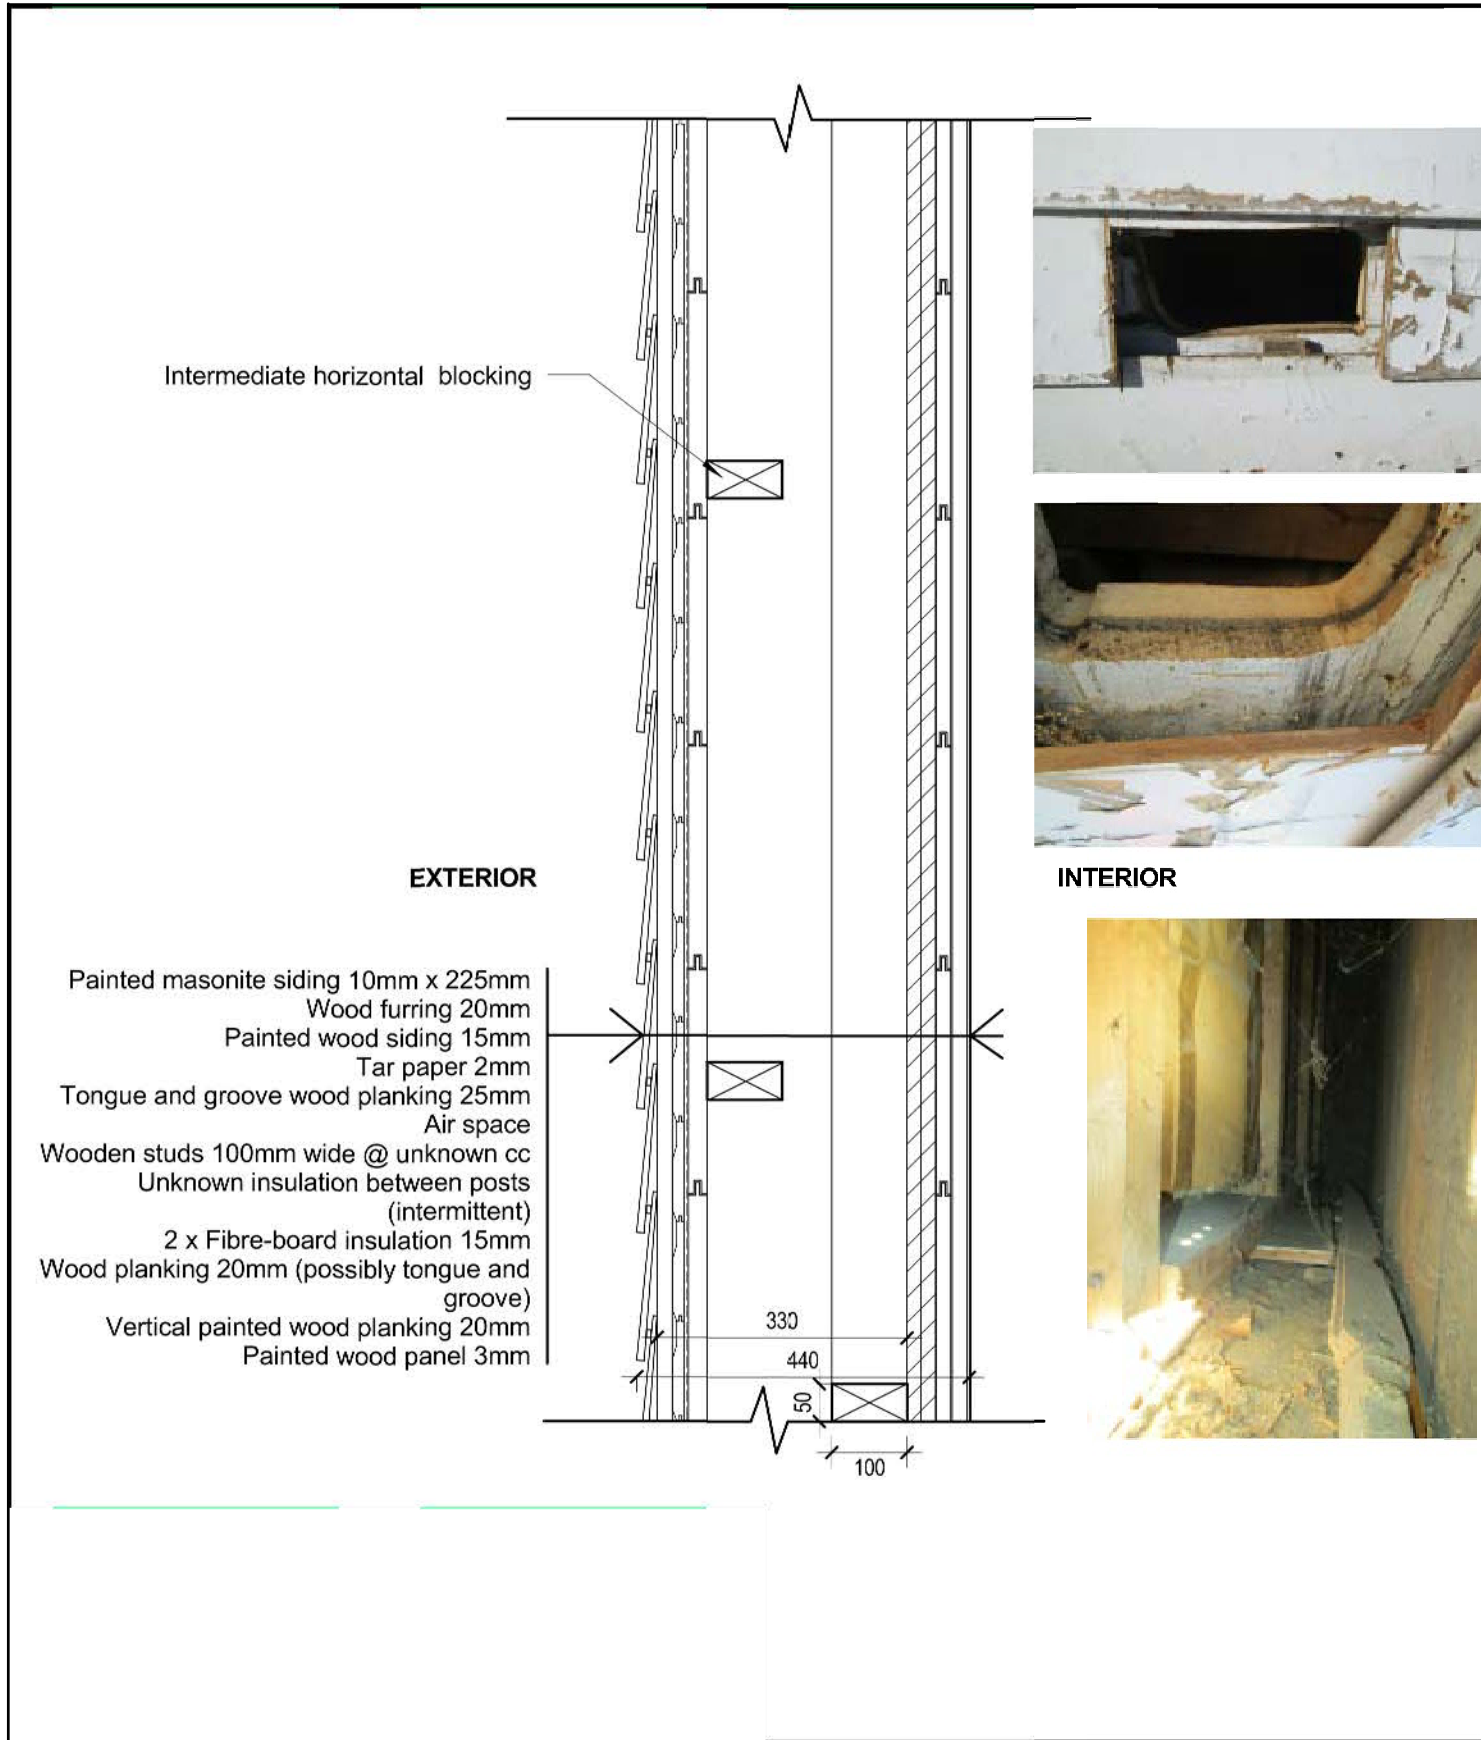
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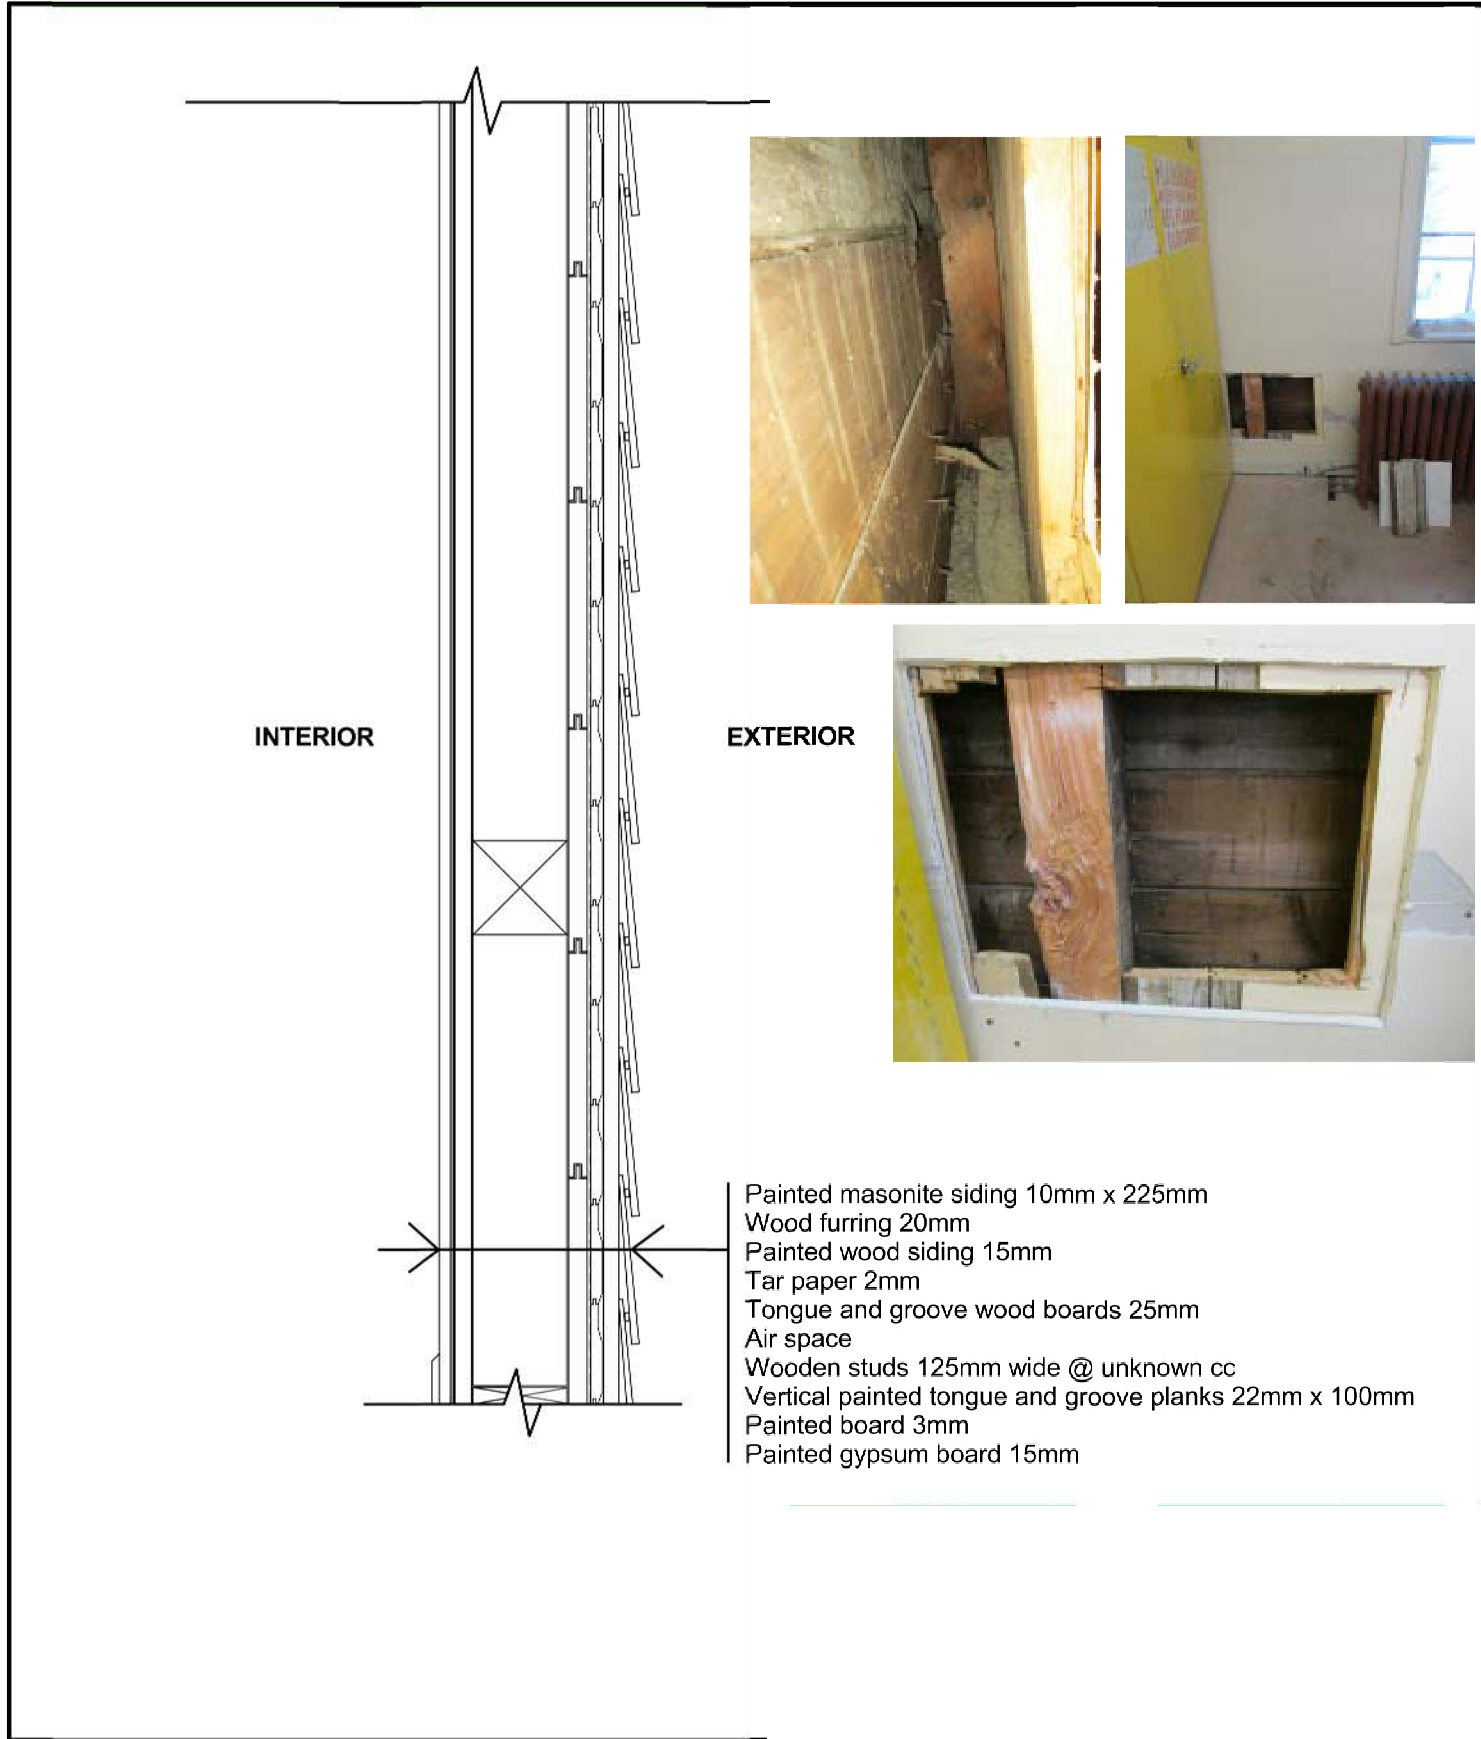
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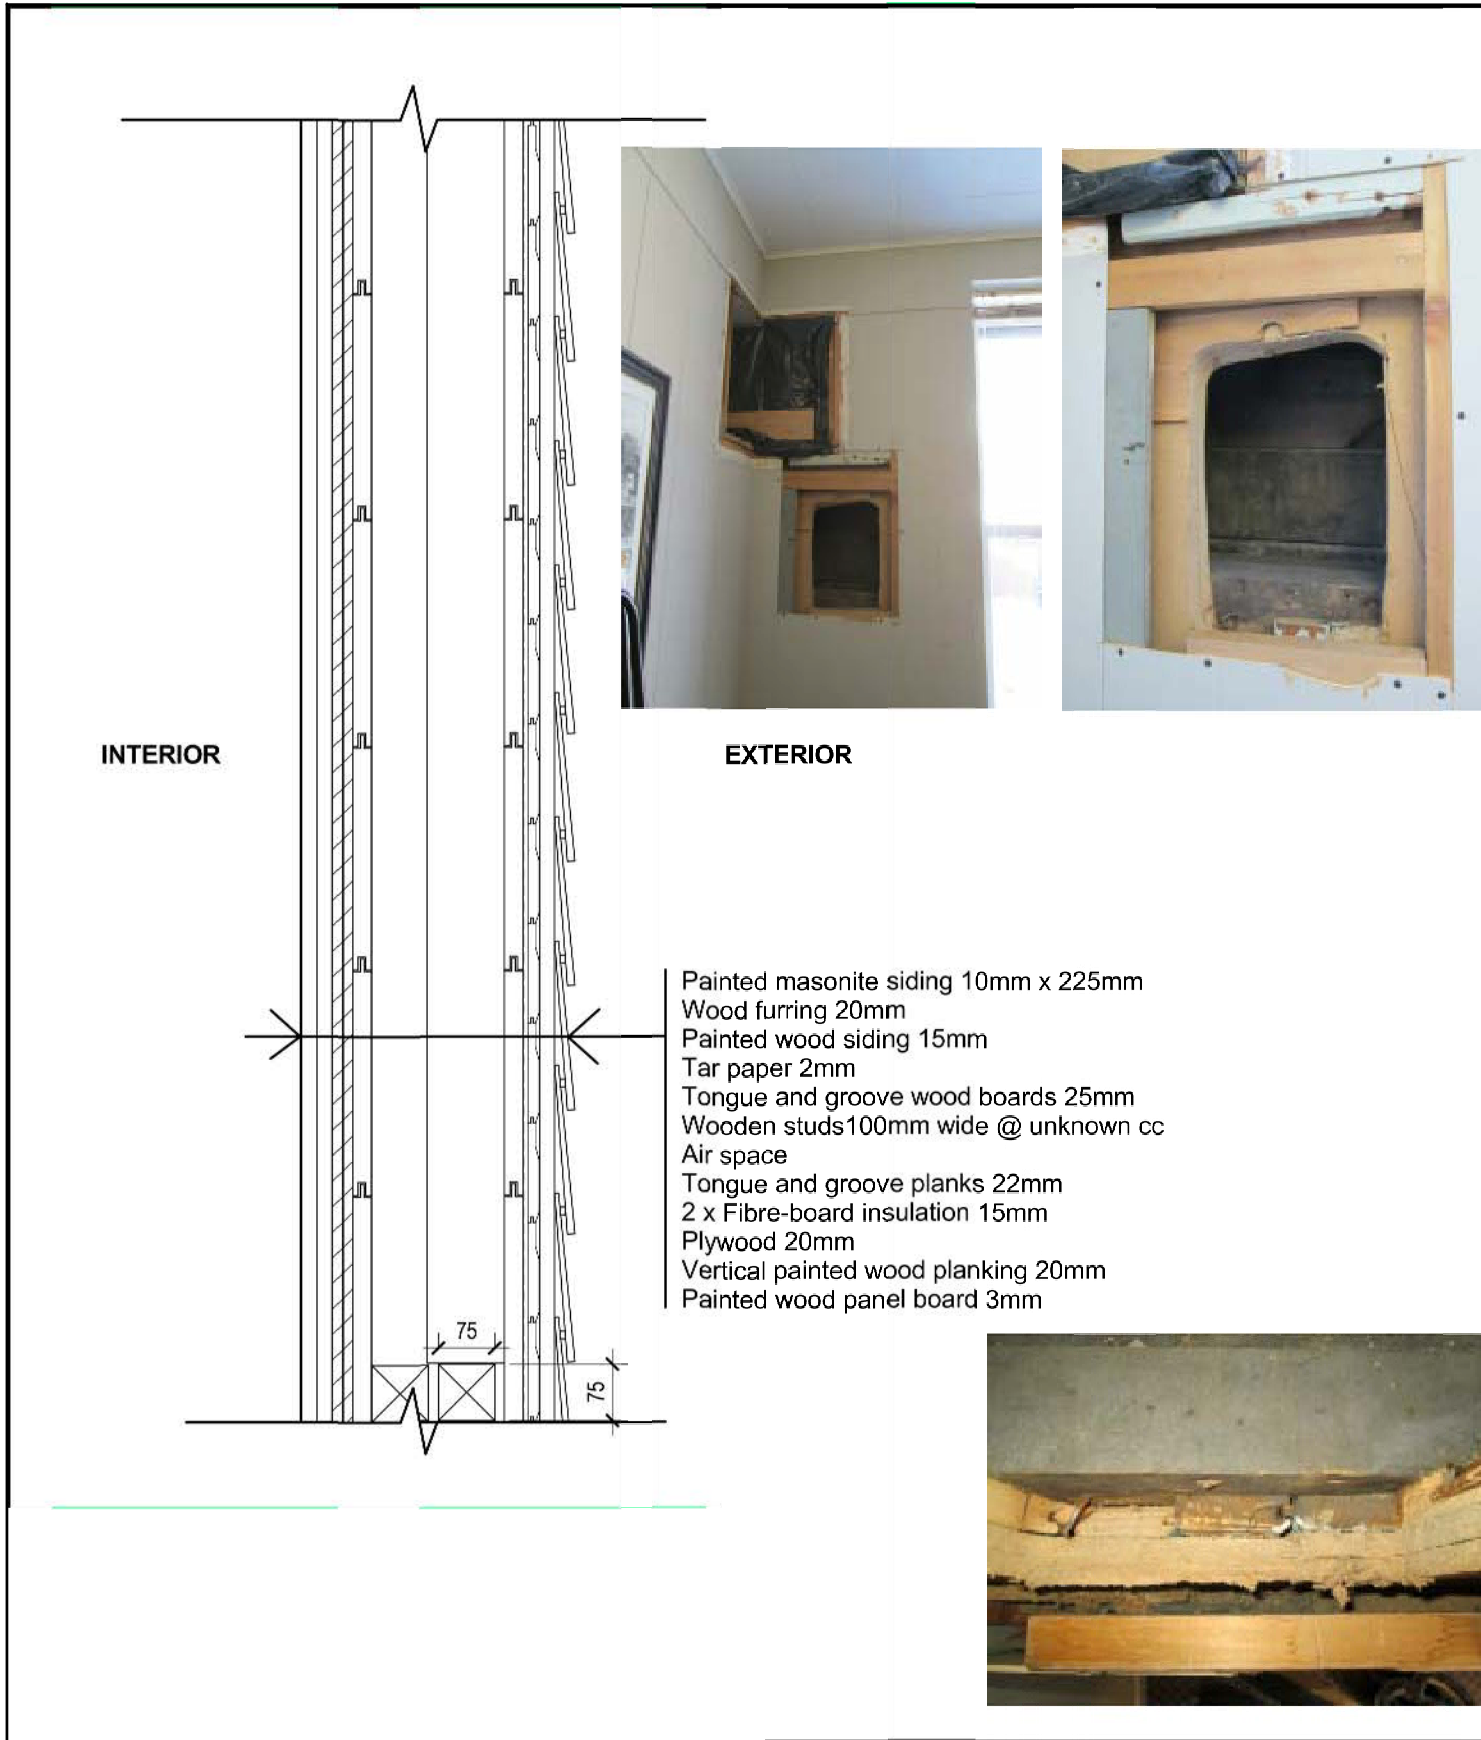
A-2.2




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OPENING 2
1:10




4
A-2.3
OPENING 5
1:10



2
A-2.3
OPENING 3
1:10

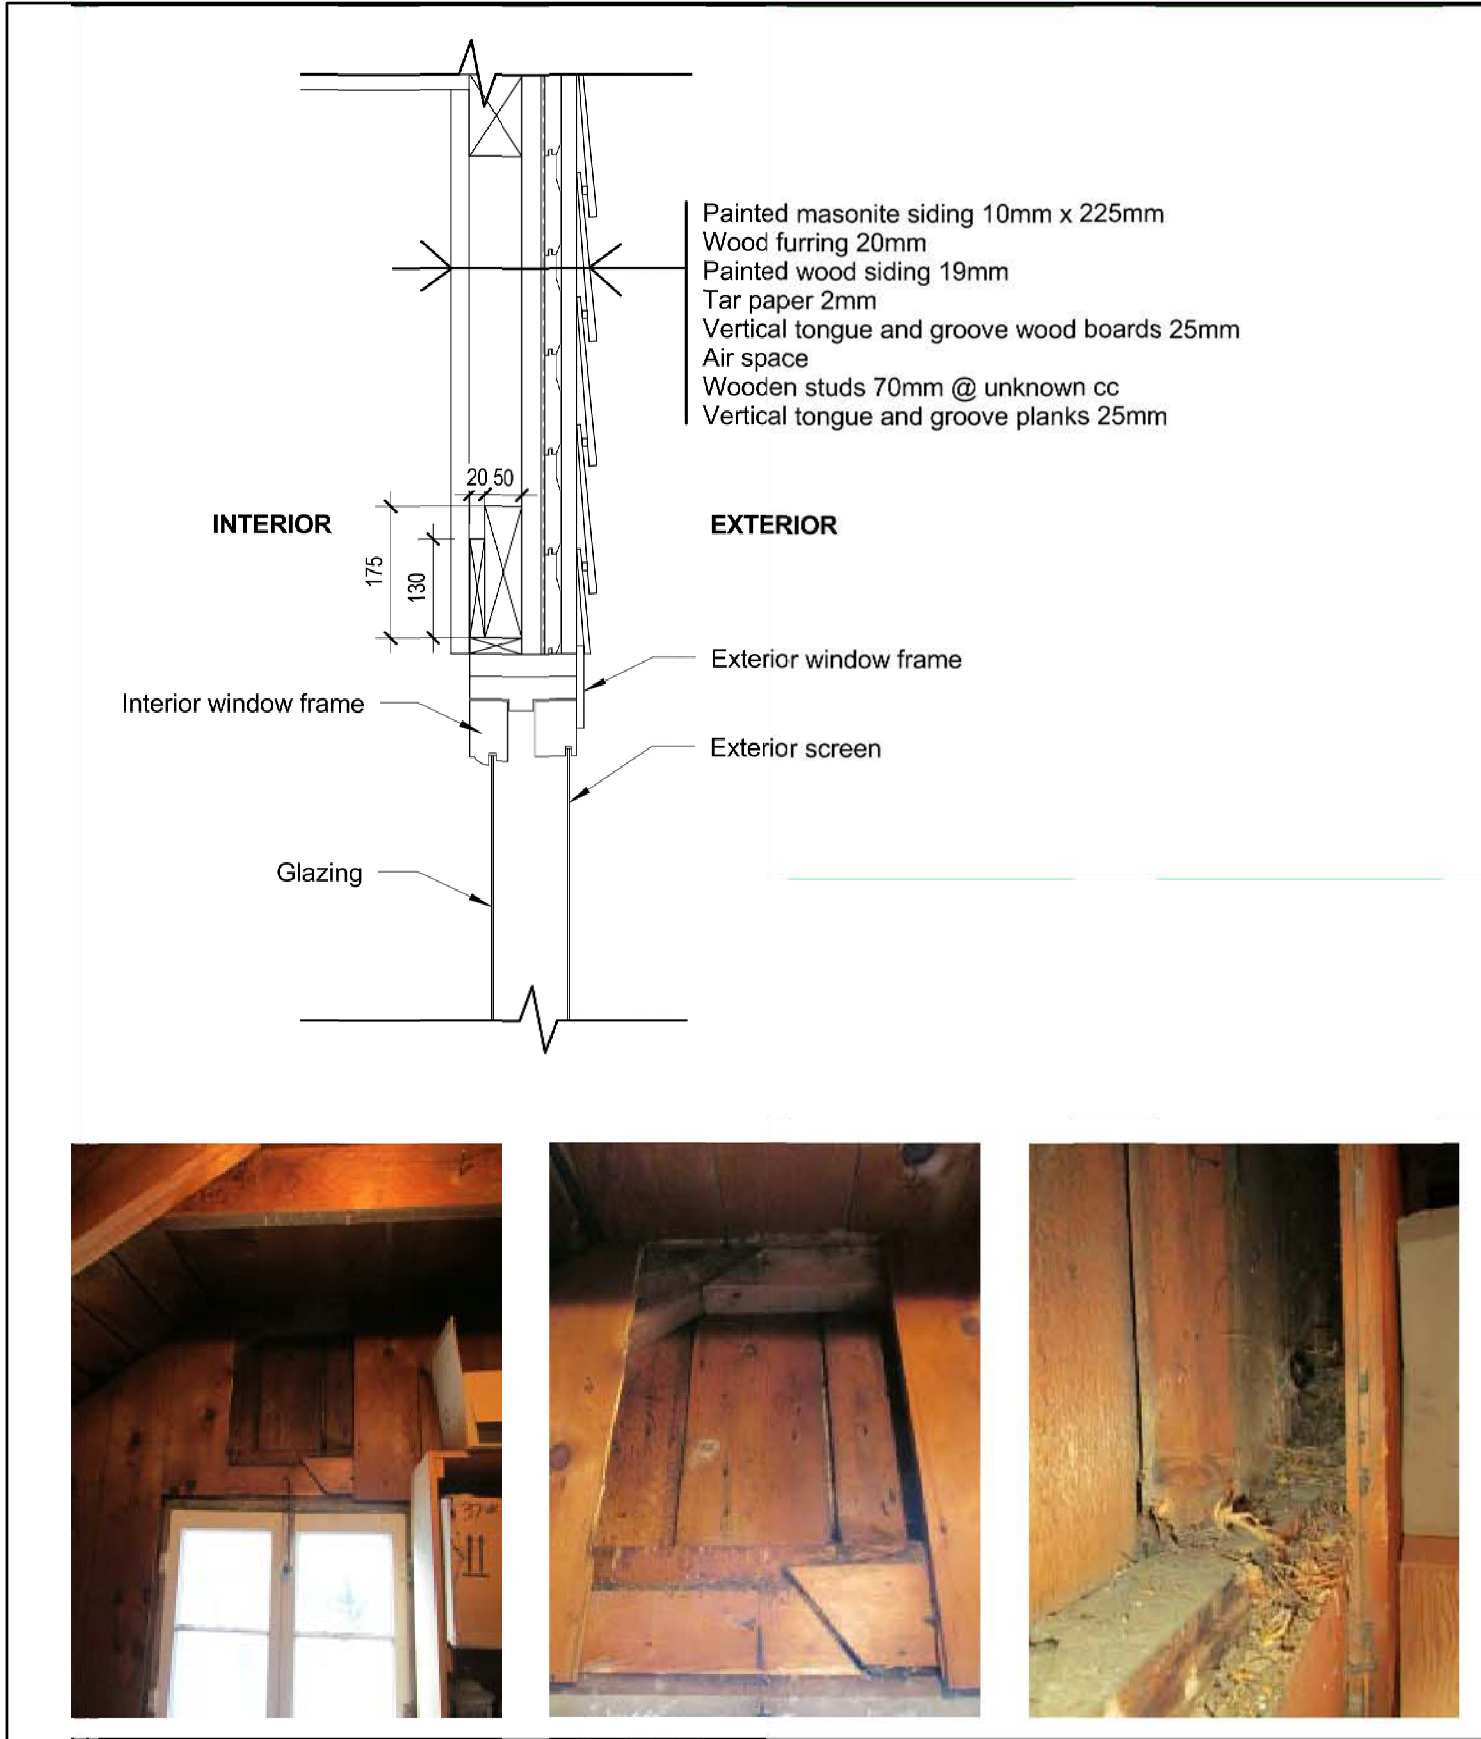

5
A-2.3
OPENING 6
1:10

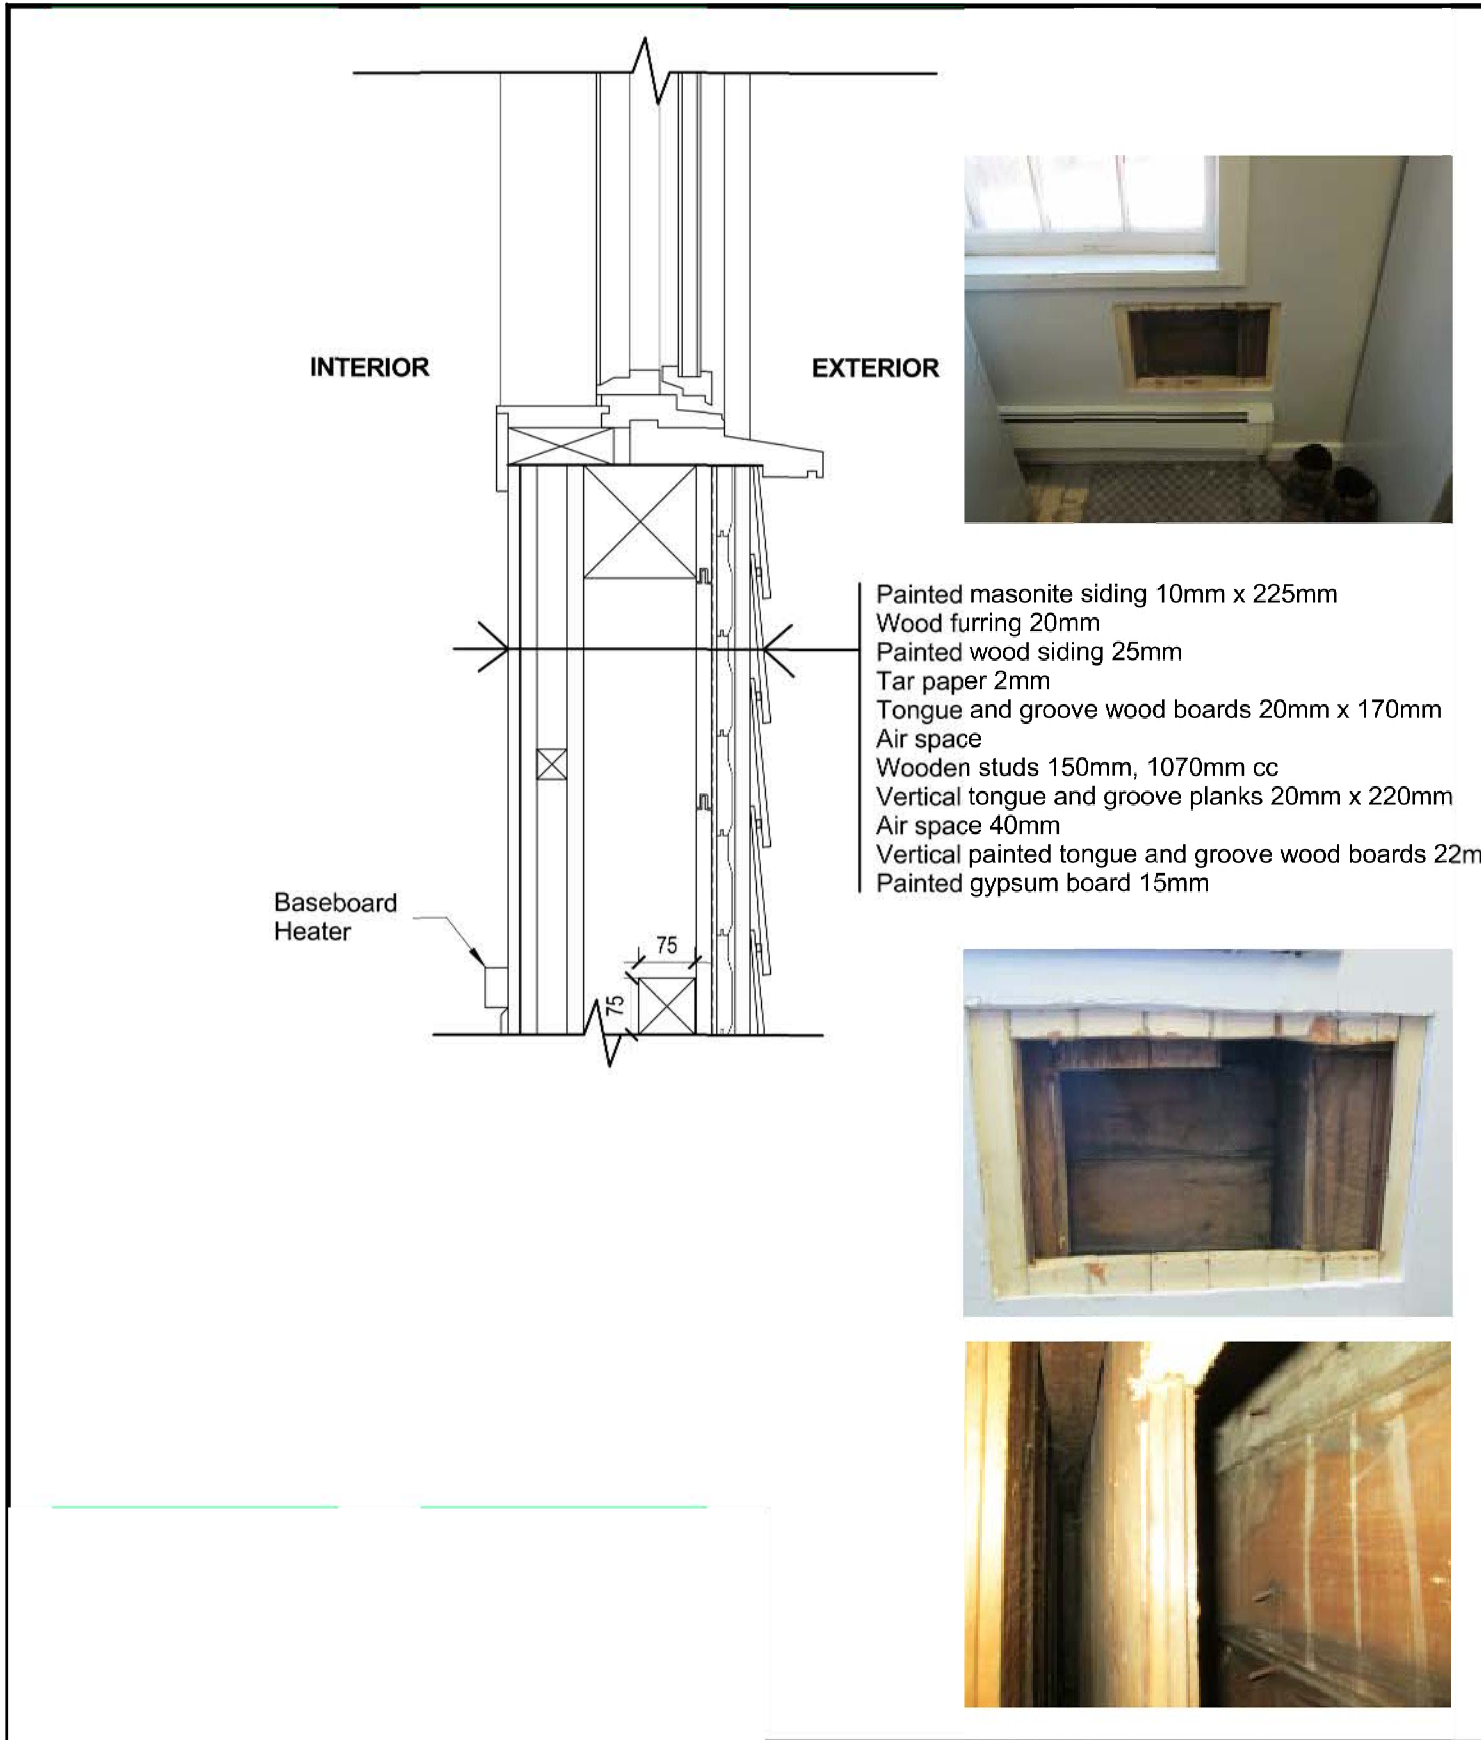

3
A-2.3
OPENING 4
1:10

TEST OPENING AND WALL SECTION INFORMATION COURTESY OF **OWNER ARCHIVES**, FROM "BUILDING CONDITION ENVELOPE REPORT" BY DFS ARCHITECTURE AND DESIGN BASED 28 MARCH 2013.

- DRAWING NOTES
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SITE OFFICE BUILDING
WALL SECTION INFORMATION

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dessiné par JG, CL

date SEPTEMBER 2015 scale
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A-2.3

AREA OF WORK

GARAGE

SHED

SITE OFFICE

SHOP

REMOVE EXISTING SANITARY, HOT
AND COLD WATER PIPING TO
SEAMSTRESS BUILDING FED
FROM SITE OFFICE.

GENERAL NOTES:

1. CONTRACTOR TO COORDINATE AND PAY FOR
LOCATES OF ALL SERVICES PRIOR TO
COMMENCEMENT OF WORK.

2. CONTRACTOR TO PAY FOR DOCUMENTATION
FOR INVERTS TO ALL EXISTING SERVICES THAT
ARE BEING CONNECTED TO.

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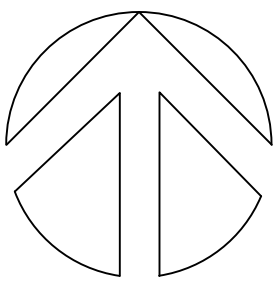


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PROJECT NORTH



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émis ou révisé

3	ISSUED FOR TENDER	2015-09-30
2	ISSUED FOR 100% REVIEW	2015-09-14
1	ISSUED FOR 90% REVIEW	2015-05-08
0	ISSUED FOR 66% REVIEW	2015-01-16
no.	description	date

project
projet

PHASE 1A BUILDING
DEMOLITION AND SITE
REMEDICATION

drawing
dessin

MECHANICAL SITE PLAN

approved by
approuvé par M.L.


designed by
conçu par J.R.M.

drawn by
dessiné par J.R.M.


date

scale
échelle 1:250

M100

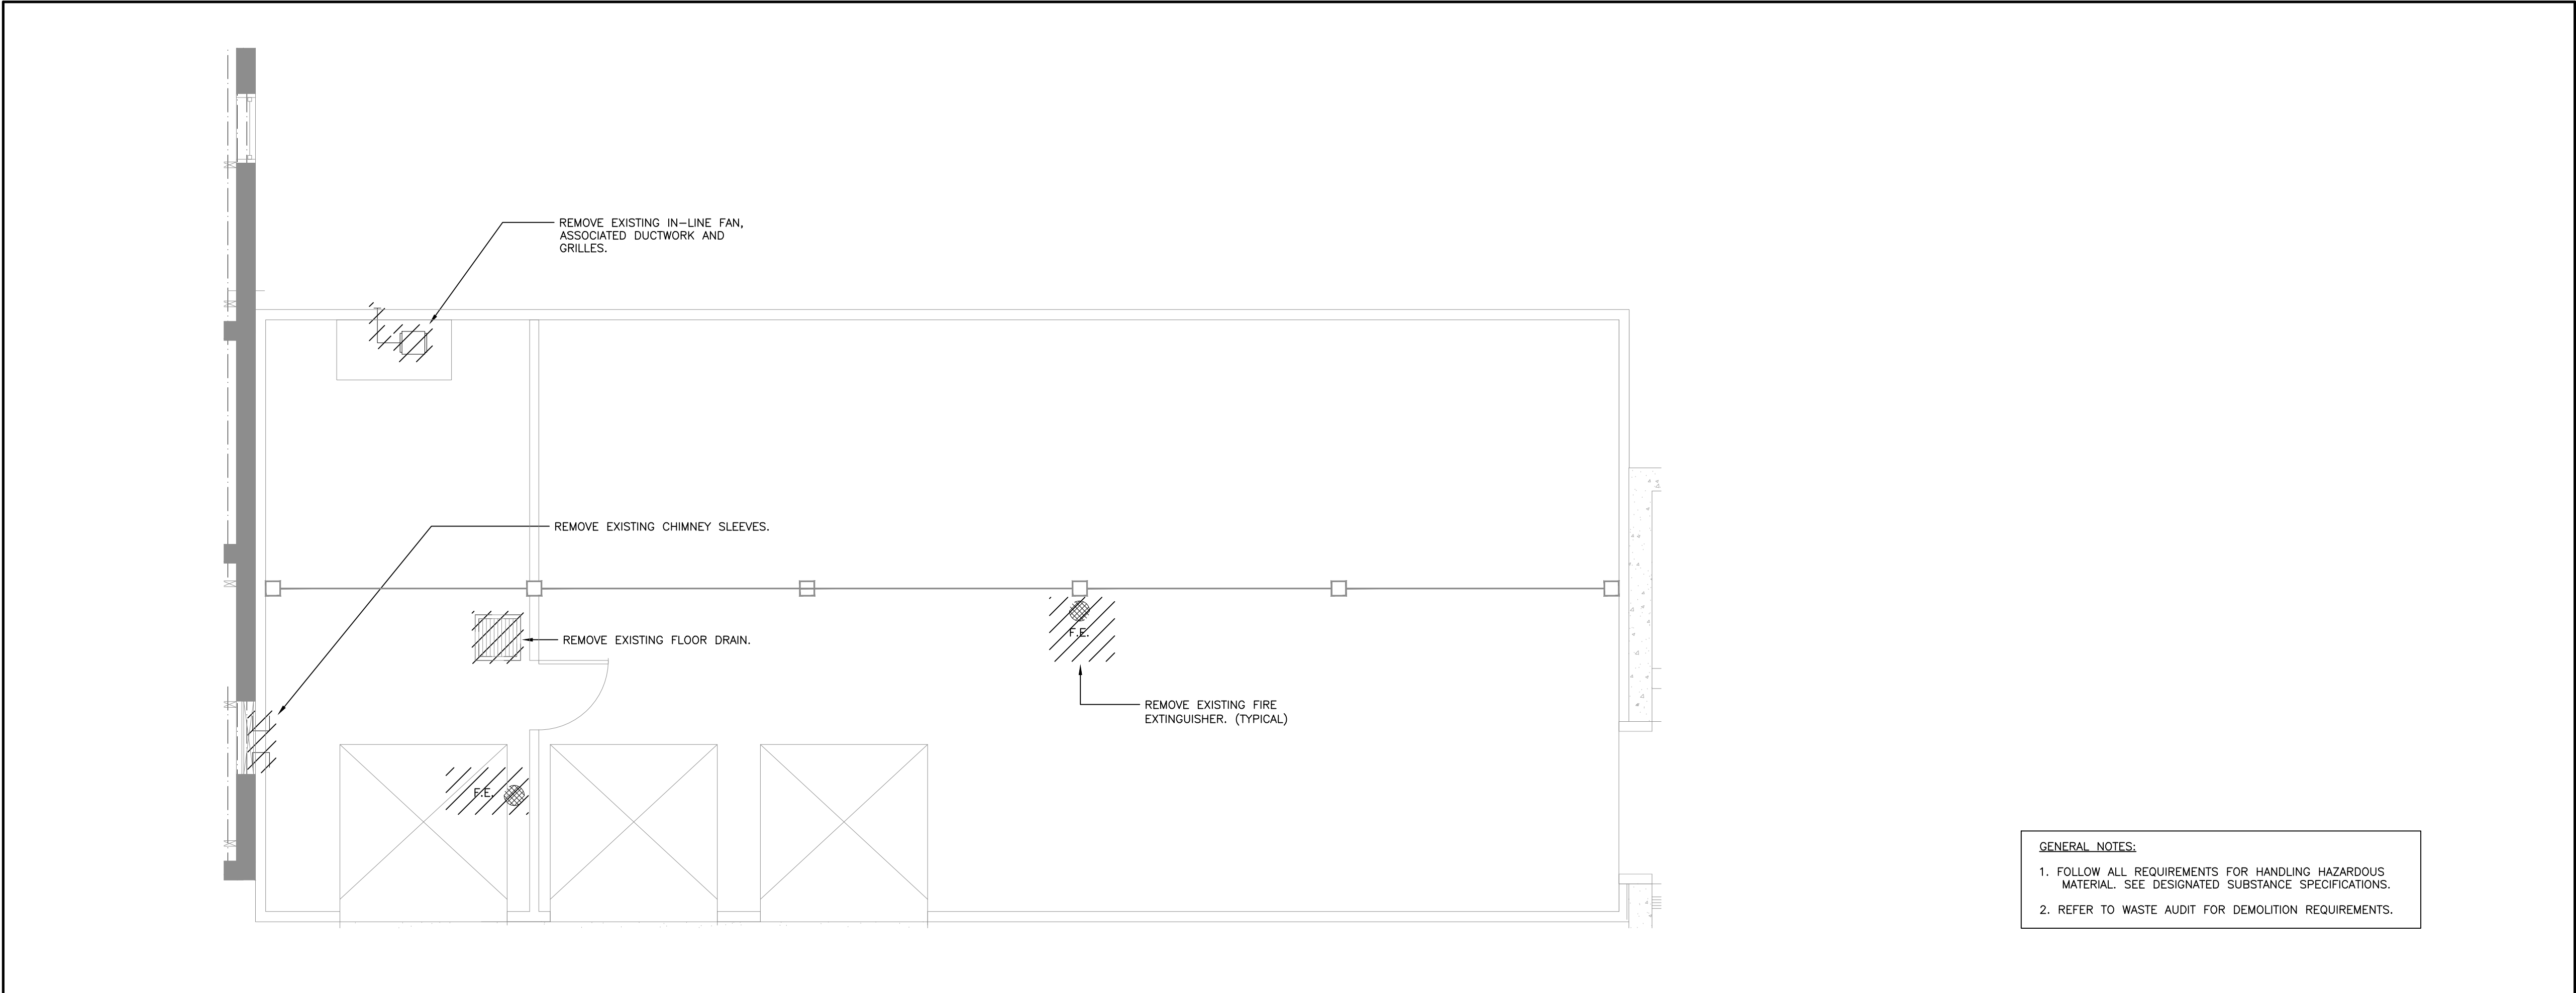

1 GARAGE BUILDING – MECHANICAL DEMOLITION

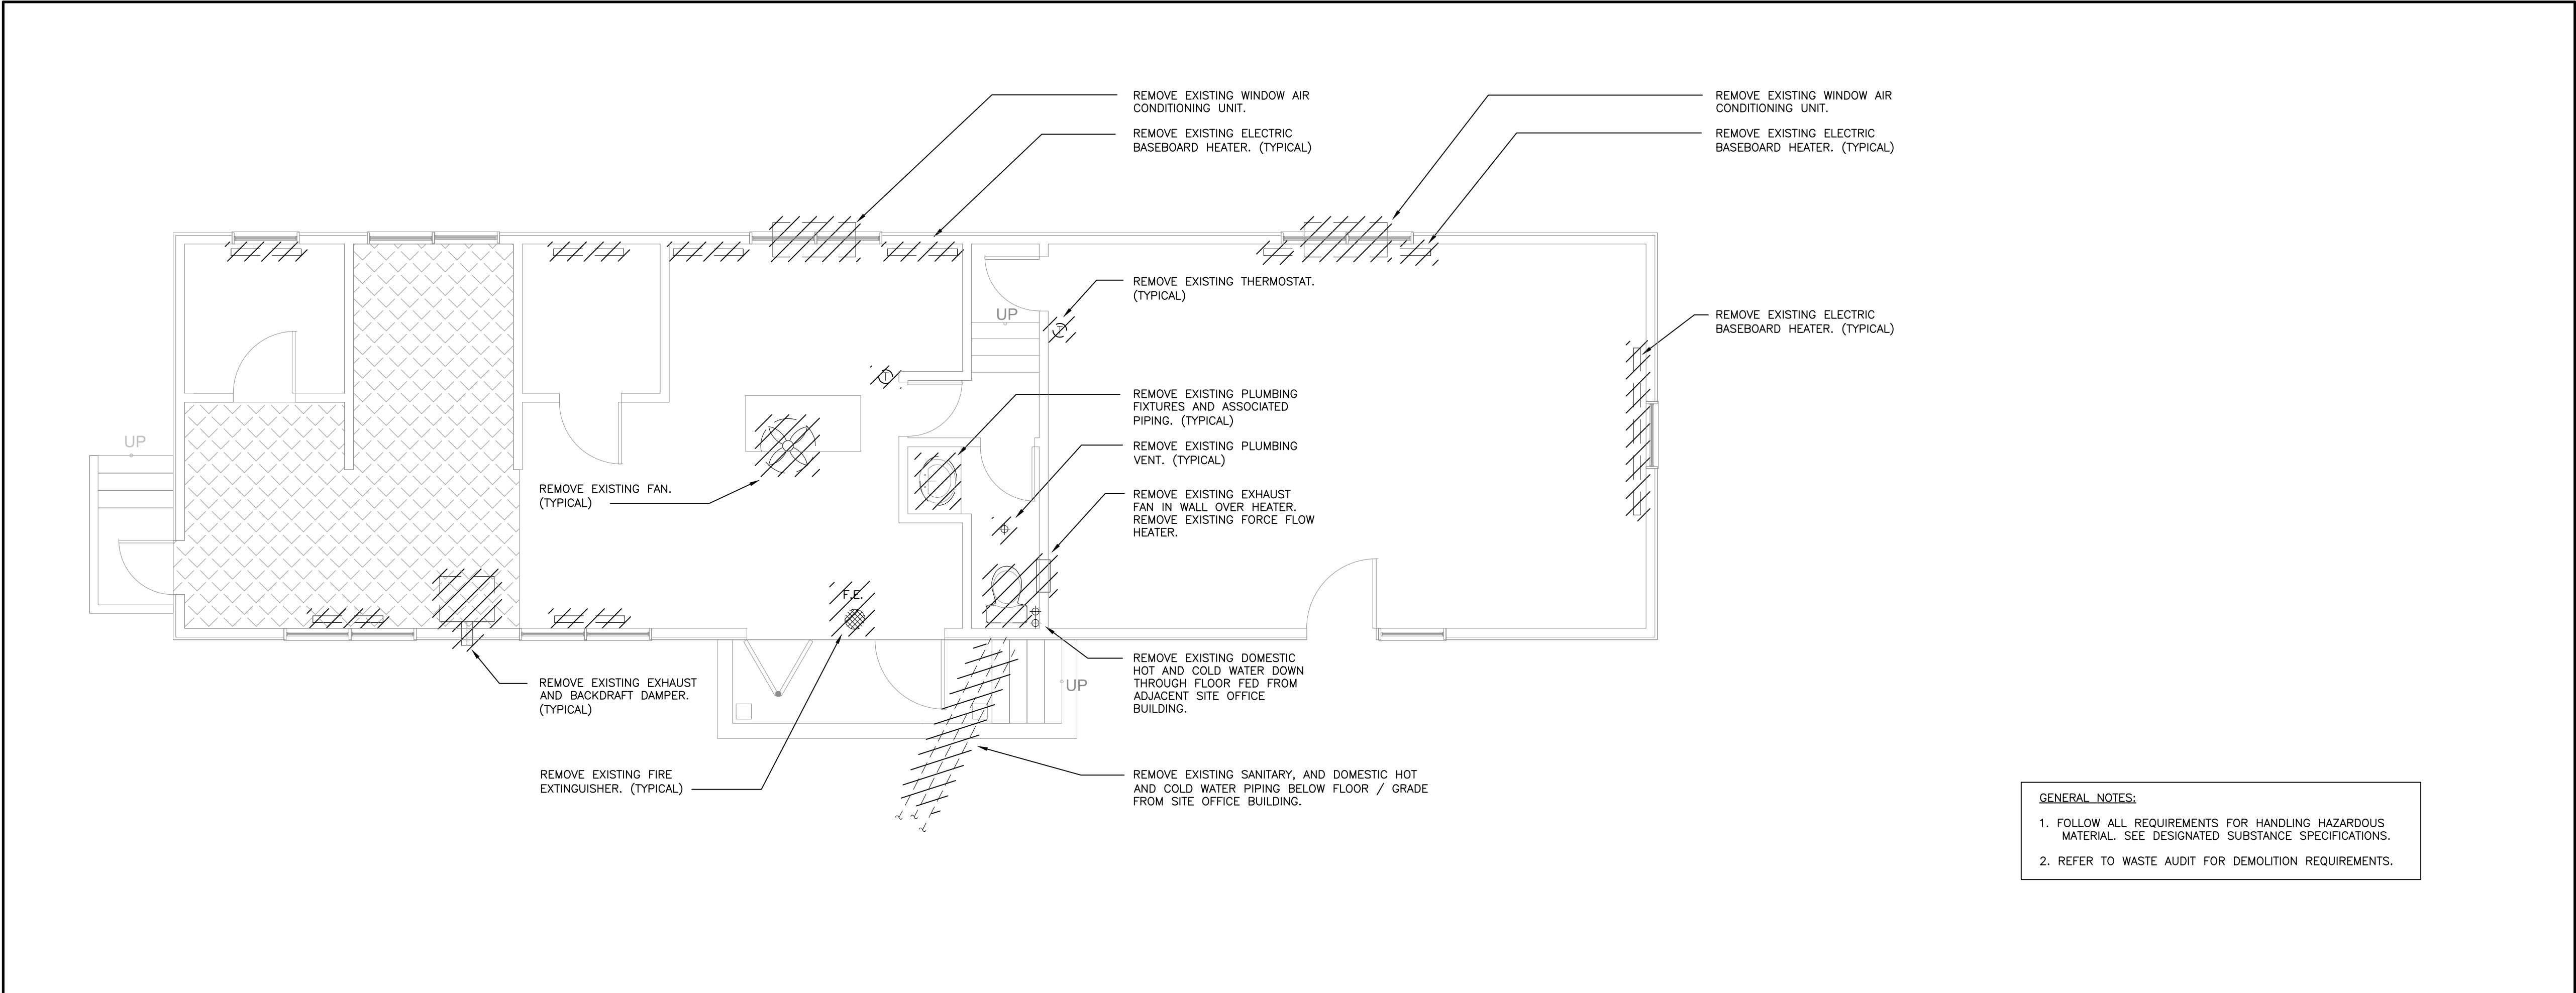

2 SHOP BUILDING – MECHANICAL DEMOLITION

consultant
expert-conseil



Smith + Andersen

1600 Carling Ave Suite 530 Ottawa Ontario K1Z 1G3
t 613 230 1186 f 613 230 2598 smithandandersen.com

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PHASE 1A BUILDING
DEMOLITION AND SITE
REMEDICATION

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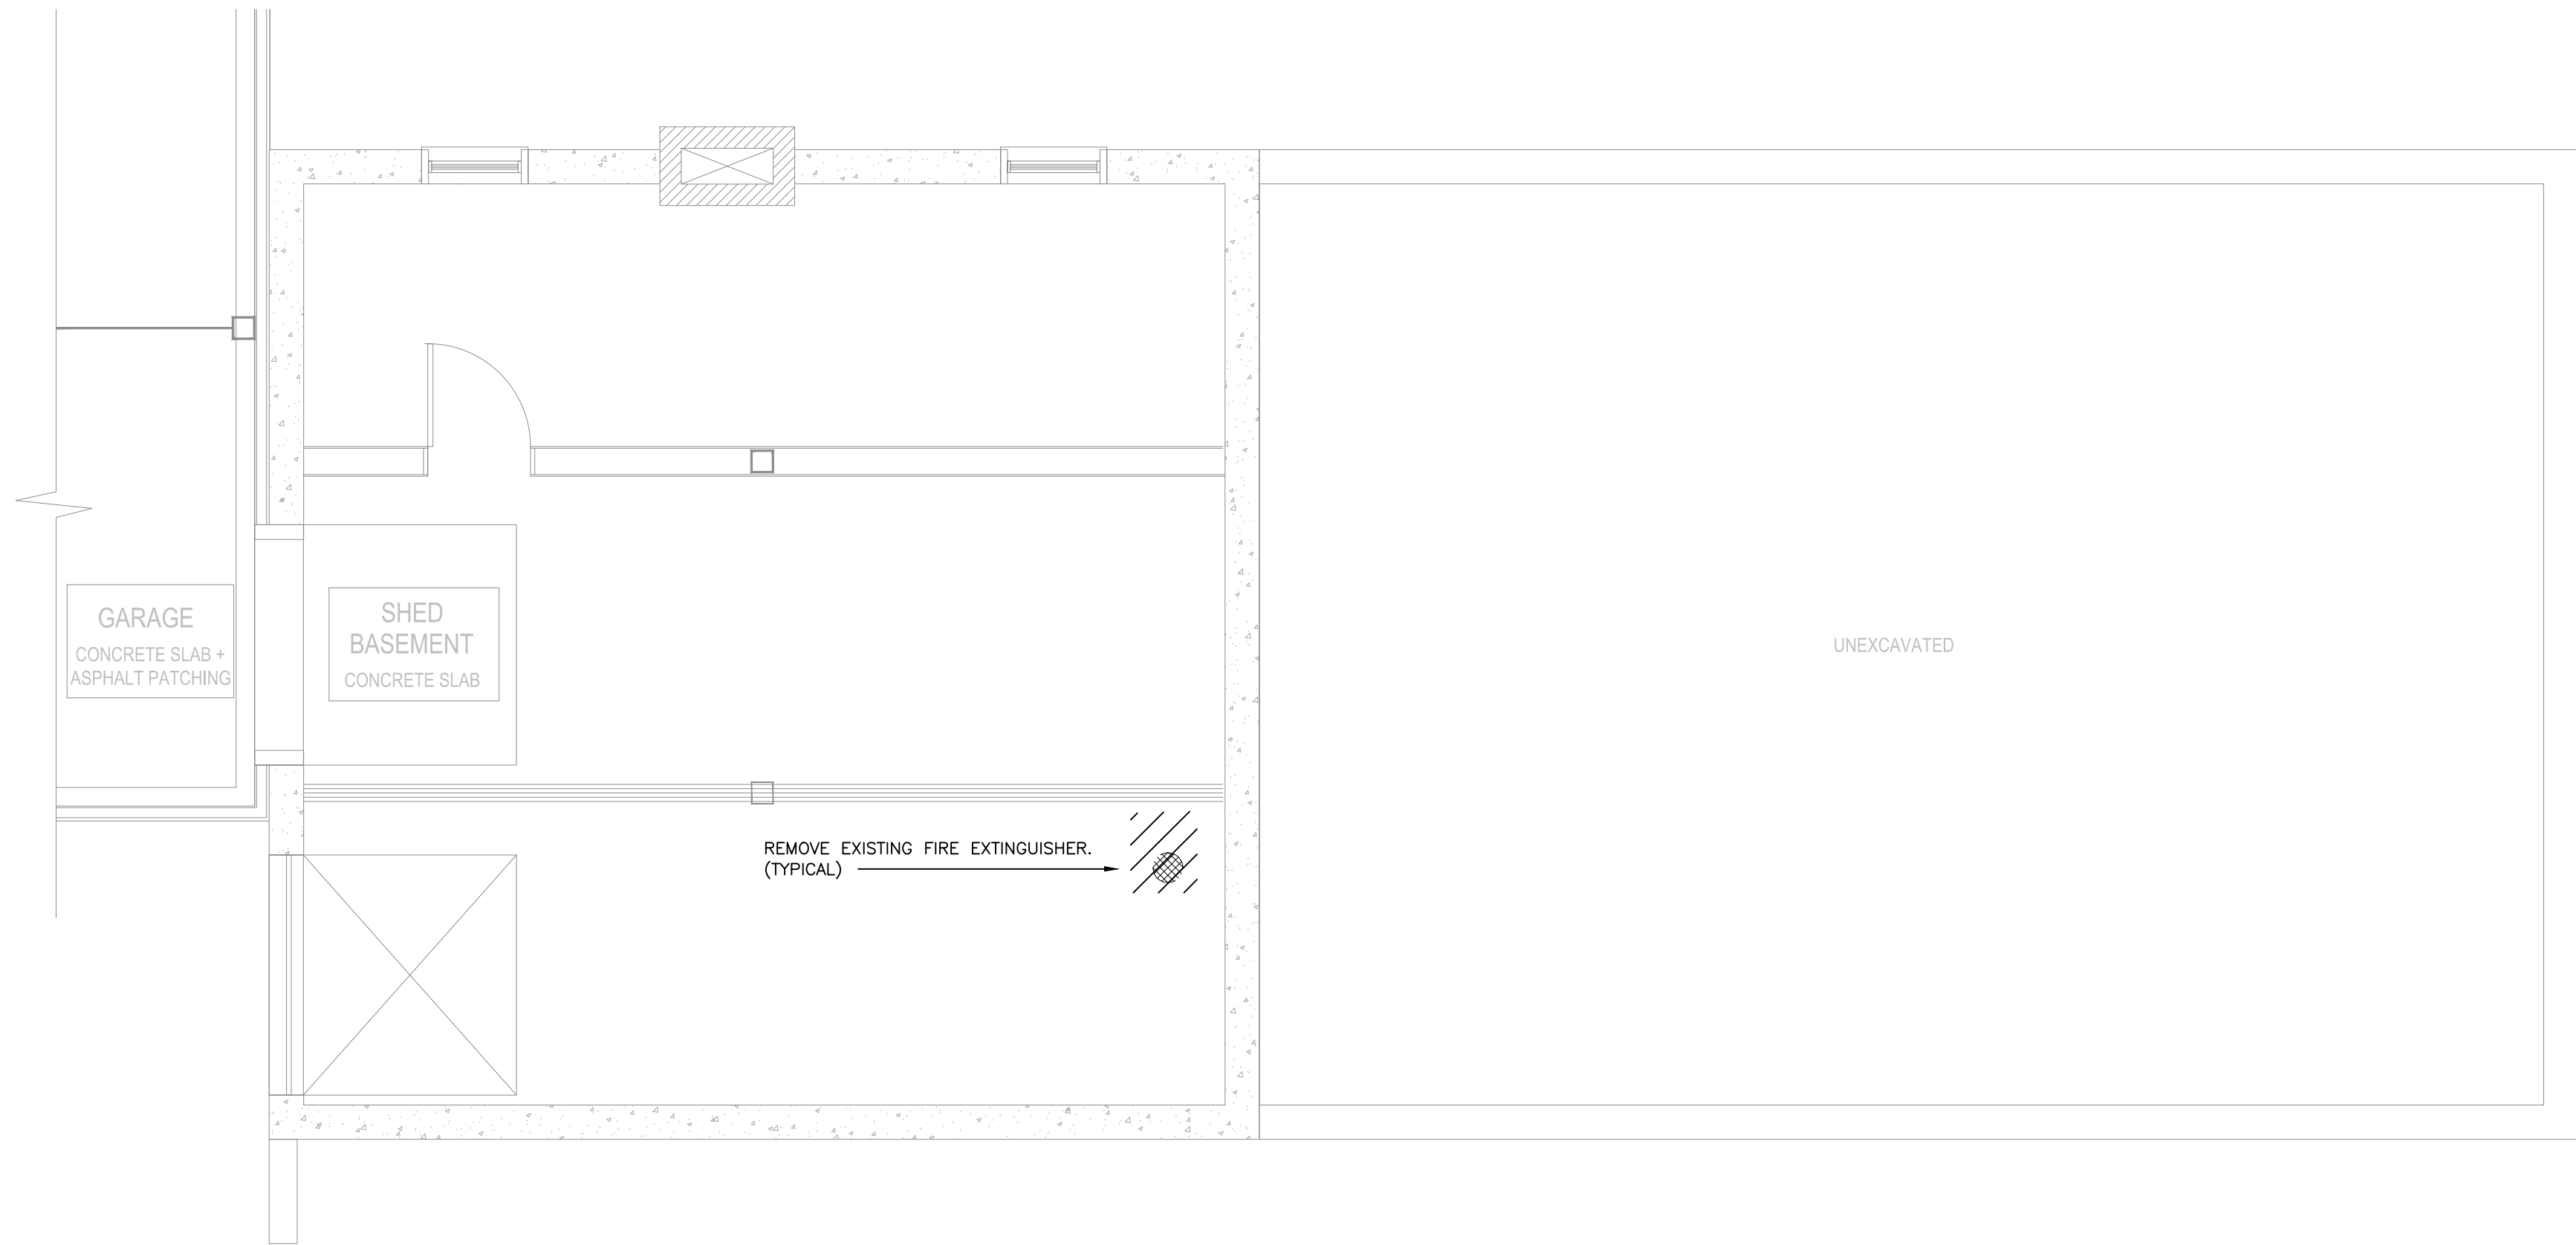
GARAGE BUILDING AND
SHOP BUILDING -
MECHANICAL DEMOLITION

approved by
approuvé par M.L.

designed by
conçu par J.R.M.

drawn by
dessiné par J.R.M.


date scale
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GENERAL NOTES:

1. FOLLOW ALL REQUIREMENTS FOR HANDLING HAZARDOUS MATERIAL. SEE DESIGNATED SUBSTANCE SPECIFICATIONS.
2. REFER TO WASTE AUDIT FOR DEMOLITION REQUIREMENTS.

1 SHED - BASEMENT - MECHANICAL DEMOLITION



GENERAL NOTES:

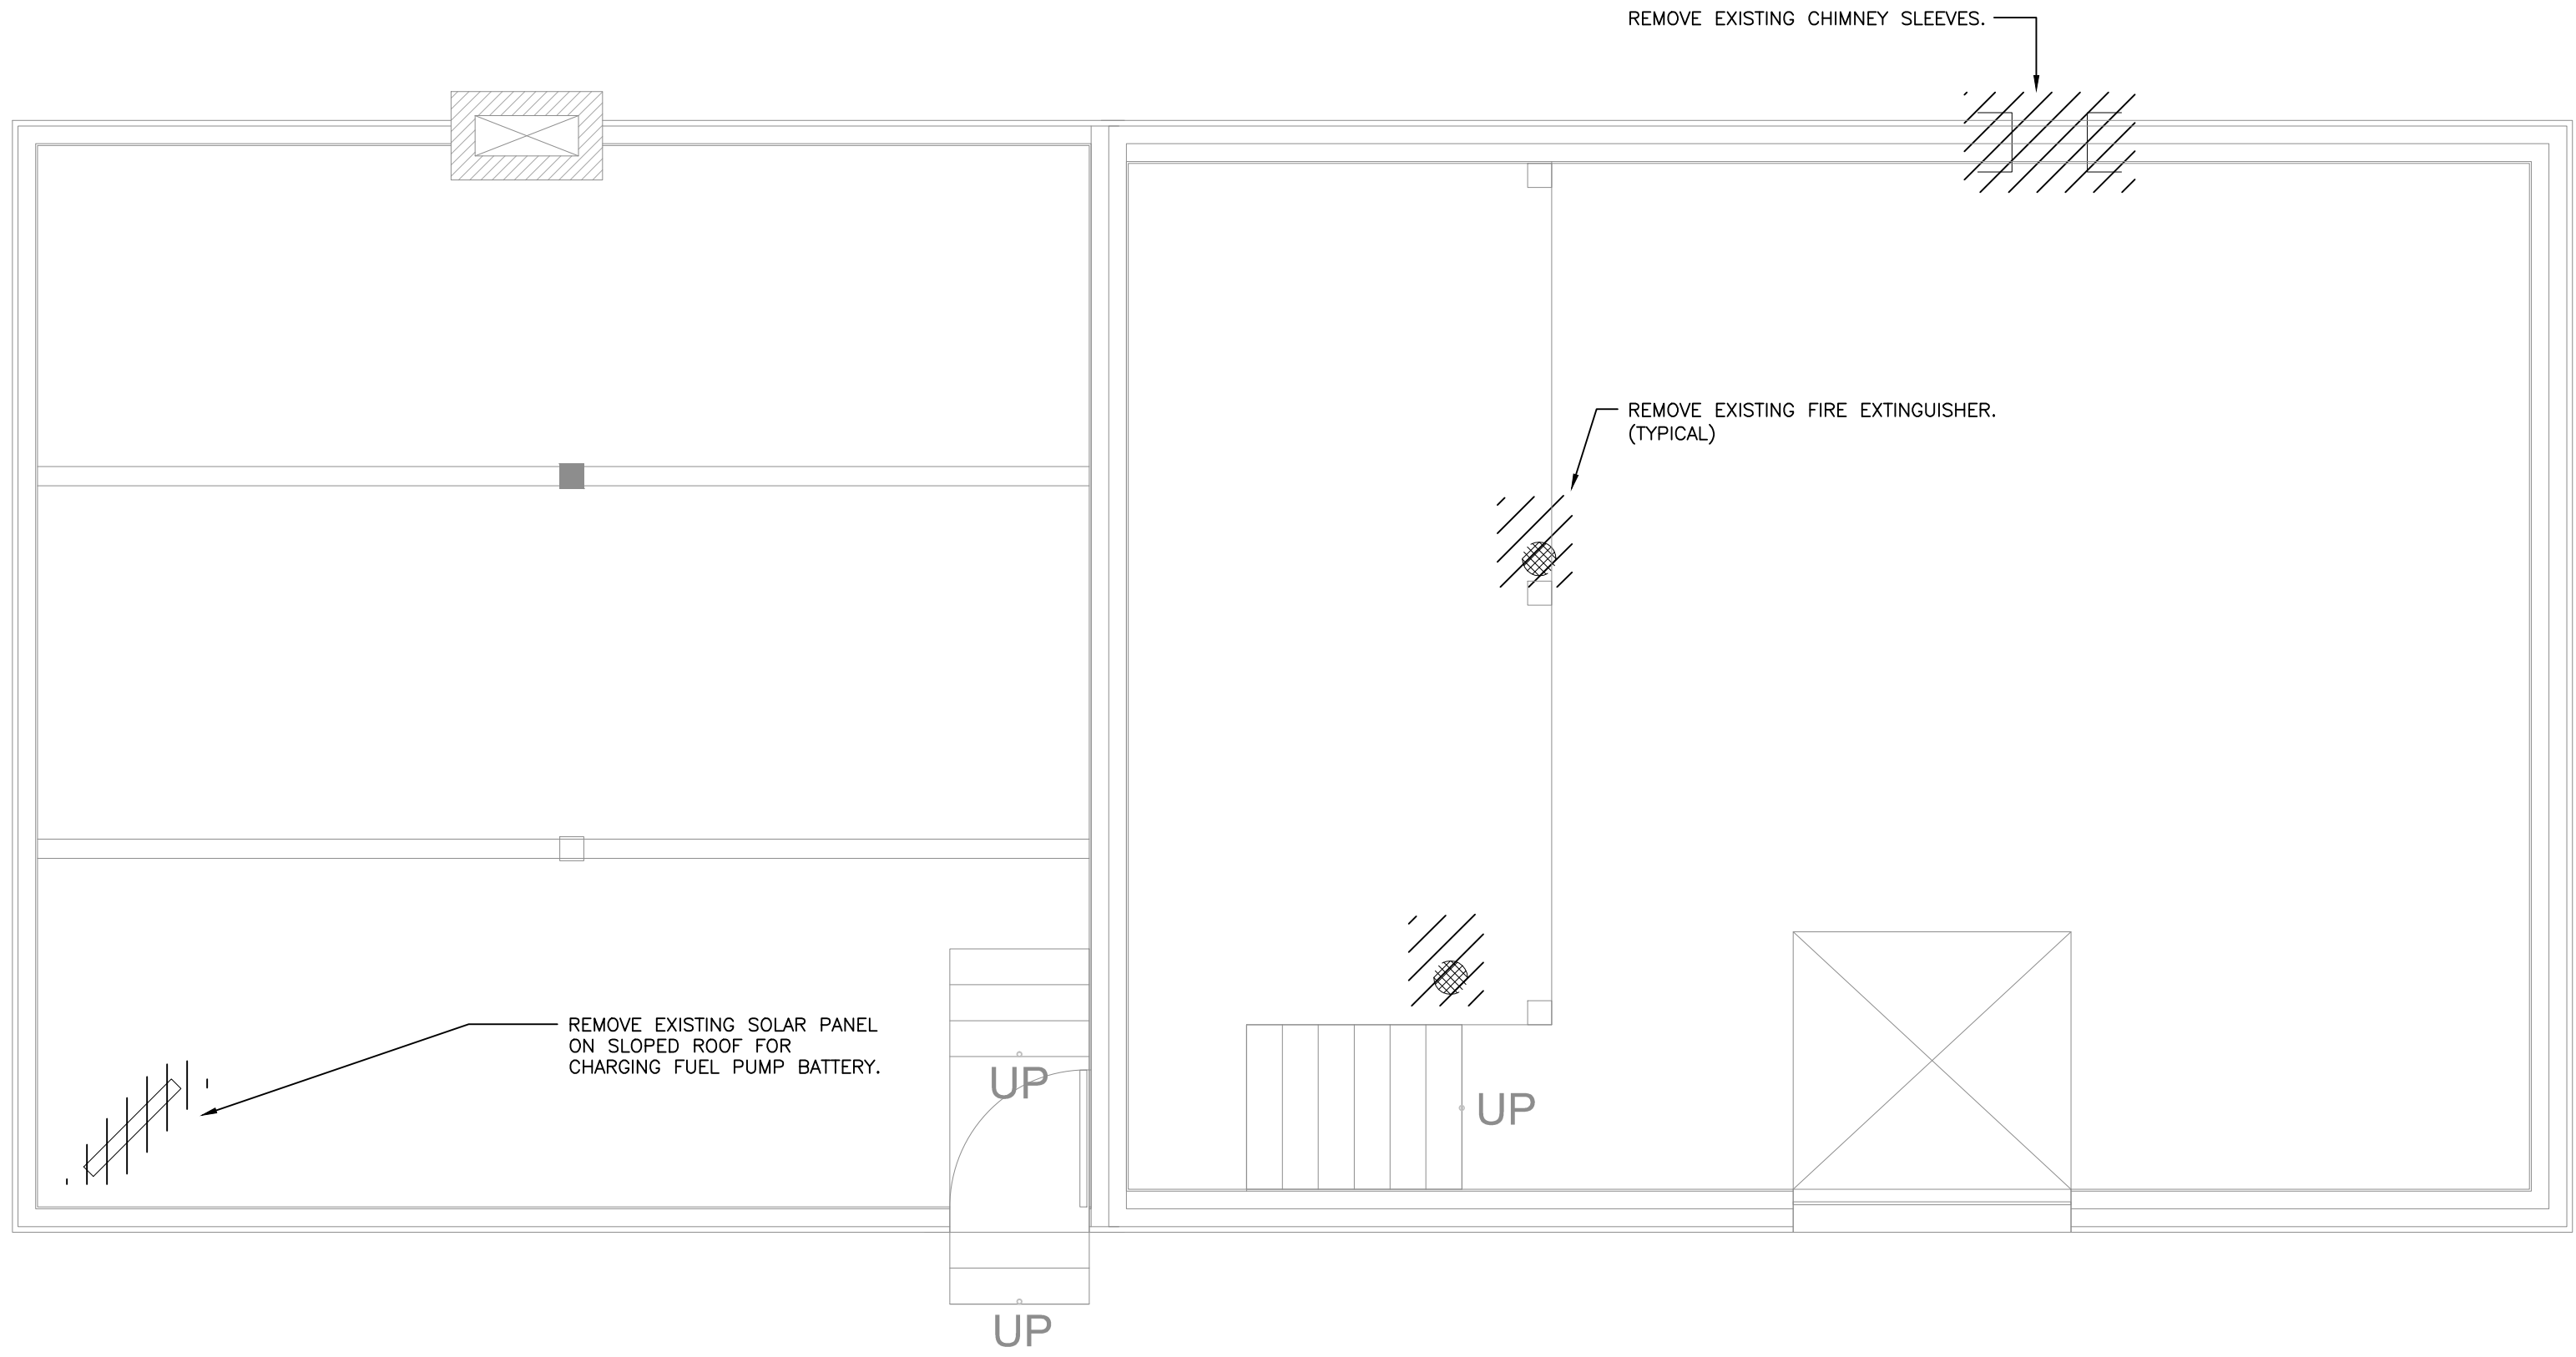1. FOLLOW ALL REQUIREMENTS FOR HANDLING HAZARDOUS MATERIAL. SEE DESIGNATED SUBSTANCE SPECIFICATIONS.
2. REFER TO WASTE AUDIT FOR DEMOLITION REQUIREMENTS.

2 SHED - GROUND FLOOR - MECHANICAL DEMOLITION

consultant
expert-conseil



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project
projet

PHASE 1A BUILDING
DEMOLITION AND SITE
REMEDIATION

drawing
dessin

SHED PLANS - MECHANICAL
DEMOLITION


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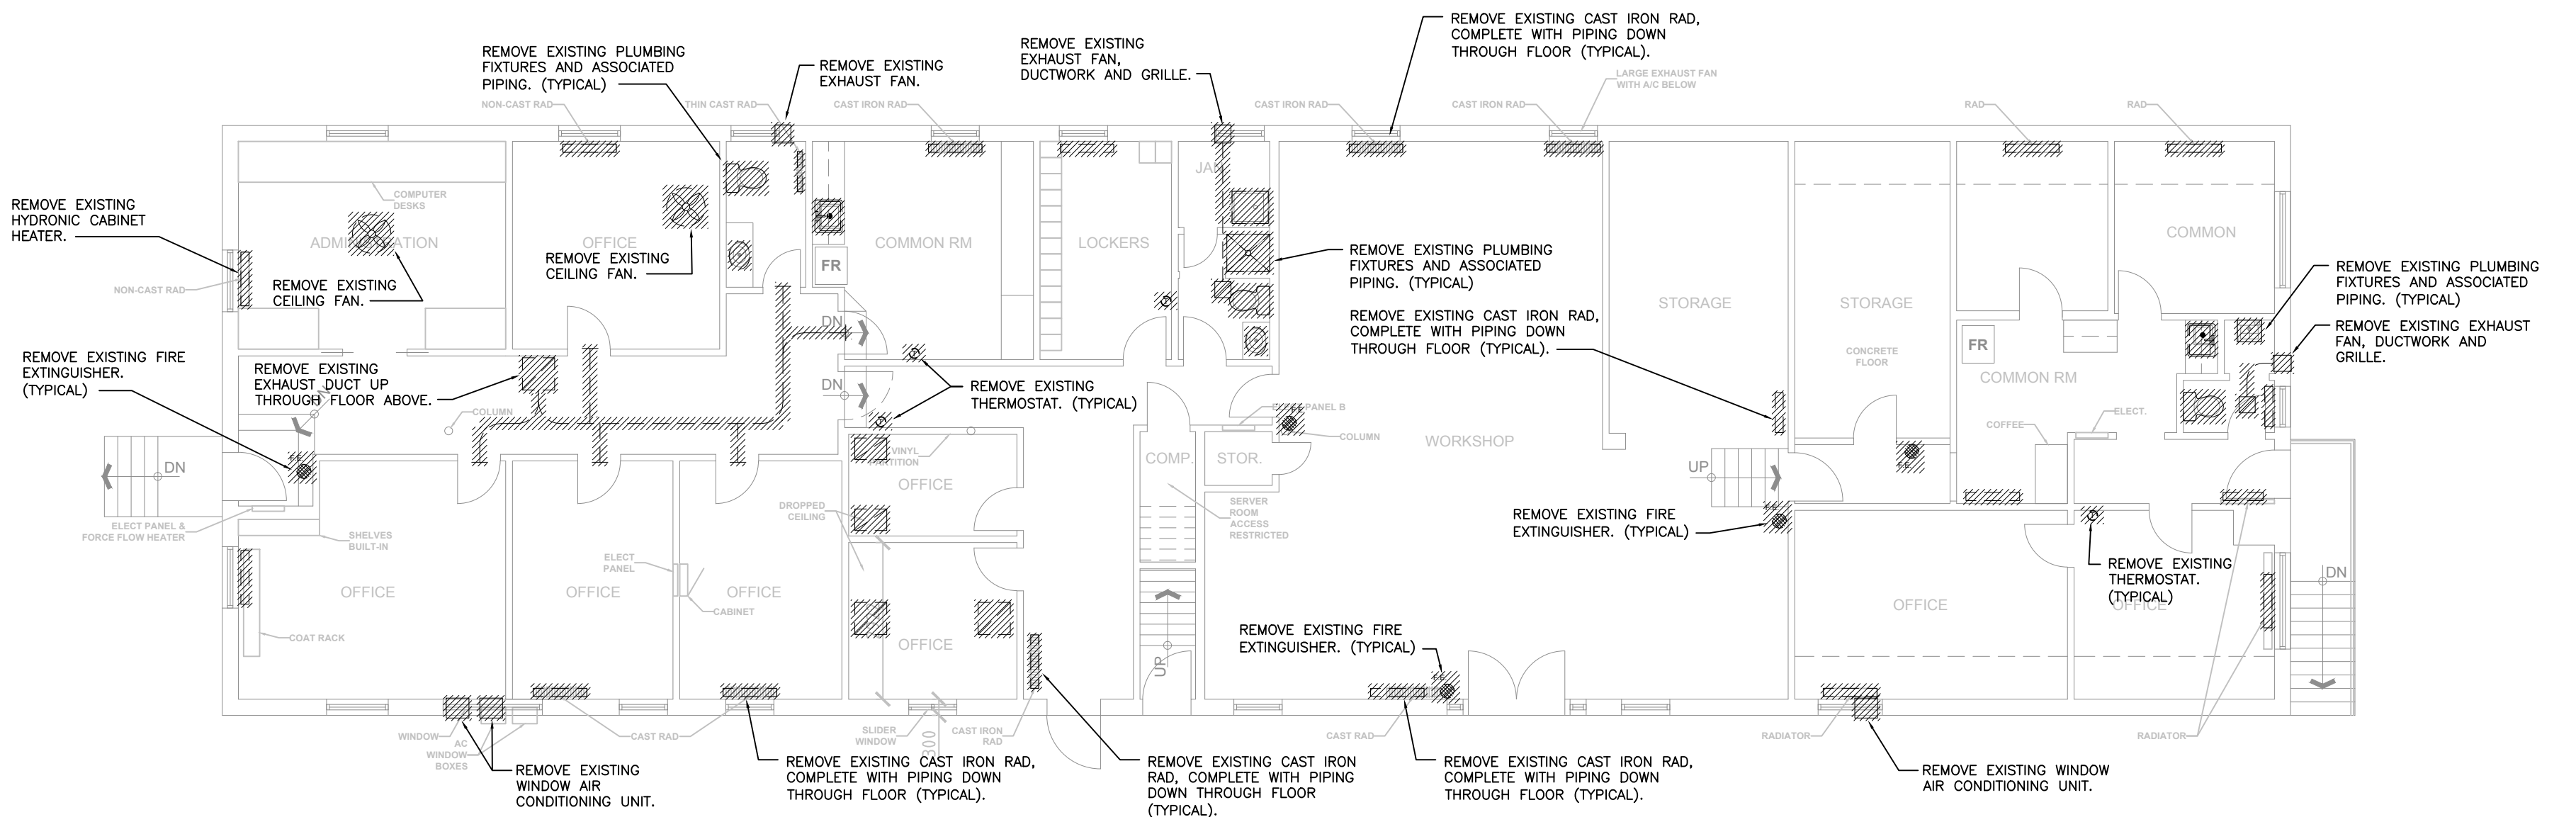
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date scale
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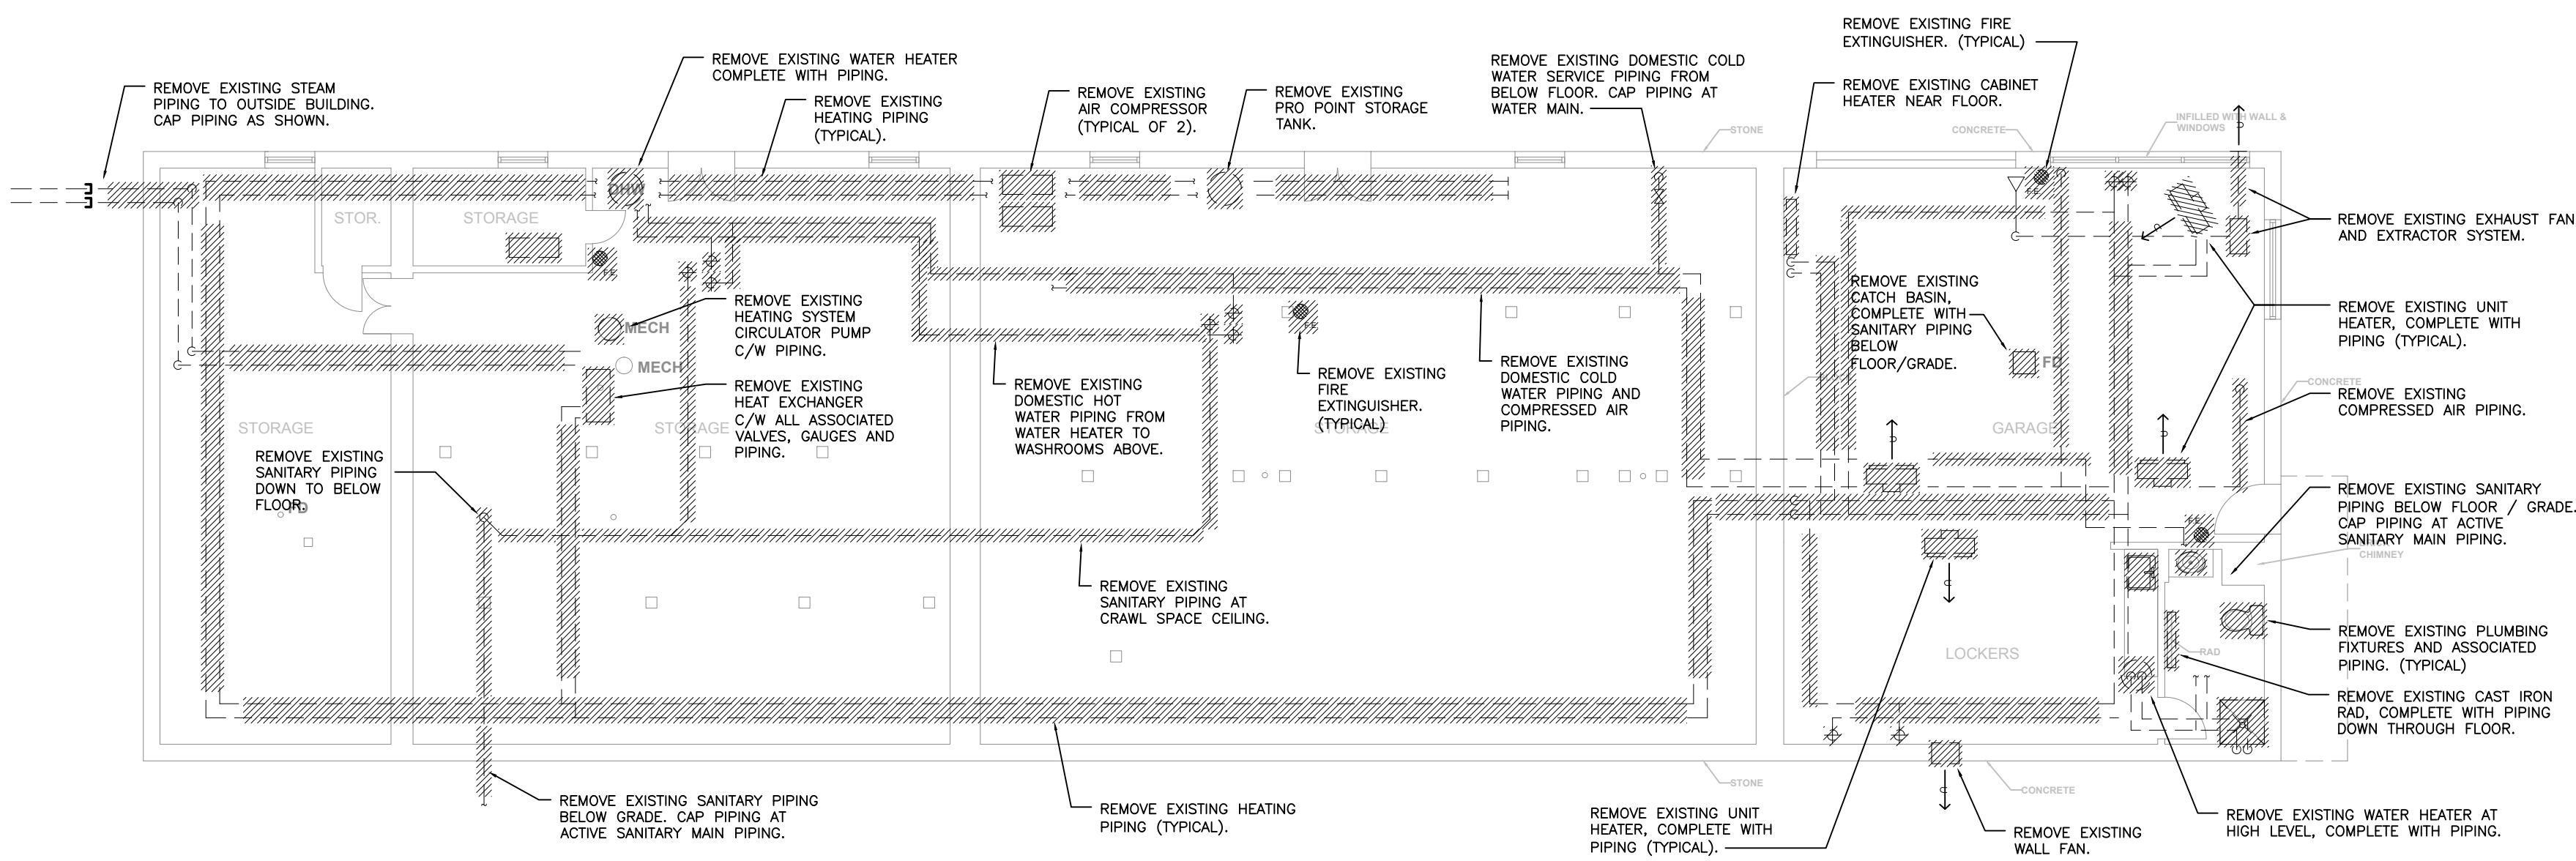
FLOOR PLAN - LEVEL 2



FLOOR PLAN - LEVEL 1



FLOOR PLAN - BASEMENT

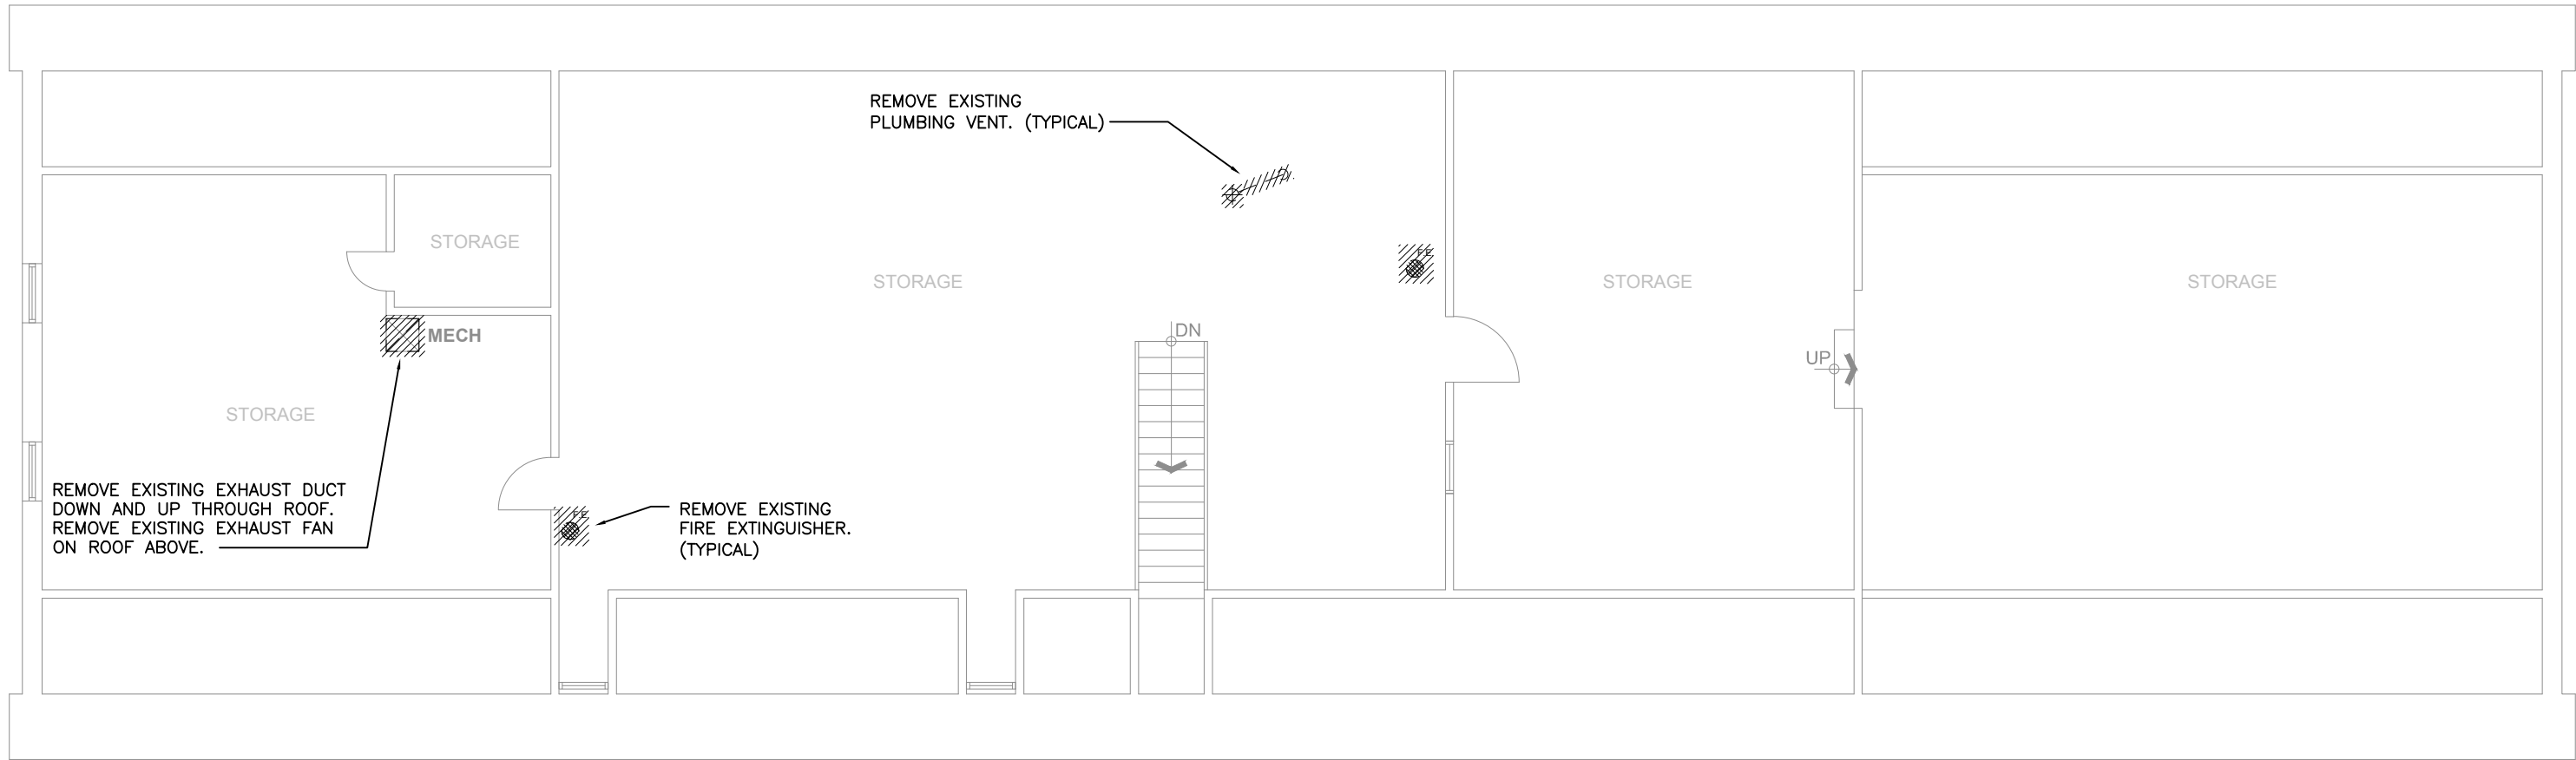

- GENERAL NOTES:
- FOLLOW ALL REQUIREMENTS FOR HANDLING HAZARDOUS MATERIAL. SEE DESIGNATED SUBSTANCE SPECIFICATIONS.
 - REFER TO WASTE AUDIT FOR DEMOLITION REQUIREMENTS.
 - HAND OVER ALL CAST IRON RADIATORS TO OWNER.

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0	ISSUED FOR 66% REVIEW	2015-01-16

project
projet

PHASE 1A BUILDING DEMOLITION AND SITE REMEDIATION

drawing
dessin

SITE OFFICE - MECHANICAL DEMOLITION

approved by
approuvé par M.L.

designed by
conçu par J.R.M.

drawn by
dessiné par J.R.M.

date JAN 16, 2015 scale 1:100
échelle

13053.002

M103

SINGLE LINE DIAGRAM LEGEND











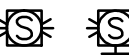

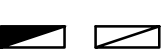

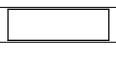
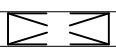




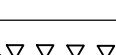

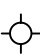


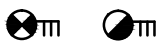


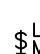

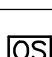
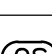

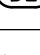
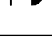
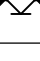



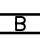

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POWER AND SYSTEMS LEGEND

	WALL MOUNTED DUPLEX RECEPTACLE 120 VOLT, 15 AMP, CSA 5-15R
	WALL MOUNTED DUPLEX RECEPTACLE 120 VOLT, 15 AMP, 2 POLE, SPLIT CIRCUIT
	WALL MOUNTED DUPLEX RECEPTACLE 120 VOLT, 15 AMP, CSA 5-15R, DEDICATED CIRCUIT
	CEILING MOUNTED DUPLEX RECEPTACLE 120 VOLT, 15 AMP, CSA 5-15R
	CEILING MOUNTED QUAD RECEPTACLE 120 VOLT, 15 AMP, CSA 5-15R
	WALL MOUNTED SPECIALTY RECEPTACLE, VOLTS AND AMPS AS INDICATED IN RECEPTACLE SCHEDULE
	WALL MOUNTED RECEPTACLES 2 DUPLEX CSA 5-15R
	ONE BACKBOX C/W ONE 3/4" CONDUIT STUBBED INTO CEILING SPACE C/W TWO CONNECTORS WITH NYLON BUSHINGS AND PULL STRINGS FOR USE BY COMMUNICATIONS CONTRACTOR. ONE CONDUIT PER BOX.
	ONE BACKBOX C/W MINIMUM 1-1/4" CONDUIT STUBBED INTO CEILING SPACE OR TO AUDIO VISUAL DEVICE C/W TWO CONNECTORS WITH NYLON BUSHINGS AND PULL STRINGS FOR USE BY AUDIO VISUAL CONTRACTOR. REFER TO AUDIO VISUAL DRAWINGS FOR COMPLETE REQUIREMENTS INCLUDING BACKBOX SIZE/TYPE, CONDUIT SIZE, ROUTING AND TERMINATION POINTS, ETC.
	FLOOR BOX COMPLETE WITH DUPLEX CSA 5-15R
	FLOOR BOX C/W DUPLEX CSA 5-15R ISOLATED GROUND
	FLOOR MOUNTED OUTLET 2 DUPLEX CSA 5-15R
	FLOOR BOX C/W CSA 5-15R AND OPENING FOR USE BY COMMUNICATION CONTRACTOR
	FLOOR BOX C/W 2 CSA 5-15R AND OPENING FOR USE BY COMMUNICATION CONTRACTOR
	SERVICE POLE, TYPE AS SPECIFIED C/W TYPE AND QUANTITY OF DEVICES INDICATED
	WALL MOUNTED WIREMOLD, TYPE AS SPECIFIED C/W TYPE AND QUANTITY OF DEVICES INDICATED
	PANEL-SURFACE MOUNT
	PANEL-FLUSH MOUNT
	DIRECT CONNECTION TO EQUIPMENT AS NOTED
	COMBINATION DISCONNECT/STARTER
	DISCONNECT SWITCH
	TRANSFORMER
	CONNECTION TO MOTOR
	MANUAL STARTER
	CONTACTOR
	BUZZER
	CONNECTION TO ELECTRIFIED FURNITURE LETTER DENOTES FEED LOCATION: W = WALL, F = FLOOR, P = PAC POLE
	TV OUTLET WALL MOUNTED ROUGH-IN
	QUAD POKE-THROUGH FLOOR BOX
	CABLE TRAY REFER TO SPECIFICATION LETTER DENOTES FOR TYPE
	GROUNDING BUS BAR
	SIGNAL BELL
	PAGING SPEAKER
	AUDIO VISUAL SPEAKER
	BASEBOARD HEATER
	UNIT HEATER

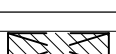
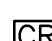







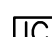




NOTE: NOT ALL SYMBOLS APPLY. CONTRACTOR TO REFER TO FLOOR PLANS.

FIRE ALARM SYSTEMS

	MANUAL PULL STATION
	FIRE ALARM BELL
	SMOKE DETECTOR
	HEAT DETECTOR
	DUCT MOUNTED SMOKE DETECTOR / HEAT DETECTOR
	FIREMAN'S HANDSET
	FIRE ALARM HOLD OPEN DEVICE – CONNECTION ONLY
	EMERGENCY HORN SINGLE
	EMERGENCY EVACUATION SPEAKER – CEILING MOUNTED / WALL MOUNTED
	EMERGENCY STROBE – CEILING MOUNTED / WALL MOUNTED
	EMERGENCY EVACUATION SPEAKER STROBE COMBINATION – CEILING MOUNTED / WALL MOUNTED
	EMERGENCY HORN/STROBE COMBINATION
	FIRE ALARM CONTROL PANEL / ANNUNCIATOR PANEL
	FIRE ALARM END OF LINE RESISTOR
<h2 style="text-align: center;">LIGHTING LEGEND</h2>	
	EXISTING BASE BUILDING LUMINAIRE TO REMAIN
	EXISTING BASE BUILDING LUMINAIRE TO BE REMOVED AND OR RELOCATED
	BASE BUILDING LUMINAIRE RELOCATED OR NEW
	EXISTING NIGHT LIGHT BASE BUILDING LUMINAIRE
	EXISTING BASE BUILDING NIGHT LIGHT LUMINAIRE TO BE REMOVED AND OR RELOCATED
	BASE BUILDING LUMINAIRE RELOCATED AND OR NEW NIGHT LIGHT CIRCUIT
	TRACK LIGHTING C/W NUMBER OF FIXTURES SHOWN
	CEILING MOUNTED LUMINAIRE EMERGENCY CIRCUIT
	CEILING MOUNTED LUMINAIRE
	CEILING MOUNTED WALL WASHER LUMINAIRE
	WALL SCONCE
	PENDANT FIXTURE
	SINGLE POLE LINE VOLTAGE LIGHT SWITCH
	3 WAY – LINE VOLTAGE LIGHT SWITCH
	LOW VOLTAGE LIGHT SWITCH – 'M' DENOTES MASTER SWITCH
	DIMMER TYPE TO SUIT LOAD (6=600W,10=1000W,15=1500W)
	WALL MOUNTED OCCUPANCY SENSOR SWITCH
	CEILING MOUNTED OCCUPANCY SENSOR
	DAY LIGHT PHOTO SENSOR
	WALL MOUNTED EMERGENCY SINGLE REMOTE HEAD
	WALL MOUNTED EMERGENCY DOUBLE REMOTE HEAD
	CEILING MOUNTED EMERGENCY SINGLE REMOTE HEAD
	CEILING MOUNTED EMERGENCY DOUBLE REMOTE HEAD
	EMERGENCY LIGHTING BATTERY UNIT C/W NUMBER OF HEADS SHOWN
	EMERGENCY LIGHTING BATTERY UNIT
	EXIT LIGHT CEILING MOUNTED C/W FACES AND ARROWS AS INDICATED
	EXIT LIGHT WALL MOUNTED C/W FACES AND ARROWS AS INDICATED

NOTE: NOT ALL SYMBOLS APPLY. CONTRACTOR TO REFER TO FLOOR PLANS.

DRAWING LIST

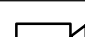NUMBER	DRAWING NAME		
E000	ELECTRICAL DRAWING LIST AND LEGEND		
E001	NOT USED		
E002	ELECTRICAL DETAILS		
E100	ELECTRICAL SITE PLAN		
E200	ELECTRICAL SINGLE LINES		
E301	GARAGE AND SHOP		
E302	SHED DEMOLITION PLANS		
E303	OCTAGONAL HERITAGE BUILDING DEMOLITION		
E304	SITE OFFICES LIGHTING DEMOLITION		
E305	SITE OFFICES POWER DEMOLITION		
ABBREVIATIONS			
E	EXISTING	V	VOLTS
ER	EXISTING TO BE REMOVED	A	AMPS
R	RELOCATED	KW	KILOWATTS
	RELOCATE	W	WATTS
RR	REMOVE AND RE-INSTALL	GFCI	GROUND FAULT CIRCUIT INTERRUPTOR
RC	REUSE CIRCUIT	TYP.	TYPICAL
I.G.	ISOLATED GROUND	C	CONDUIT
J.B	JUNCTION BOX	GRND	GROUND
AFF	ABOVE FINISHED FLOOR	D	DEDICATED
L.V.	LOW VOLTAGE	NL	NIGHT LIGHT
O/C	OVER COUNTER	EF	EXHAUST FAN
P	PARABOLIC LOUVER	RTU	ROOF TOP UNIT
WP	WEATHERPROOF	HWT	HOT WATER TANK
SECURITY LEGEND			
	SECURITY CARD READER ROUGH-IN		
	SECURITY ELECTRIC STRIKE ROUGH-IN		
	SECURITY MAGNETIC LOCK ROUGH-IN C/W FIRE ALARM TIE-IN		
	DOOR CONTACT ROUGH-IN		
	SECURITY DOOR ALARM ROUGH-IN		
	BREAK GLASS SENSOR ROUGH-IN		
	AUTOMATIC DOOR OPERATOR ROUGH-IN		
	WALL MOUNTED SECURITY REQUEST TO EXIT MOTION SENSOR		
	WALL MOUNTED INTERCOM ROUGH-IN		
	SECURITY KEY PAD ROUGH-IN		
	PUSH BUTTON ROUGH-IN		
	SECURITY CAMERA ROUGH-IN		
	DOOR BELL/CHIME		
NOTE: NOT ALL SYMBOLS APPLY. CONTRACTOR TO REFER TO FLOOR PLANS.			

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0	ISSUED FOR 66% REVIEW	2015-01-16
no.	description	date

project
projet

PHASE 1A BUILDING DEMOLITION AND SITE REMEDIATION

drawing
dessin

ELECTRICAL DRAWING LIST AND LEGEND

approved by
approuvé par A.D.


designed by
conçu par M.M.

drawn by
dessiné par M.M.


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Sep. 30, 15	échelle	N.T.S.

13053.002


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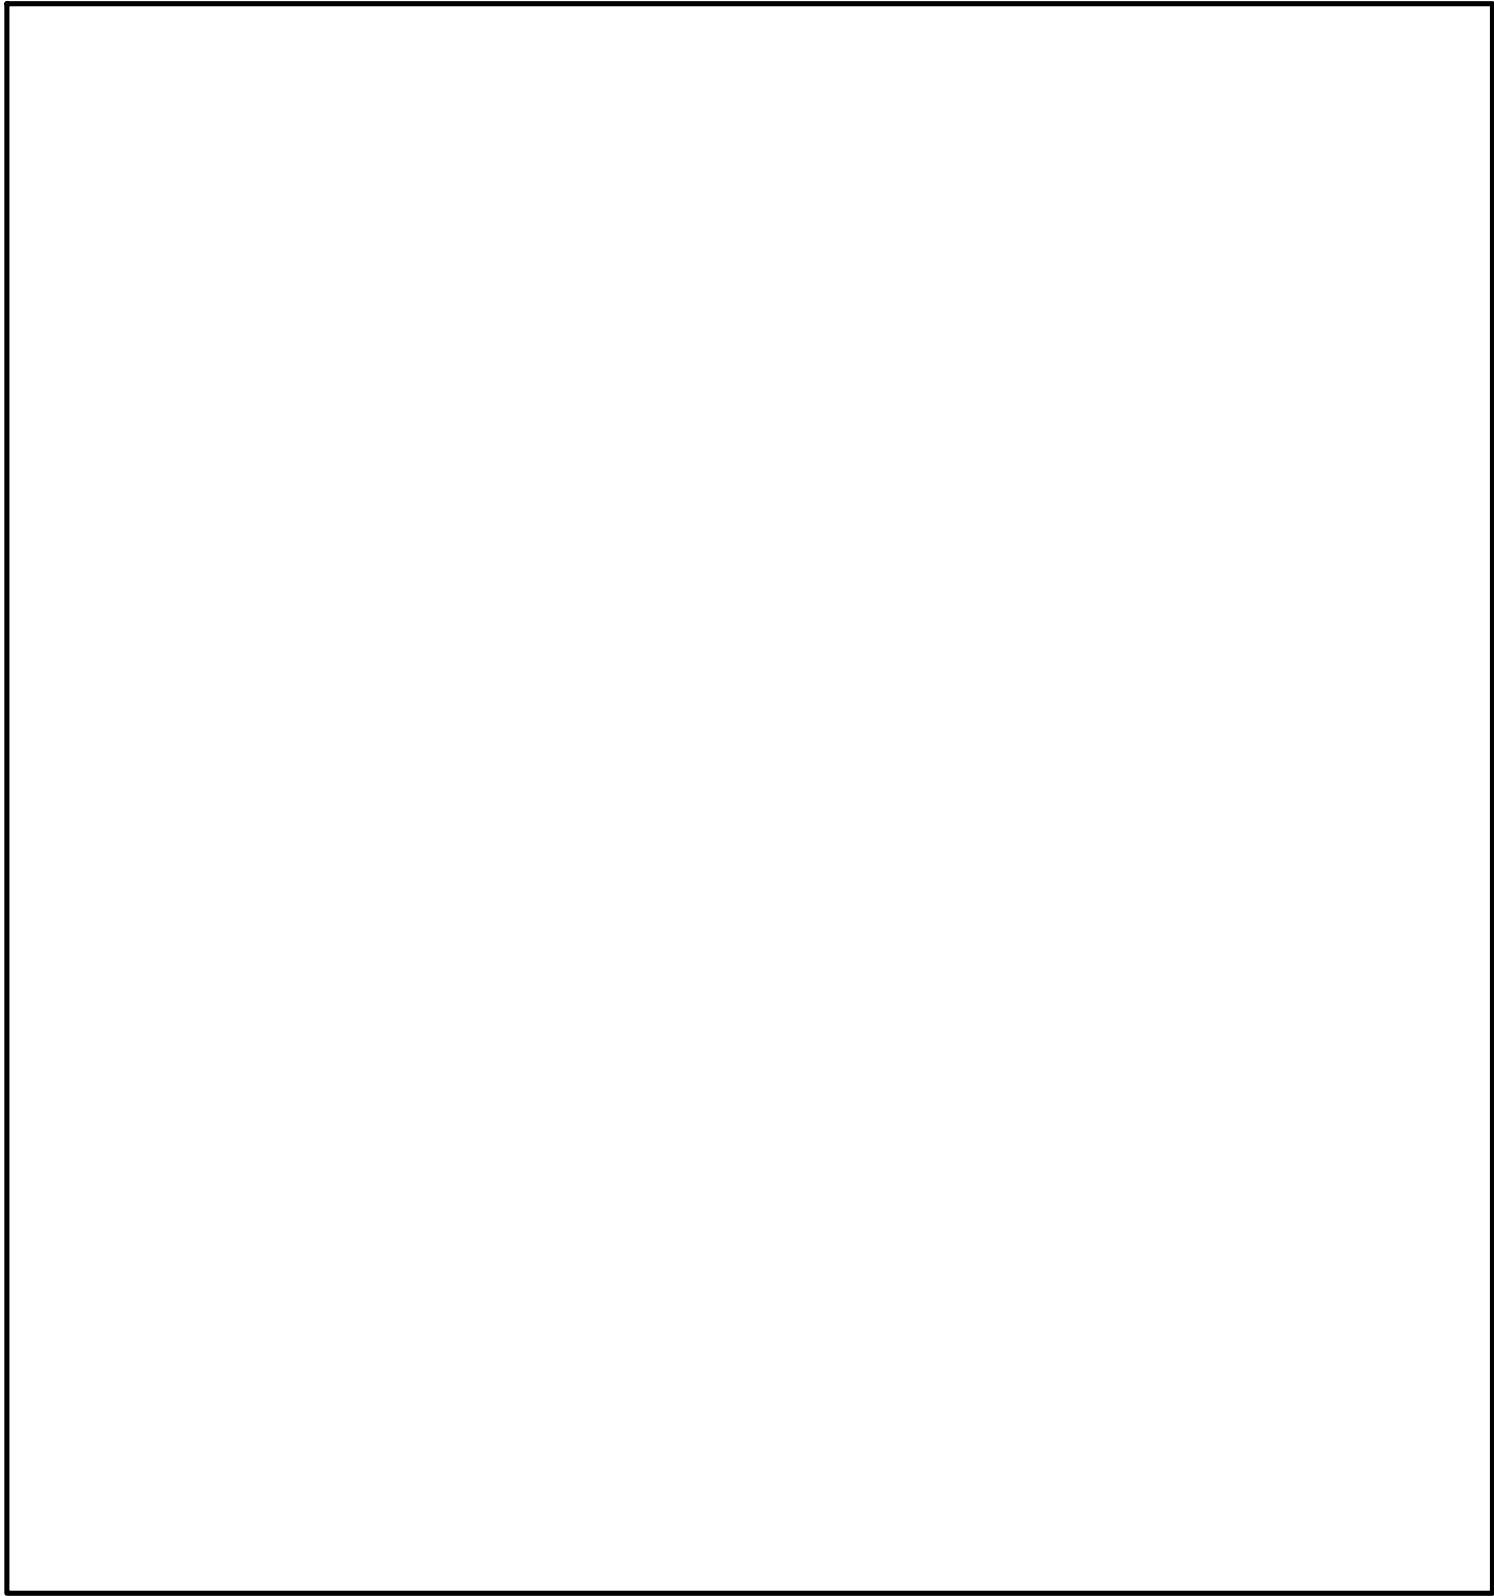
5 TYPICAL GANGED QUAD-RECEPTACLE AND DATA OUTLET.
SCALE: N.T.S.

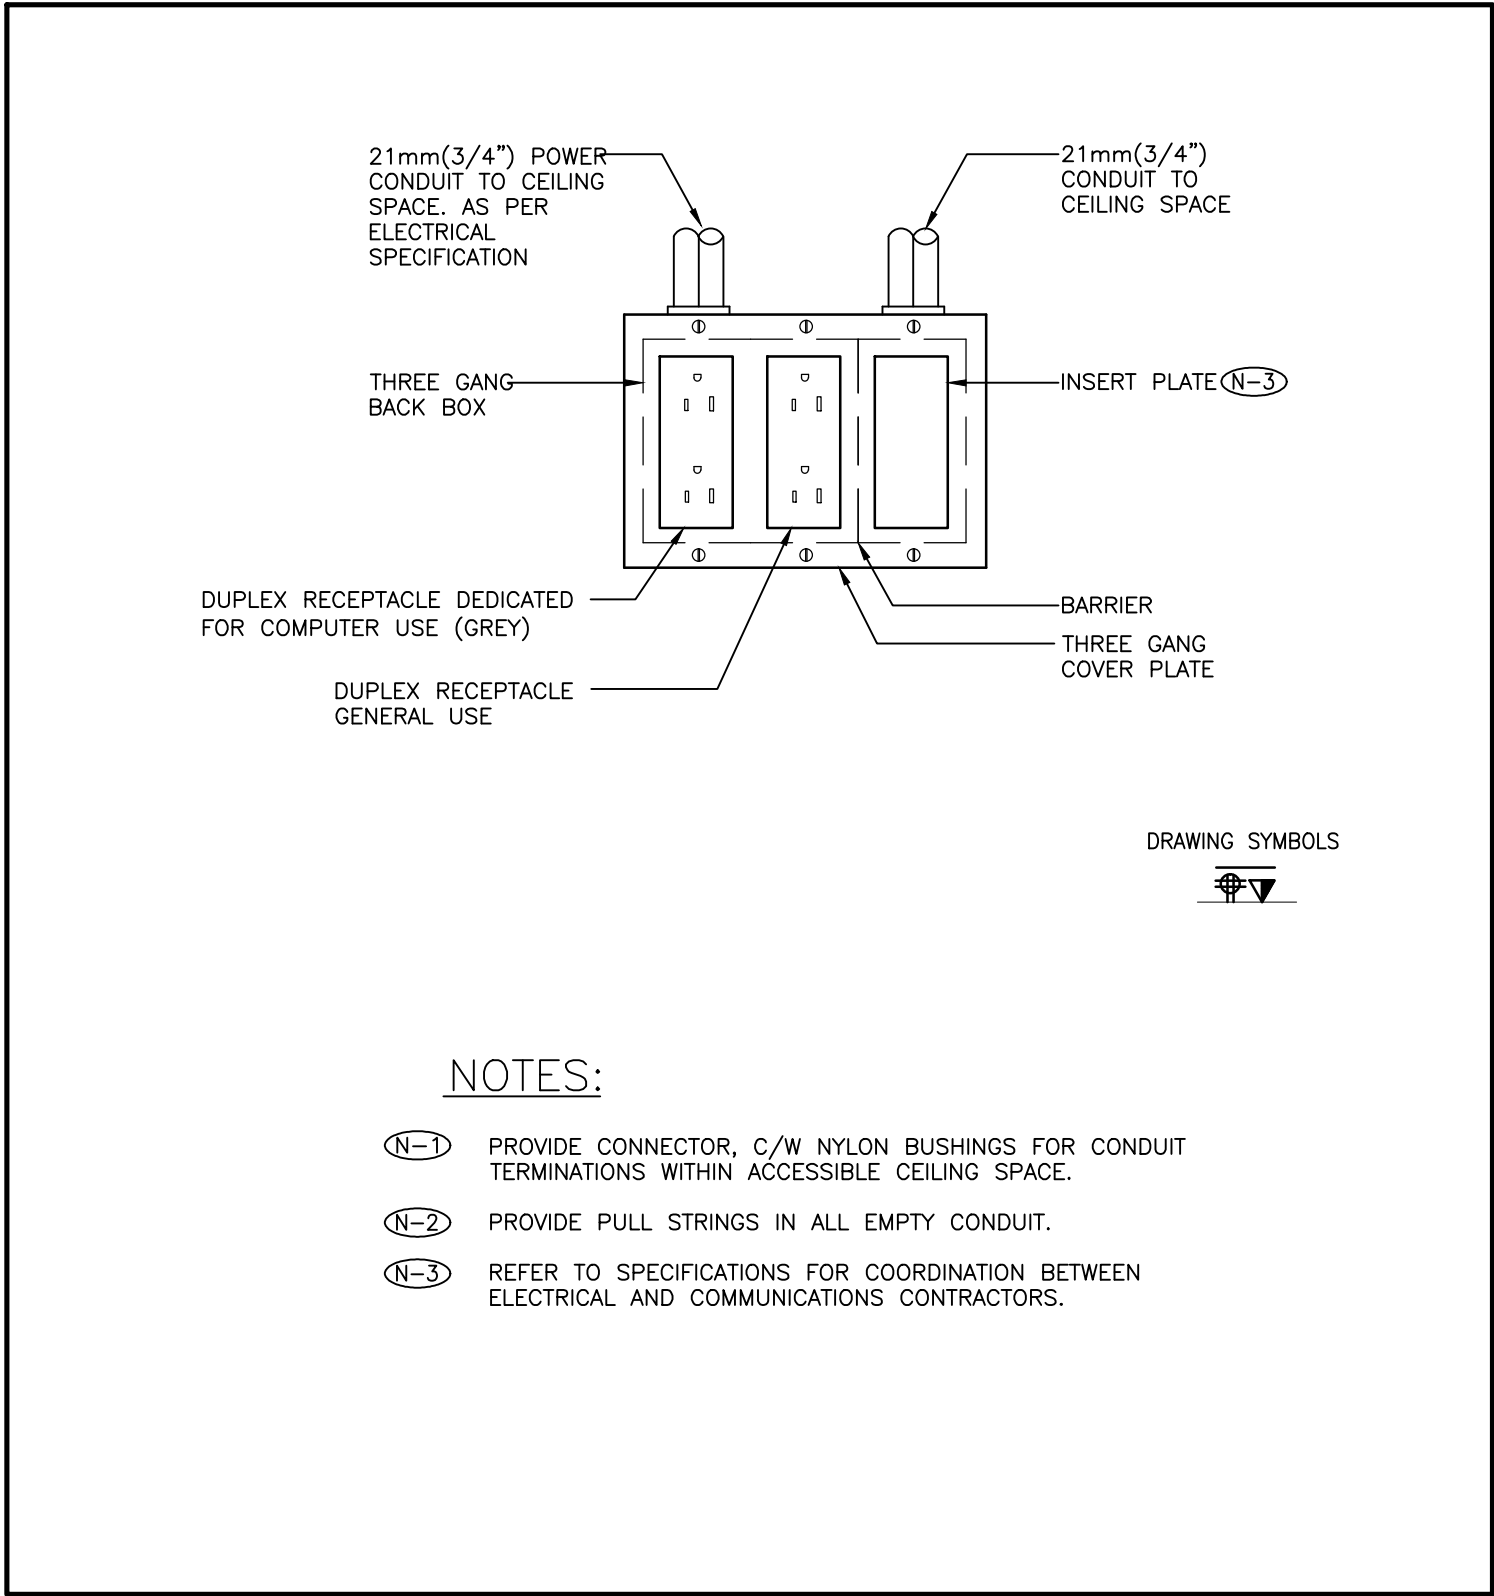


3 TYPICAL GANGED DUPLEX AND DATA OUTLET
SCALE: N.T.S.

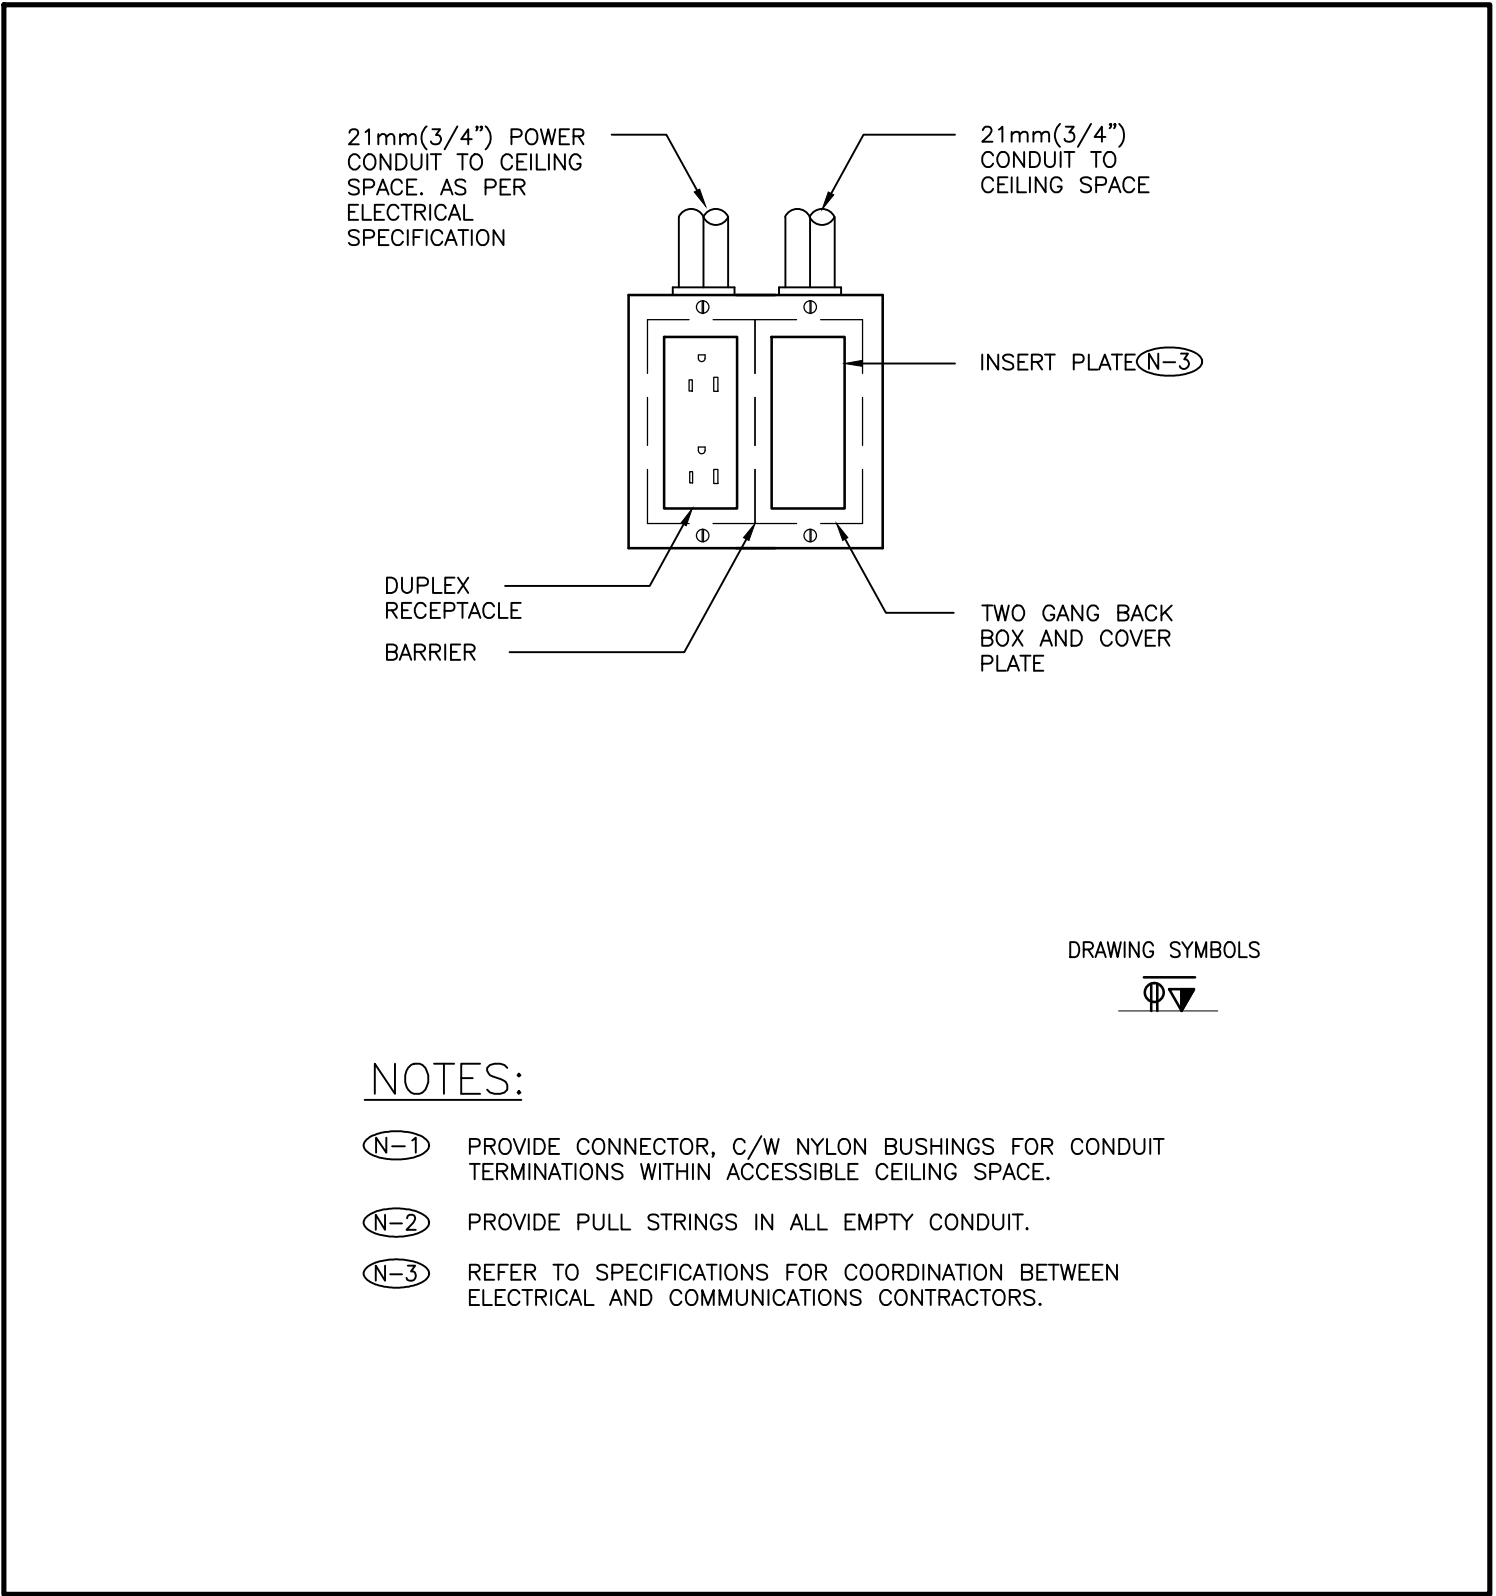


1 TYPICAL DUPLEX RECEPTACLE AND DATA OUTLET DETAIL
SCALE: N.T.S.

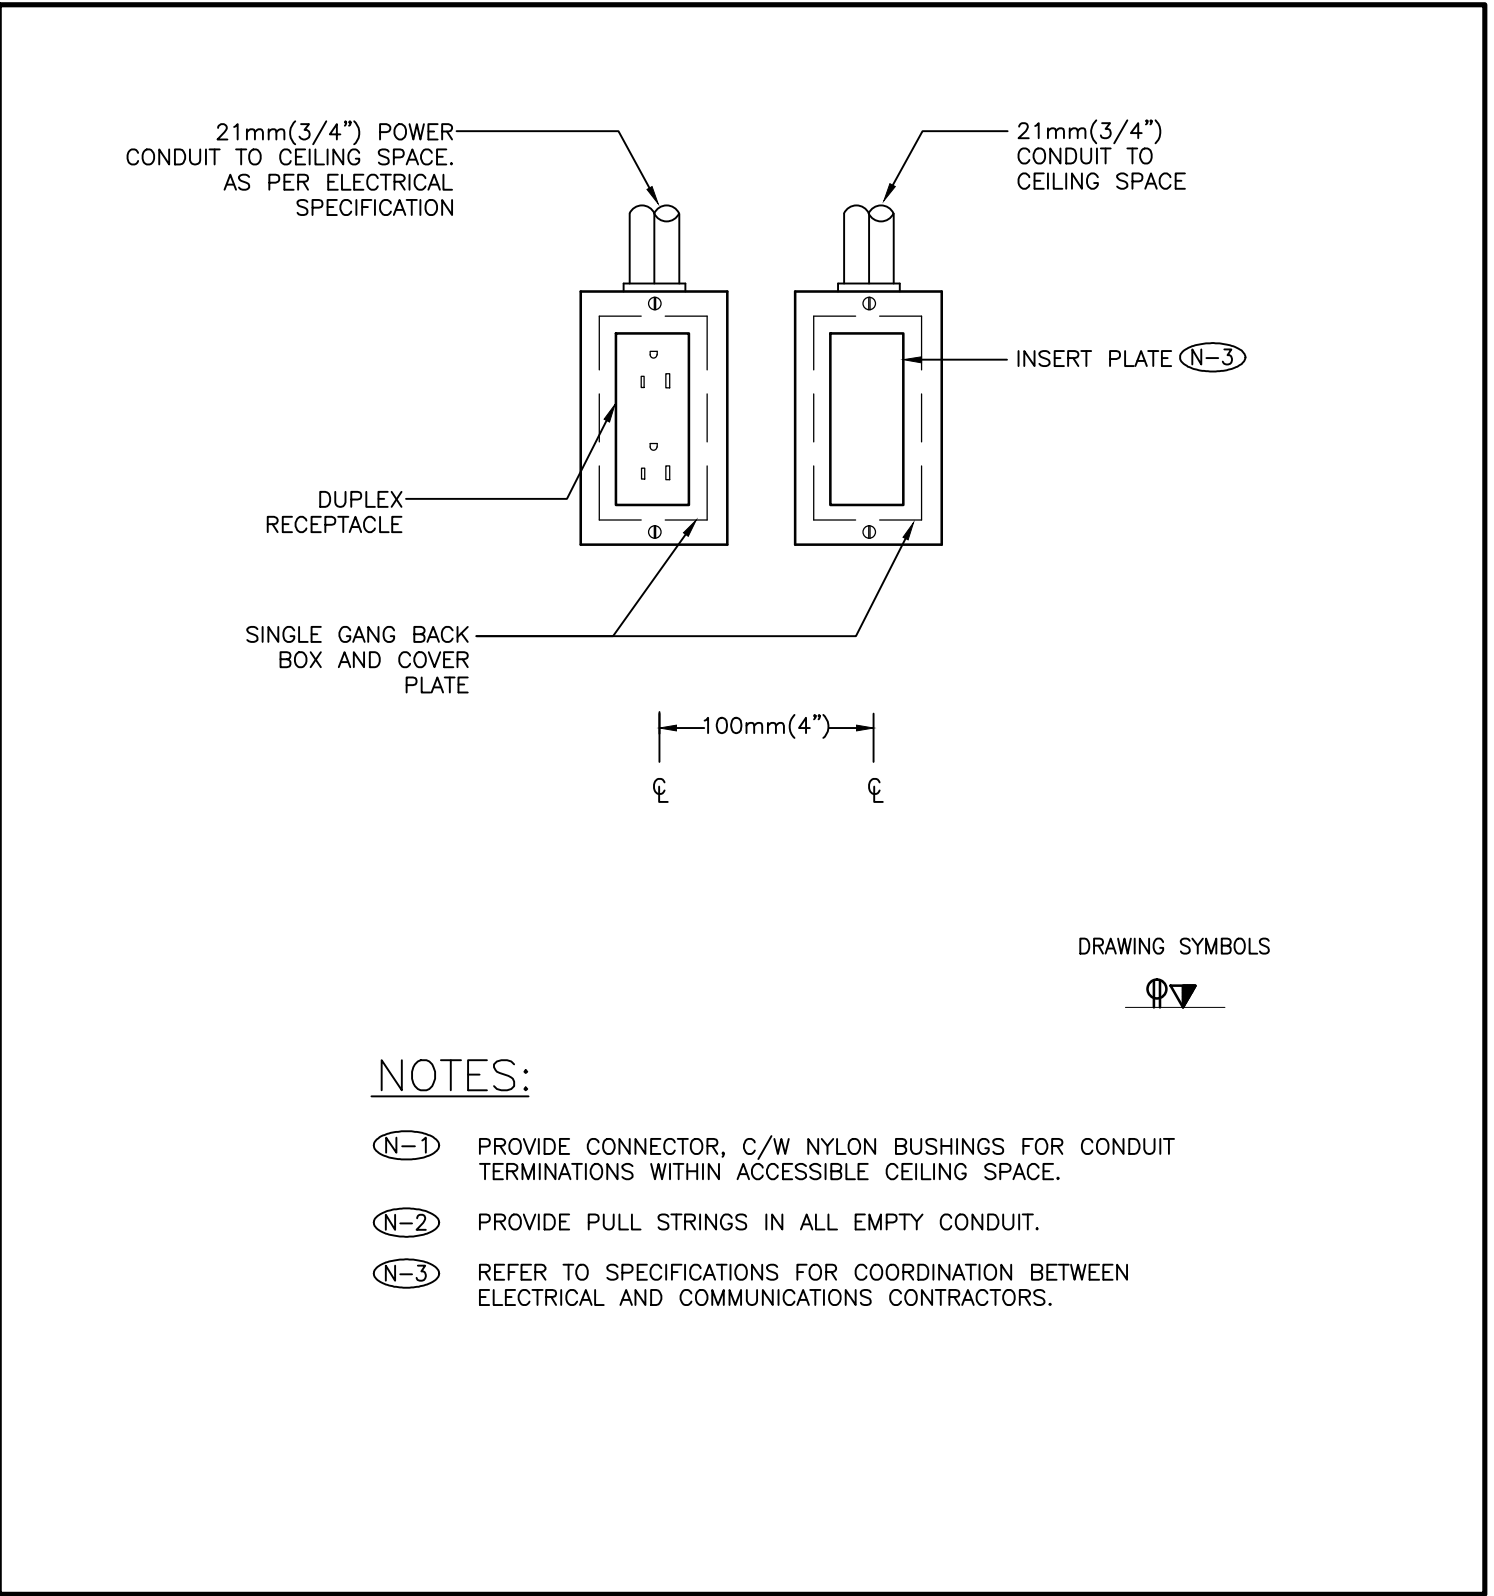

6 RESERVED
SCALE: N.T.S.

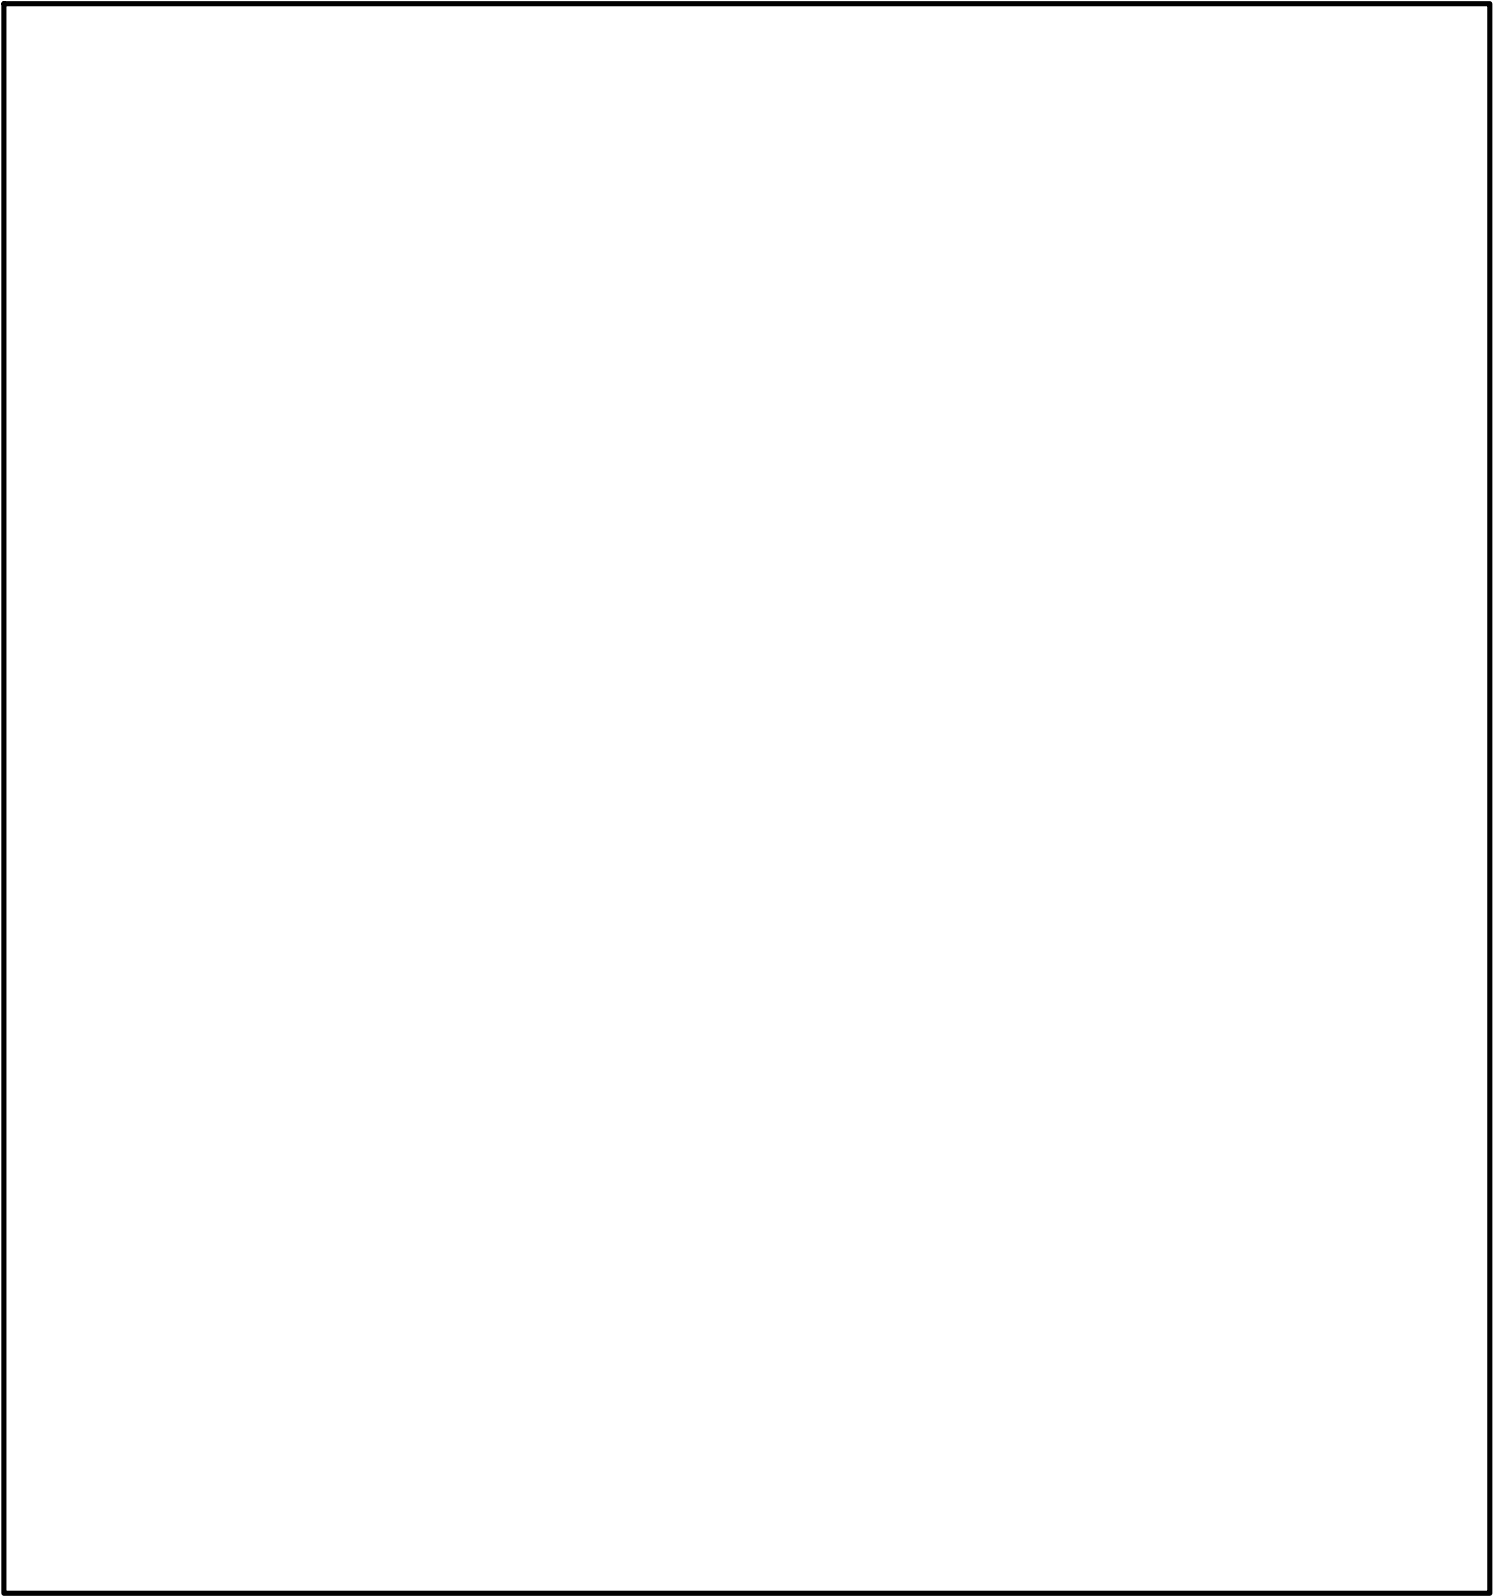

4 RESERVED.
SCALE: N.T.S.

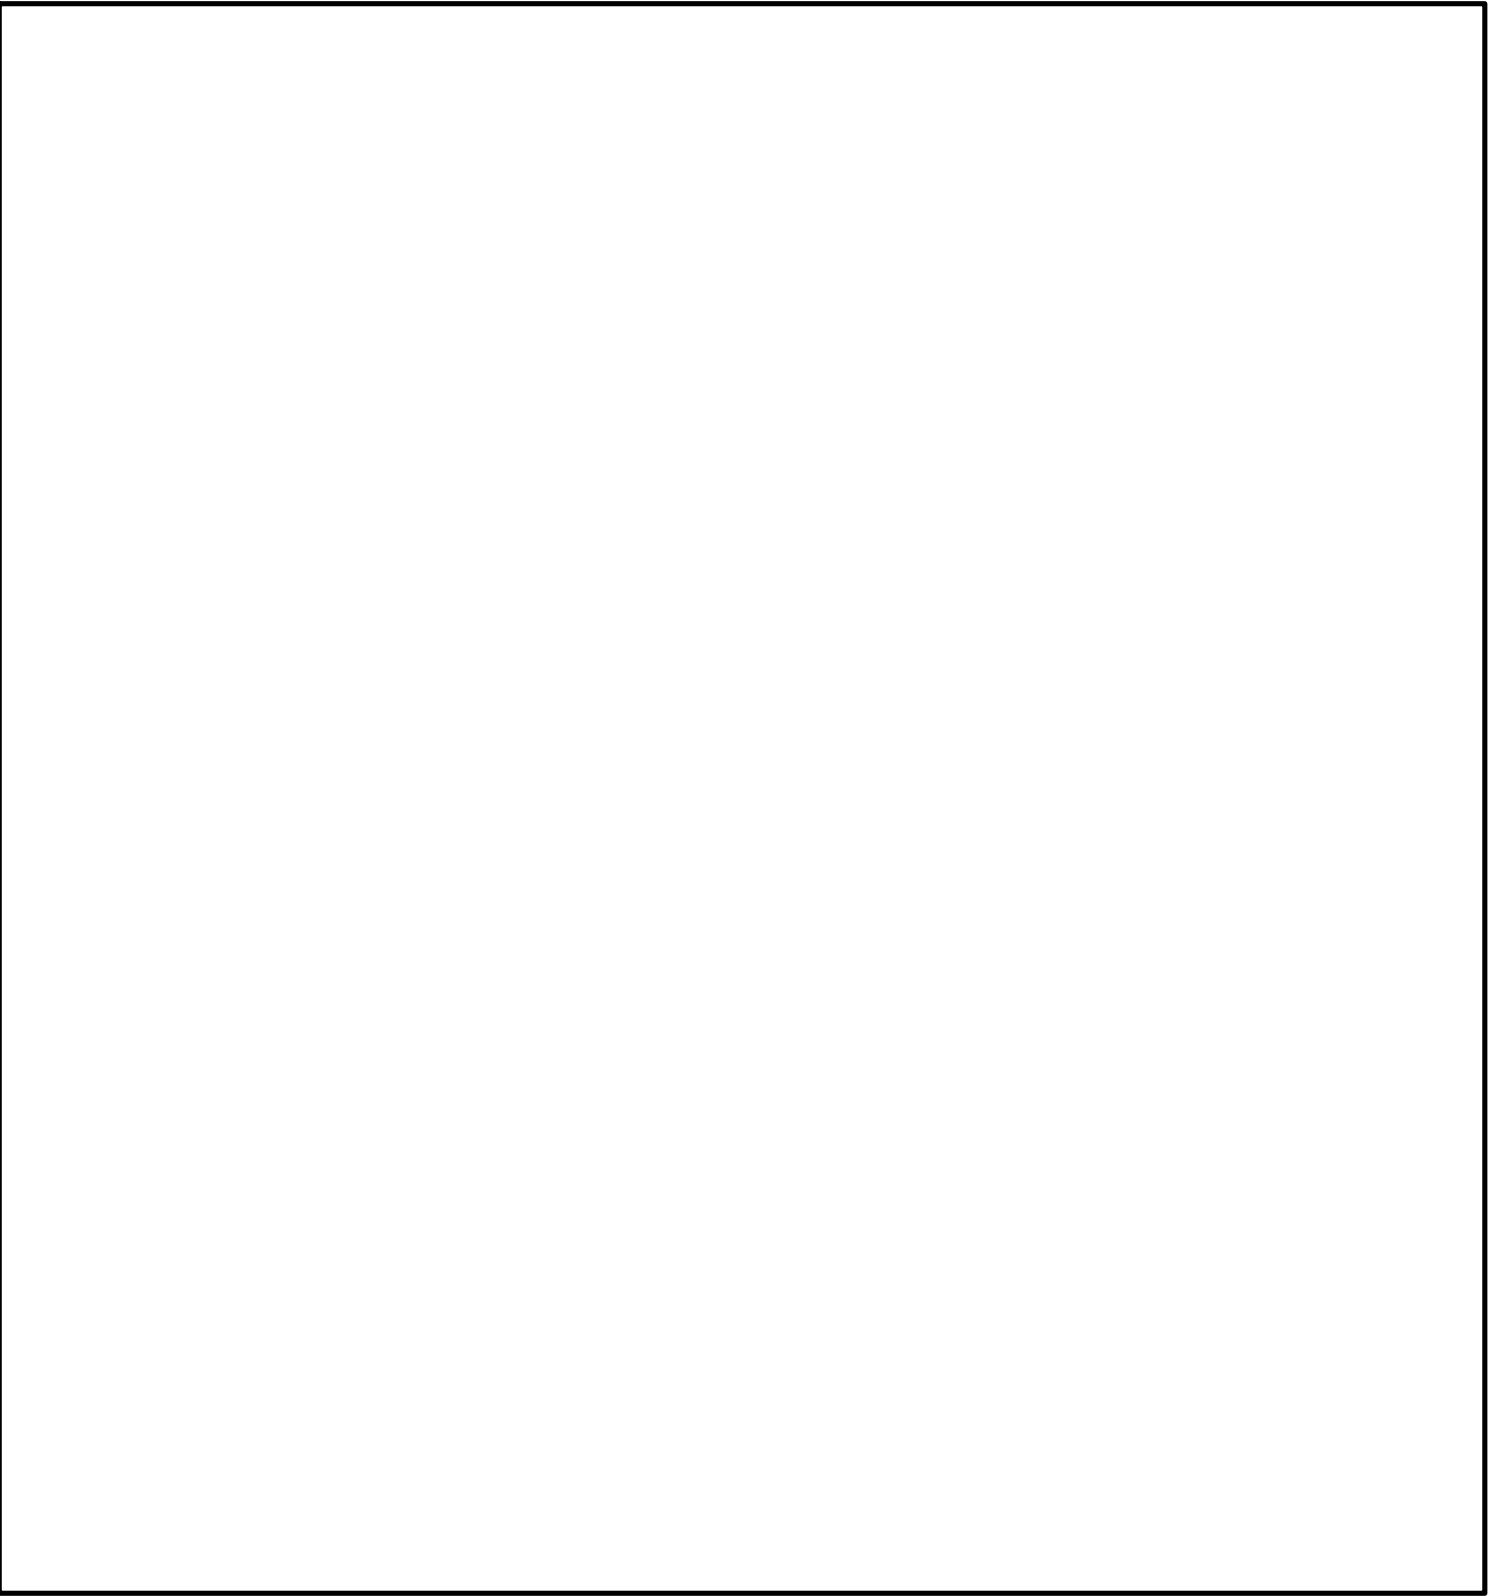

2 RESERVED.
SCALE: N.T.S.

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no.	description	date

project
projet

PHASE 1A BUILDING
DEMOLITION AND SITE
REMEDIATION

drawing
dessin

ELECTRICAL DETAILS

approved by
approuvé par A.D.

designed by
conçu par M.M.


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date
Sep. 30, 15

scale
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E002



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GENERAL NOTES

1. FOLLOW ALL REQUIREMENTS FOR HANDLING AND DISPOSAL OF HAZARDOUS MATERIALS, INCLUDING BUT NOT LIMITED TO FLUORESCENT TUBES, BALLASTS, BATTERIES, AND THERMOSTATS. SEE DESIGNATED SUBSTANCE SPECIFICATION 024199.
2. REFER TO WASTE AUDIT FOR DEMOLITION REQUIREMENTS.

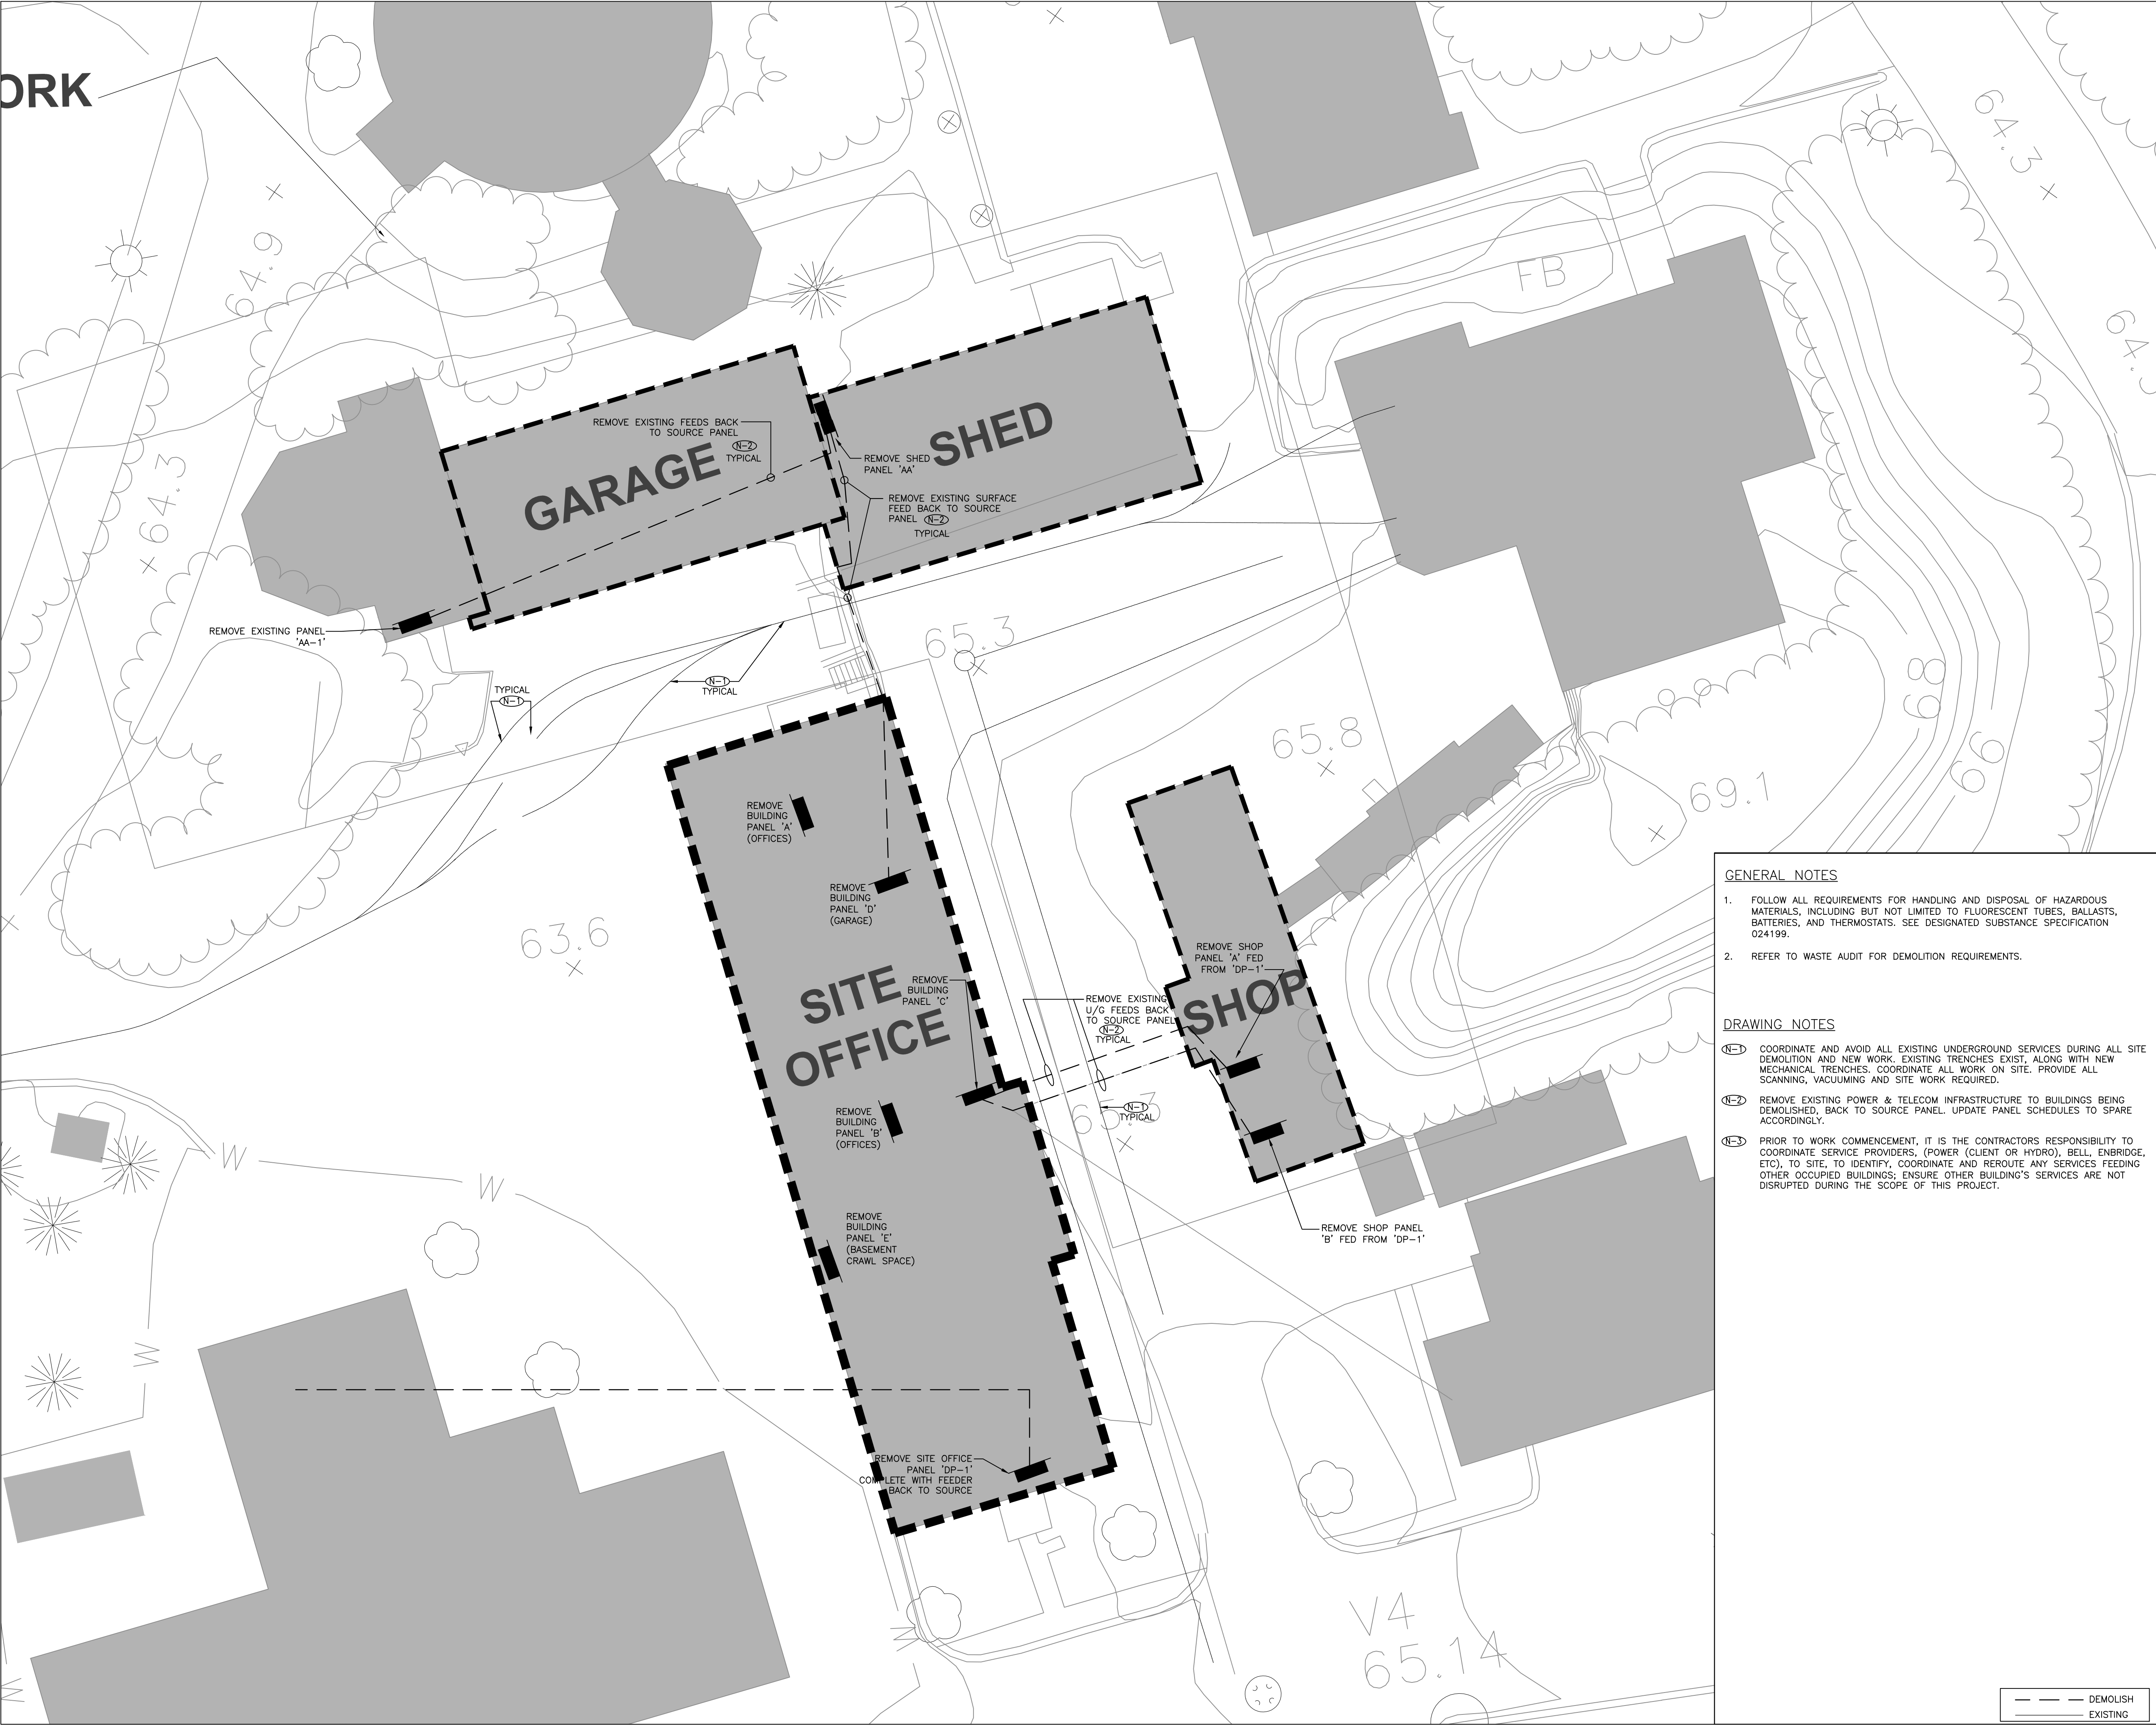DRAWING NOTES

- (N-1) COORDINATE AND AVOID ALL EXISTING UNDERGROUND SERVICES DURING ALL SITE DEMOLITION AND NEW WORK. EXISTING TRENCHES EXIST, ALONG WITH NEW MECHANICAL TRENCHES. COORDINATE ALL WORK ON SITE. PROVIDE ALL SCANNING, VACUUMING AND SITE WORK REQUIRED.
- (N-2) REMOVE EXISTING POWER & TELECOM INFRASTRUCTURE TO BUILDINGS BEING DEMOLISHED, BACK TO SOURCE PANEL. UPDATE PANEL SCHEDULES TO SPARE ACCORDINGLY.
- (N-3) PRIOR TO WORK COMMENCEMENT, IT IS THE CONTRACTORS RESPONSIBILITY TO COORDINATE SERVICE PROVIDERS, (POWER (CLIENT OR HYDRO), BELL, ENBRIDGE, ETC), TO SITE, TO IDENTIFY, COORDINATE AND REROUTE ANY SERVICES FEEDING OTHER OCCUPIED BUILDINGS; ENSURE OTHER BUILDING'S SERVICES ARE NOT DISRUPTED DURING THE SCOPE OF THIS PROJECT.

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PHASE 1A BUILDING
DEMOLITION AND SITE
REMEDICATION

drawing
dessin

ELECTRICAL SITE PLAN


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designed by conçu par M.M.		
drawn by dessiné par M.M.		
date	Sep. 30, 15	scale échelle 1:150

13053.002

E100

DRAWING NOTES:

- (N-1) REMOVE ALL ELECTRICAL EQUIPMENT INDICATED, COMPLETE WITH ALL CONDUIT AND WIRING. ENSURE TO DISCONNECT AND MAKE SAFE PRIOR TO REMOVAL. COORDINATE AND ENSURE EXISTING BURIED SERVICES (INCLUDING ELECTRICAL) ARE NOT AFFECTED/DAMAGED DURING EXCAVATION.
- (N-2) DISCONNECT POWER AT THE SOURCE PRIOR TO COMMENCEMENT OF DEMOLITION. COORDINATE SHUT-DOWN WITH THE CLIENT. REFER TO ELECTRICAL SITE PLAN.
- (N-3) DISCONNECT AND MAKE SAFE ALL ELECTRICAL, PRIOR TO DEMOLITION.

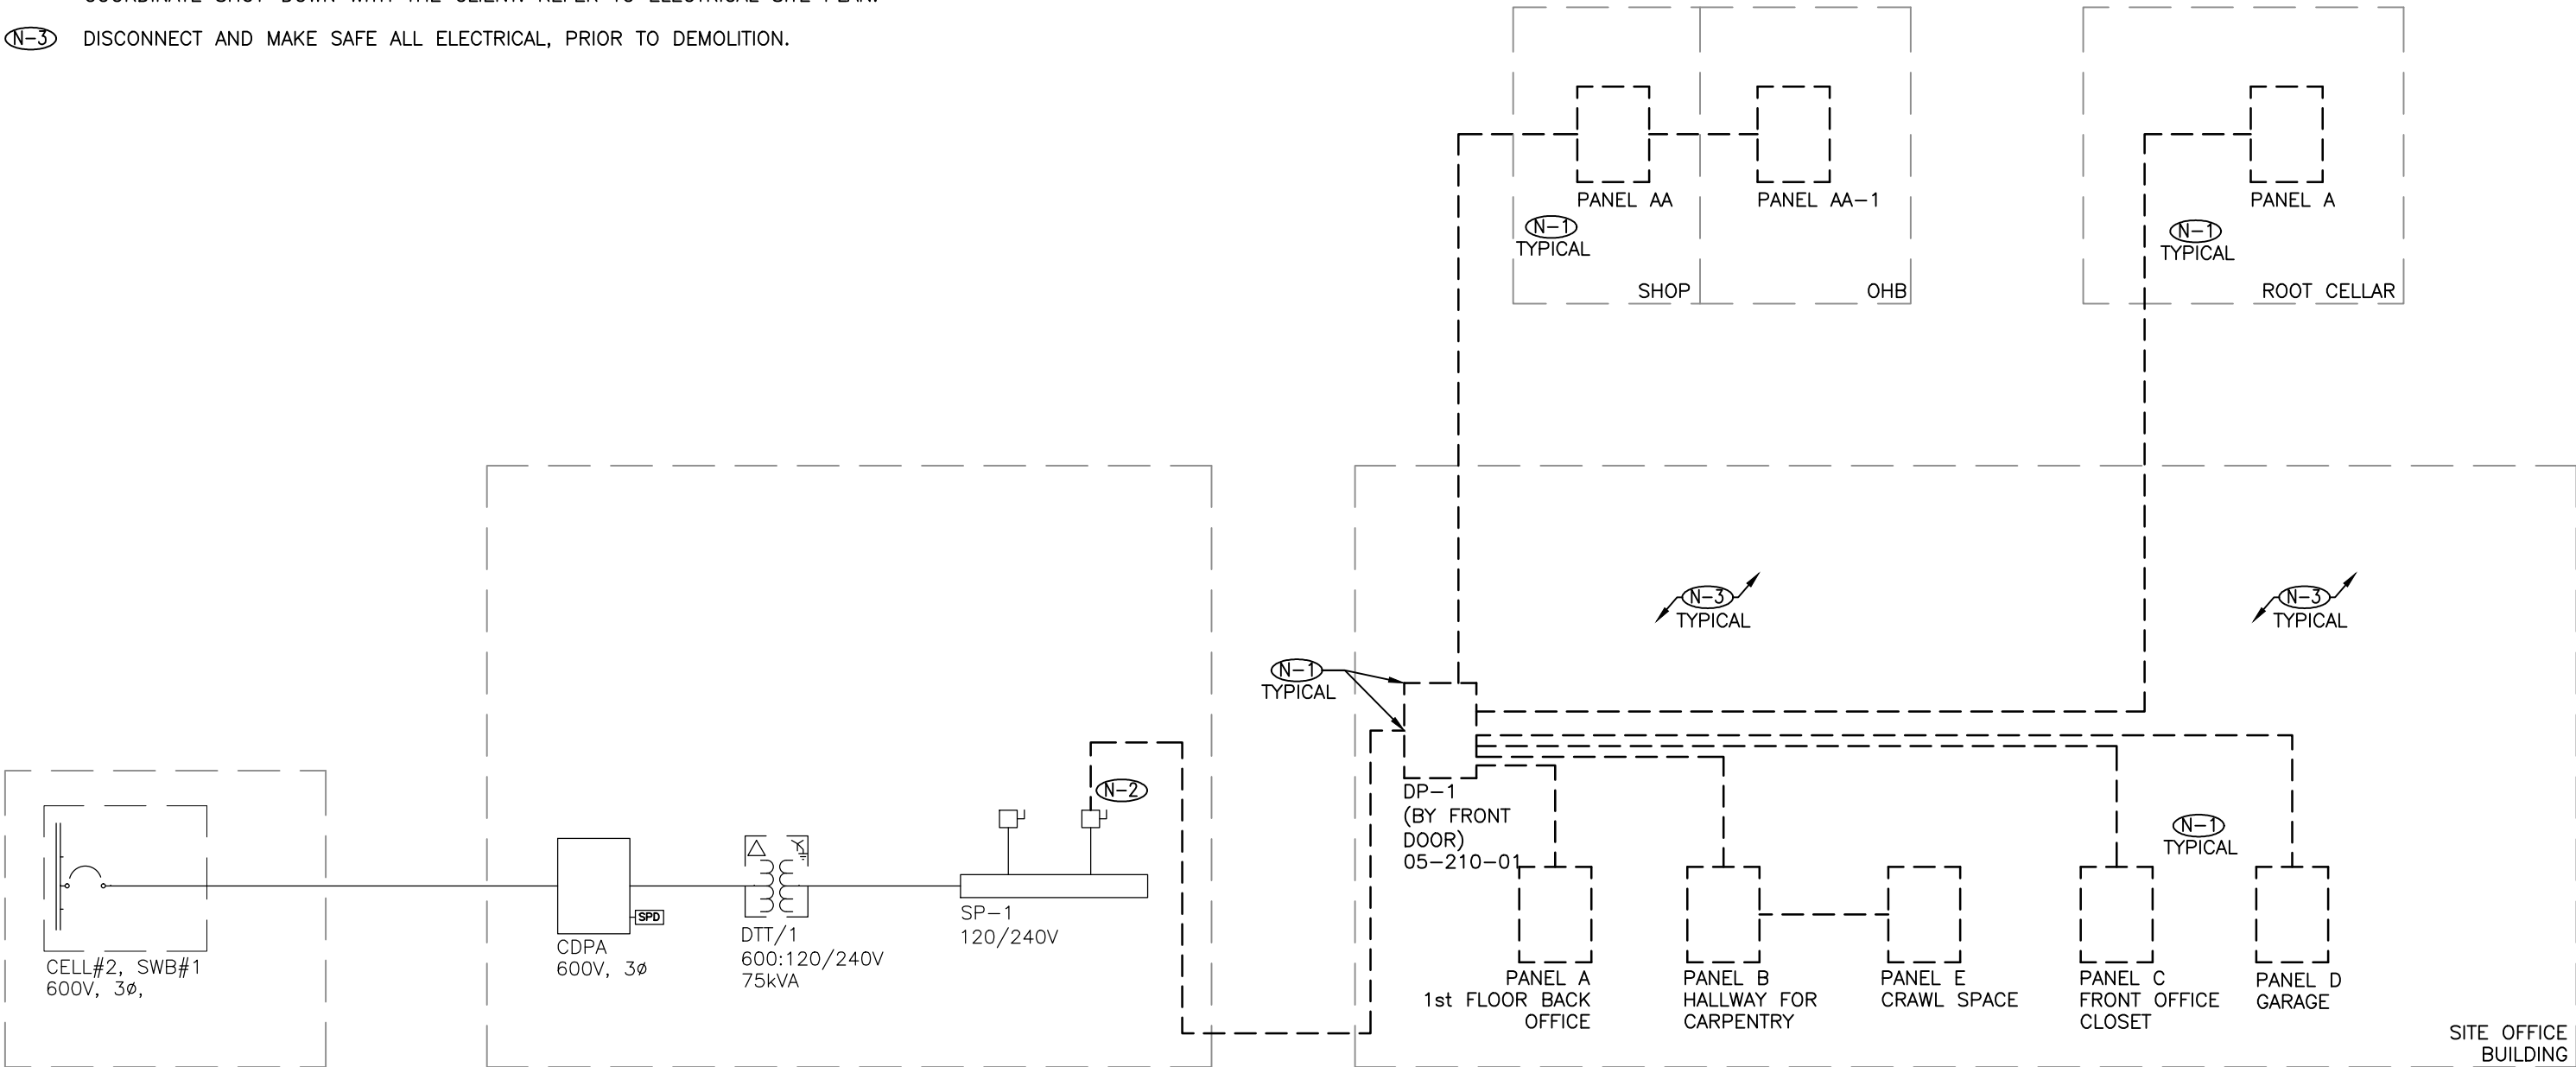

1
E200 ELECTRICAL DEMOLITION SINGLE LINE
SCALE: N.T.S.

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PHASE 1A BUILDING
DEMOLITION AND SITE
REMEDICATION

drawing
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ELECTRICAL SINGLE LINES

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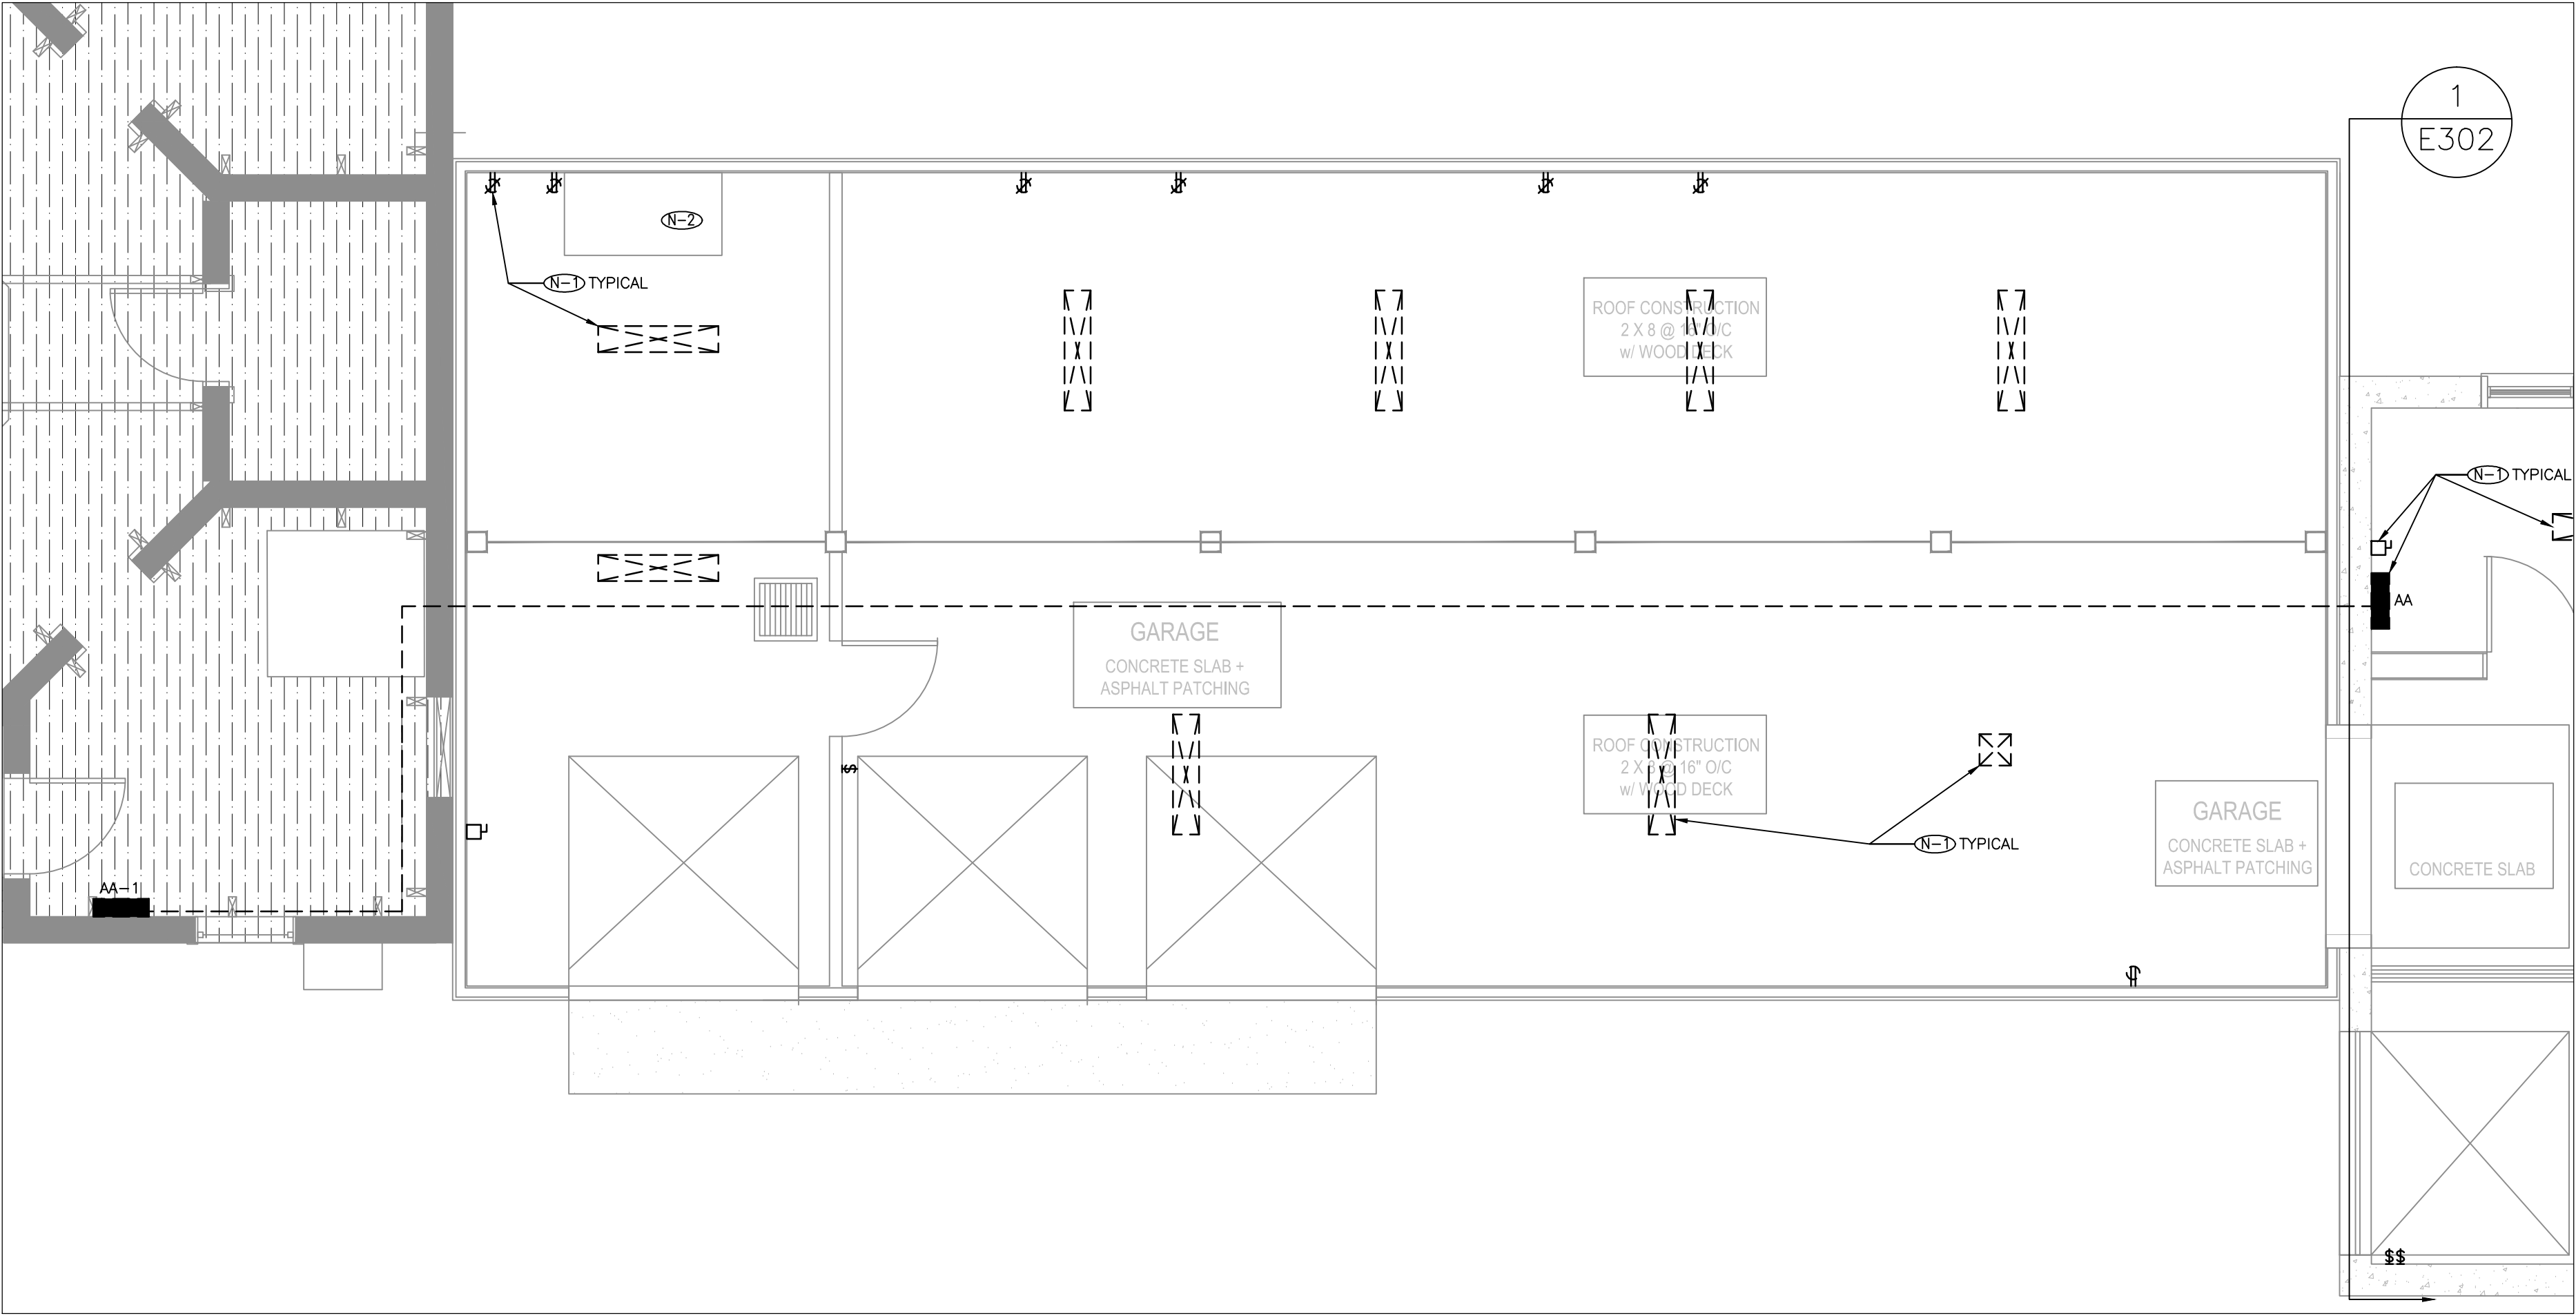
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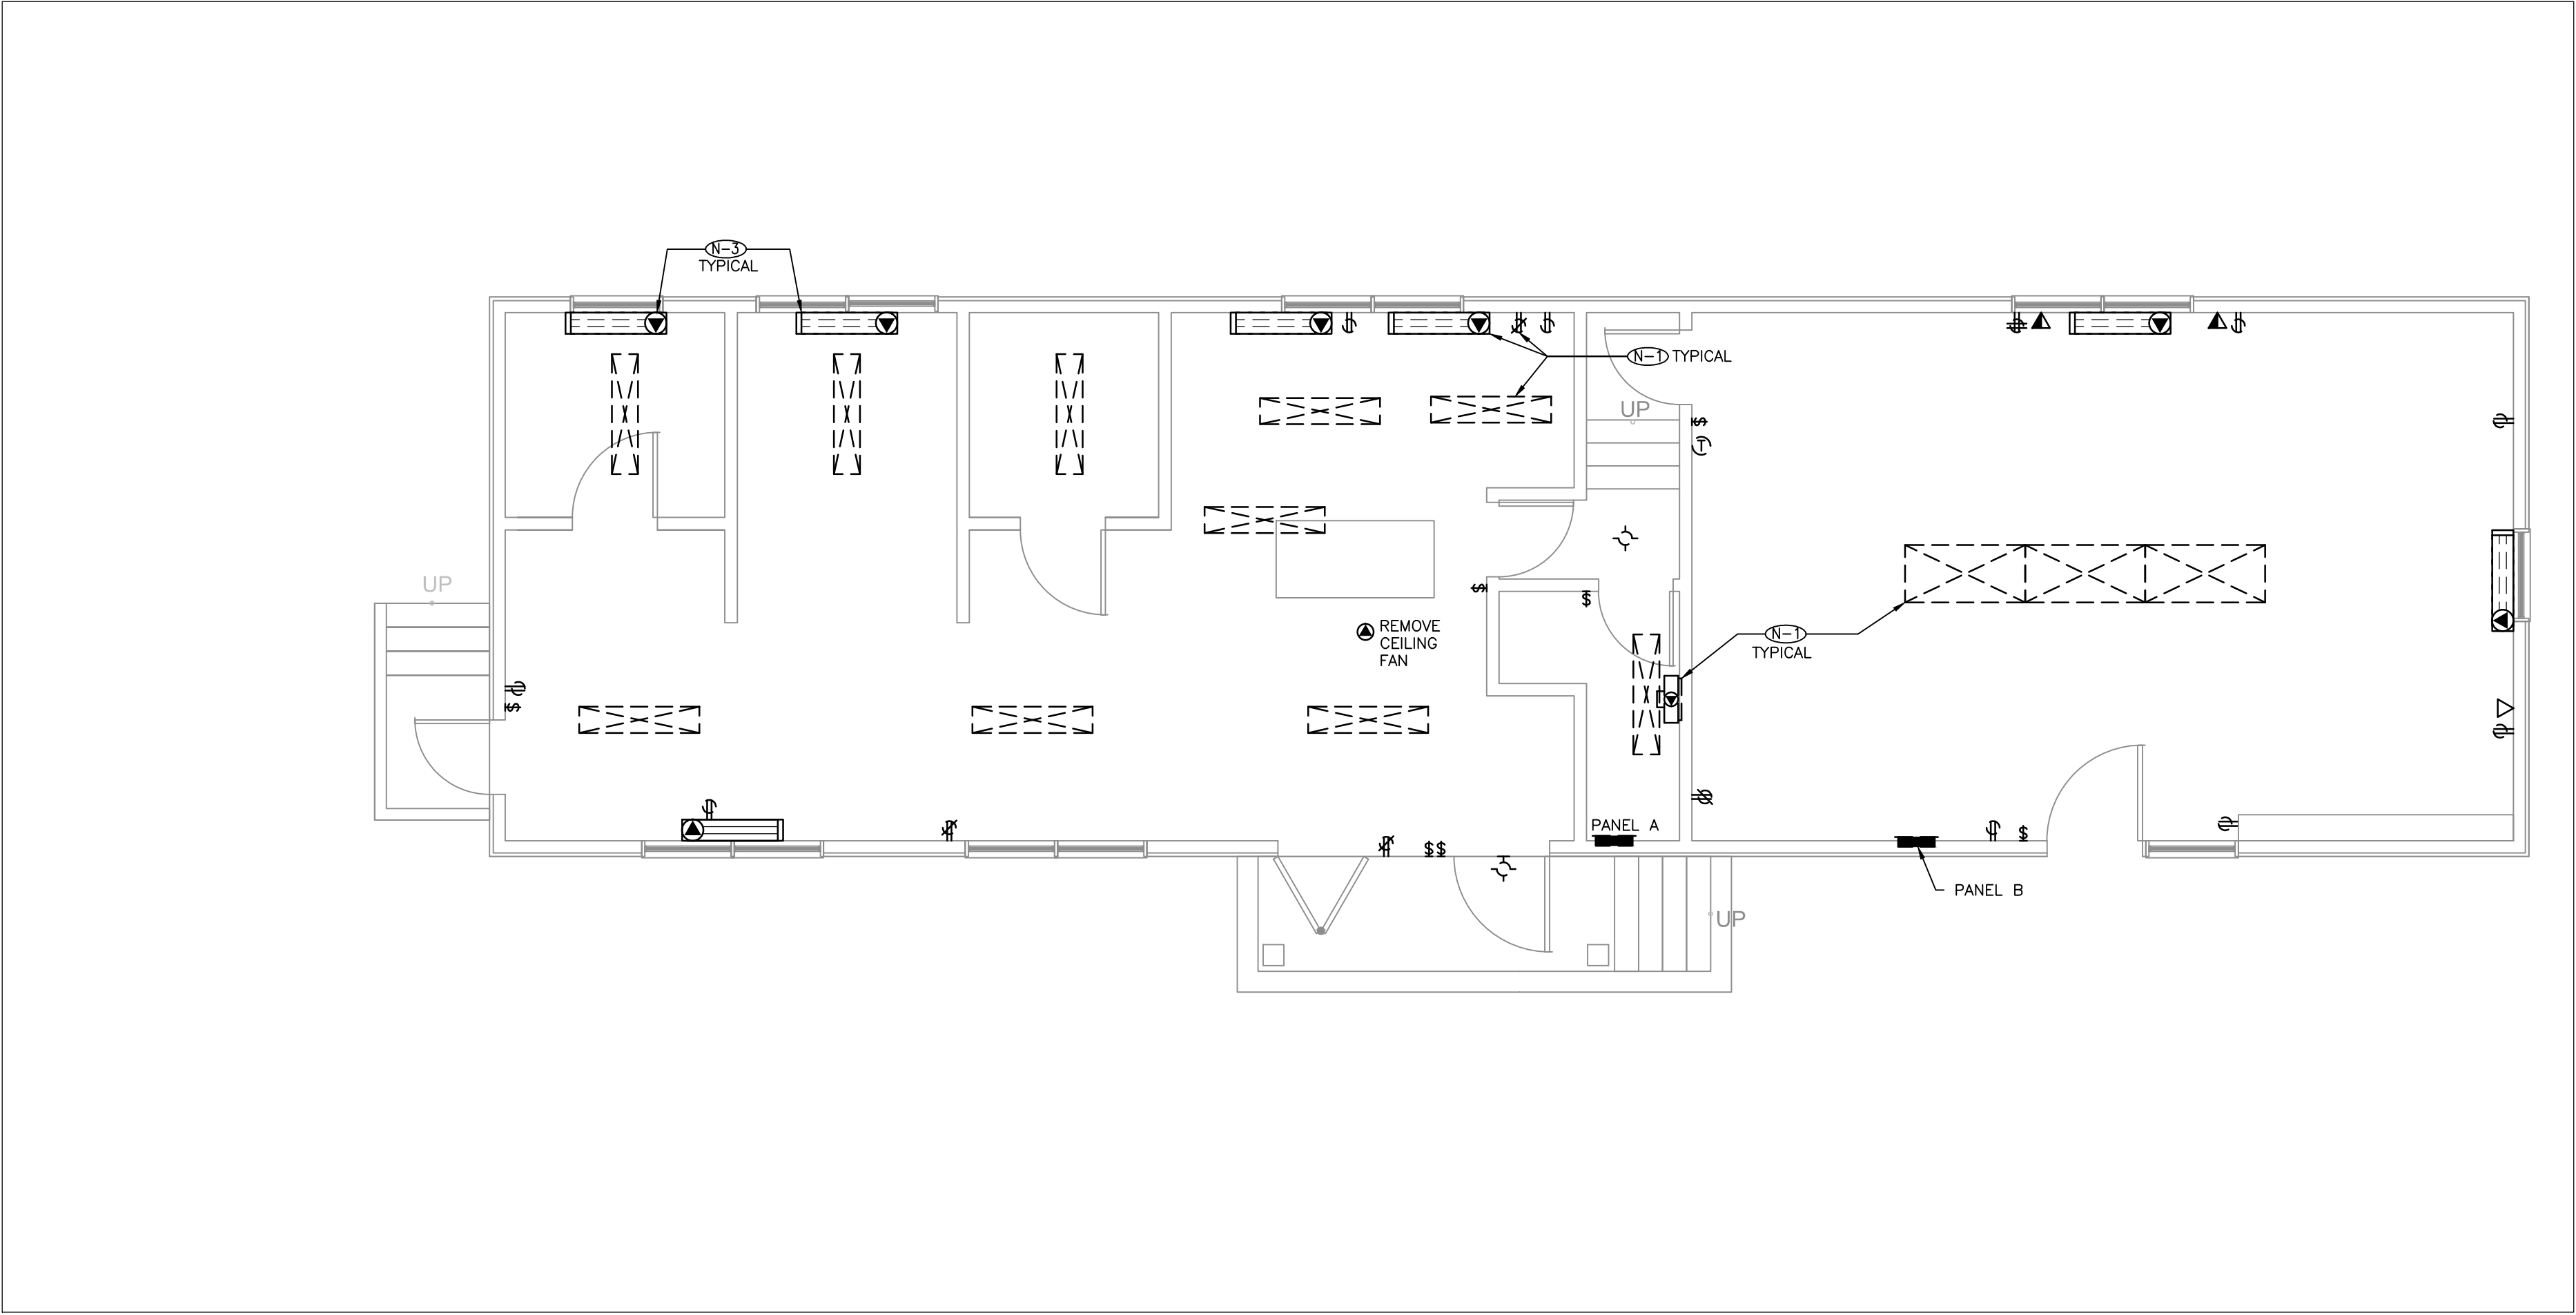
scale
échelle N.T.S.

13053.002

E200



1
E301
GARAGE FIRST FLOOR AS-FOUND DEMOLITION PLAN
1:50



2
E301
FLOOR PLAN SHOP – AS FOUND DEMOLITION PLAN
1:50

GENERAL NOTES

1. FOLLOW ALL REQUIREMENTS FOR HANDLING AND DISPOSAL OF HAZARDOUS MATERIALS, INCLUDING BUT NOT LIMITED TO FLUORESCENT TUBES, BALLASTS, BATTERIES, AND THERMOSTATS. SEE DESIGNATED SUBSTANCE SPECIFICATION 024199.
2. REFER TO WASTE AUDIT FOR DEMOLITION REQUIREMENTS.

DRAWING NOTES

- (N-1) REMOVE ALL EXISTING ELECTRICAL DEVICES, CONDUIT AND WIRING BACK TO SOURCE PANEL. MOST CONDUIT IS SURFACE RUN. ALLOW FOR REMOVAL OF ALL DEVICES, CONDUIT & WIRING MOUNTED AT HIGHER CEILING ELEVATIONS.
- (N-2) FLAMMABLE CABINET, REMOVAL BY OTHERS.
- (N-3) REMOVE BASEBOARD HEATERS, COMPLETE WITH CONDUIT AND WIRING.

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project
projet

PHASE 1A BUILDING
DEMOLITION AND SITE
REMEDIATION


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dessin

GARAGE AND SHOP


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approuvé par A.D.
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conçu par M.M.
drawn by
dessiné par M.M.
date Sep. 30, 15 scale
échelle AS NOTED

13053.002

E301

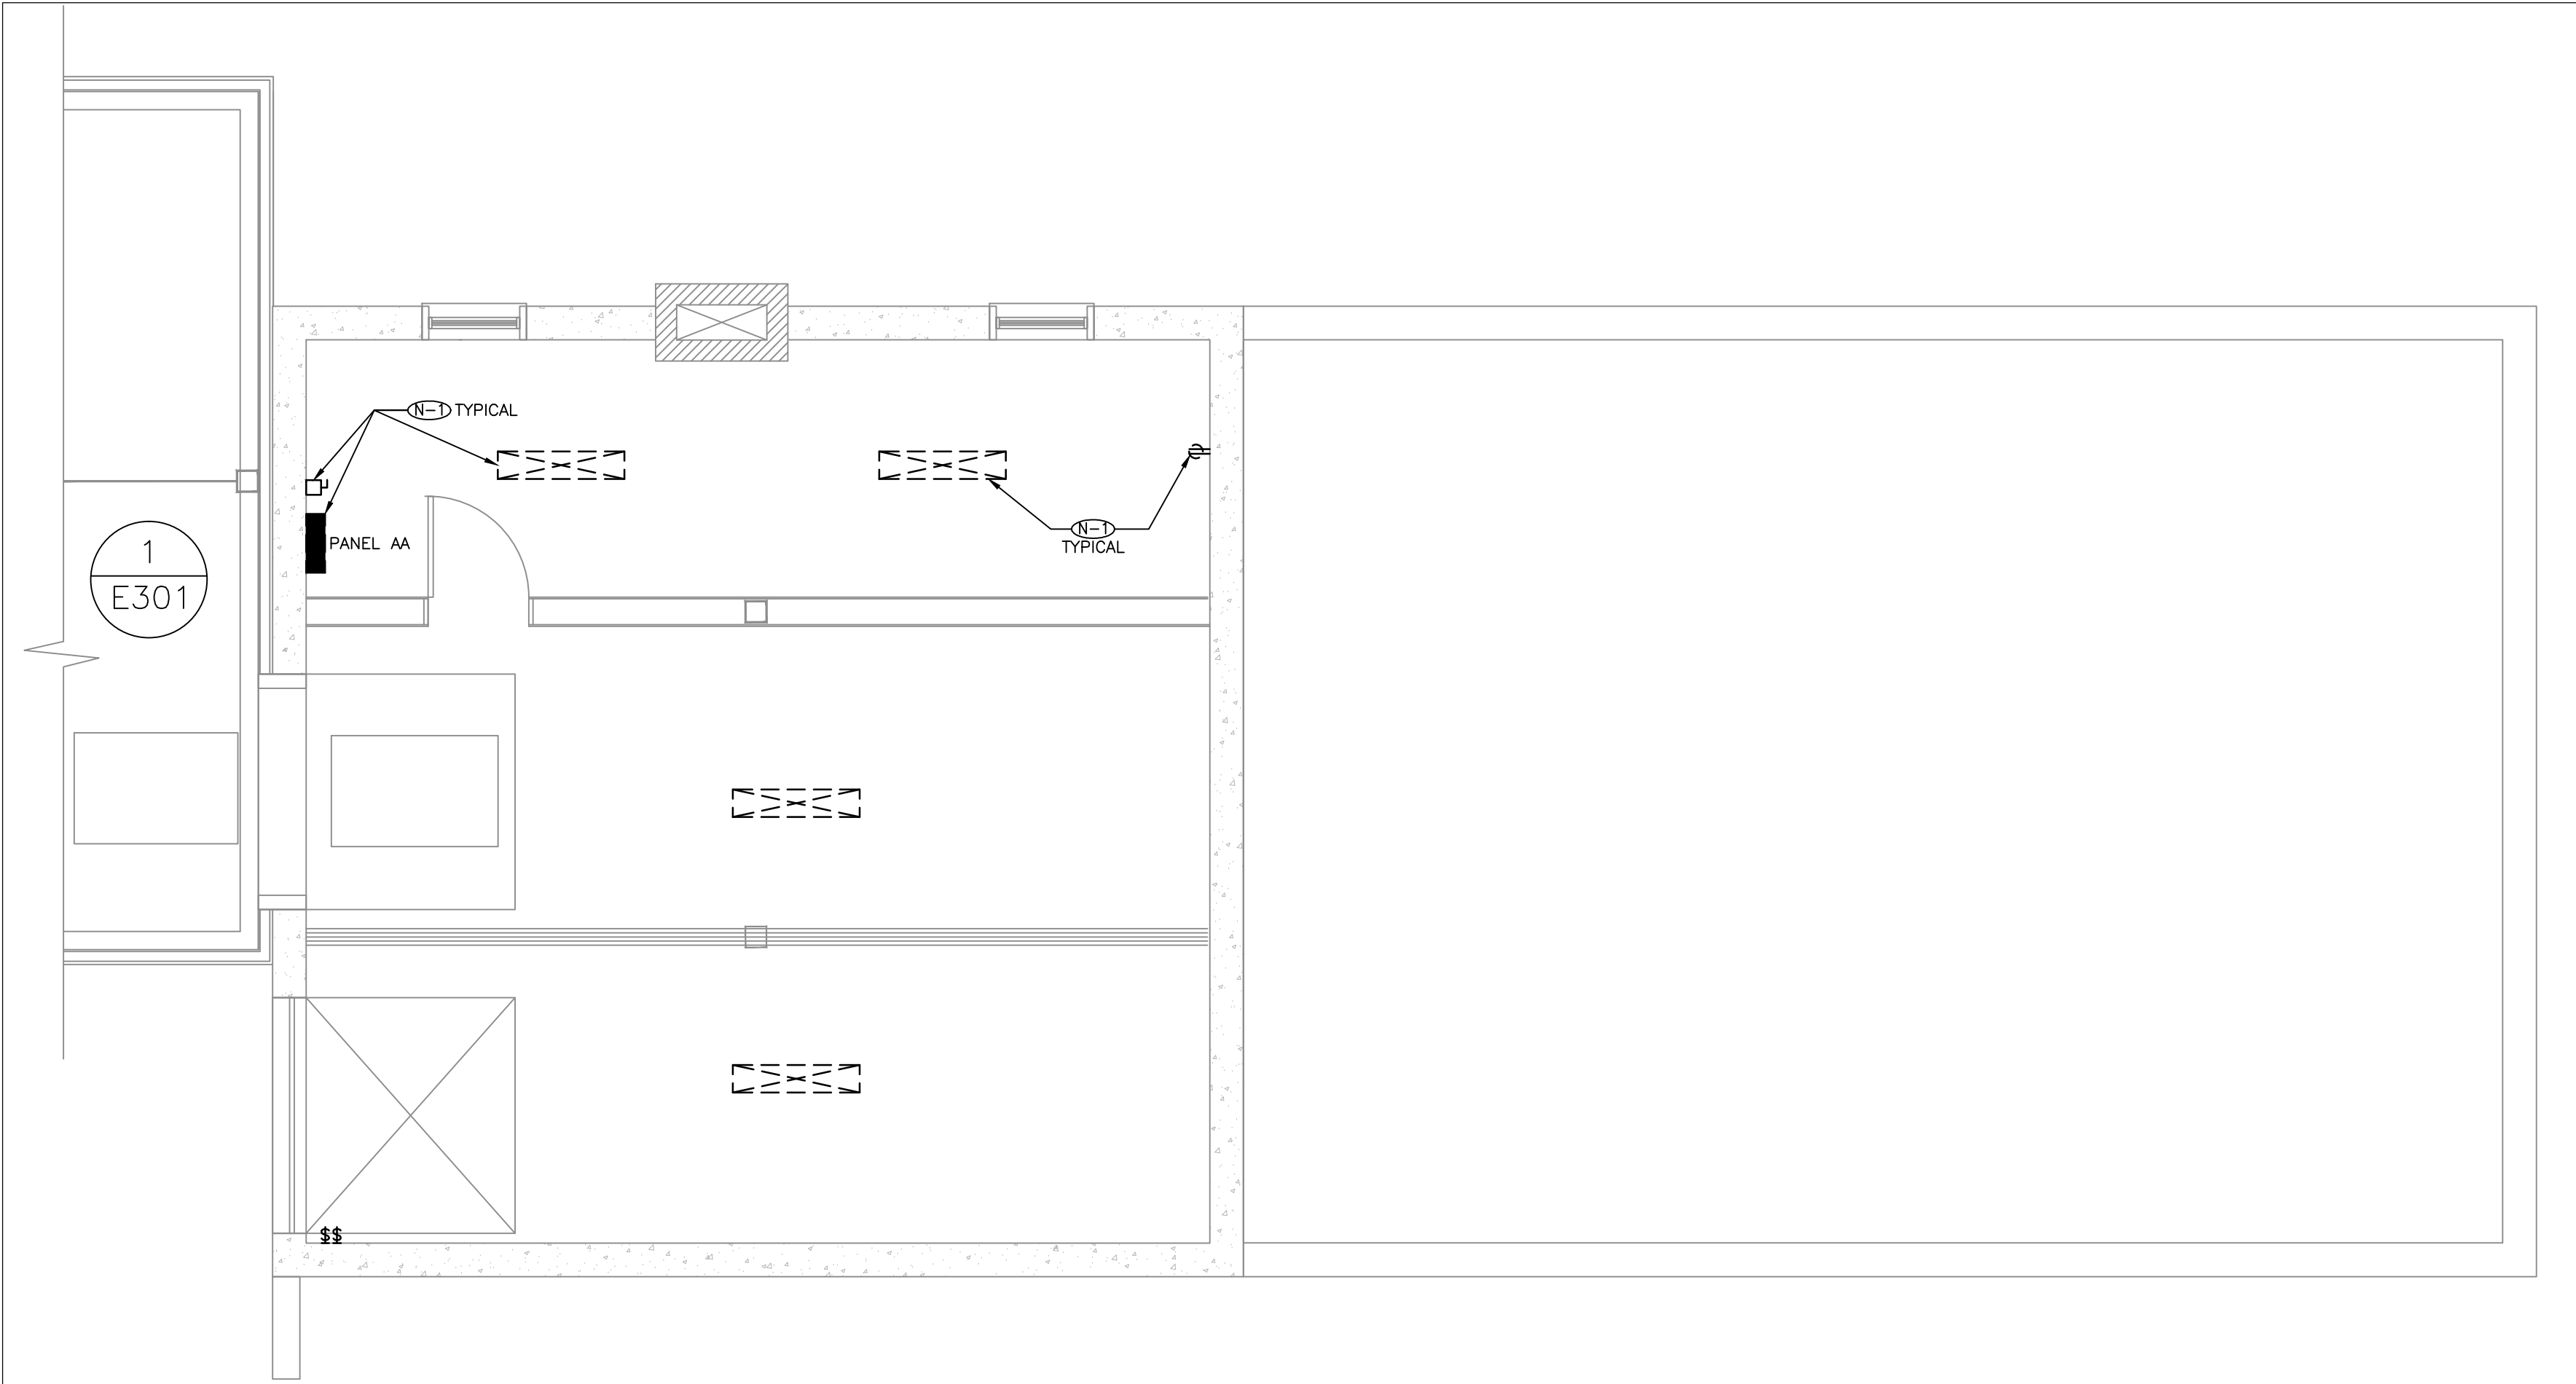

1 SHED BASEMENT PLAN – AS FOUND DEMOLITION
E302 1:50

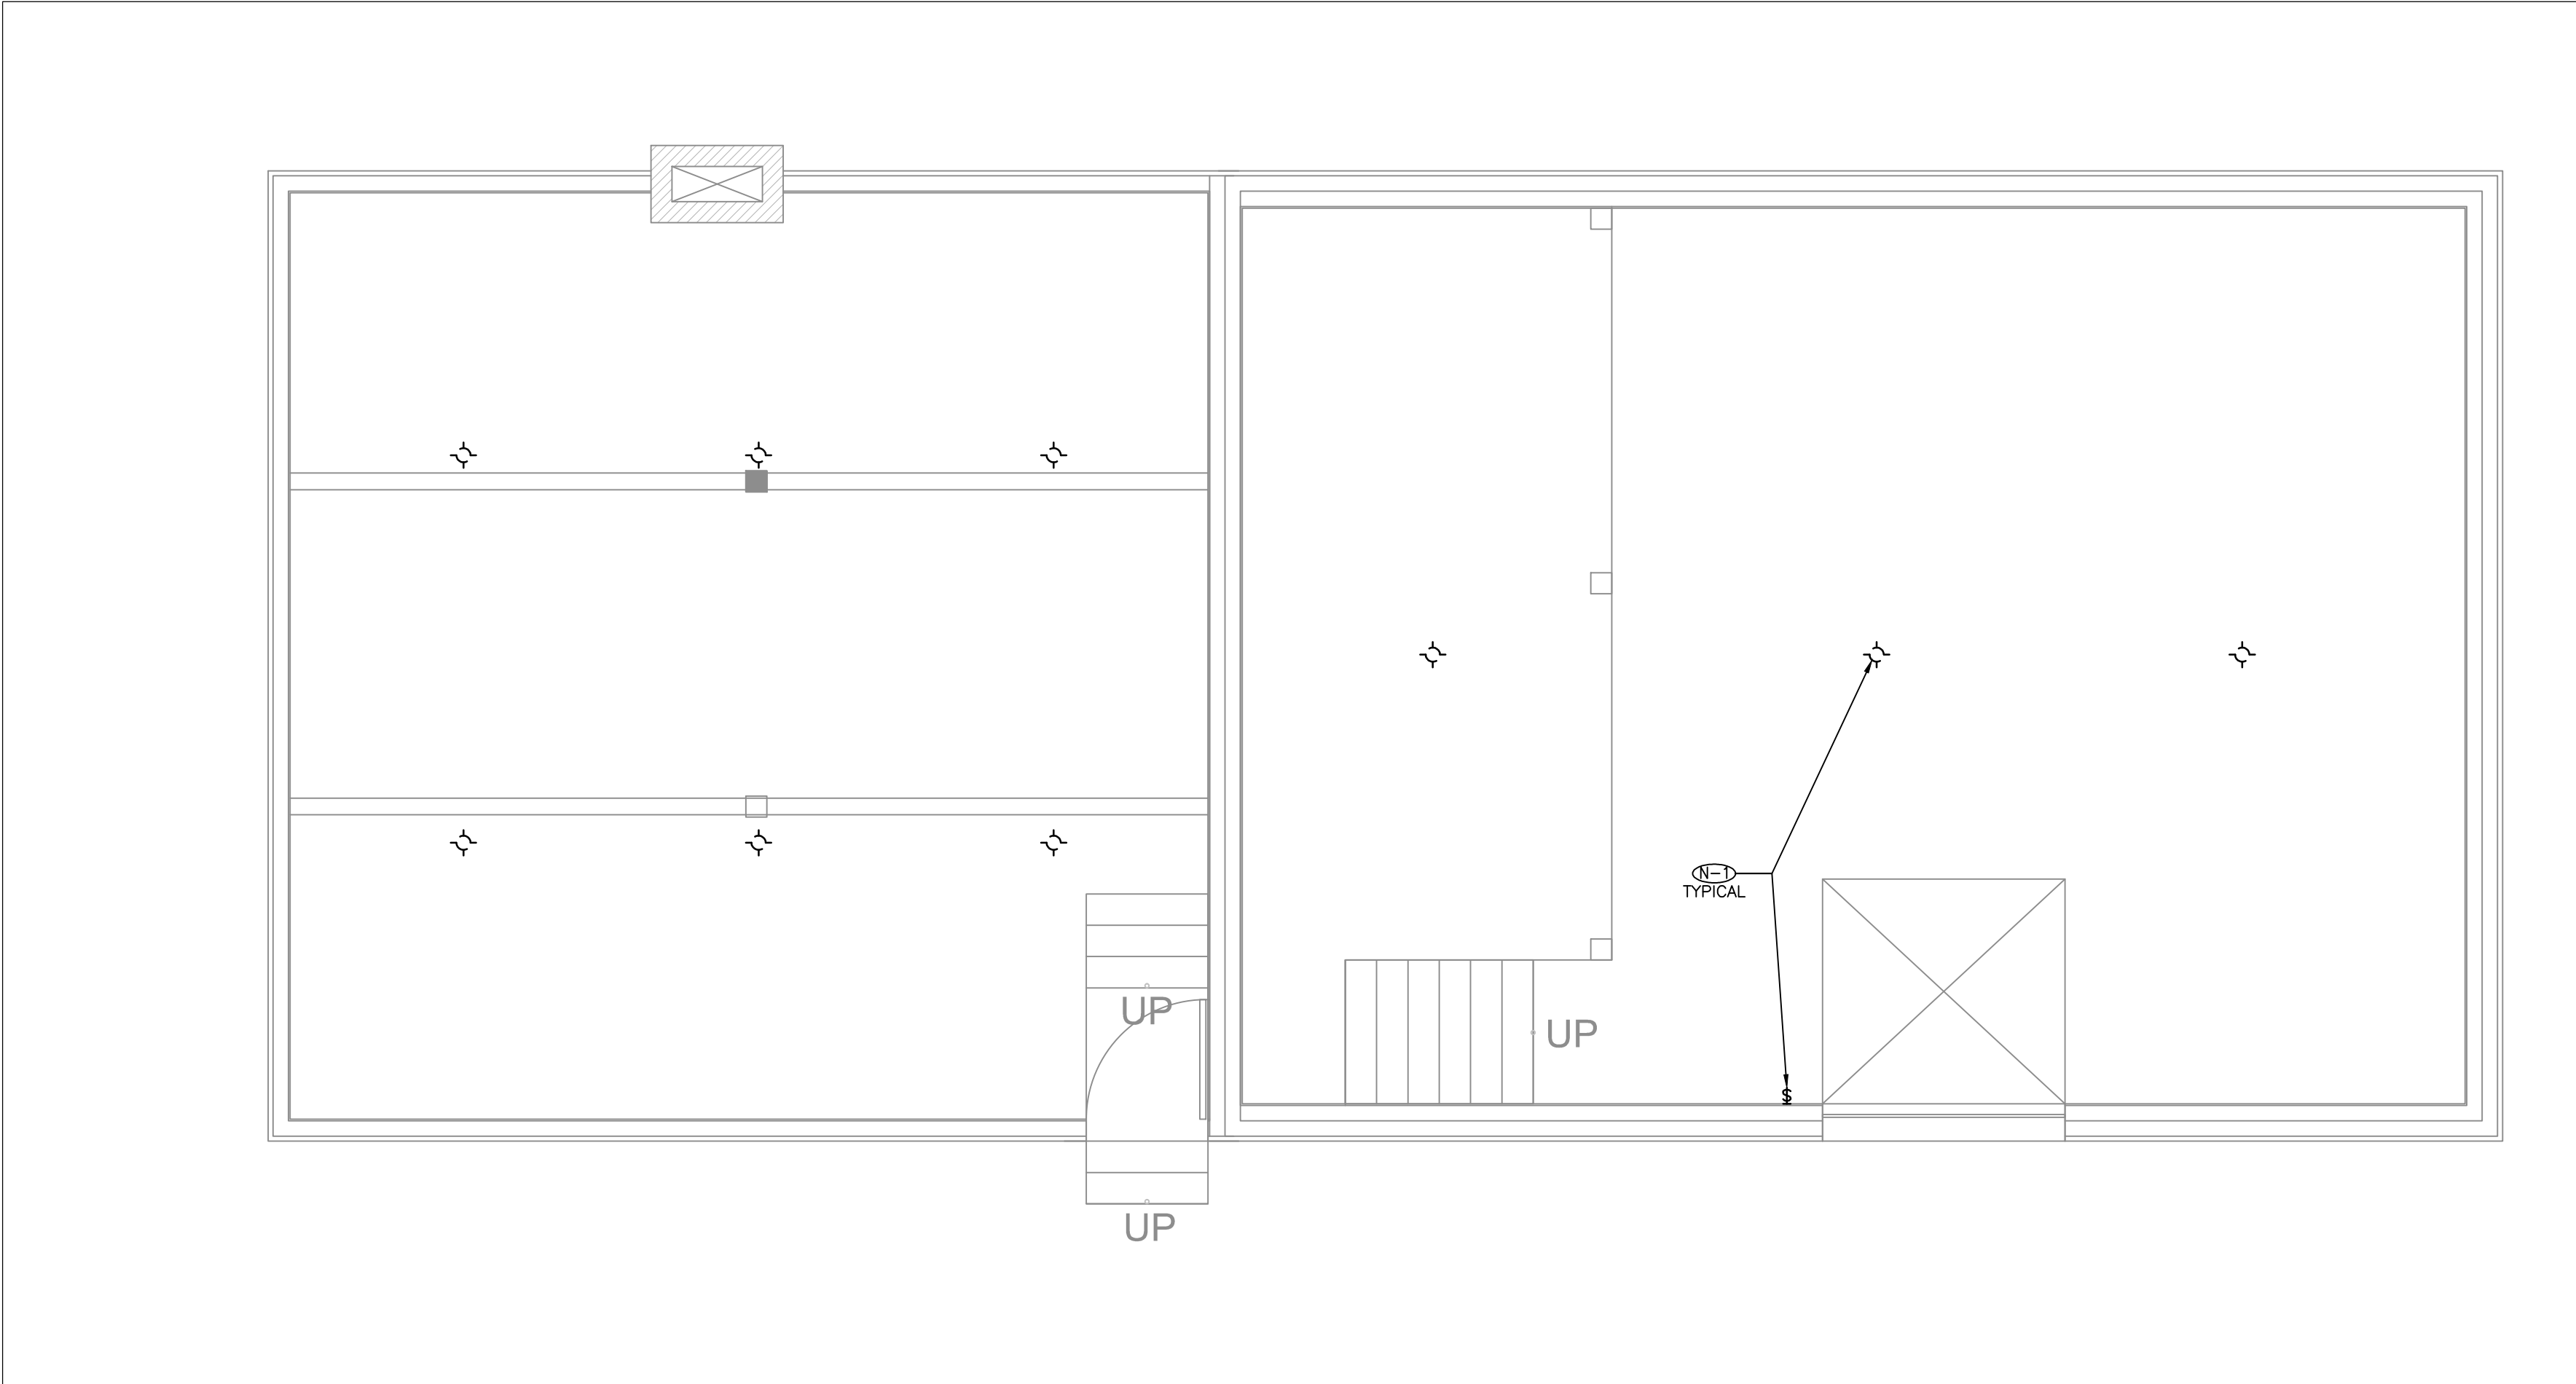

2 SHED FIRST FLOOR DEMOLITION PLAN – AS FOUND DEMOLITION
E302 1:50

GENERAL NOTES

1. FOLLOW ALL REQUIREMENTS FOR HANDLING AND DISPOSAL OF HAZARDOUS MATERIALS, INCLUDING BUT NOT LIMITED TO FLUORESCENT TUBES, BALLASTS, BATTERIES, AND THERMOSTATS. SEE DESIGNATED SUBSTANCE SPECIFICATION 024199.
2. REFER TO WASTE AUDIT FOR DEMOLITION REQUIREMENTS.

DRAWING NOTES

N-D REMOVE ALL EXISTING ELECTRICAL DEVICES, CONDUIT AND WIRING BACK TO SOURCE PANEL. MOST CONDUIT IS SURFACE RUN; ALLOW FOR REMOVAL OF ALL DEVICES, CONDUIT & WIRING MOUNTED AT HIGHER CEILING ELEVATIONS.

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PHASE 1A BUILDING
DEMOLITION AND SITE
REMEDIATION

drawing
dessin

SHED DEMOLITION PLANS

approved by approuvé par A.D.		
designed by conçu par M.M.		
drawn by dessiné par M.M.		
date	Sep. 30, 15	scale échelle AS NOTED

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E302


1. FOLLOW ALL REQUIREMENTS FOR HANDLING AND DISPOSAL OF HAZARDOUS MATERIALS, INCLUDING BUT NOT LIMITED TO FLUORESCENT TUBES, BALLASTS, BATTERIES, AND THERMOSTATS. SEE DESIGNATED SUBSTANCE SPECIFICATION 024199.
2. REFER TO WASTE AUDIT FOR DEMOLITION REQUIREMENTS.

- ① REMOVE EXISTING PANEL AA--1, COMPLETE WITH CONDUIT AND WIRING BACK TO SOURCE GARAGE PANEL. REFER TO SITE PLAN FOR MORE INFORMATION.
- ② REMOVE EXISTING SURFACE BRANCH CONDUIT & WIRING TO FENCE RECEPTACLES.
- ③ REMOVE ALL EXISTING ELECTRICAL DEVICES, CONDUIT AND WIRING BACK TO SOURCE PANEL. MOST CONDUIT IS SURFACE RUN. ALLOW FOR REMOVAL OF ALL DEVICES, CONDUIT & WIRING MOUNTED AT HIGHER CEILING ELEVATIONS.
- ④ REMOVE OLD SUSPENDED LIGHT/FAN CONNECTION, COMPLETE WITH CONDUIT AND WIRING BACK TO SOURCE.

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1 OCTAGONAL HERITAGE BUILDING DEMOLITION PLAN
E303 1:50

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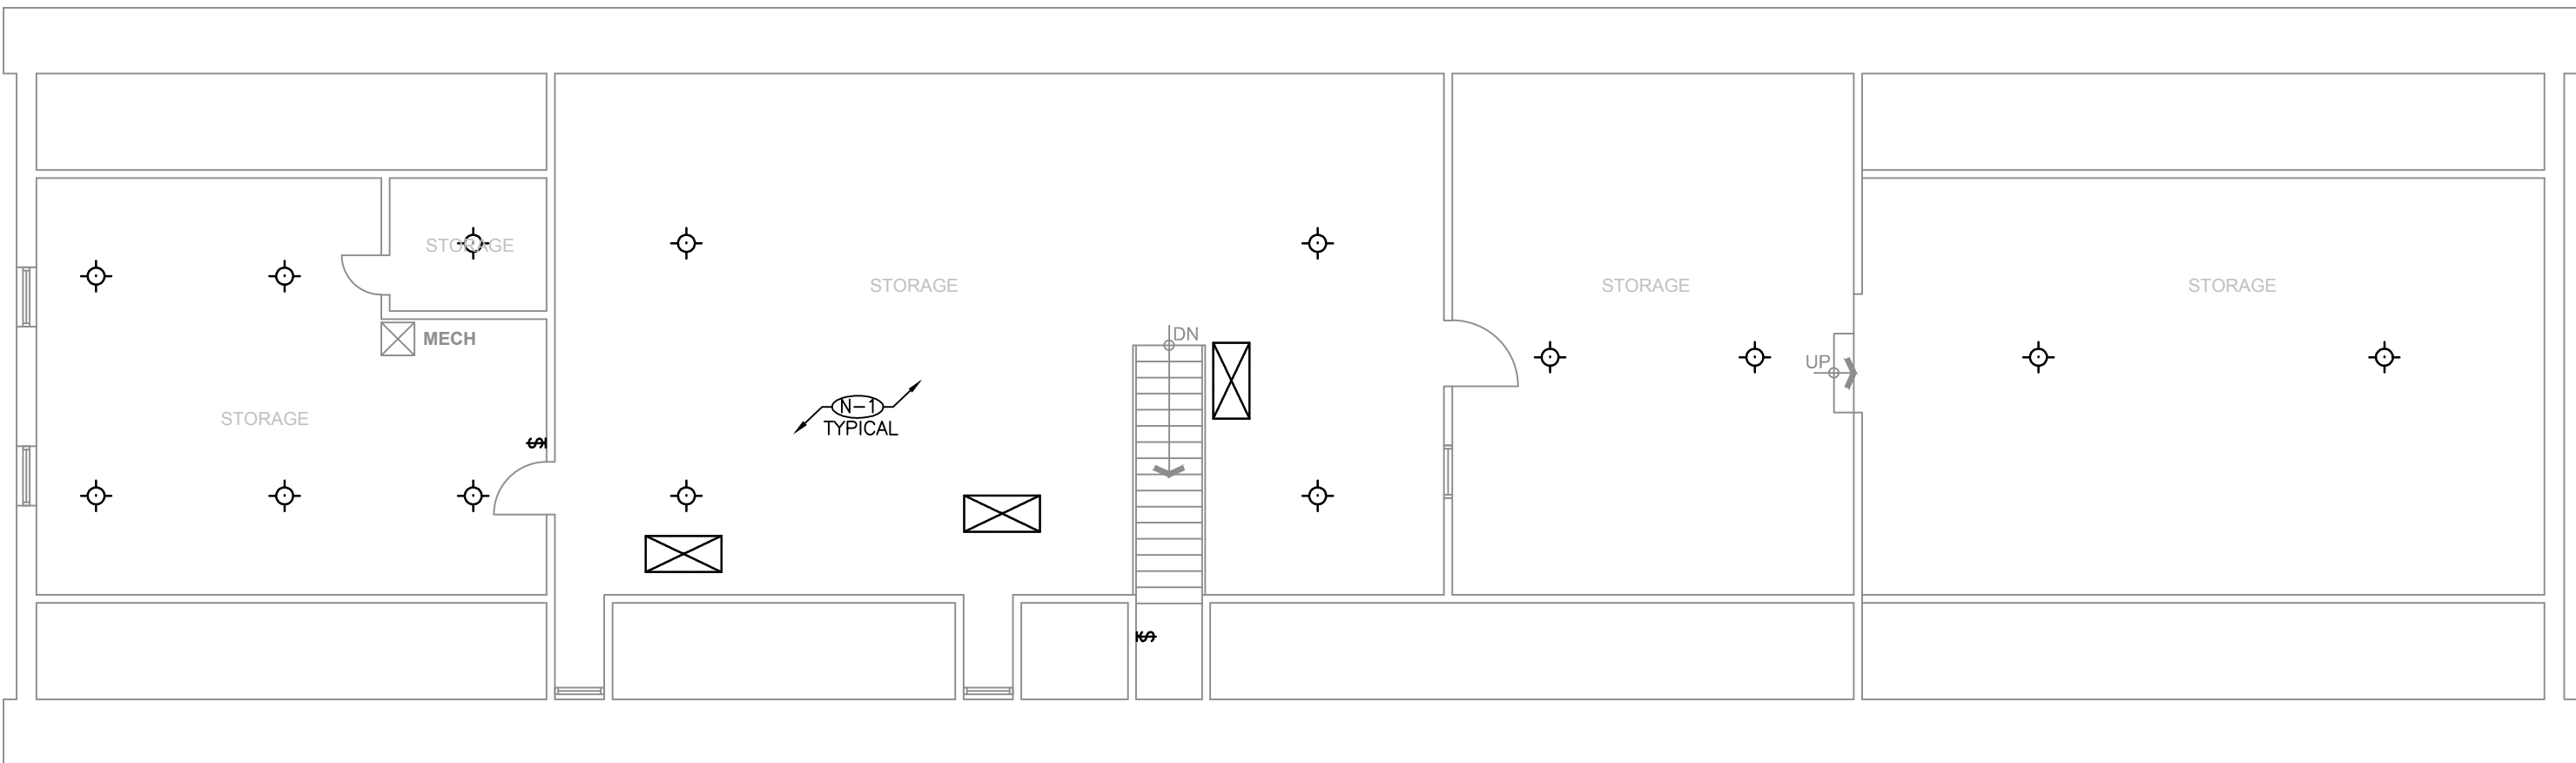
drawn by

date _____

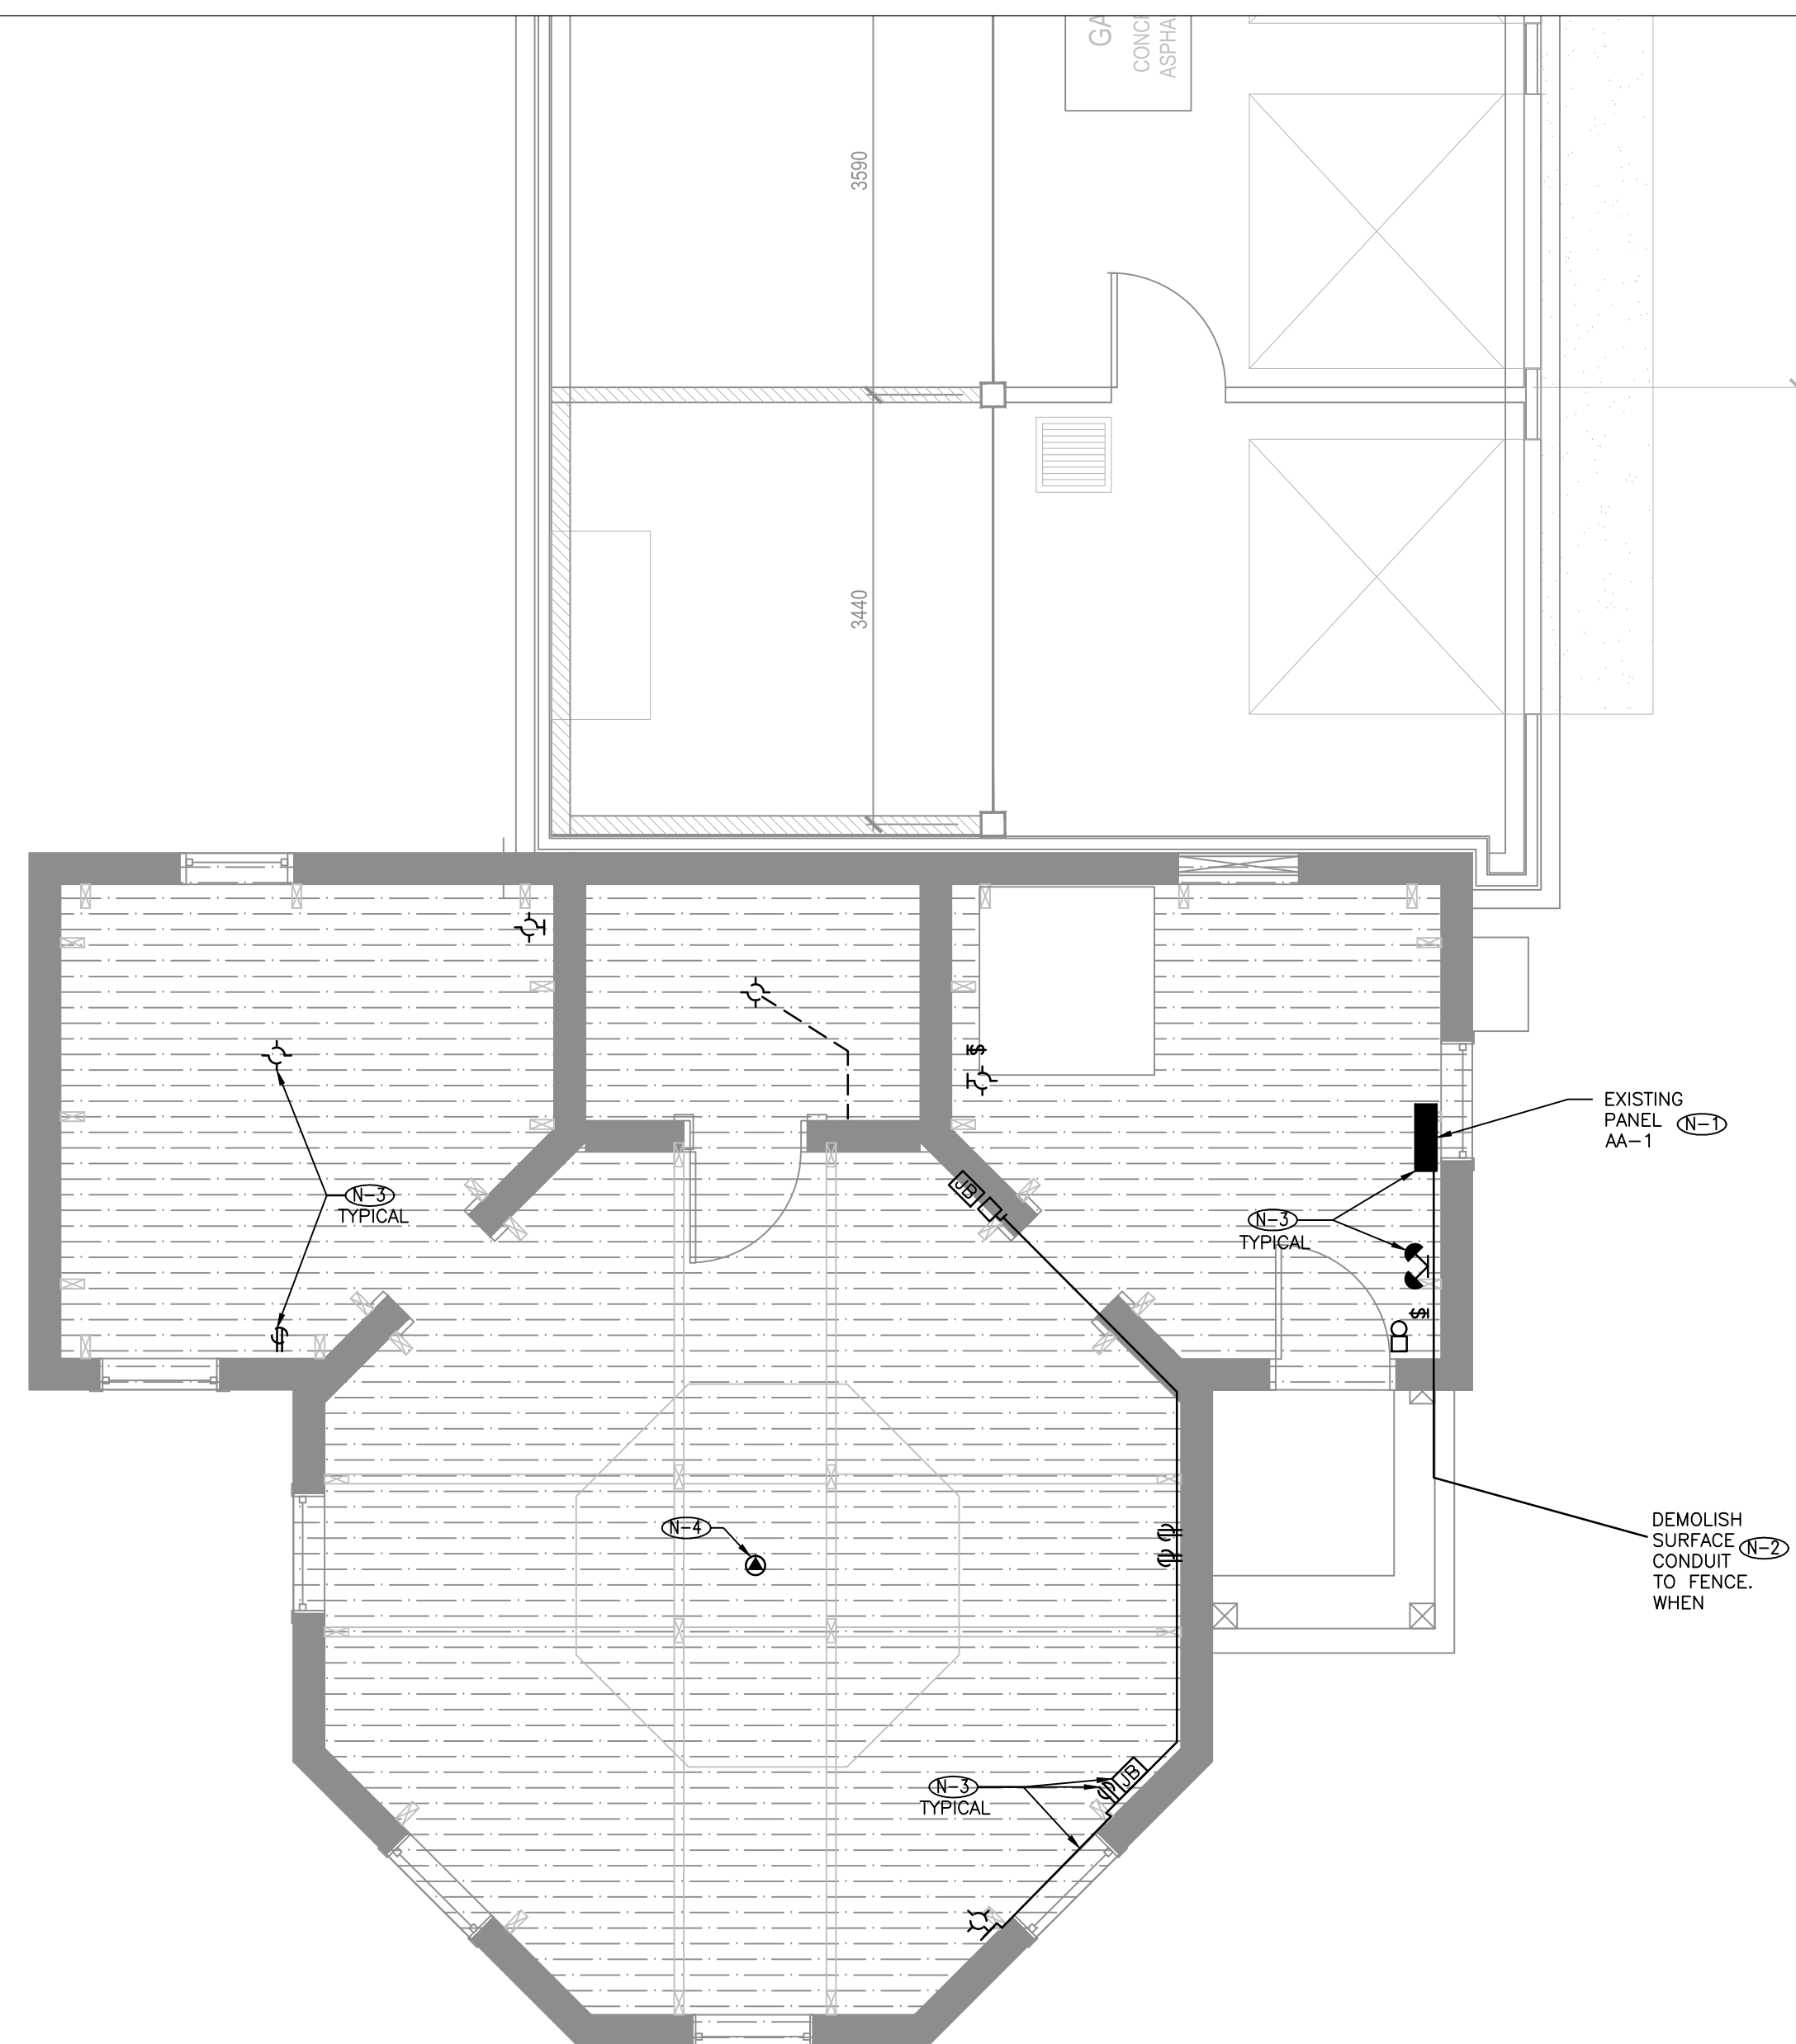échelle 1:50

E303


FLOOR PLAN - LEVEL 2



GENERAL NOTES:

1. FOLLOW ALL REQUIREMENTS FOR HANDLING AND DISPOSAL OF HAZARDOUS MATERIALS, INCLUDING BUT NOT LIMITED TO FLUORESCENT TUBES, BALLASTS, BATTERIES, AND THERMOSTATS. SEE DESIGNATED SUBSTANCE SPECIFICATION 024199.
2. REFER TO WASTE AUDIT FOR DEMOLITION REQUIREMENTS.


FLOOR PLAN - LEVEL 1

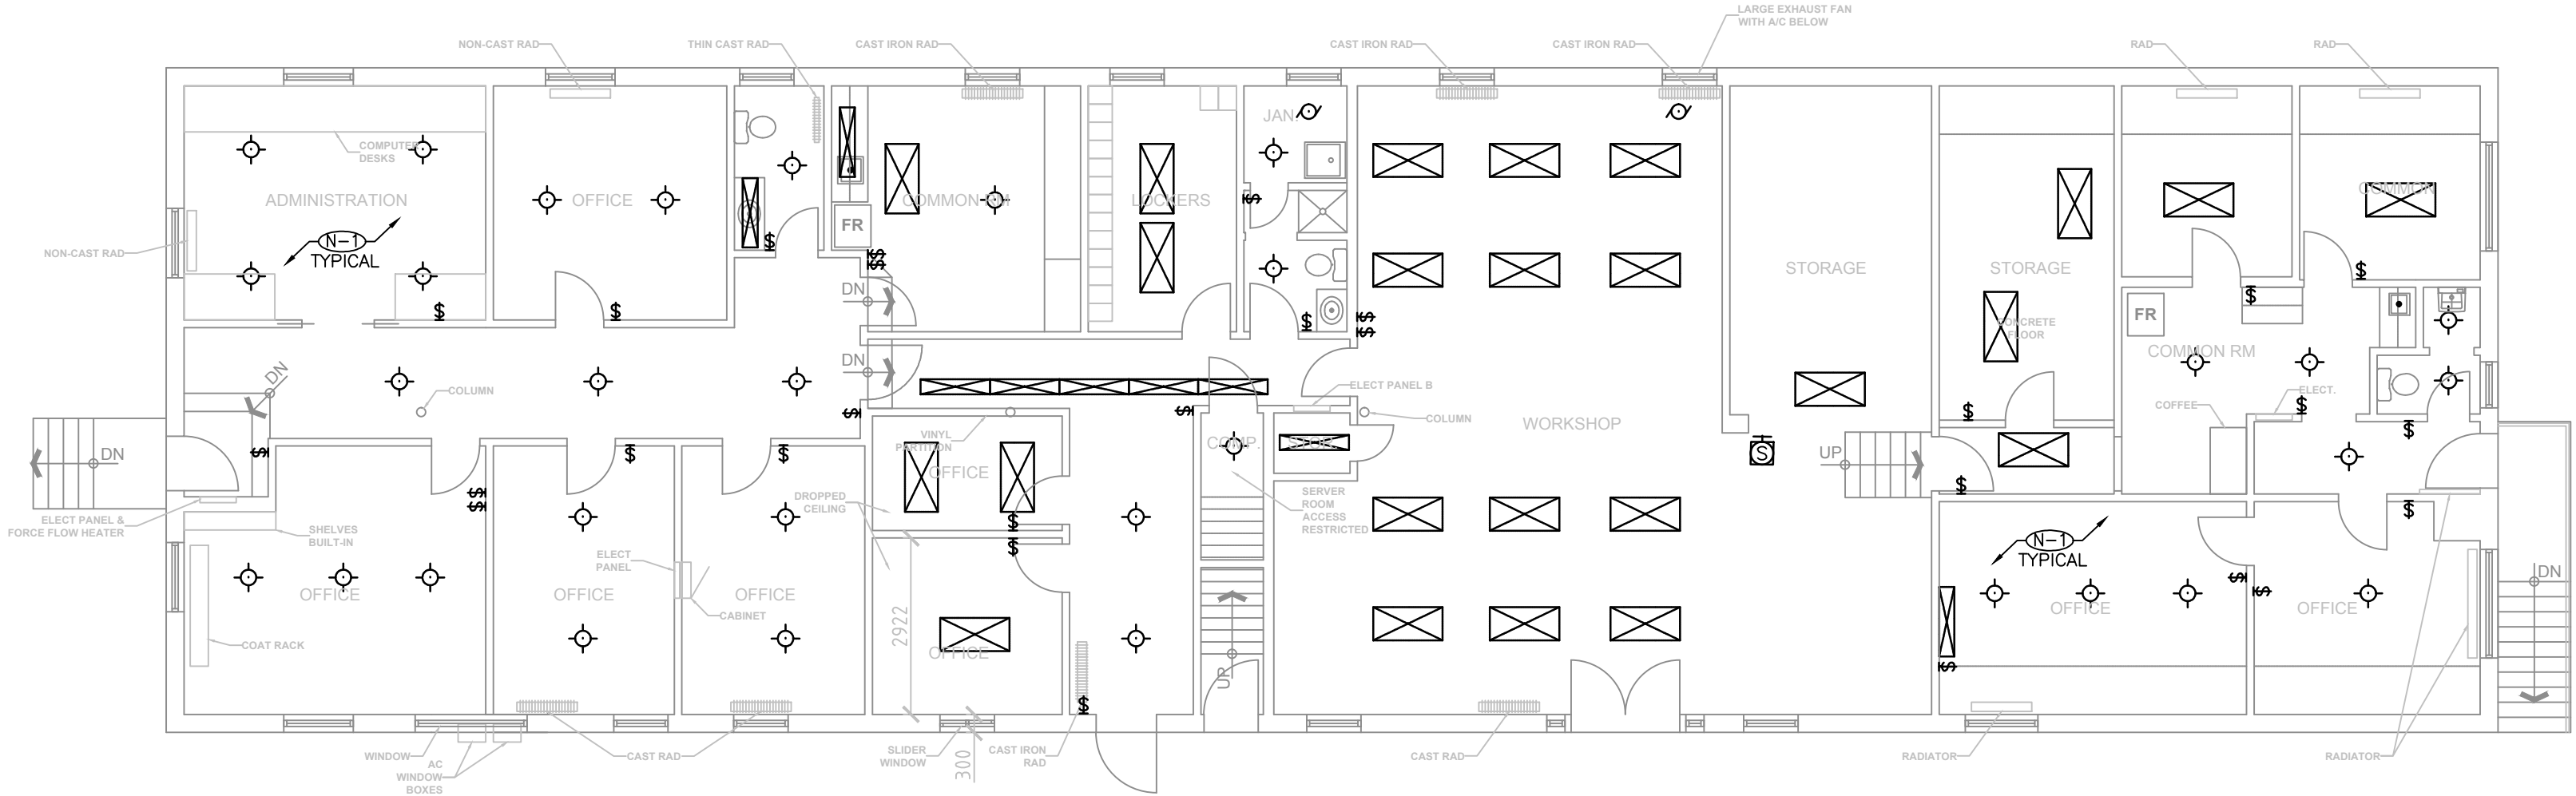

DRAWING NOTES:

- Ⓝ-D BUILDING IS BEING DEMOLISHED; REMOVE ALL ELECTRICAL DEVICES AND EQUIPMENT FROM THE BUILDING. DISCONNECT AND MAKE SAFE PRIOR TO DEMOLITION.

FLOOR PLAN - BASEMENT

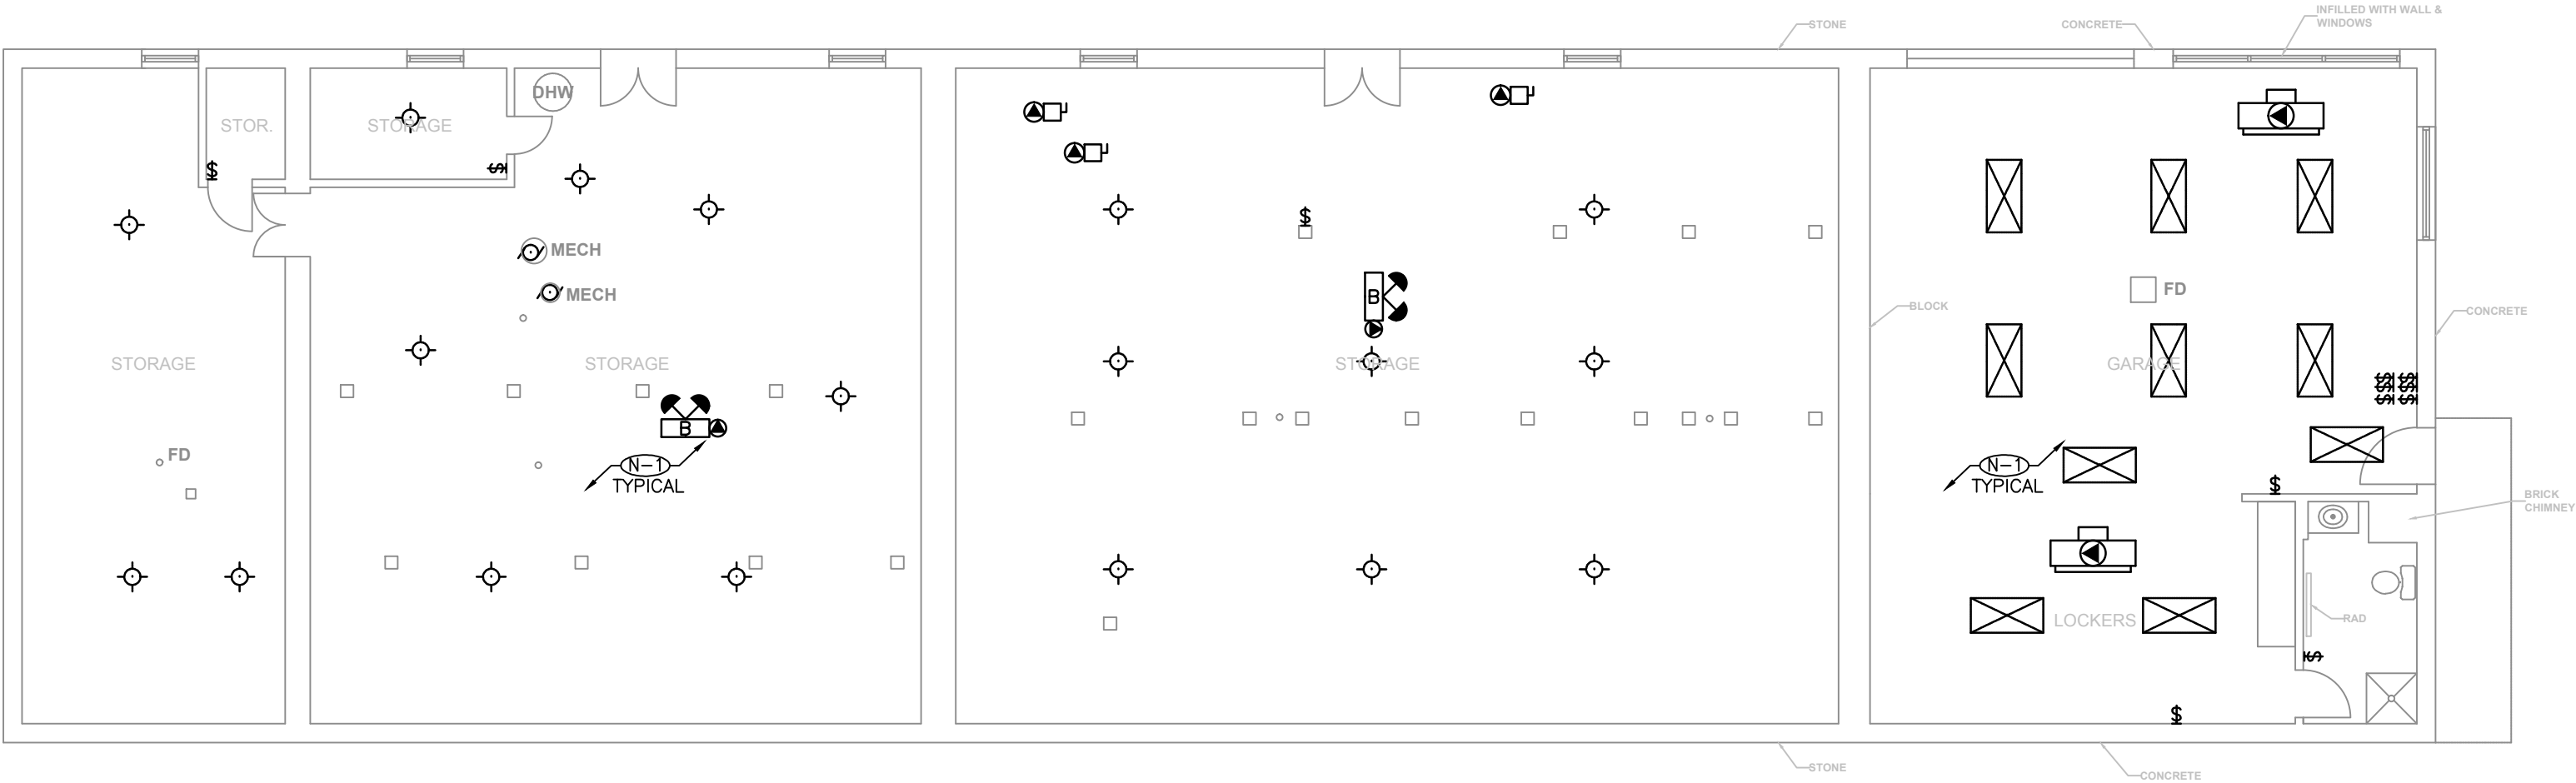

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PHASE 1A BUILDING
DEMOLITION AND SITE
REMEDICATION

drawing
dessin

SITE OFFICES LIGHTING
DEMOLITION

approved by
approuvé par A.D.

designed by
conçu par M.M.

drawn by
dessiné par M.M.

date
Sep. 30, 15

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échelle 1:100

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E304

FLOOR PLAN - LEVEL 2

AS-FOUND DEMOLITION FLOOR PLAN – LEVEL 2

GENERAL NOTES:

- 1. FOLLOW ALL REQUIREMENTS FOR HANDLING AND DISPOSAL OF HAZARDOUS MATERIALS, INCLUDING BUT NOT LIMITED TO FLUORESCENT TUBES, BALLASTS, BATTERIES, AND THERMOSTATS. SEE DESIGNATED SUBSTANCE SPECIFICATION 024199.
- 2. REFER TO WASTE AUDIT FOR DEMOLITION REQUIREMENTS.

FLOOR PLAN - LEVEL 1

AS-FOUND DEMOLITION FLOOR PLAN – LEVEL 1

DRAWING NOTES:

- 1. BUILDING IS BEING DEMOLISHED: REMOVE ALL ELECTRICAL DEVICES AND EQUIPMENT FROM THE BUILDING. DISCONNECT AND MAKE SAFE PRIOR TO DEMOLITION.
- 2. SIEMENS BUILDING AUTOMATION COMMUNICATION CABLE. ENSURE CABLE IS REMOVED AND RELOCATED BY THE CLIENT PRIOR TO DEMOLITION.

AS-FOUND DEMOLITION FLOOR PLAN – BASEMENT

FLOOR PLAN - BASEMENT

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0	ISSUED FOR 66% REVIEW	2015-01-16
no.	description	date

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PHASE 1A BUILDING
DEMOLITION AND SITE
REMEDICATION


drawing
dessin

SITE OFFICES POWER
DEMOLITION

approved by approuvé par A.D.		
designed by conçu par M.M.		
drawn by dessiné par M.M.		
date	Sep. 30, 15	scale échelle 1:100

13053.002

E305

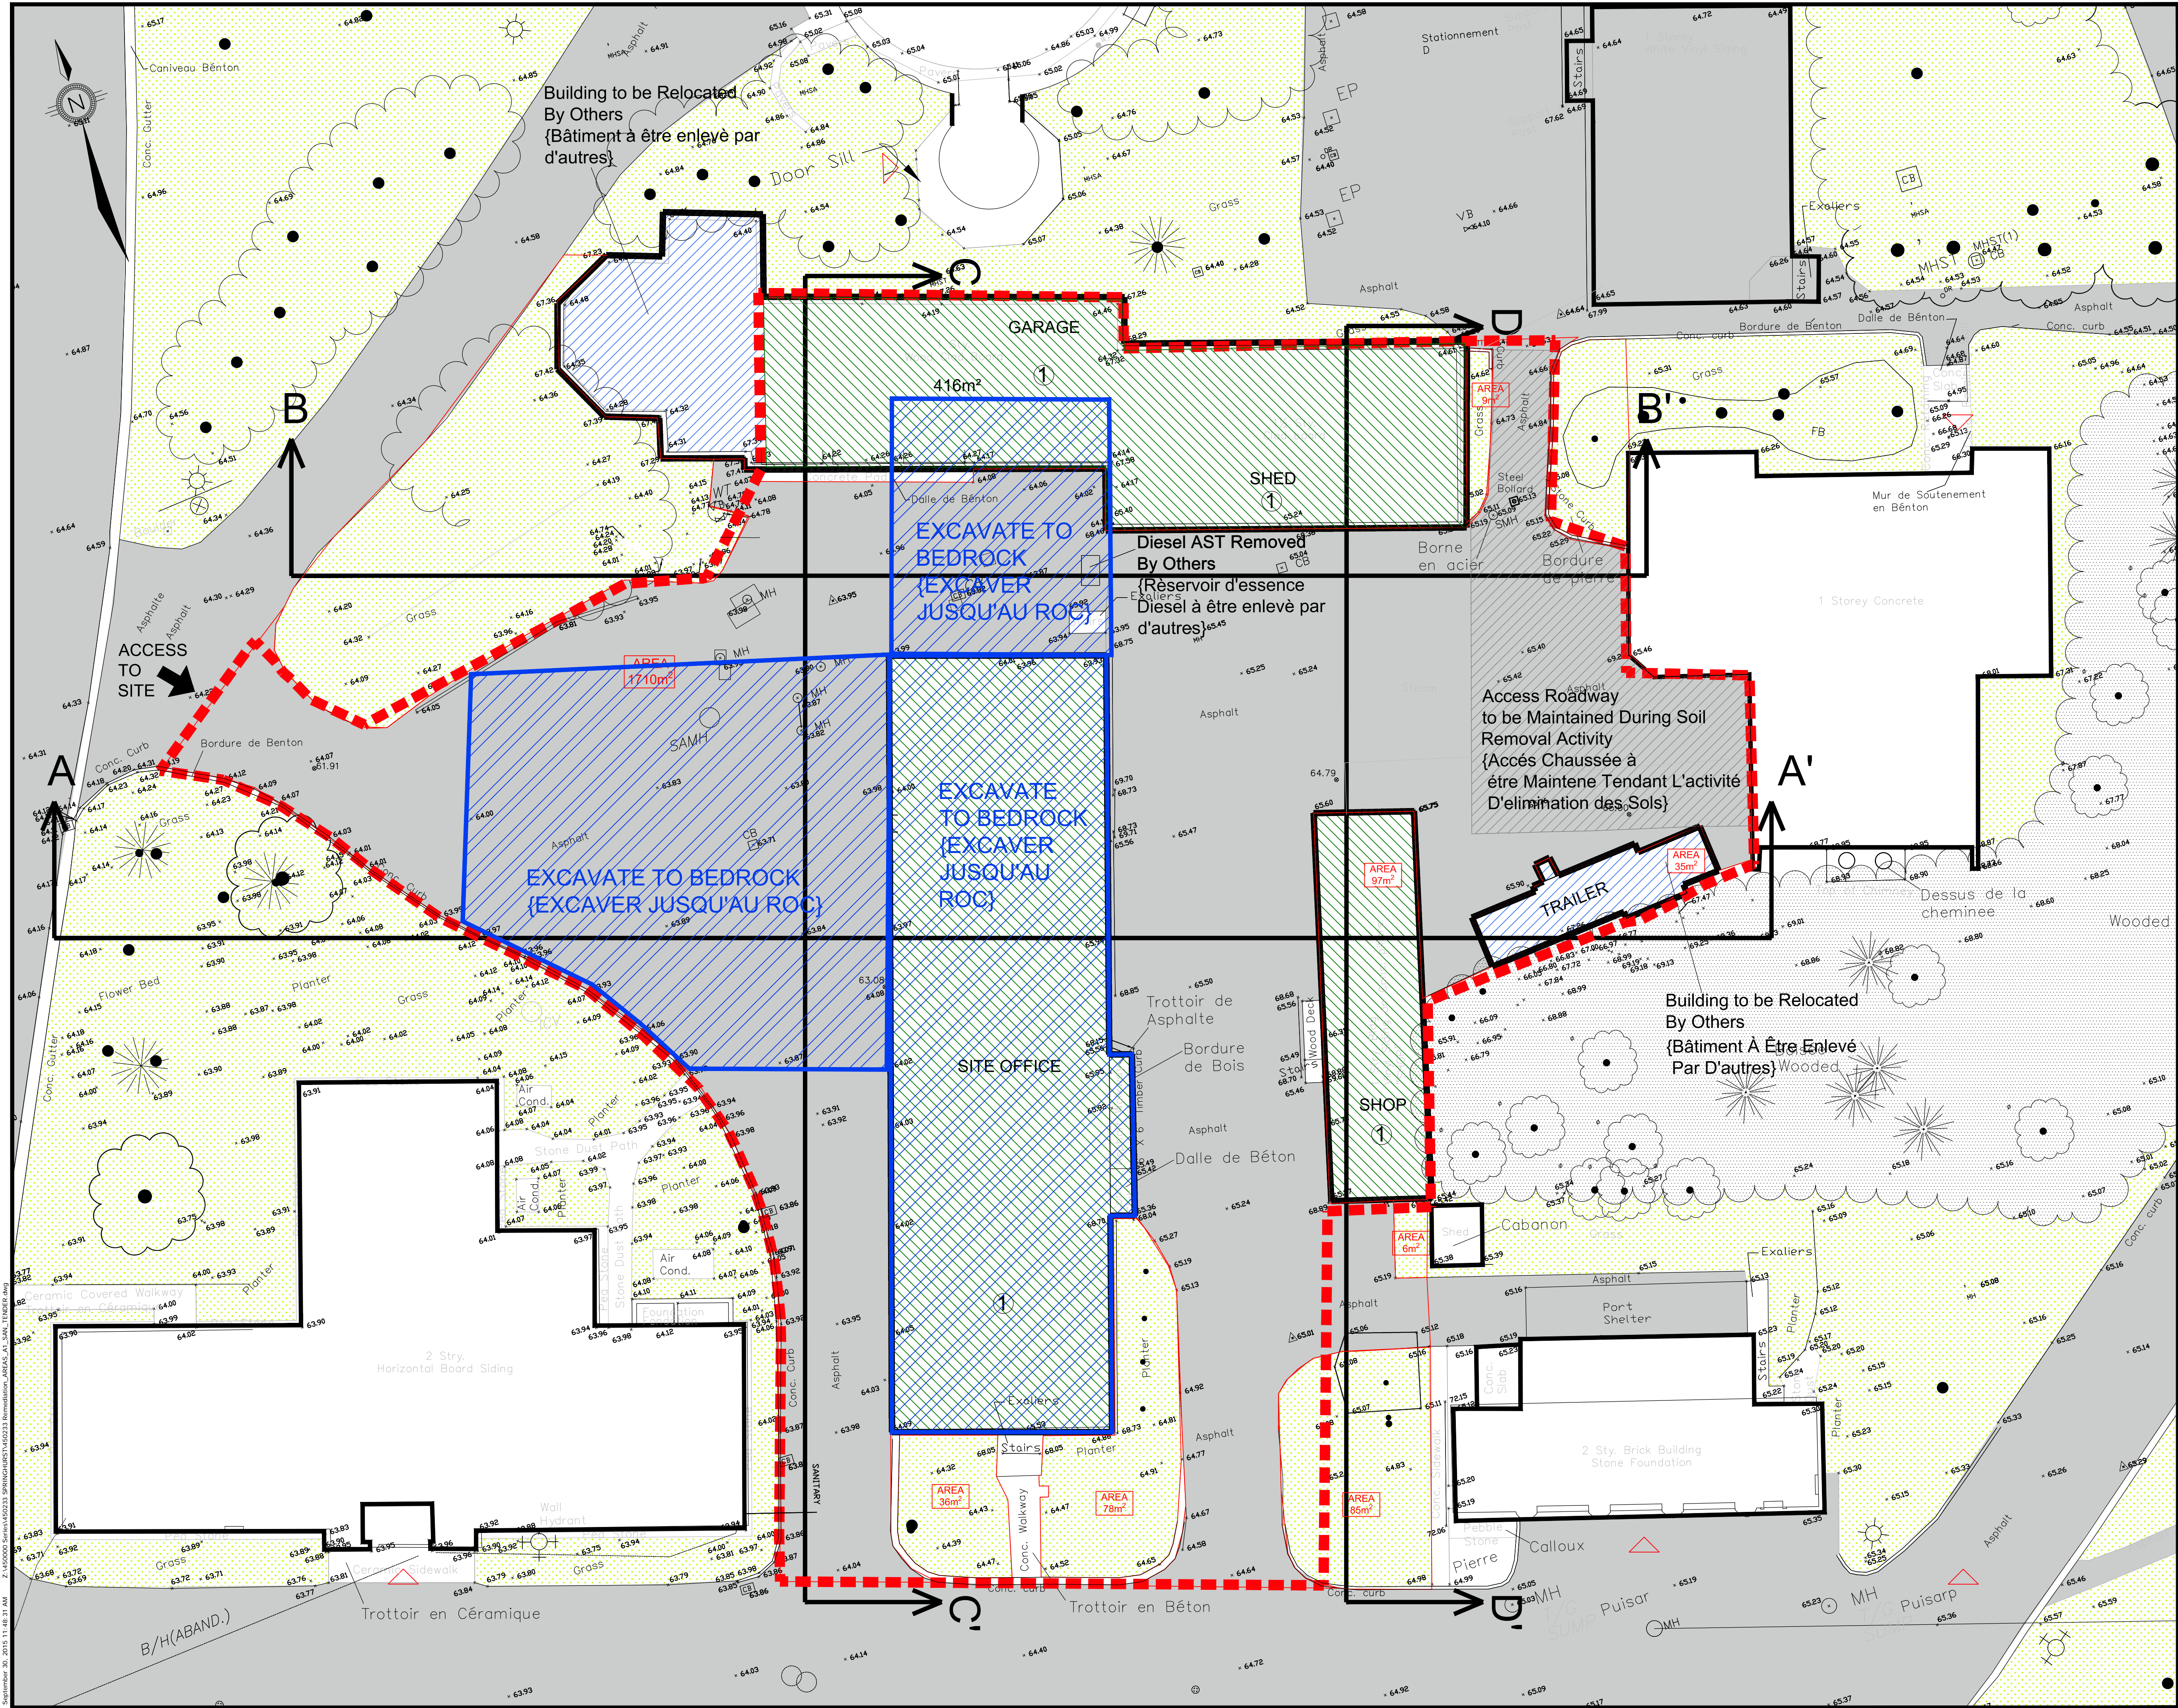

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LEGEND:

- EXISTING BUILDING (BÂTIMENT EXISTANT)
- CONSTRUCTION FENCE LINE (CONSTRUCTION LIMITS) (LIGNE DE CLÔTURE TEMPORAIRE)
- EXISTING BUILDING (BÂTIMENT EXISTANT)
- EXISTING ASPHALT AREA (SURFACE ASPHALTÉE EXISTANTE)
- EXISTING GRASS AREA (ZONE GAZONNÉE)
- CURRENT ELEVATION (METRES ABOVE SEA LEVEL) (ELEVATION ACTUEL (METRES AU-DESSUS DU NIVEAU DE LA MER))
- BUILDING TO BE DEMOLISHED (BÂTIMENT À DÉMOLIR)
- BUILDING TO BE REMOVED BY OTHERS (BÂTIMENT À ÊTRE ENLEVÉ PAR D'AUTRES)
- N.I.C. (NOT IN CONTRACT (PAS SANS LE CONTRAT))

NOTE 1:
Building to be demolished : Refer to Drawings
Bâtiment à démolir: Consulter les dessins

- A1.0 - Garage
- A1.1 - Shed
- A1.2 - Shop
- A2.0 - Site office building

0 2 4 metres
SCALE 1:150

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5	ISSUED FOR TENDER	30 Sept. 2015
4	EDITS	9 Sept. 2015
3	EDITS	21 Aug. 2015
2	EDITS	5 Mar. 2015
1	EDITS	23 Feb. 2015
no.	description	date

project
projet

OPERATIONS ZONE REDEVELOPMENT
RÉNOVATION DE LA ZONE D'EXPLOITATION

drawing
dessin

SITE PLAN
PLAN SITE

OTTAWA, ONTARIO

approved by
approuvé par

T.A.

designed by
conçu par

T.A.

drawn by
dessiné par

I.S.Z.

date

SEPT. 2015

scale
échelle


1:150

project no.
no. du projet

14423 RMA

sheet no.
no. de la feuille

SR-1

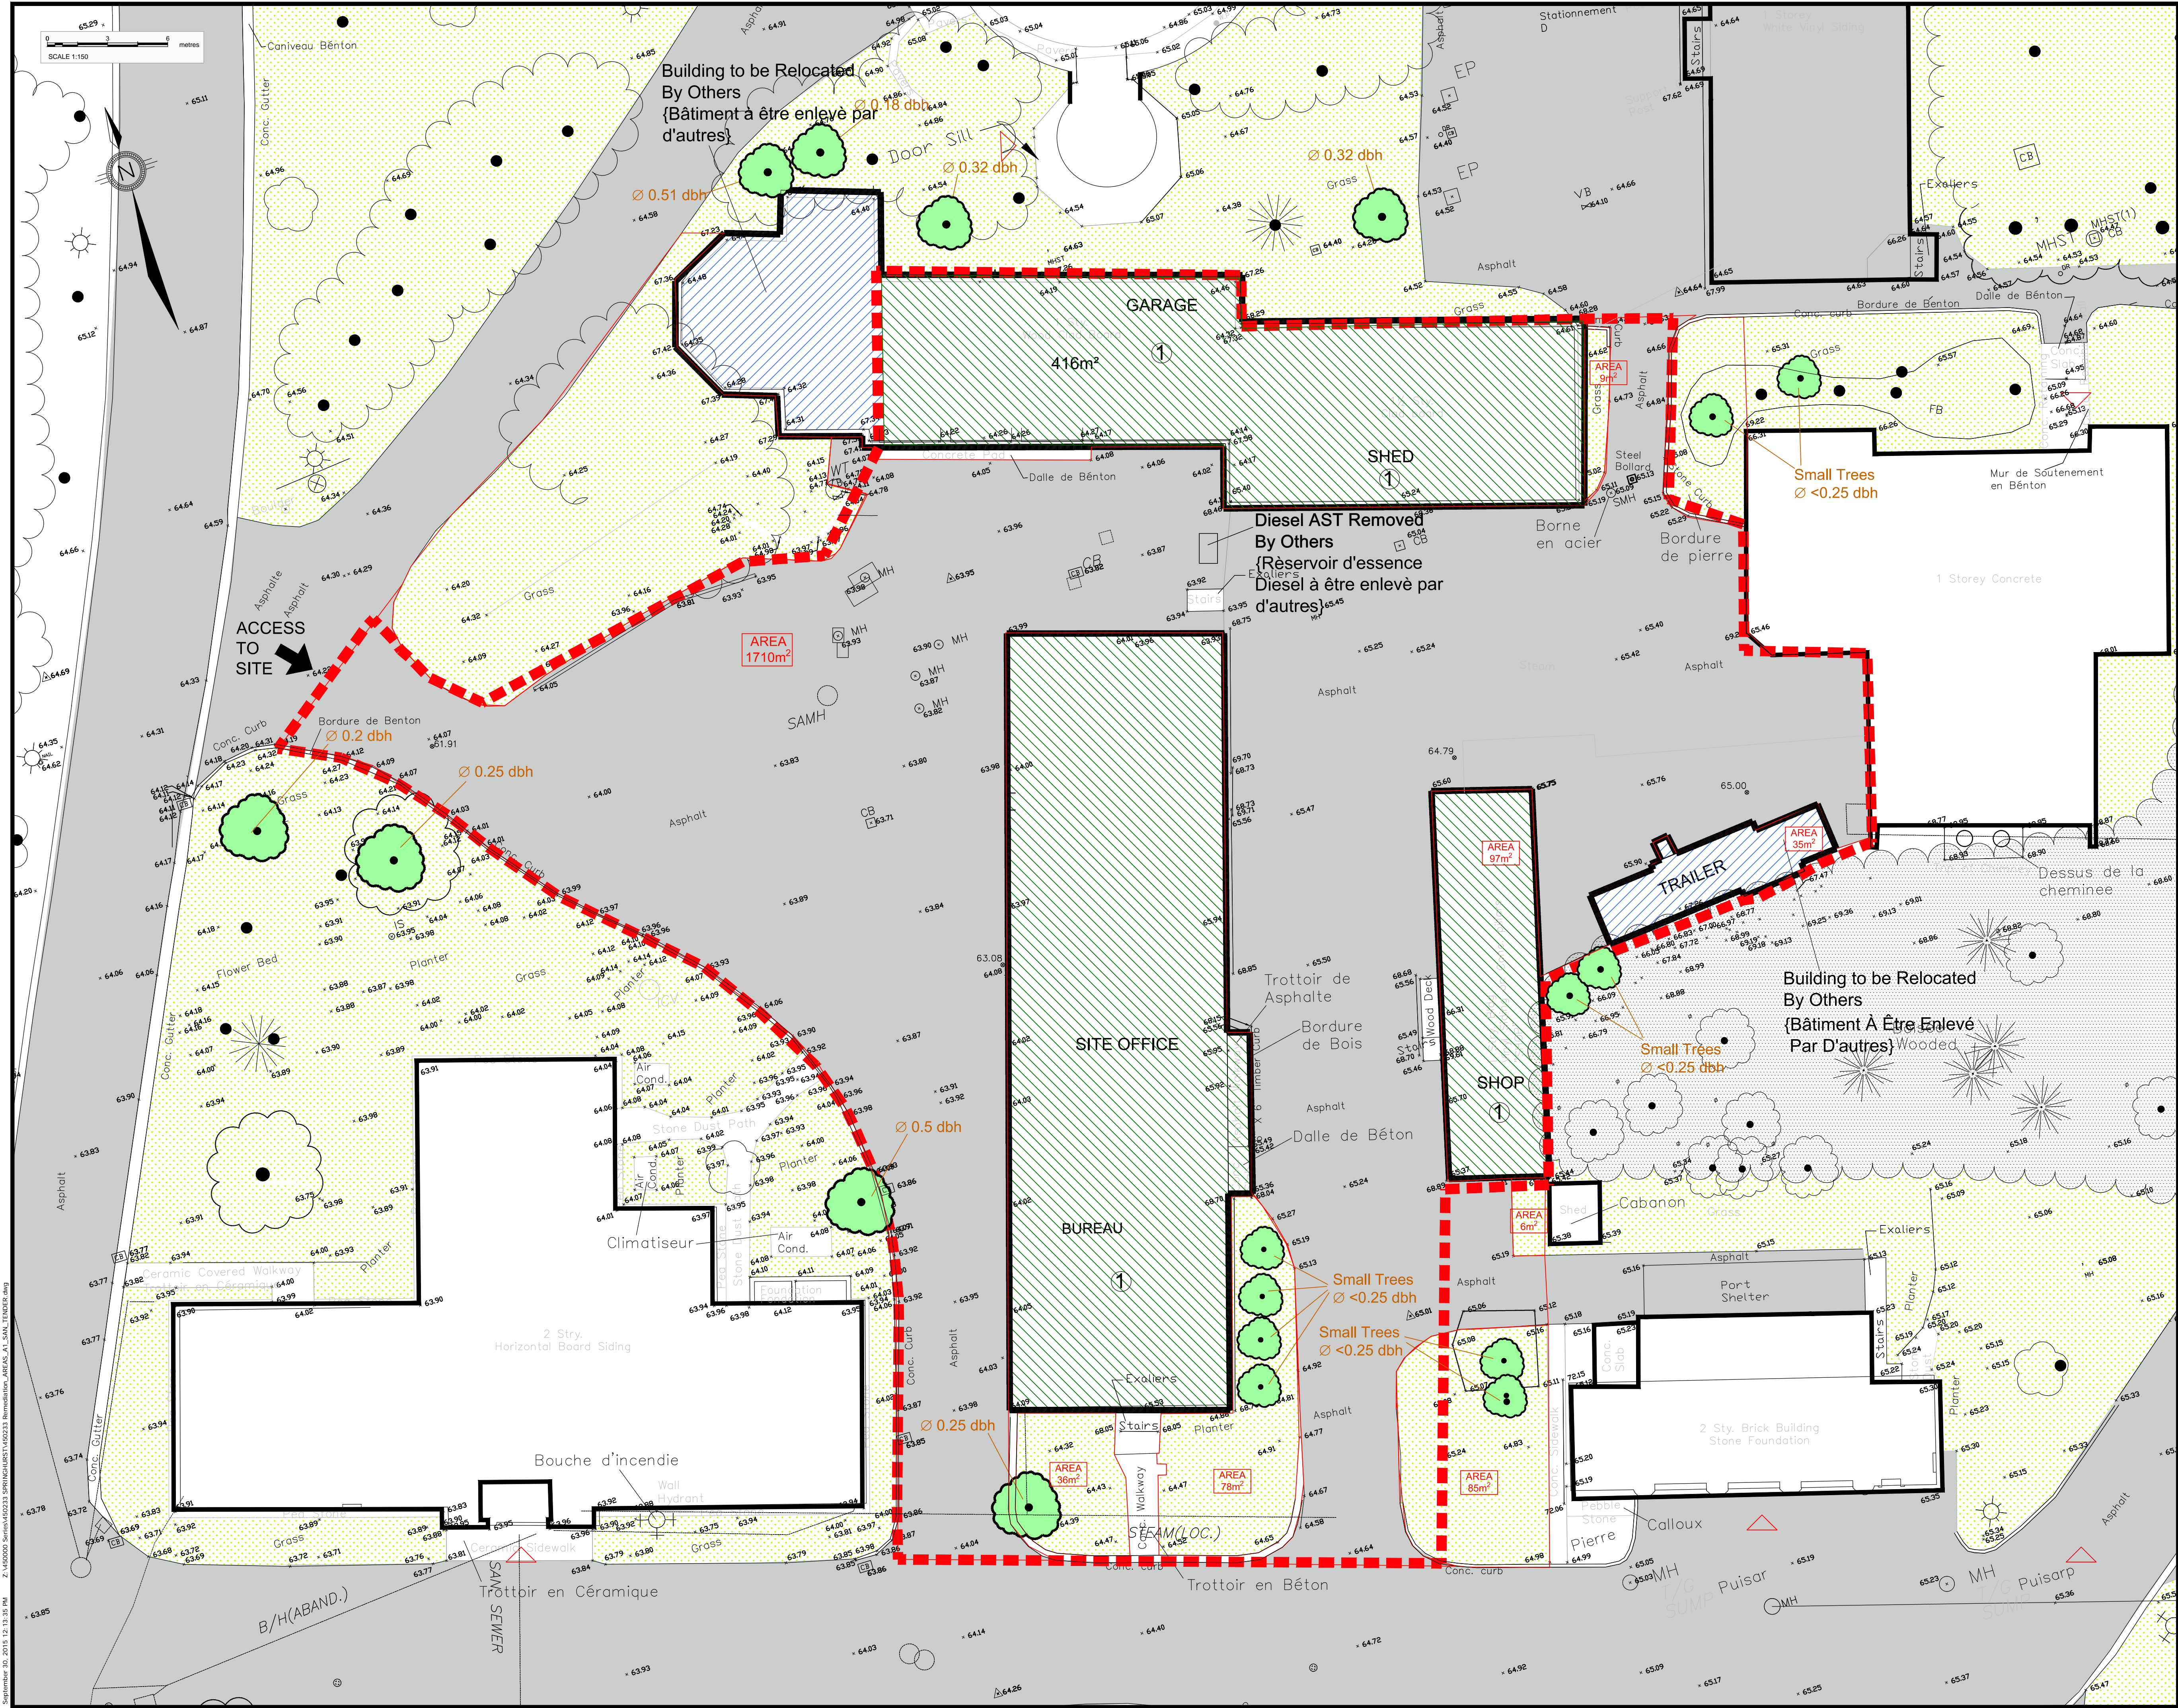

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LEGEND:

- EXISTING BUILDING (BÂTIMENT EXISTANT)
- CONSTRUCTION FENCE LINE (CONSTRUCTION LIMITS) (LIGNE DE CLÔTURE TEMPORAIRE)
- EXISTING BUILDING (BÂTIMENT EXISTANT)
- EXISTING ASPHALT AREA (SURFACE ASPHALTÉE EXISTANTE)
- EXISTING GRASS AREA (ZONE GAZONNÉE)
- CURRENT ELEVATION (METRES ABOVE SEA LEVEL) (ELEVATION ACTUELLE (MÈTRES AU-DESSUS DU NIVEAU DE LA MER))
- BUILDING TO BE DEMOLISHED (BÂTIMENT À DÉMOLIR)
- BUILDING TO BE REMOVED BY OTHERS (BÂTIMENT À ÊTRE ENLEVÉ PAR D'AUTRES)
- N.I.C. (NOT IN CONTRACT) (PAS SANS LE CONTRAT)
- TREES TO BE PROTECTED (ARBRES À PROTÉGER)
- DIAMETER AT BREAST HEIGHT (m) (DIAMÈTRE À LA HAUTEUR DE LA POITRINE (m))

NOTE ①:
Building to be demolished : Refer to Drawings
Bâtiment à démolir: Consulter les dessins

- A1.0 - Garage
- A1.1 - Shed
- A1.2 - Shop
- A2.0 - Site office building

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3	EDITS	21 Aug. 2015
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1	EDITS	23 Feb. 2015

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projet



OPERATIONS ZONE REDEVELOPMENT
RÉNOVATION DE LA ZONE D'EXPLOITATION

drawing
dessin

TREE PROTECTION PLAN
PLAN DE PROTECTION TREE

OTTAWA, ONTARIO

approved by approuvé par	T.A.
designed by conçu par	T.A.
drawn by dessiné par	I.S.Z.
date SEPT. 2015	scale échelle 1:150
project no. no. du projet 14423 RMA	sheet no. no. de la feuille SR-2

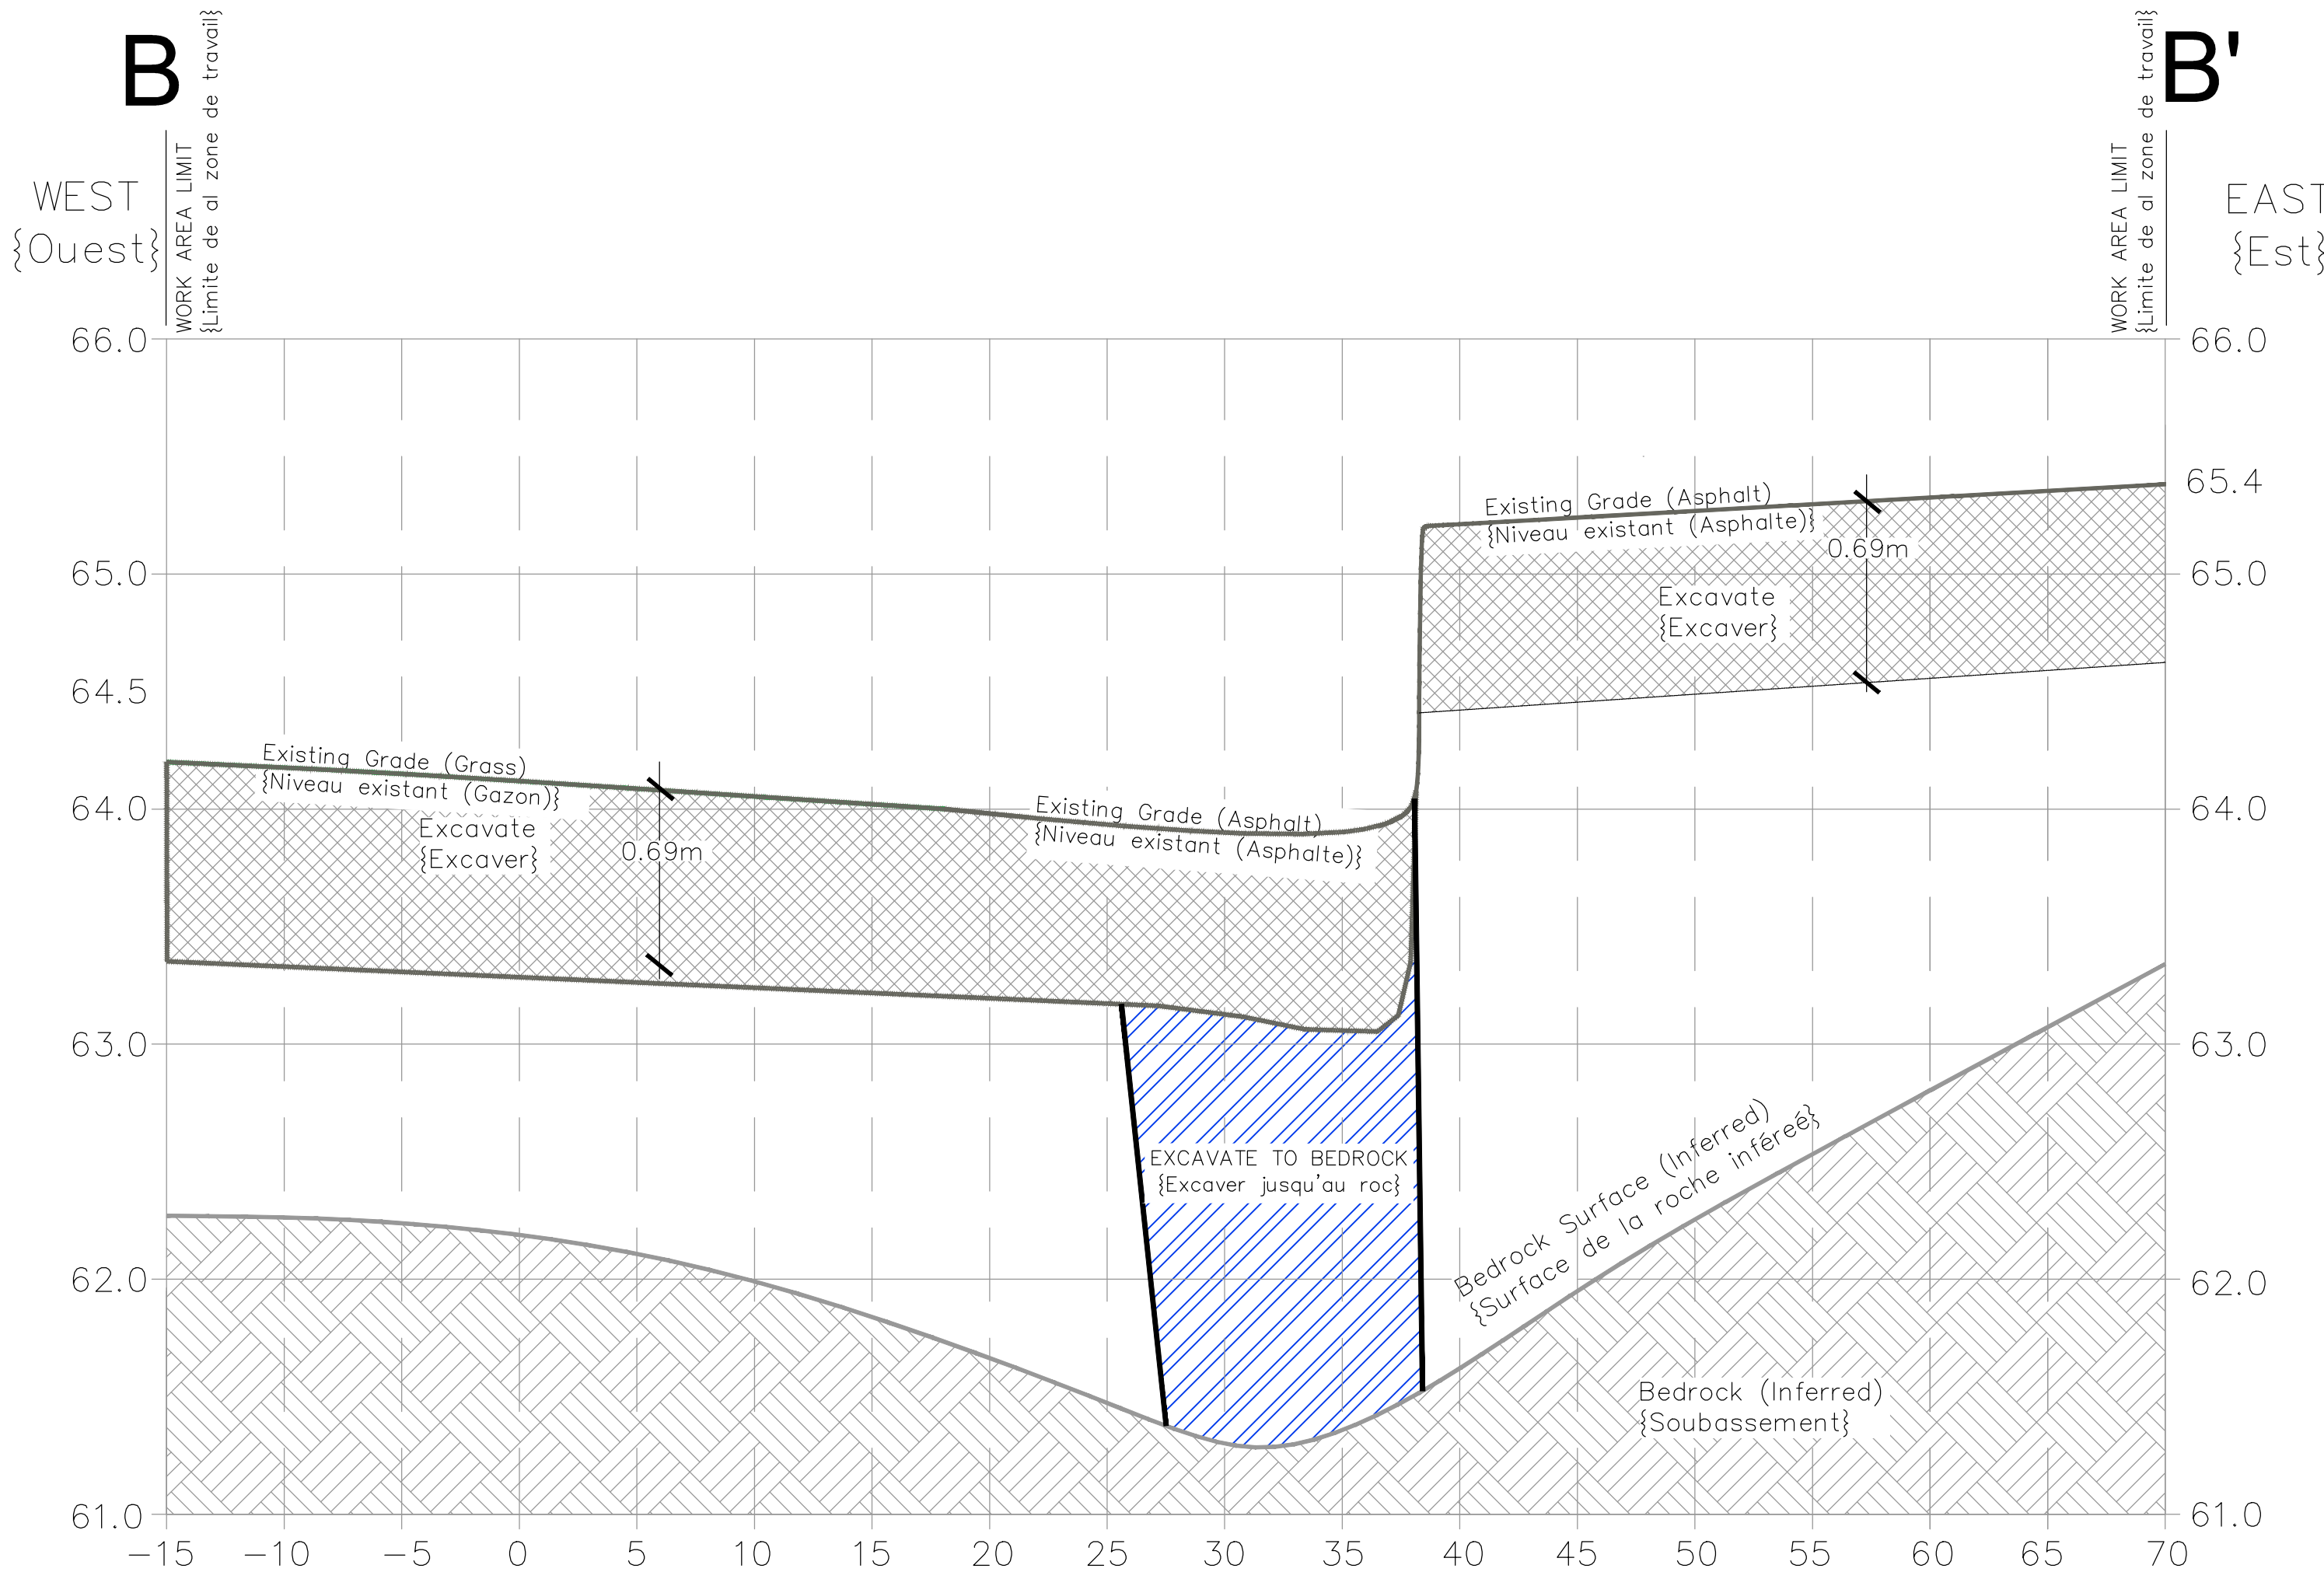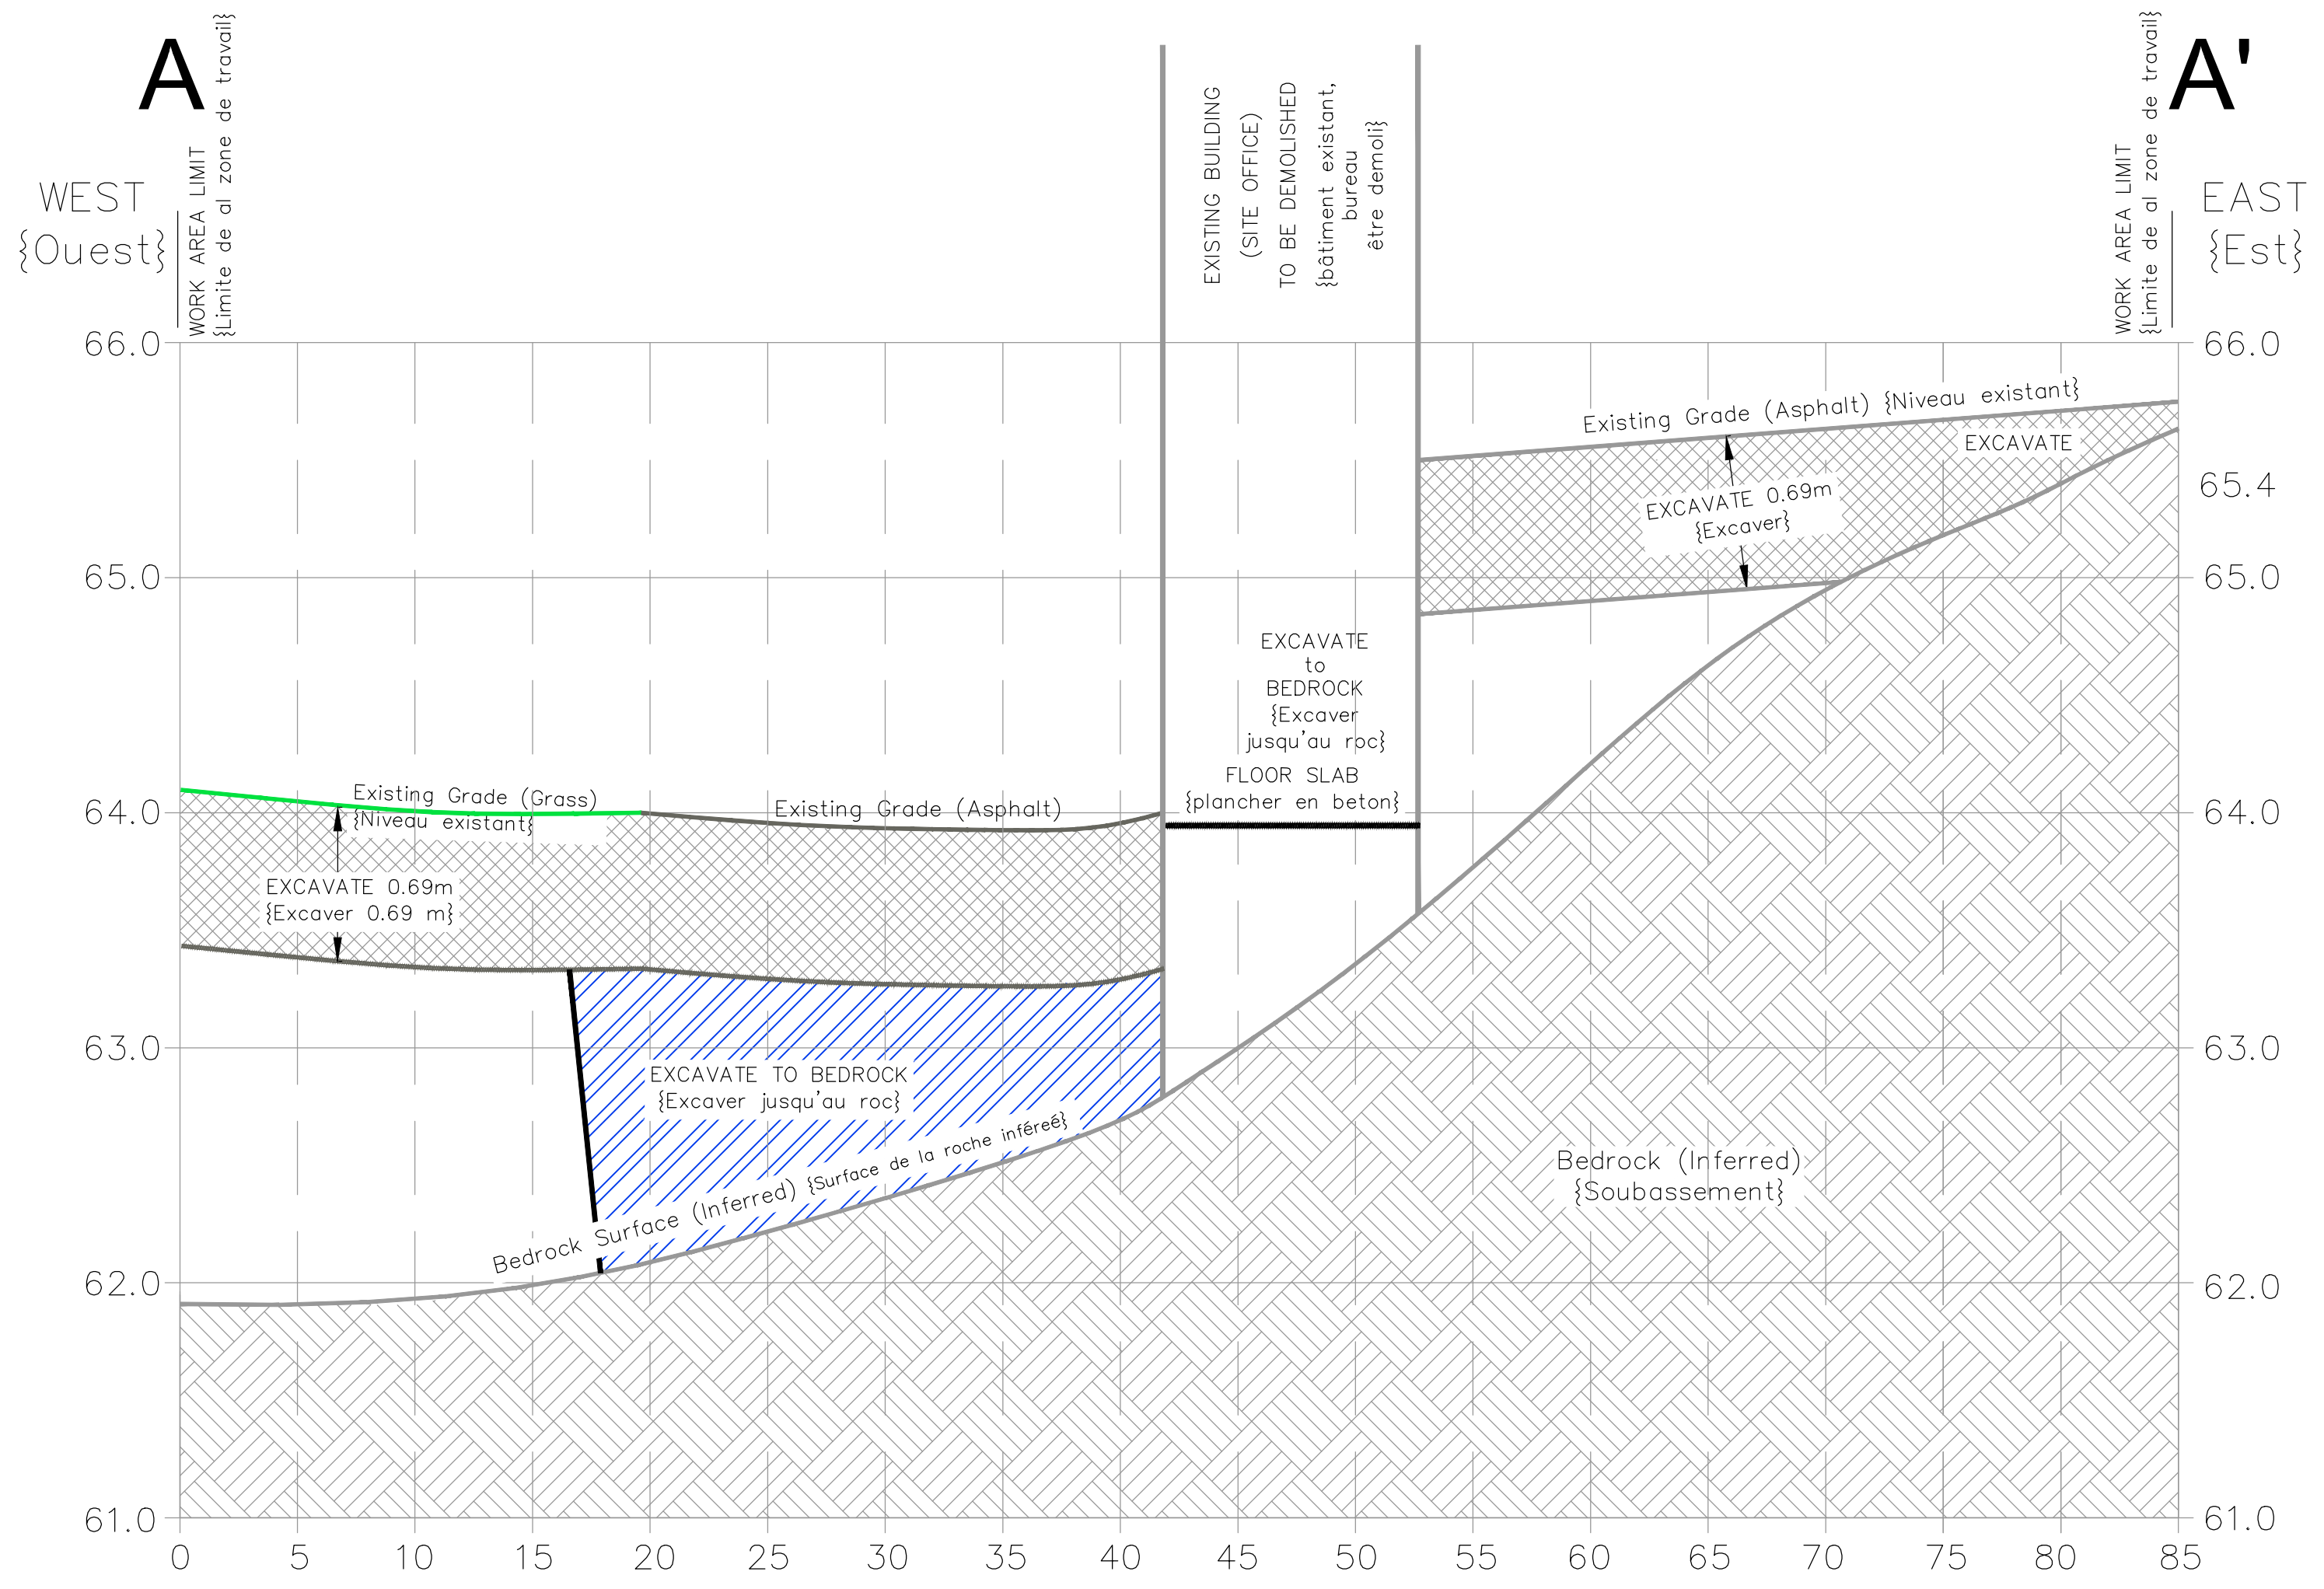

SCALE
HORIZONTAL 1:250
VERTICAL 1:25

consultant
expert-conseil

 **ARCADIS**

LEGEND:

issued or revised émis ou révisé		
4	ISSUED FOR TENDER	30 Sept. 2015
3	EDITS	17 Sept. 2015
2	EDITS	21 Aug. 2015
1	EDITS	23 Feb. 2015
no.	description	date



OPERATIONS ZONE REDEVELOPMENT
RÉNOVATION DE LA ZONE
D'EXPLOITATION

drawing
dessin

SECTION A-A', B-B'

OTTAWA, ONTARIO

approved by approuvé par	T.A.
designed by conçu par	T.A.
drawn by dessiné par	I.S.Z.
date no. du projet	SEPT. 2015 14423 RMA
scale échelle	AS SHOWN SR-4

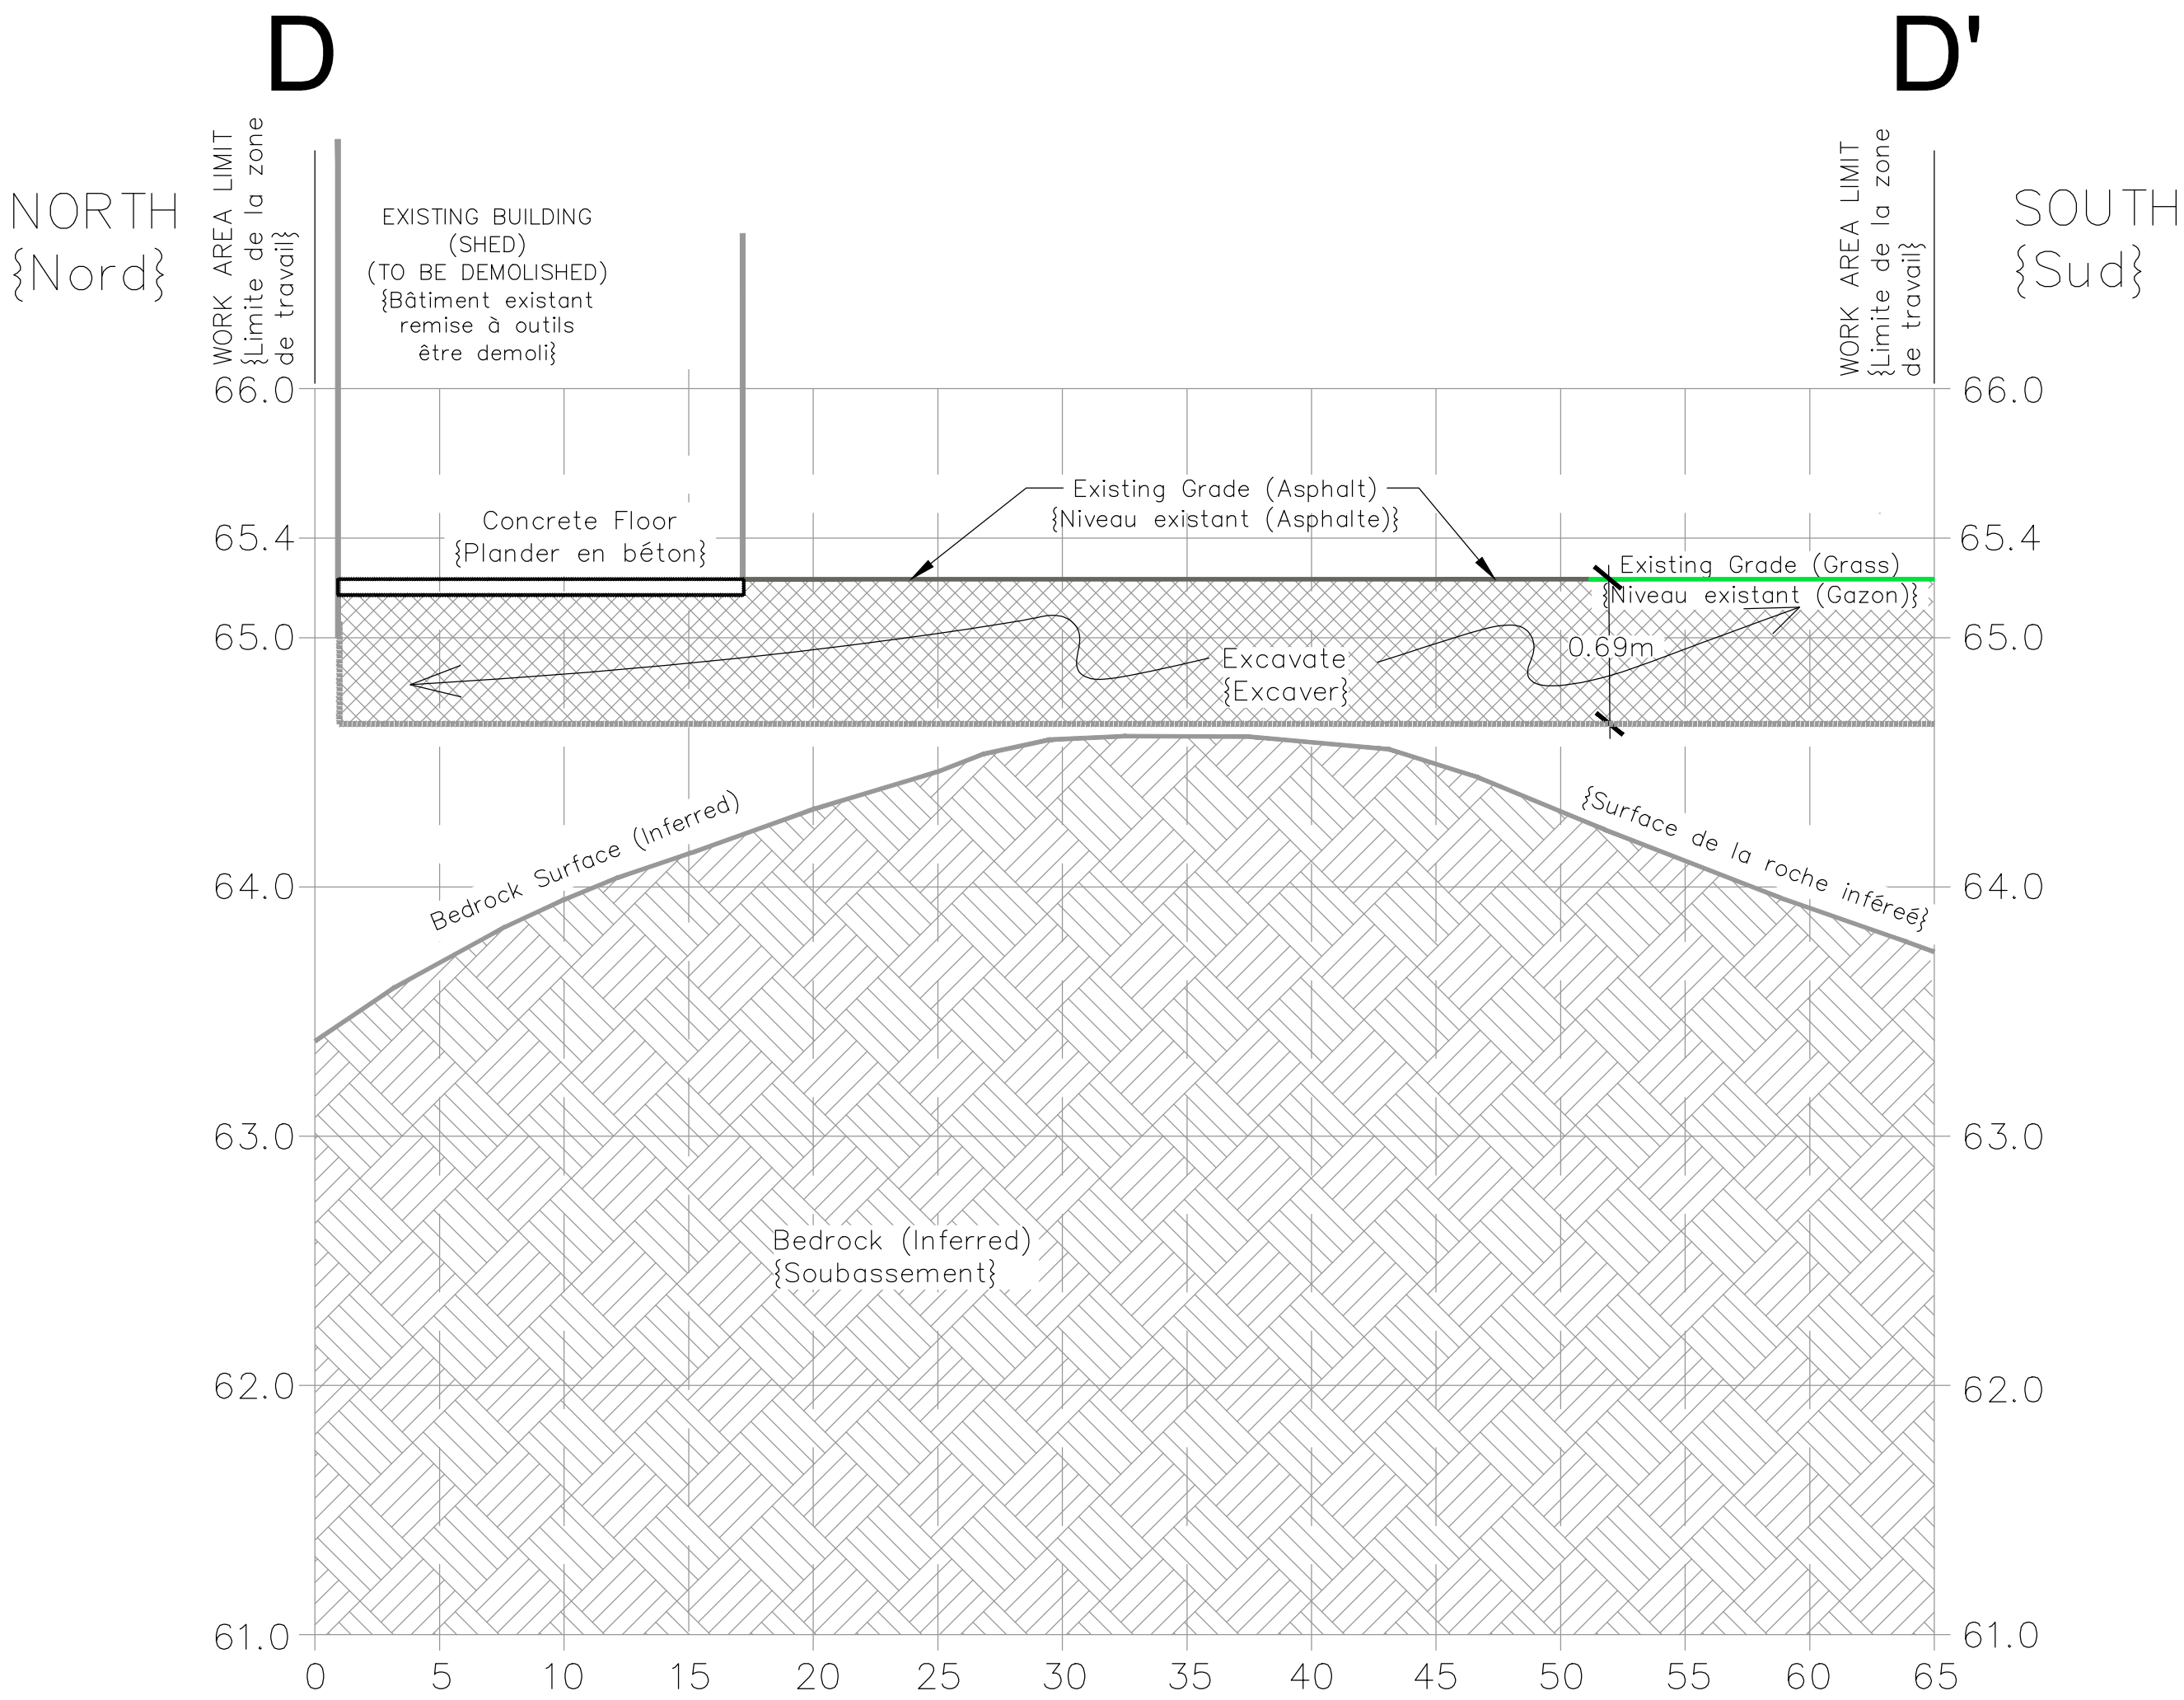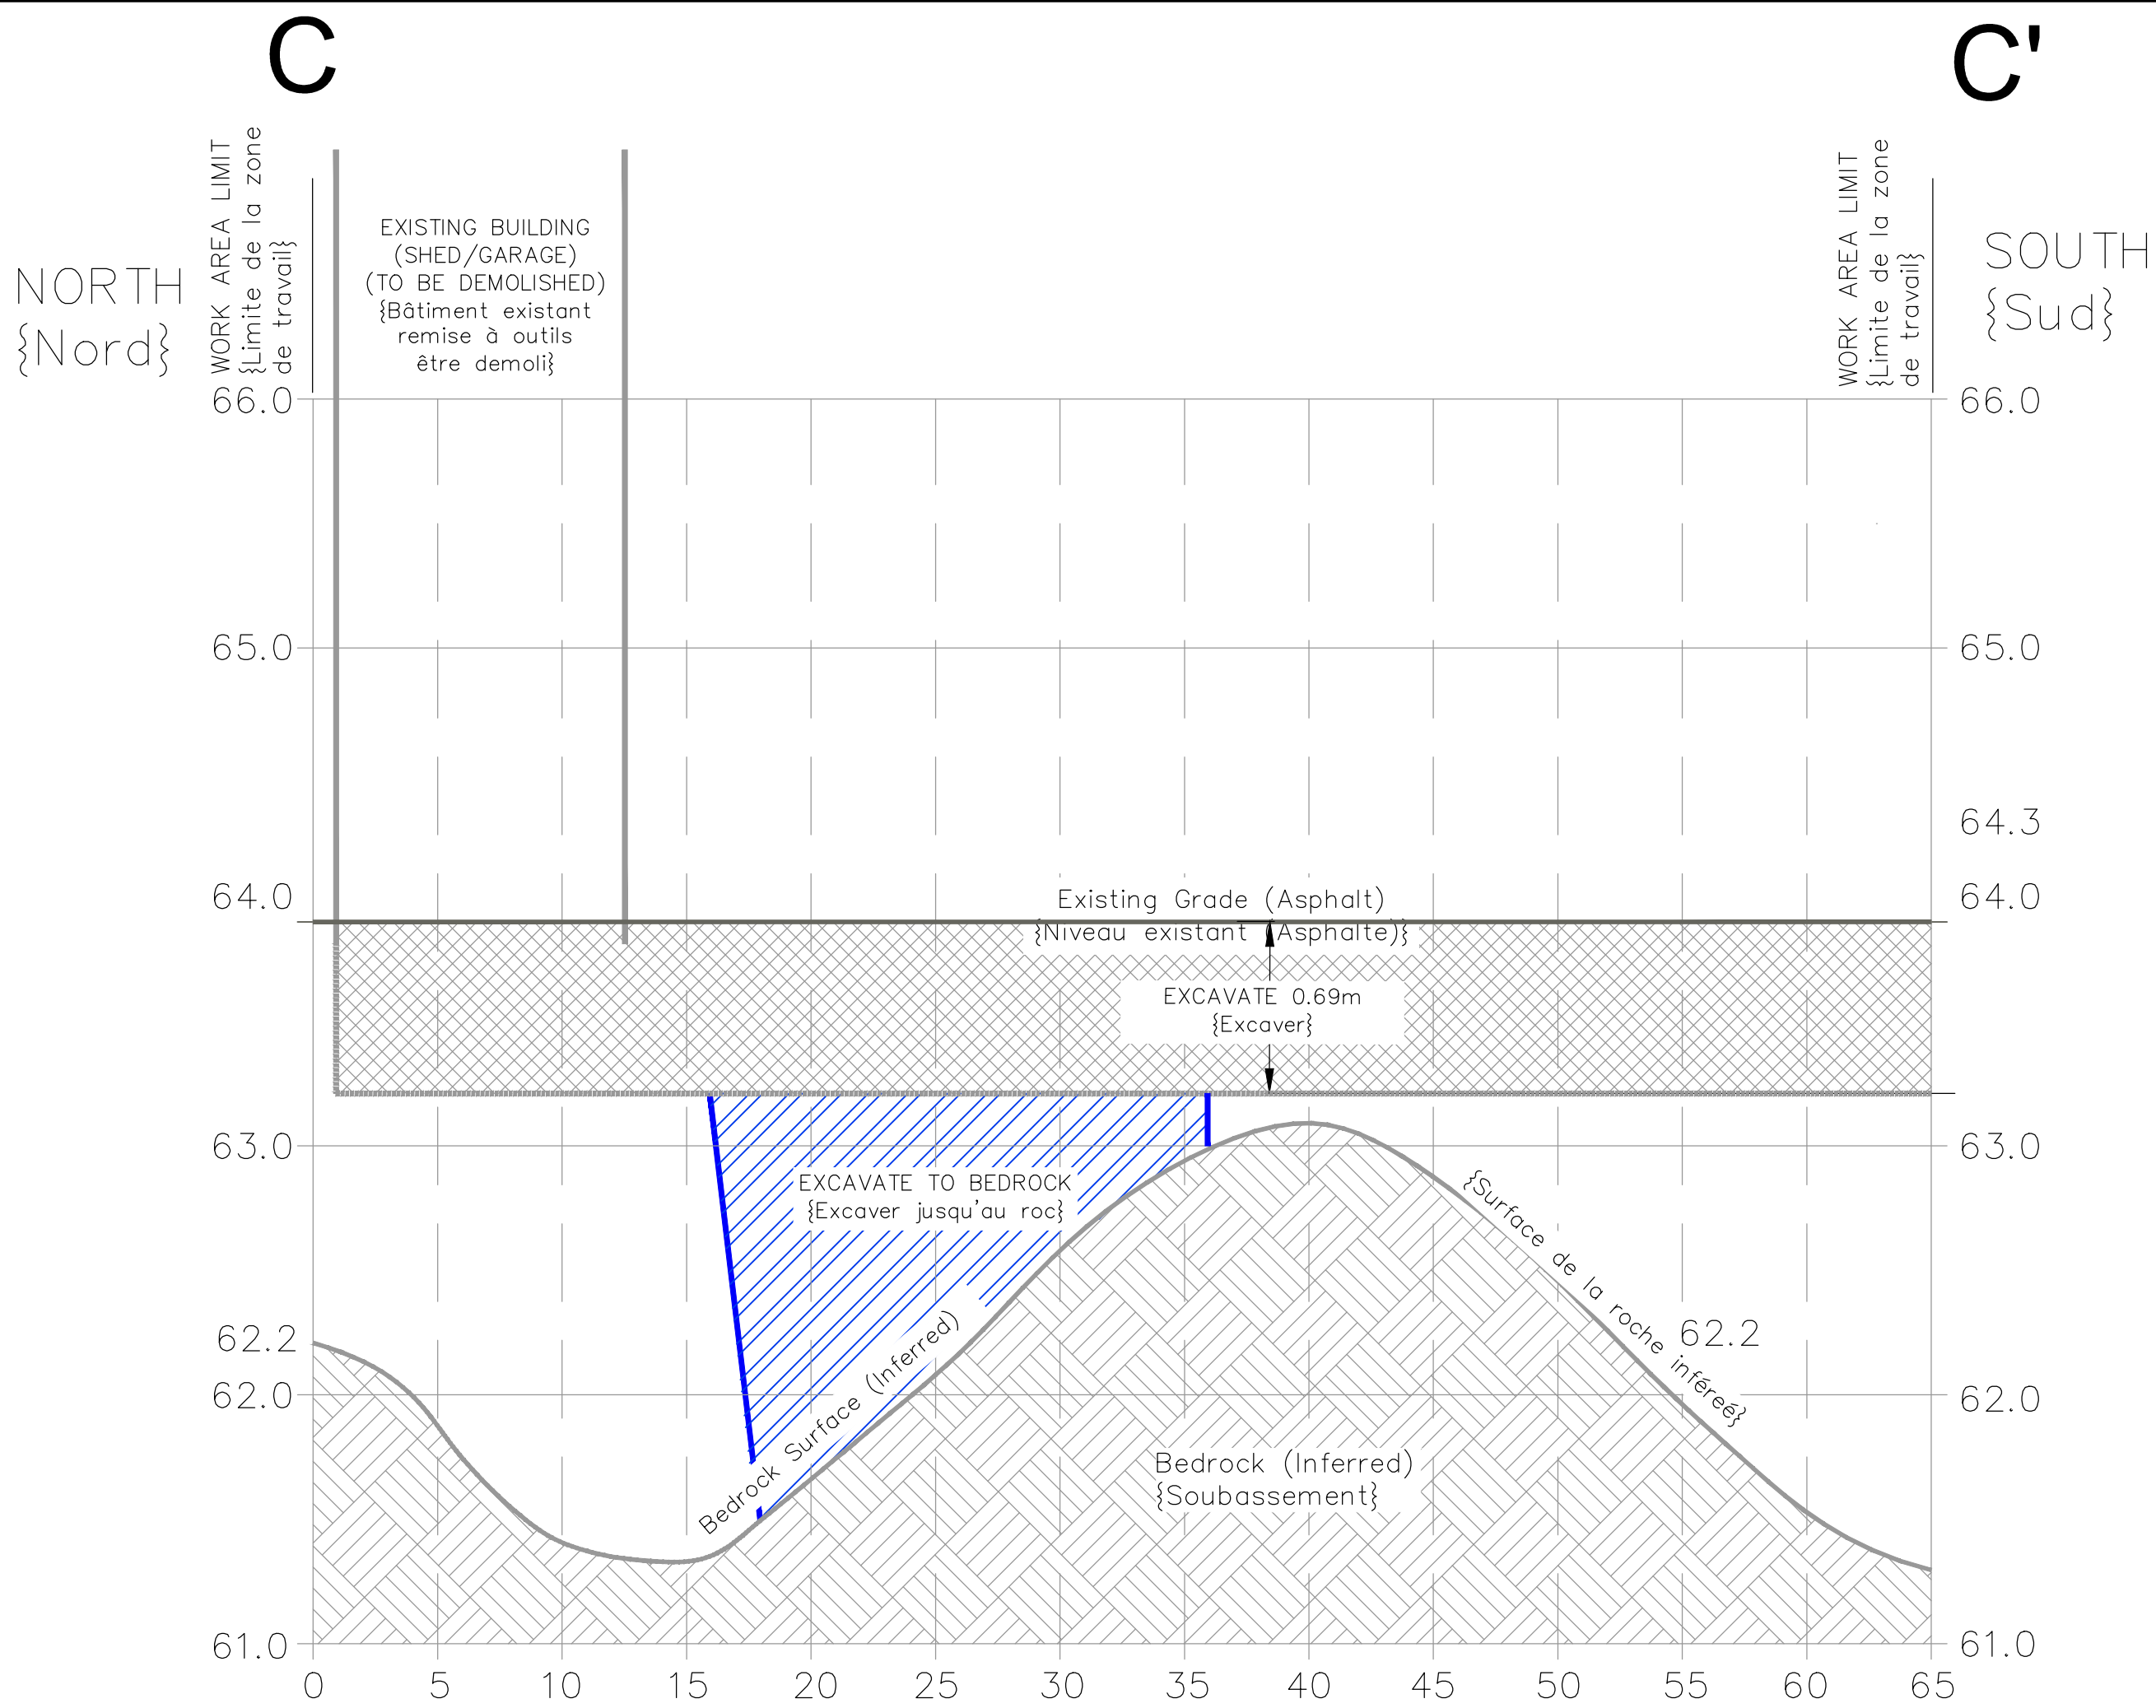

SCALE
HORIZONTAL 1:250
VERTICAL 1:25



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4	ISSUED FOR TENDER	30 Sept. 2015
3	EDITS	17 Sept. 2015
2	EDITS	21 Aug. 2015
1	EDITS	23 Feb. 2015
no.	description	date

project
projet

OPERATIONS ZONE REDEVELOPMENT
RÉNOVATION DE LA ZONE
D'EXPLOITATION

drawing
dessin

SECTION C-C', D-D'

OTTAWA, ONTARIO

approved by approuvé par	T.A.
designed by conçu par	T.A.
drawn by dessiné par	I.S.Z.
date SEPT. 2015	scale échelle AS SHOWN
project no. no. du projet 14423 RMA	sheet no. no. de la feuille SR-5