



SEE INSET FOR  
CONTINUATION

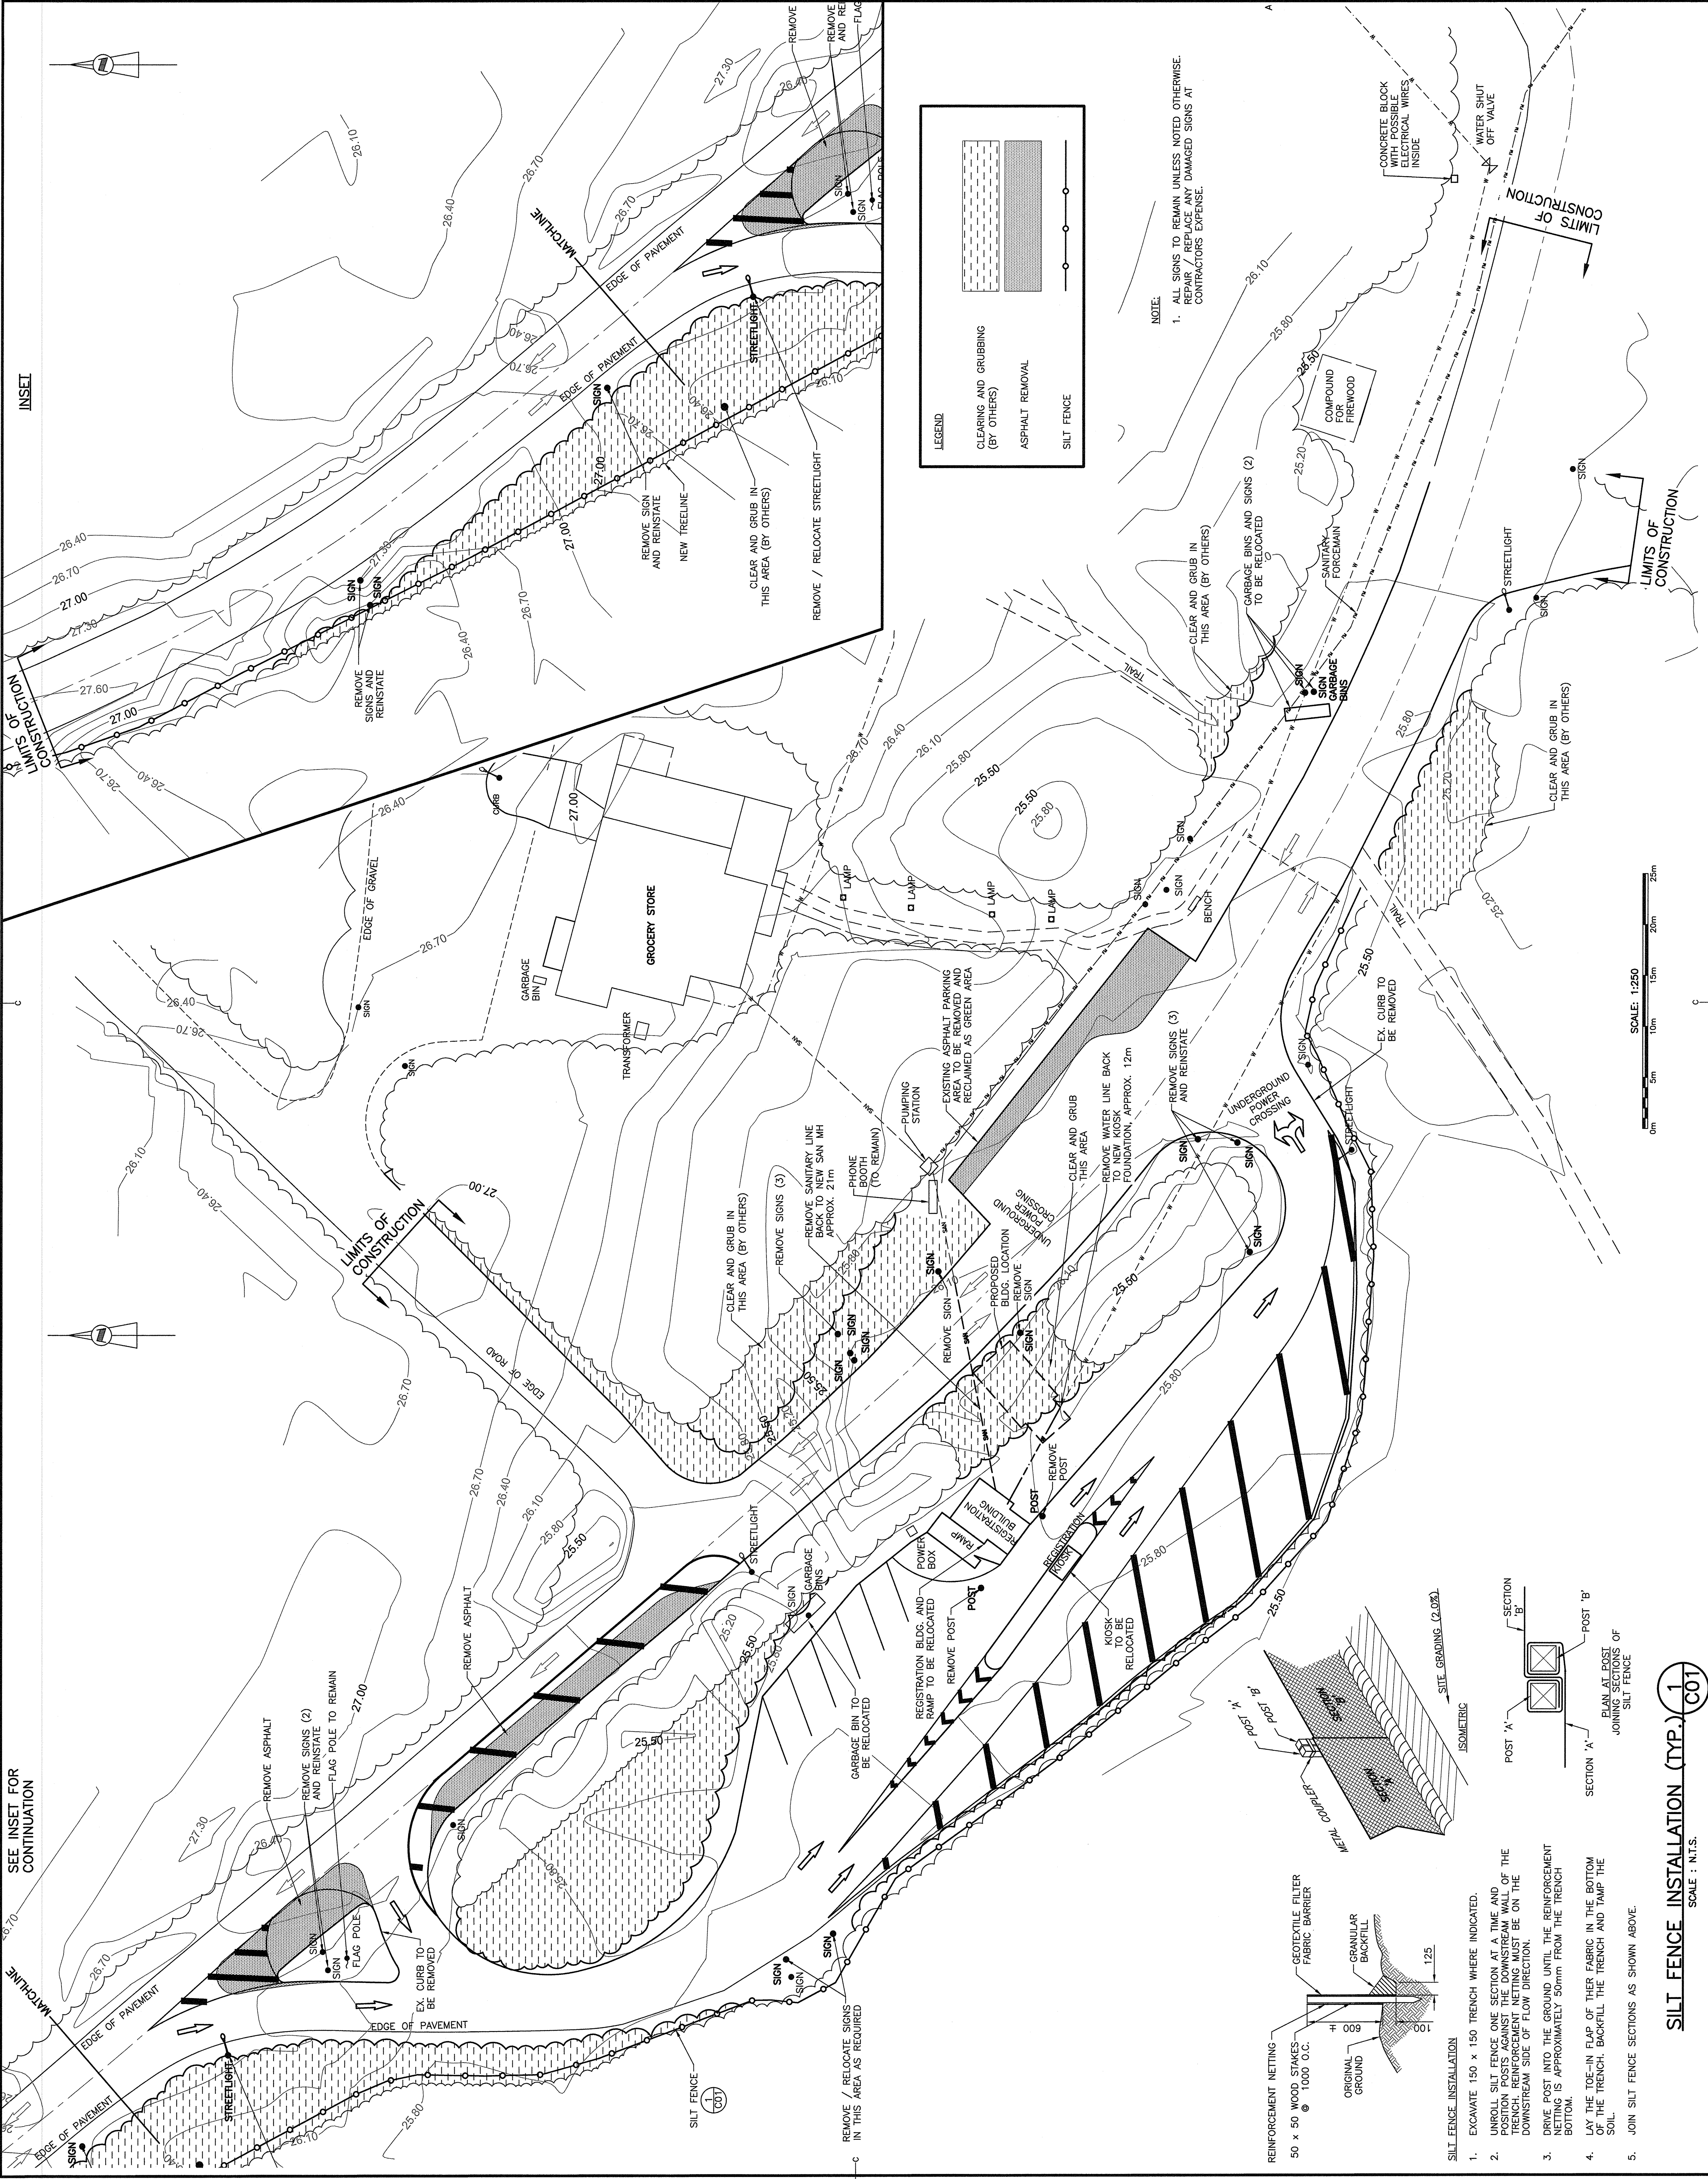


INSET

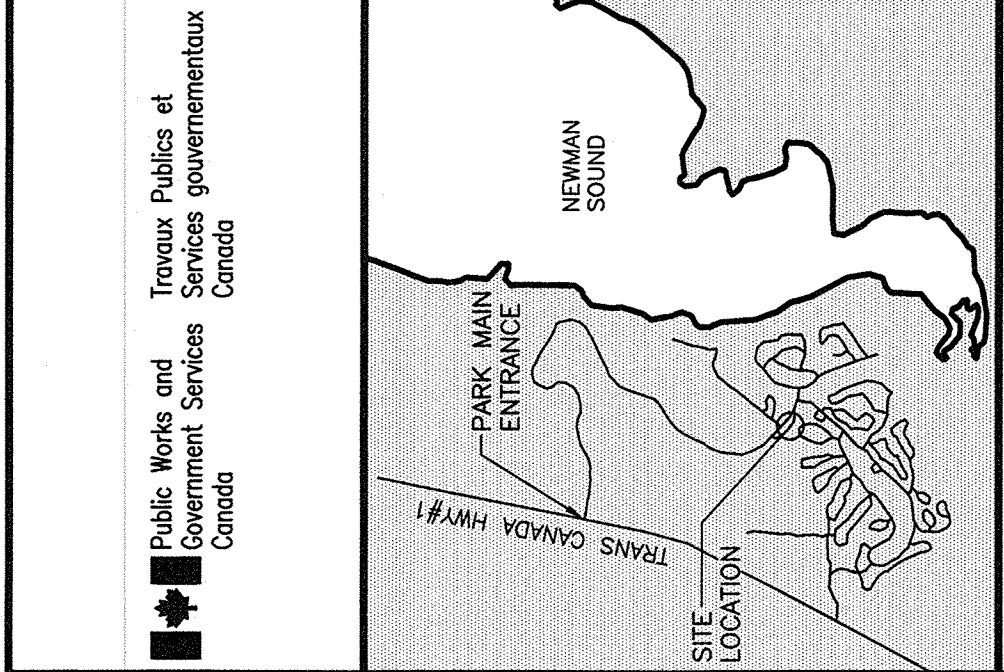

**SNC-LAVALIN**  
SNC-LAVALIN Inc.  
Halifax, Nova Scotia, Canada  
Member of the SNC-LAVALIN Group

PROVINCE OF NEWFOUNDLAND  
PERMIT HOLDER  
CLASS "A"  
The Permit Alone  
SNC-LAVALIN Inc.  
To Practice Professional Engineering  
in the Province of Newfoundland  
Permit No. as issued by PEOENL 803458  
which is valid for the year 2015

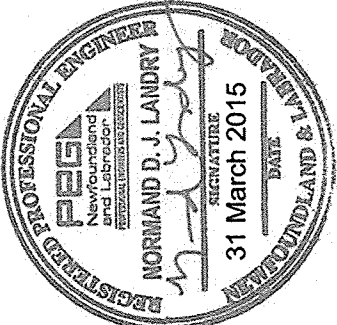

revisions	project
CO1	ISSUED FOR TENDER
CO1	MAR 31 2015
CO1	date

NEWNAM SOUND  
REGISTRATION AREA  
REDESIGN  
TERRA NOVA  
NATIONAL PARK, NL

EXISTING SITE PLAN,  
REMOVALS, EROSION AND  
SEDIMENT CONTROL


designed	AC.M.	checked
date	2014-03-14	drawn
drawn	D.F.B.	designed
date	2014-03-14	approved
approved		date

Tender  
PWSSC Project Manager  
no. du projet  
R.065741.001


drawing no.  
C01

**SILT FENCE INSTALLATION (TYP.)**

1

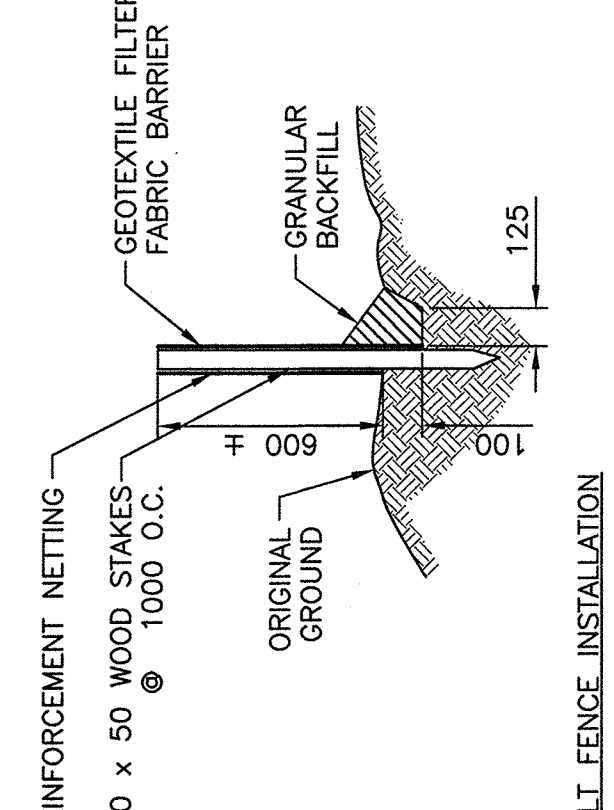

1. EXCAVATE 150 x 150 TRENCH WHERE INDICATED.
2. UNROLL SILT FENCE ONE SECTION AT A TIME AND POSITION POSTS AGAINST THE DOWNSTREAM WALL OF THE TRENCH. REINFORCEMENT NETTING MUST BE ON THE DOWNSTREAM SIDE OF FLOW DIRECTION.
3. DRIVE POST INTO THE GROUND UNTIL THE REINFORCEMENT NETTING IS APPROXIMATELY 50mm FROM THE TRENCH BOTTOM.
4. LAY THE TOE-IN FLAP OF THE FABRIC IN THE BOTTOM OF THE TRENCH. BACKFILL THE TRENCH AND RAMP THE SOIL.
5. JOIN SILT FENCE SECTIONS AS SHOWN ABOVE.

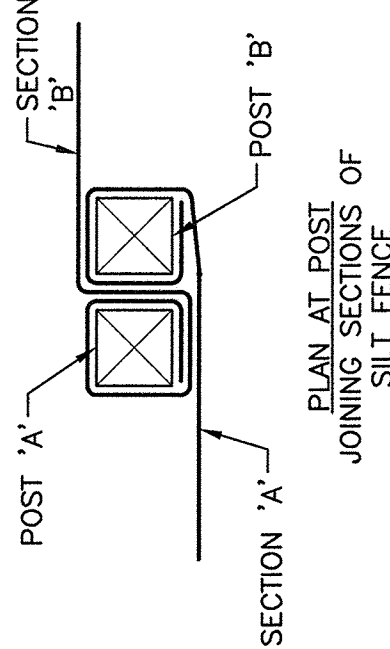

SCALE: 1:250