# CAPE BEALE **LIGHT TOWER** REFURBISHMENT **Fisheries and Oceans Canada**



## STRUCTURAL

#### WSP

Suite 400, 401 Garbally Road Victoria, B C, V8T 5M3 Tel: (250) 384-5510 Fax: (250) 386-2844 Email: randy.emery@wspgroup.com Contact: Randy Emery

## DWG # DESCRIPTION

S000	COVER SHEET
S001	NOTES, SITE PLAN
S002	EXISTING CONDITIONS/DECONSTRUCTION
S003	NEW STRUCTURAL FRAMING
S004	STRUCTURAL SECTIONS & DETAILS

## **BUILDING ENVELOPE**

GOAL Engineering Ltd Unit #9 - 755 Vanalman Avenue Victoria, BC, V8Z 3B8 Tel: (250) 744-3992 Fax: (604) 360-2166 Email: govstaas@goalengineering.com Contact: Greg Ovstaas

DWG # DESCRIPTION

**BUILDING ENVELOPE ELEVATIONS & SECTIONS** D001

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## **ISSUED FOR:** TENDER

DATE: **OCTOBER 9, 2015** 

SET NO.:



SUITE 400-401 GARBALLY ROAD VICTORIA (BRITISH COLUMBIA) CANADA V8T 5M3 TEL.: 250-384-5510 | FAX: 250-386-2844 | WWW.WSPGROUP.COM

WSP PROJECT NO: DFO PROJECT NO: CCG DRAWING NO: 131-19104-11 F1700-150861 10247

### **GENERAL NOTES**

- 1. CONTRACTOR TO VERIFY ALL DIMENSIONS FOR BUILDING (INCLUDING EXISTING STRUCTURAL MEMBER SIZES) PRIOR TO COMMENCEMENT OF WORK AND NOTIFY DEPARTMENTAL REPRESENTATIVE OF ANY DISCREPANCIES.
- 2. DRAWINGS SHOW THE COMPLETED PROJECT. THEY DO NOT SHOW COMPONENTS WHICH MAY BE NECESSARY FOR CONSTRUCTION SAFETY. CONTRACTOR IS RESPONSIBLE FOR SAFETY ON AND ABOUT THE JOB SITE DURING CONSTRUCTION.
- 3. CONTRACTOR TO ENSURE THAT ALL WORK IS CARRIED OUT BY THE RULES AND CUSTOMS OF THE BEST TRADE PRACTICES AND THEIR SPECIFICATIONS BY SKILLED TRADES PEOPLE KNOWLEDGEABLE OF THE TYPE OF CONSTRUCTION. THEY ARE TO BE PROPERLY EQUIPPED AND SUPERVISED.
- 4. NOTIFY DEPARTMENTAL REPRESENTATIVE 96 HOURS IN ADVANCE FOR CONSTRUCTION REVIEW OF THE WORK.

#### 5. STRUCTURAL DESIGN DATA.

a. ENGINEER OF RECORD: RANDALL EMERY, P.ENG. (STRUCTURAL) GREG OVSTAAS, P. ENG. (BUILDING ENVELOPE) b. DESIGN CODE - NATIONAL BUILDING CODE OF CANADA 2010.

DESI	DESIGN PARAMETERS					
BUILI	BUILDING IMPORTANCE CATEGORY NORMAL					
SNO\	SNOW LOAD PARAMETERS					
	Ss = 1.1 kPa Sr = 0.40 kPa Is [ULS] = 1.0 Is [SLS] = 0.9					
WINE	WIND LOAD PARAMETERS					
	q50 = 0.68 kPa lw [ULS] = 1.0 lw [SLS] = 0.75					
SEISI	SEISMIC PARAMETERS					
	Sa(0.2) = 1.2 Sa(0.5) = 0.94 Sa(1.0) = 0.48 Sa(2.0) = 0.21 PGA = 0.52					
	le = 1.0					
	SITE CLASS: C (ASSUMED)					
DESI	DESIGN LOADS					
GRAVITY						
		SNOW (kPa)	LIVE (kPa)	DEAD (kPa)	PARTITION (kPa)	
	ROOF	1.28	-	1.00	-	
	FLOORS	-	2.40	1.00	-	
LATE	LATERAL - WIND					
	DESIGN WALL PRESSURE FOR WALL CLADDING AND SUPPORT FRAMING - CAPE BEALE					
	STRENGTH (FACTORED) 3.54 kPa					
	DEFLECTION	1.90 kPa				

## STRUCTURAL STEEL NOTES

1. STRUCTURAL STEEL TO CONFORM TO THE REQUIREMENTS OF THE FOLLOWING STANDARDS: CHANNELS, ANGLES & PLATE: G40.21 300W HSS & LIGHT GAUGE SECTIONS: G40.21 350W BOLTS STEEL CONNE


	BOLTS STEEL CONNECTIONS:	ASTM A325 (HDG)
	ANCHOR BOLTS:	ASTM F593 (AISI 316)
	BOLTS (WOOD PLATES):	ASTM F593 (AISI 316)
2.	FABRICATION, ERECTION, STRUCTURAL DESIGN	& DETAILING OF ALL STRUCTURAL STEEL TO BE IN ACCORDANCE WITH


- CAN/CSA-S16-09.
- 3. ALL WELDING TO CONFORM TO CSA W59 AND BE PERFORMED BY FABRICATORS "FULLY APPROVED" BY THE CANADIAN WELDING BUREAU UNDER CSA W47. FABRICATING SHOP TO HAVE A DIVISION 10R 2 CERTIFICATION BY THE CANADIAN WELDING BUREAU TO THE REQUIREMENTS OF CSA W47.1 AND SUBMIT PROOF OF CERTIFICATION PRIOR TO START OF WORK.
- 4. FIELD WELDING IS NOT PERMITTED.


5. STRUCTURAL STEEL SHOP DRAWINGS: SUBMIT 4 COPIES OF SHOP DRAWINGS TO THE DEPARTMENTAL REPRESENTATIVE FOR REVIEW PRIOR TO FABRICATION. THE CONTRACTOR SHALL BE RESPONSIBLE FOR ALL DIMENSIONS AND FIT-UP OF ALL COMPONENTS.


## WOOD FRAMING NOTES

- 1. ALL STRUCTURAL LUMBER SHALL HAVE AN AVERAGE EQUILIBRIUM MOISTURE CONTENT NOT EXCEEDING 15% OR LESS OVER A YEAR AND NOT EXCEEDING 19% AT ANY TIME. ALL WOOD TO BE PRESSURE TREATED.
- 2. SAWN LUMBER FRAMING GRADES AND SPECIES SHALL CONFORM TO STRUCTURAL LUMBER COMPLYING WITH THE REQUIREMENTS OF CSA STANDARD CAN/CSA-0141. ALL WOOD TO BE HEM-FIR GRADE SELECT STRUCTURAL.
- 3. NAILS AND SPIKES: TO CSA-B111.
- 4. BOLTS: 9.5mm [3/8"] DIAMETER CARRIAGE BOLTS TO ASTM F593 (AISI 316), COMPLETE WITH NUTS AND WASHERS, UNLESS SHOWN OTHERWISE.
- 5. WOOD PRESERVATIVES SHALL CONFORM TO AND BE APPLIED IN ACCORDANCE WITH CSA-080-M. WOOD PRESERVATION SHALL BE EITHER ALKALINE COPPER QUATERNARY (ACQ) OR COPPER AZOLE (CA). ACQ MAYBE EITHER TYPE ACQ-B (AMMONIACAL) OR TYPE ACQ-D (AMINE). PRESERVATIVES SHALL BE APPLIED TO THE WOOD IN A WATER SOLUTION, TO RETENTION LEVELS RECOMMENDED BY THE MANUFACTURER. FIELD TREAT ALL CUT ENDS, NOTCHES AND BOLT HOLES. SUBMIT PRESERVATIVE SPECIFICATIONS TO THE DEPARTMENTAL REPRESENTATIVE FOR APPROVAL. WOOD PRESERVATIVES TO CONFORM TO REQUIREMENT OF LOCAL AUTHORITY.
- 6. NAILS, BOLTS AND METALS IN CONTACT WITH PRESERVED WOOD PRODUCTS SHALL BE HOT DIPPED GALVANIZED TO STANDARD ASTM A153 WITH A G185 GALVANIZING DESIGNATION THAT MEETS ASTM A653. STAINLESS STEEL CAN ALSO BE USED.

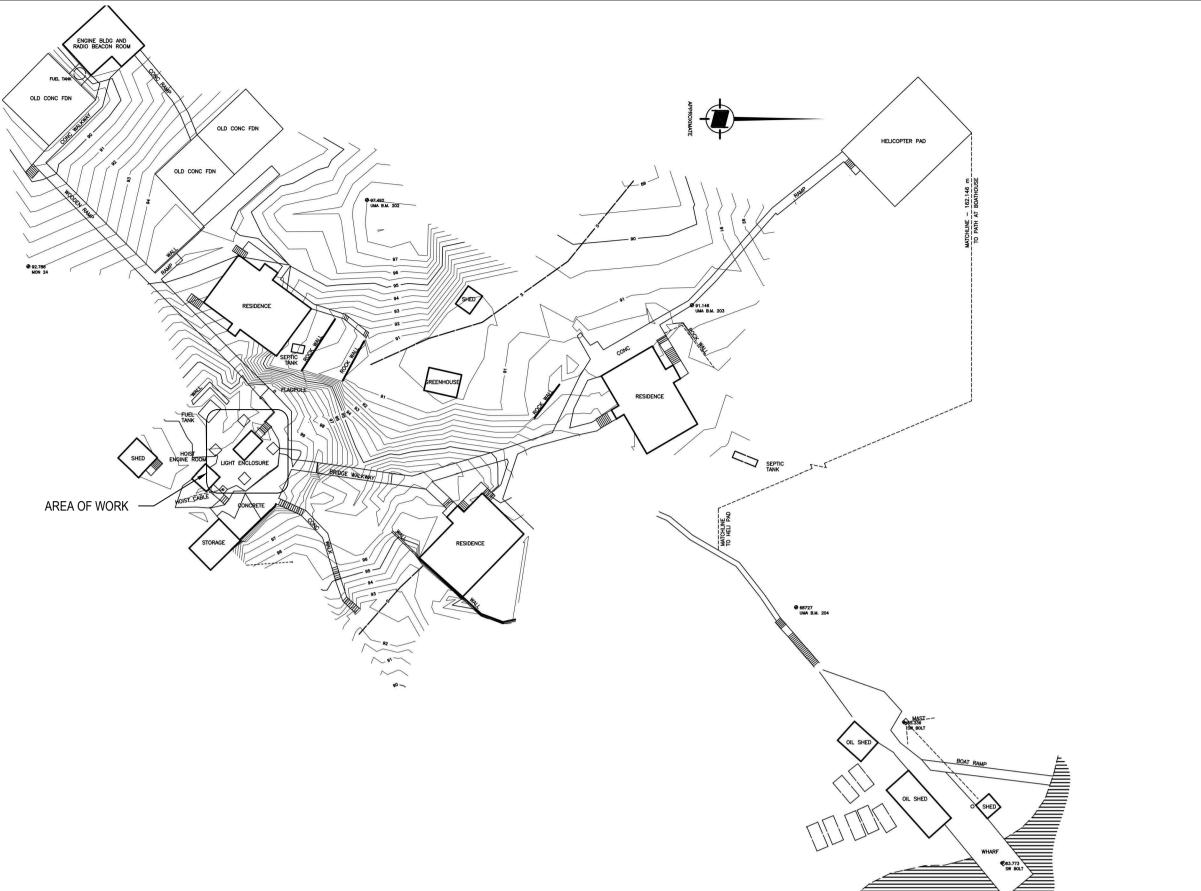

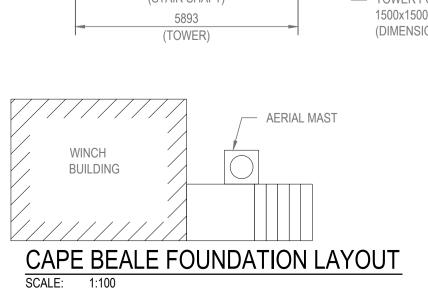


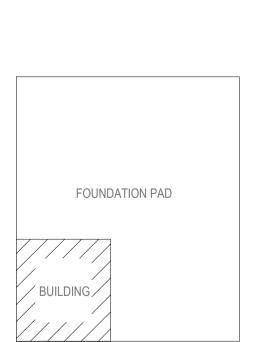

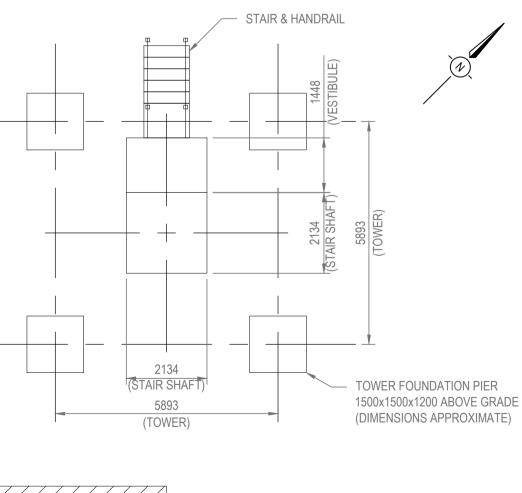



CAPE BEALE SITE PLAN SCALE: N.T.S.


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Diana Isalnd	× *	YANCOUVER	SUITE 400-401 GARBALLY ROAD VICTORIA (BRITISH COLUMBIA) CANADA V8T 5M3 TEL.: 250-384-5510   FAX: 250-386-2844   WWW.WSPGROUP.COM JOB No. 131-19104-11		
CAPE SCALE:	BE N.T.S		R. GEMERY BBITSH 2015-10-13 2015-10-13		
			SCALE 1:1 0 20 40 60 20 SCALE IN MILLIMETRES DO NOT SCALE DRAWINGS 5 4 3 2 1 ISSUED FOR TENDER 10/09/2015		
			0 90% SUBMISSION FOR REVIEW 08/26/2015   Revision/ Revision Description/Description Date/Date   Client/client Fisheries and Oceans Canada		
ABBREVIAT	IONS		25 Huron Street Victoria, BC Project title/Titre du projet		
AB ALT APPROX BOT BLDG BP BS CP	-	APPROXIMATELY			
C/W DWG (E) EF EW		COMPLETE WITH DRAWING EXISTING EACH FACE EACH WAY	Approved by/Approuve par Designed by/Concept par RANDALL EMERY, P. ENG Drawn by/Dessine par		
FTG GALV HORIZ HDG	- - -	FOOTING GALVANIZED HORIZONTAL HOT DIPPED GALVANIZED	ROD MAR/2015.08/04 PWGSC Project Manager/Administrateur de Projets TPSGC PWGSC, Architectural and Engineering Resources Manager/ Ressources Architectural et de Directeur d'Ingénierie, TPSGC		
LG MAX MIN (N) NS		LONG MAXIMUM MINIMUM NEW NEAR SIDE	Client/client Drawing title/Titre du dessin		
NTS PT OC R/W REINF SS		NOT TO SCALE PRESSURE TREATED ON CENTER REINFORCE WITH REINFORCEMENT STAINLESS STEEL	NOTES SITE PLAN		
STD TYP U/N VERT	- - -	STANDARD TYPICAL UNLESS NOTED VERTICAL	Project No./No. du projetSheet/FeuilleRevision no./ La Révision no.F1700-150861 CCG Drawing No./No. du dessin 10247Sheet/FeuilleImage: Comparison no./ La Révision no.1 OF 5		

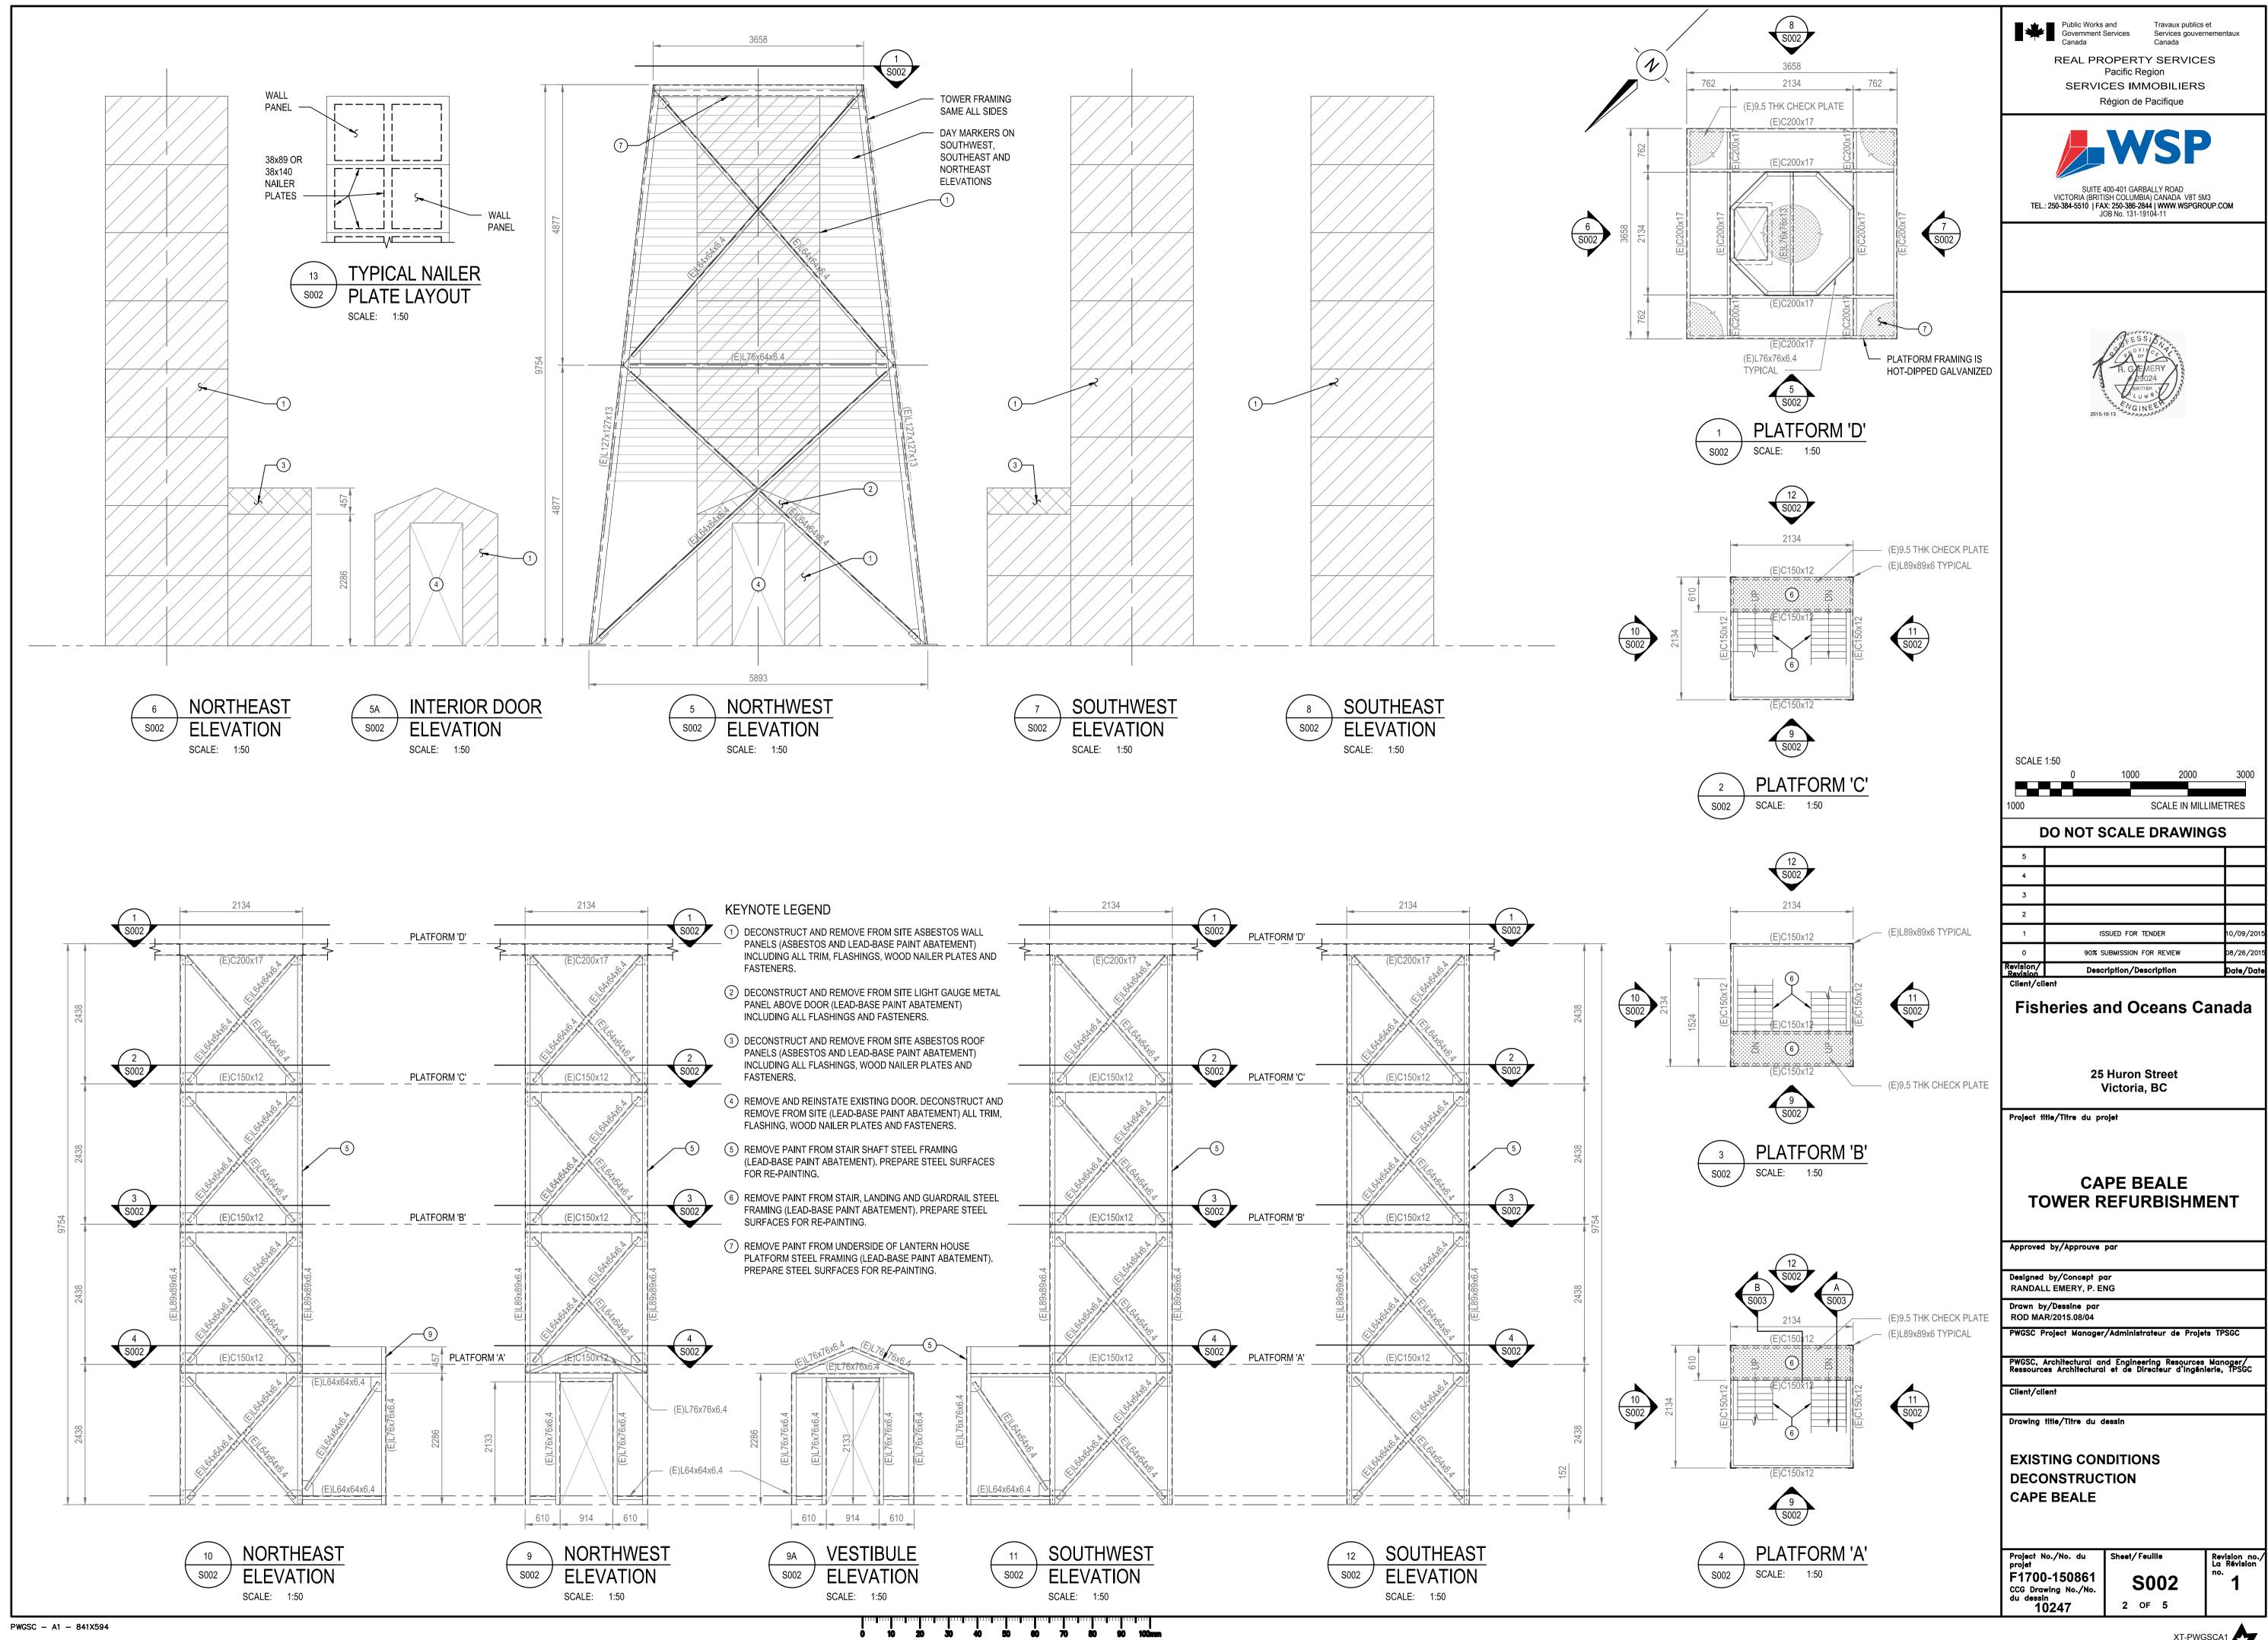

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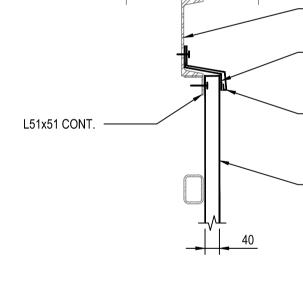


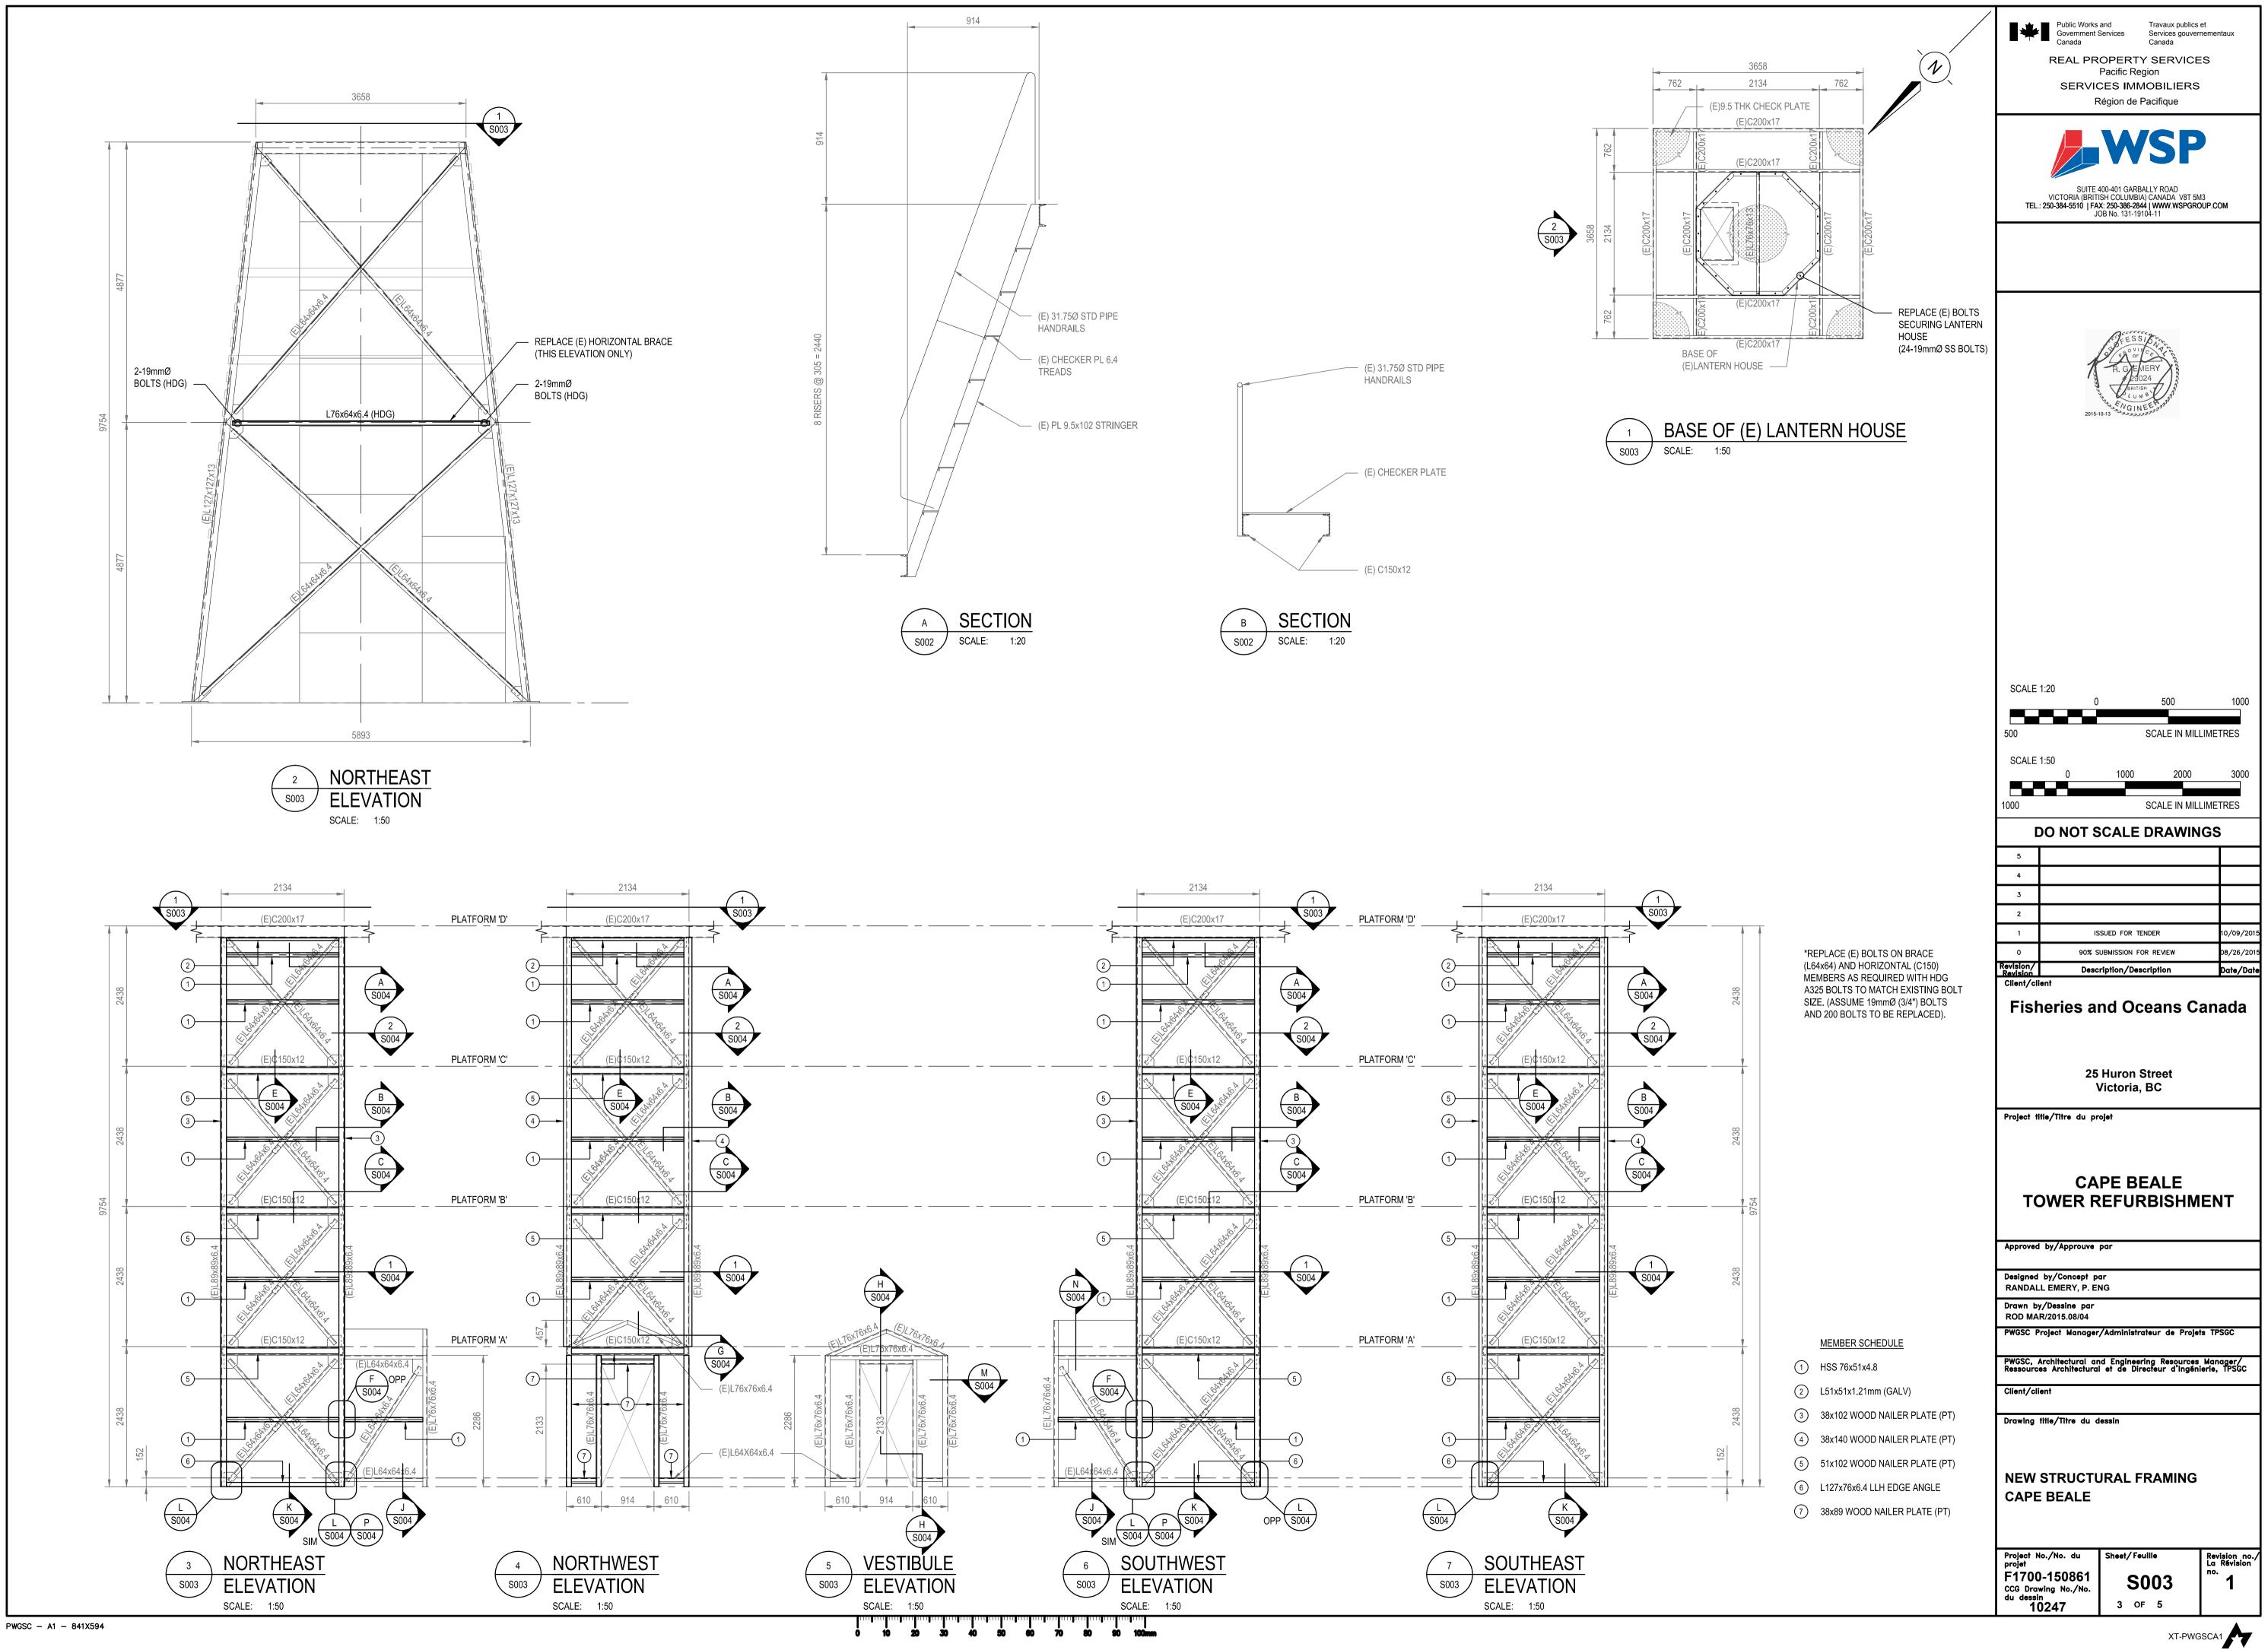

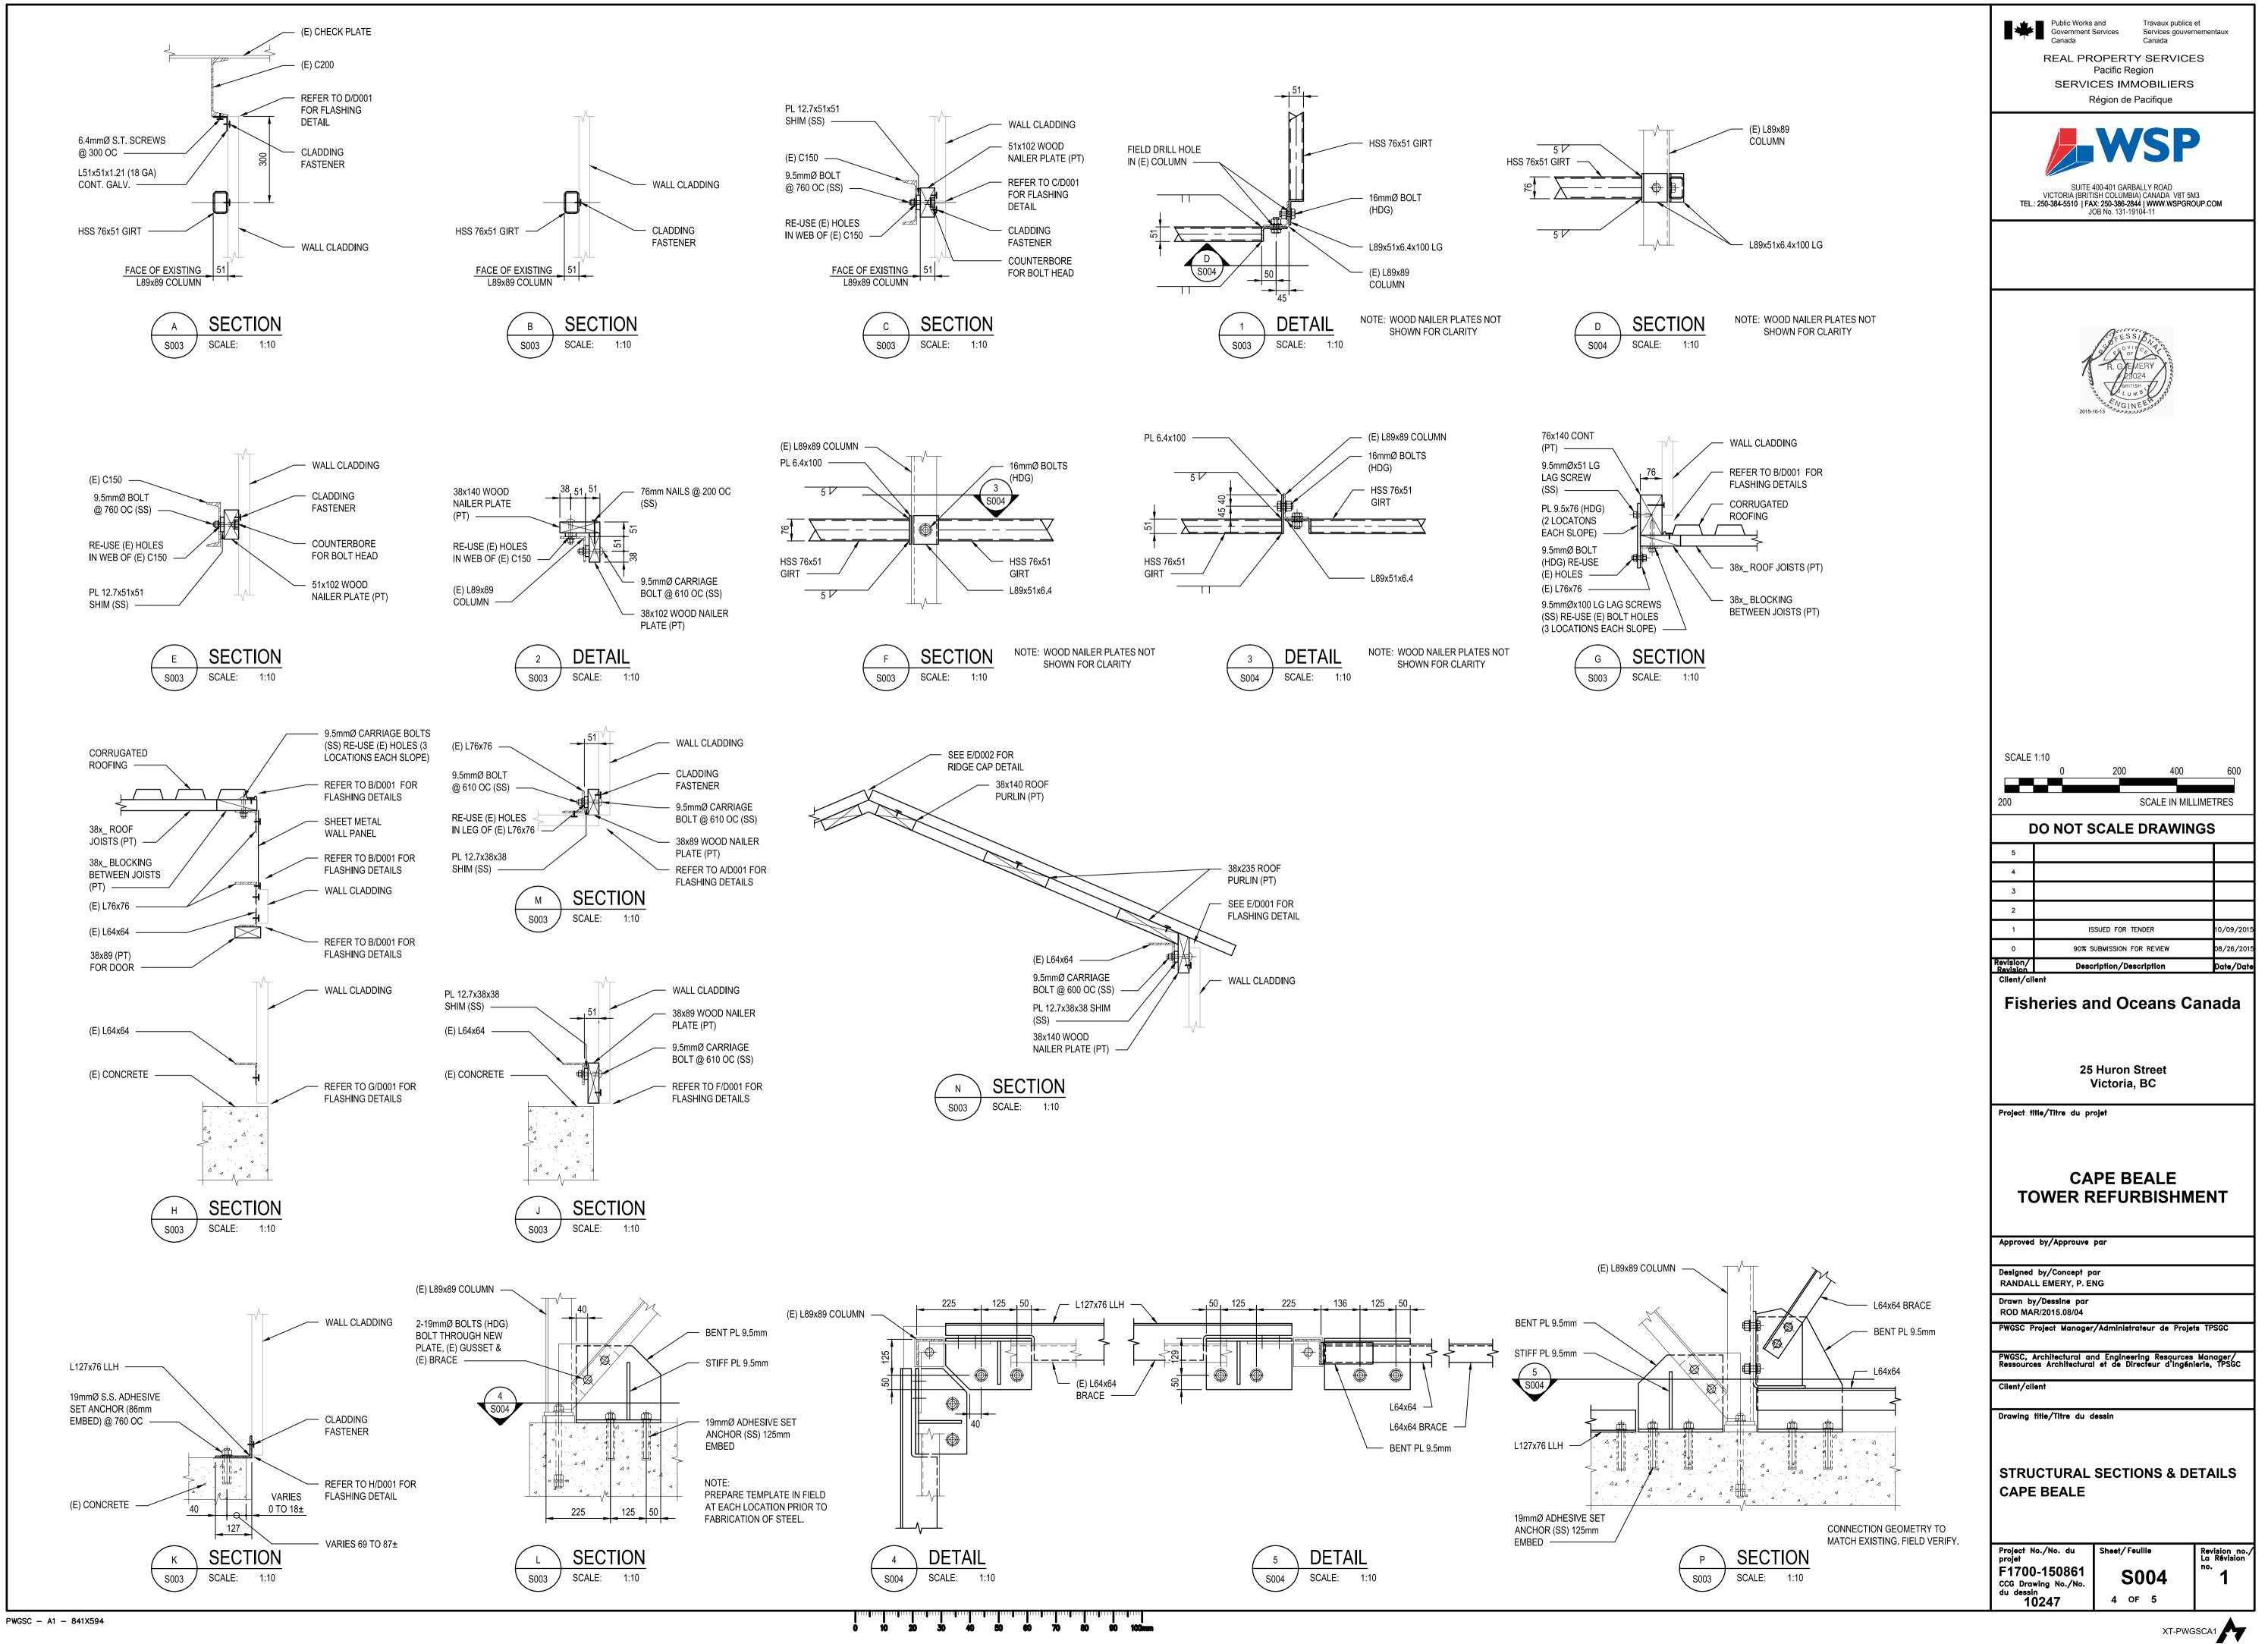

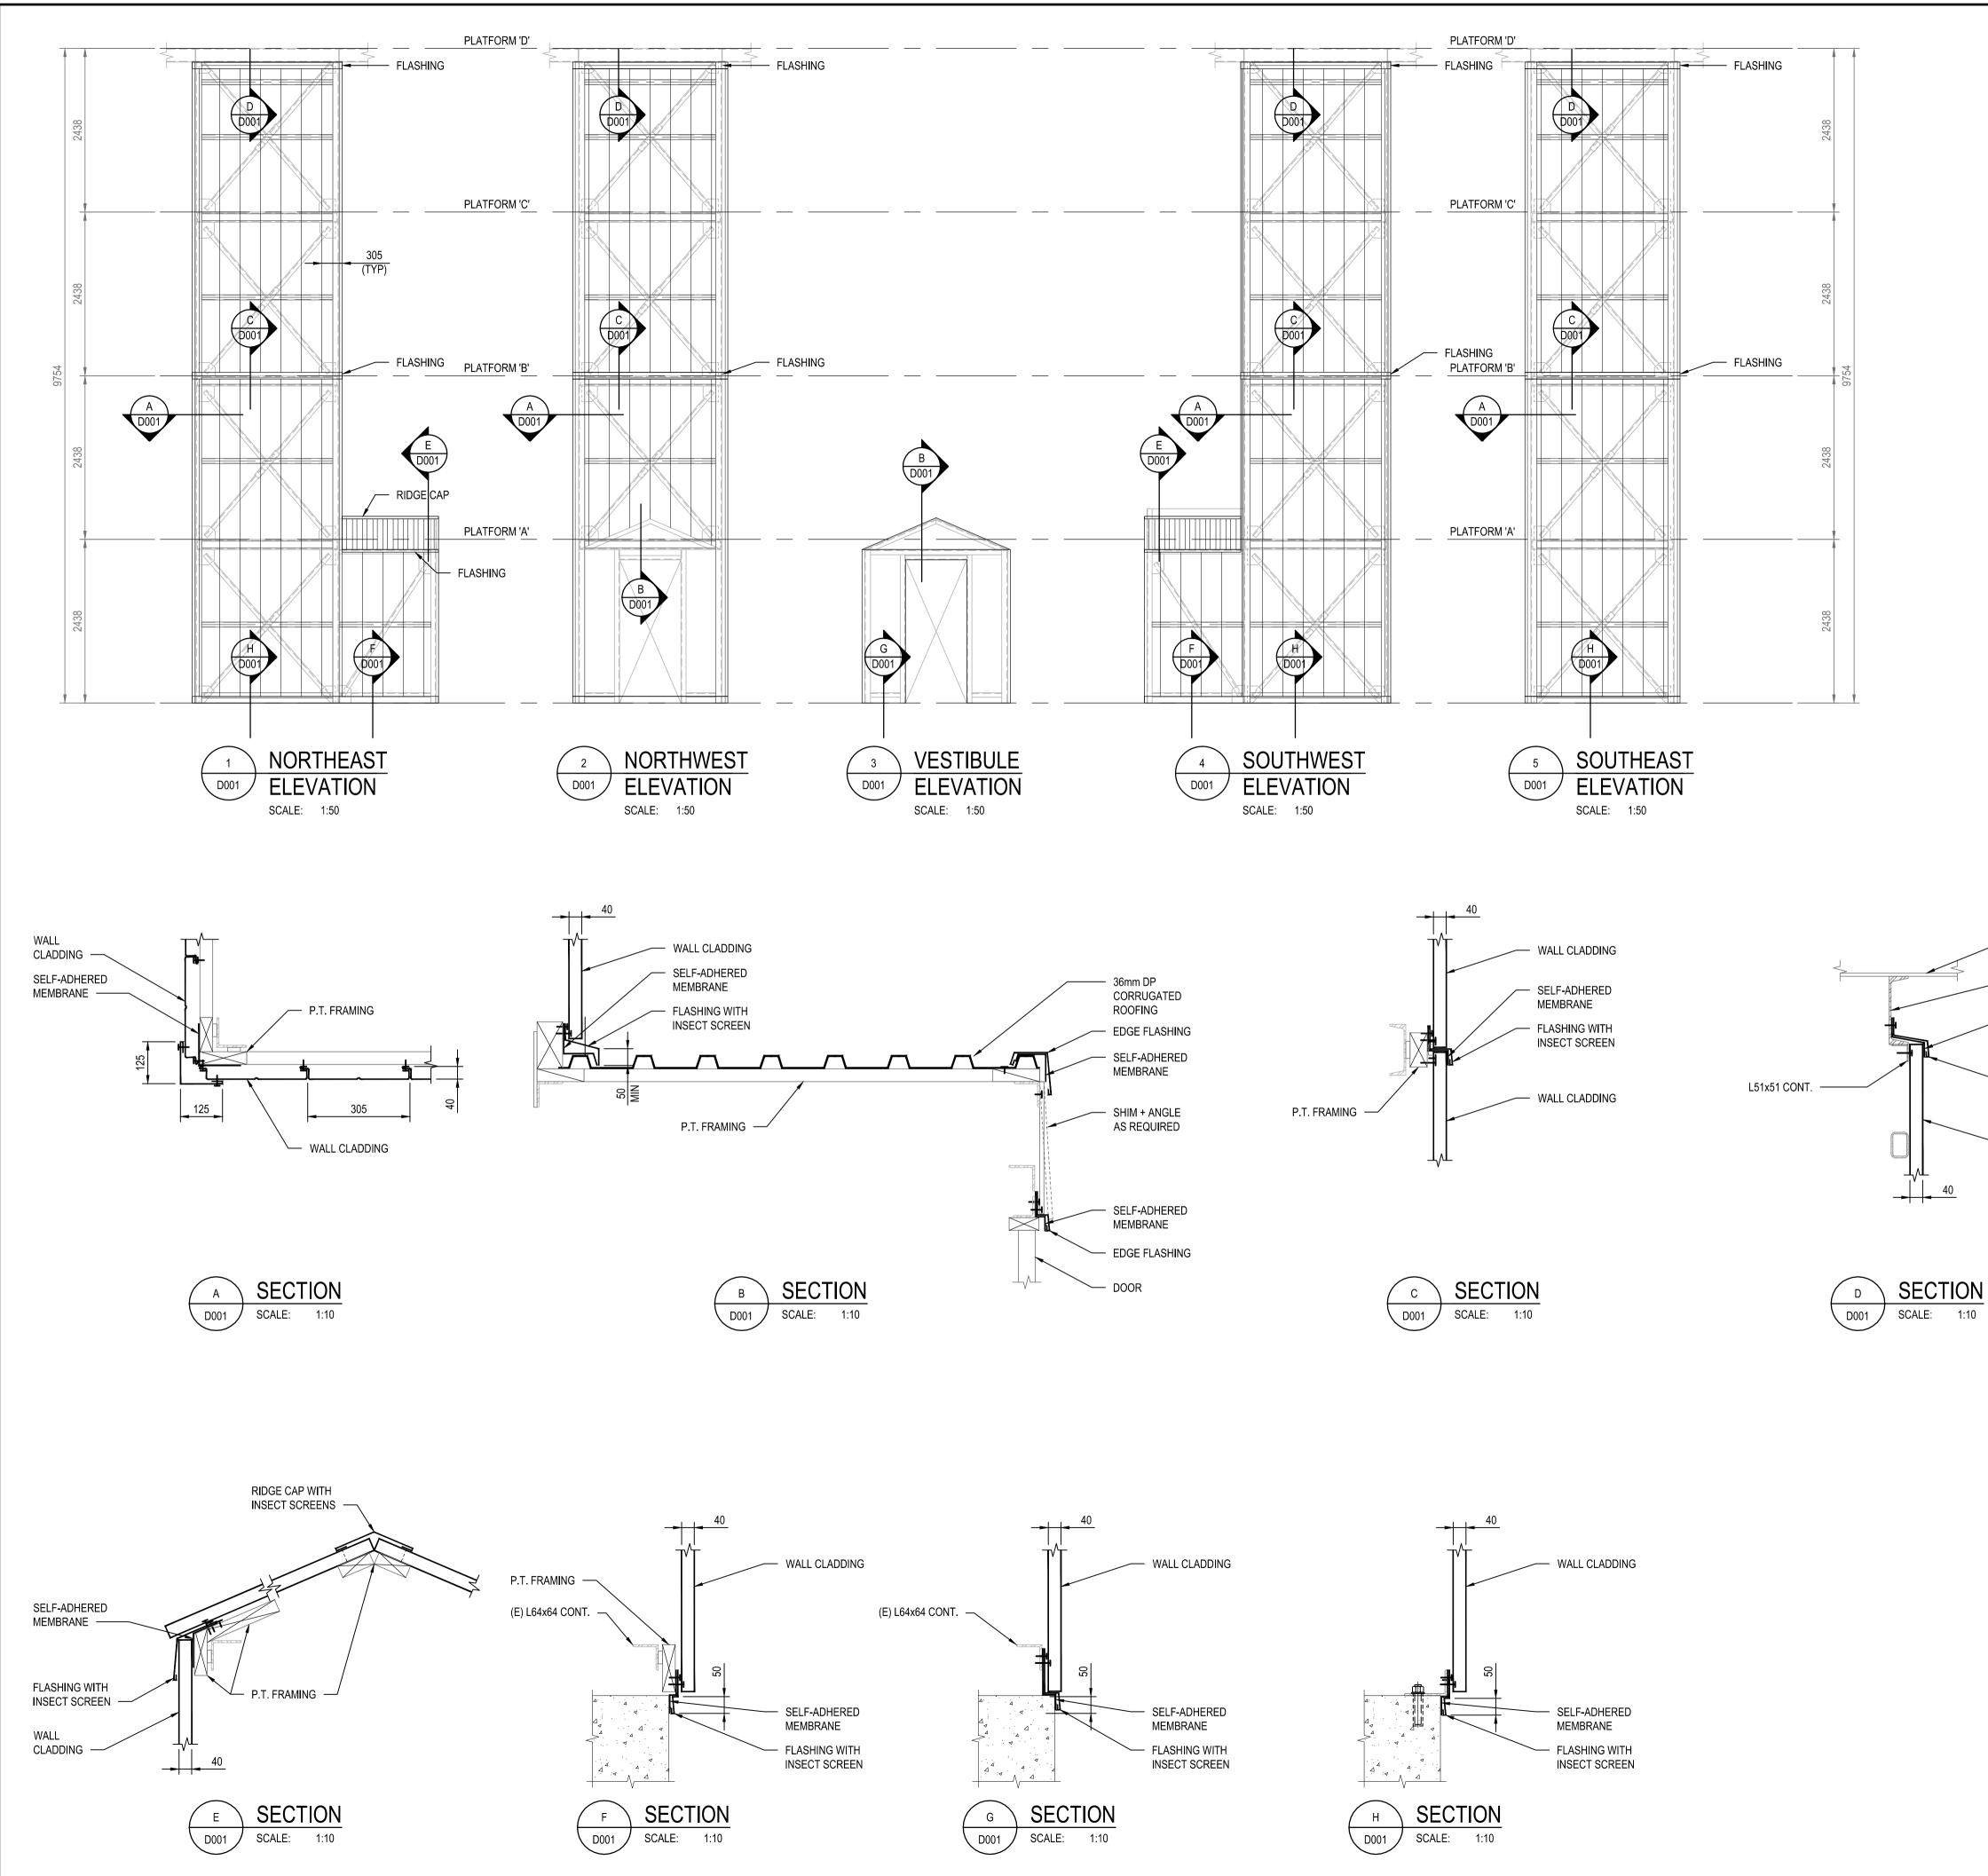PWGSC - A1 - 841X594

## 0 10 20 30 40 50 60 70 80 90 100mm



Public Works and Government Services Canada Canada Canada REAL PROPERTY SERVICES Pacific Region SERVICES IMMOBILIERS Région de Pacifique OAL ENGINEERING LTD. UNIT 9 - 755 VANALMAN AVE. VICTORIA, BC, V8Z 3B8 T: (250) 744 3992 F: (250) 744 3983 W: GOÁLENGINEERING.COM OFESSI. PROVINC G. OVSTAAS # 13909 O BRITIBH 2015-10-13 SCALE 1:10 400 600 SCALE IN MILLIMETRES 200 SCALE 1:50 2000 3000 1000 SCALE IN MILLIMETRES 1000 DO NOT SCALE DRAWINGS ISSUED FOR TENDER 90% SUBMISSION FOR REVIEW )8/26/20 Description/Description Revision/ Date/Date Client/clien Fisheries and Oceans Canada 25 Huron Street Victoria, BC Project title/Titre du projet CAPE BEALE TOWER REFURBISHMENT Approved by/Approuve par Designed by/Concept par GREG OVSTAAS, P. ENG Drawn by/Dessine par ROD MAR/2015.08/04 PWGSC Project Manager/Administrateur de Projets TPSG PWGSC, Architectural and Engineering Resources Manager/ Ressources Architectural et de Directeur d'Ingénierie, TPSGC Client/client Drawing title/Titre du dessin **BUILDING ENVELOPE ELEVATIONS & SECTIONS** CAPE BEALE Project No./No. du projet Revision no. La Révision Sheet/Feuille F1700-150861 CCG Drawing No./No. du dessin 10247 D001 1 5 OF 5

- (E) LANTERN HOUSE CHECKER PLATE - (E) C200

- SELF-ADHERED MEMBRANE

FLASHING WITH INSECT SCREEN

WALL CLADDING