
PLOT SCALE:

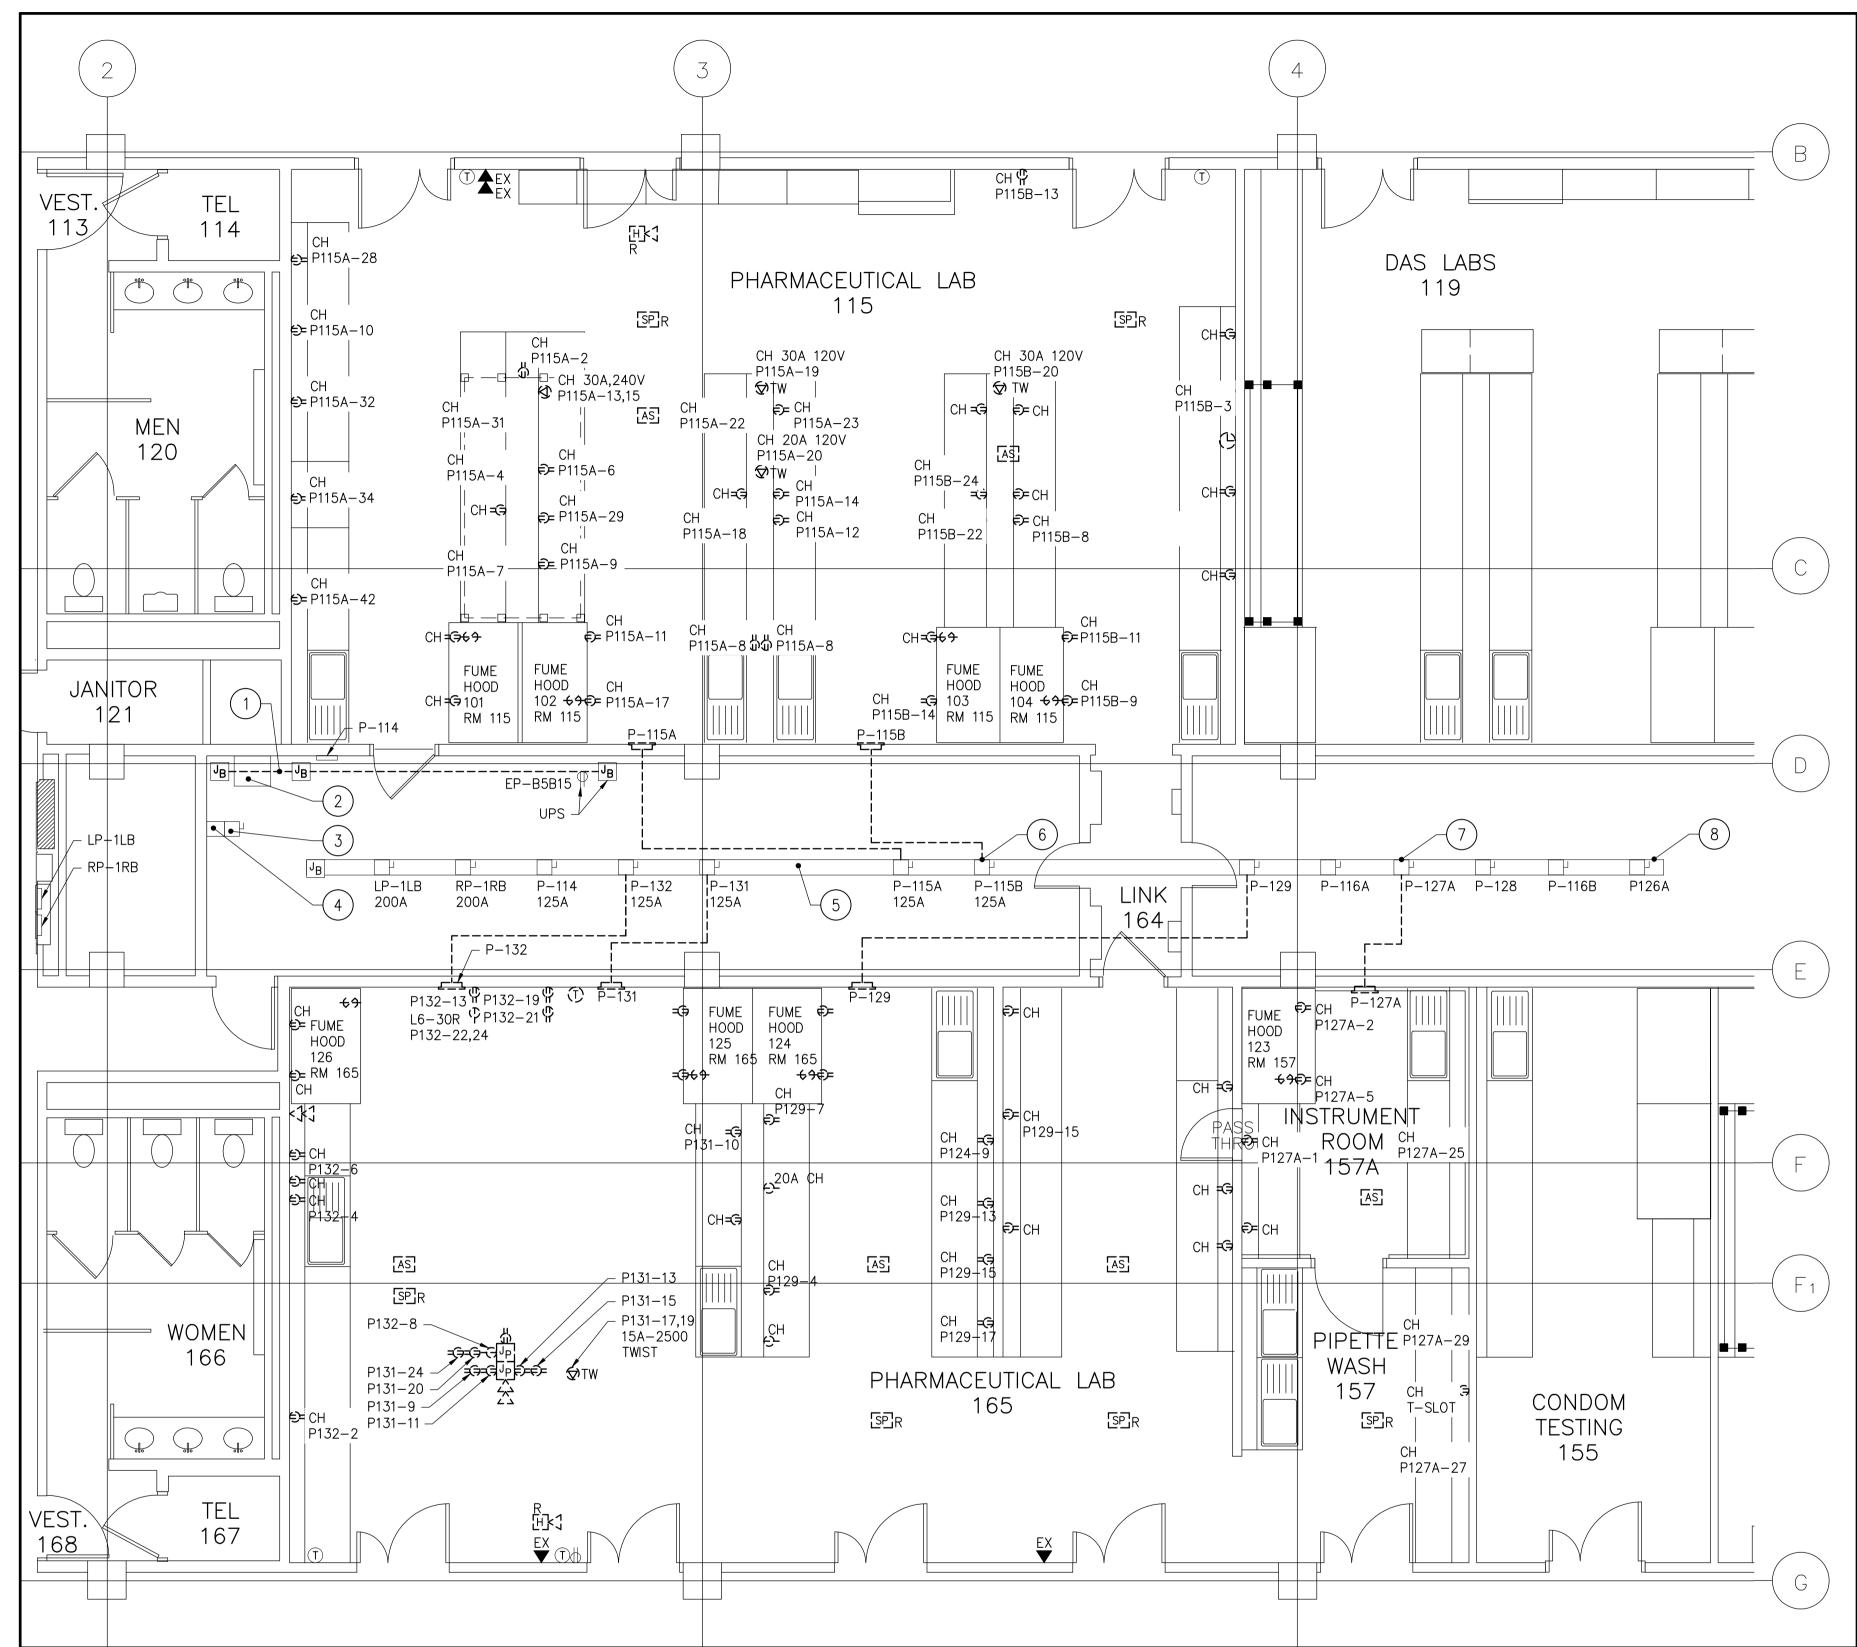

# PARTIAL LEVEL 1 POWER & SYSTEMS DEMOLITION LAYOUT

### LEVEL 1 POWER & SYSTEMS DEMO. DRAWING NOTES:

- REMOVE & RELOCATE 21mm EMT FOR "JIFFY POLE RM 106 SECURITY COMPUTER" DOWN TO AVOID NEW MECH. DUCT WORK. COORDINATE WITH MECH. DUCT WORK. EXTEND CONDUIT AND WIRING AS REQUIRED.
- EXISTING 112.5KVA TRANSFORMER 1T2, 600/120/208V- $\left(2\right)$  3ø, %Z-3.4 TO REMAIN.
- EXISTING TRANSFORMER 1T2 600VAC DISCONNECT 200A TO REMAIN.
- $\left(egin{array}{c}4\end{array}
  ight)$  existing 600VAC bus duct to remain.
- EXISTING FPE 400A-347/600V-3ø-4W 5 ) RATED LOW IMPEDANCE BUS DUCT SERIES 54-00677-06 TO REMAIN.
- (6) REUSE BUS DUCT MOUNTED SWITCH TO PROVIDE POWER TO NEW PANEL P115. UPDATE LABEL.
- REUSE BUS DUCT MOUNTED SWITCH TO PROVIDE POWER TO NEW PANEL P165. (REFER TO DWG E3.1 & UPDATE LABEL.
- (8) EXISTING 120/208VAC WEST BUS DUCT TO REMAIN.

#### **DEMOLITION LEGEND**

- REMOVE 120V-15A DUPLEX RECEPTACLE, € ALL ASSOCIATED CONDUIT AND WIRING BACK TO SOURCE
- REMOVE 5-20RA SIMPLEX RECEPTACLE, ALL ASSOCIATED CONDUIT AND WIRING BACK TO SOURCE
- REMOVE 120/240 CONVENIENCE//SPECIAL NEMA CONFIGURATION RECEPTACLE, BACKBOX, CONDUIT AND ALL ASSOCIATED WIRING BACK TO SOURCE
- REMOVE NETWORK OUTLET. REFER TO
- REMOVE CLOCK, ALL ASSOCIATED CONDUIT AND WIRING BACK TO SOURCE
- REMOVE JIFFY POLE BY ELECTRICAL
- CONTRACTOR AND ALL TYPICAL ASSOCIATED CONDUIT AND WIRING BACK TO SOURCE
- RELOCATE SPEAKER AND EXTEND ALL ASSOCIATED CONDUIT AND WIRING AS REQUIRED AS CLOSE AS POSSIBLE TO PREVIOUS LOCATION IN NEW CEILING.
- REMOVE 135°F HEAT DETECTOR FIXED TEMPERATURE & 15°F RATE OF RISE, ALL ASSOCIATED CONDUIT AND WIRING BACK TO SOURCE. PREVIOUS DEVICE IN LOOP ON FIRE ALARM PANEL. EXTEND CONDUIT & WIRING TO MAKE CIRCUIT GOOD.
- REMOVE TOGGLE SWITCH AND ALL ASSOCIATED CONDUIT AND WIRING BACK TO SOURCE
- REMOVE RECESSED PANEL
- RELOCATE CEILING MOUNTED FIRE ALARM HORN TO NEW T-BAR CEILING IN AS CLOSE TO PREVIOUS LOCATION AS
- REMOVE MOTION SENSOR, ALL ASSOCIATED CONDUIT AND WIRING BACK TO SOURCE. MAKE CIRCUIT GOOD.
- REMOVE LINE VOLTAGE T-STAT, CONDUIT
- EXISTING SURFACE MOUNT PANEL TO

& WIRING TO SOURCE.

- EXISTING DISCONNECT SWITCH TO REMAIN.
- EXISTING DUPLEX RECEPTACLE TO
- EXISTING LINE VOLTAGE THERMOSTAT TO
- EXISTING TELEPHONE OUTLET TO REMAIN
- EXISTING JUNCTION BOX TO REMAIN.
- TWIST LOCK TW
- CH COUNTER HEIGHT

#### LINETYPE LEGEND

EXISTING TO REMAIN

---- REMOVE

# **GENERAL NOTES**

1. DATA & PHONE WIRING IS TO BE TEMPORARILY PULLED UP & SAFELY COILED IN THE CEILING SPACE TO THEN BE REUSED IN NEW LOCATIONS IDENTIFIED (RE-INSTALLATION, RE-CONNECTION, VERIFICATION & TESTING, ETC IS N.I.C. AND IS BY OTHERS). LABEL ALL CABLES.

#### CONTRACT DRAWINGS

CONTRACT DRAWINGS FOR ELECTRICAL WORK ARE IN PART DIAGRAMMATIC, INTENDED TO CONVEY THE SCOPE OF WORK AND CONTRACTOR TO COORDINATE LAYOUT OF ELECTRICAL SYSTEMS WITH ARCHITECTURAL, STRUCTURAL, AND MECHANICAL BUILDING COMPONENTS, AS WELL AS OTHER ELECTRICAL SYSTEMS. PROVIDE ADDITIONAL JUNCTION BOXES, FITTINGS, SUPPORTS, ETC. REQUIRED TO FACILITATE THE WORK. NO EXTRA PAYMENTS ARISING FROM FAILURE TO MAKE THIS COORDINATION WILL BE CONSIDERED.

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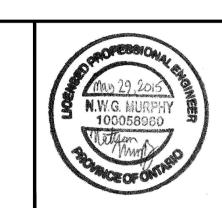



CORNWALL, ONTARIO

CANADA K6J 3E5

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2	ISSUED FOR TENDER	2015/05/29
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evision	description	date

Do not scale drawings. Verify all dimensions and conditions on site and immediately notify the engineer of all discrepancies.

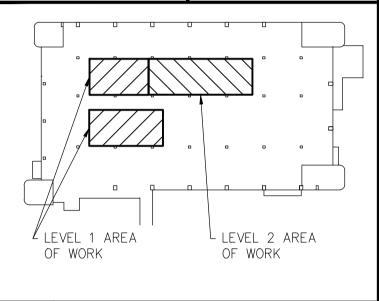

A Detail No. No. du détail B drawing no. - where detail required

dessin no. — où détail exigé drawing no. — where detailed

Ontario

project title titre du projet TORONTO HEALTH CANADA 2301 MIDLAND AVE

LABORATORY UPGRADES

drawing title titre du dessin PARTIAL LEVEL 1 POWER AND SYSTEMS DEMOLITION

dessiné par TS conçu par NM

approuvé par FΗ soumission ádministratěu

AQUIL ALI

project date date du projet 2015/04/15

R.054345.001

drawing no. no. du dessin E1.2

DATE PLOTTED: PLOT SCALE: CAD FILE:

PLOT SCALE:

CAD FILE:

PARTIAL LEVEL 2 — LIGHTING DEMOLITON
SCALE: 1:50

**GENERAL NOTES** 

1. REFER TO DRAWING E1.1 FOR DEMOLITION LIGHTING LEGEND.


# CONTRACT DRAWINGS


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revision	description	date

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Ontario

project title titre du projet TORONTO HEALTH CANADA 2301 MIDLAND AVE

LABORATORY UPGRADES

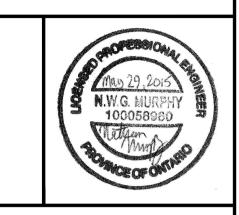drawing title titre du dessin PARTIAL LEVEL 2 LIGHTING DEMOLITON

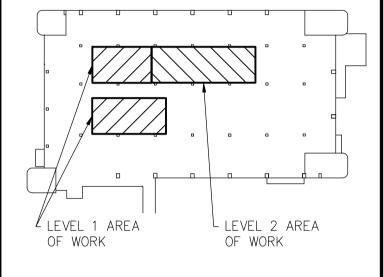
drawn by dessiné par TS designed by conçu par NM approved by approuvé par FΗ tender soumission project manager administrateur AQUIL ALI

project date date date du projet 2015/04/15

project no. no. du projet R.054345.001

drawing no. no. du dessin

E1.3

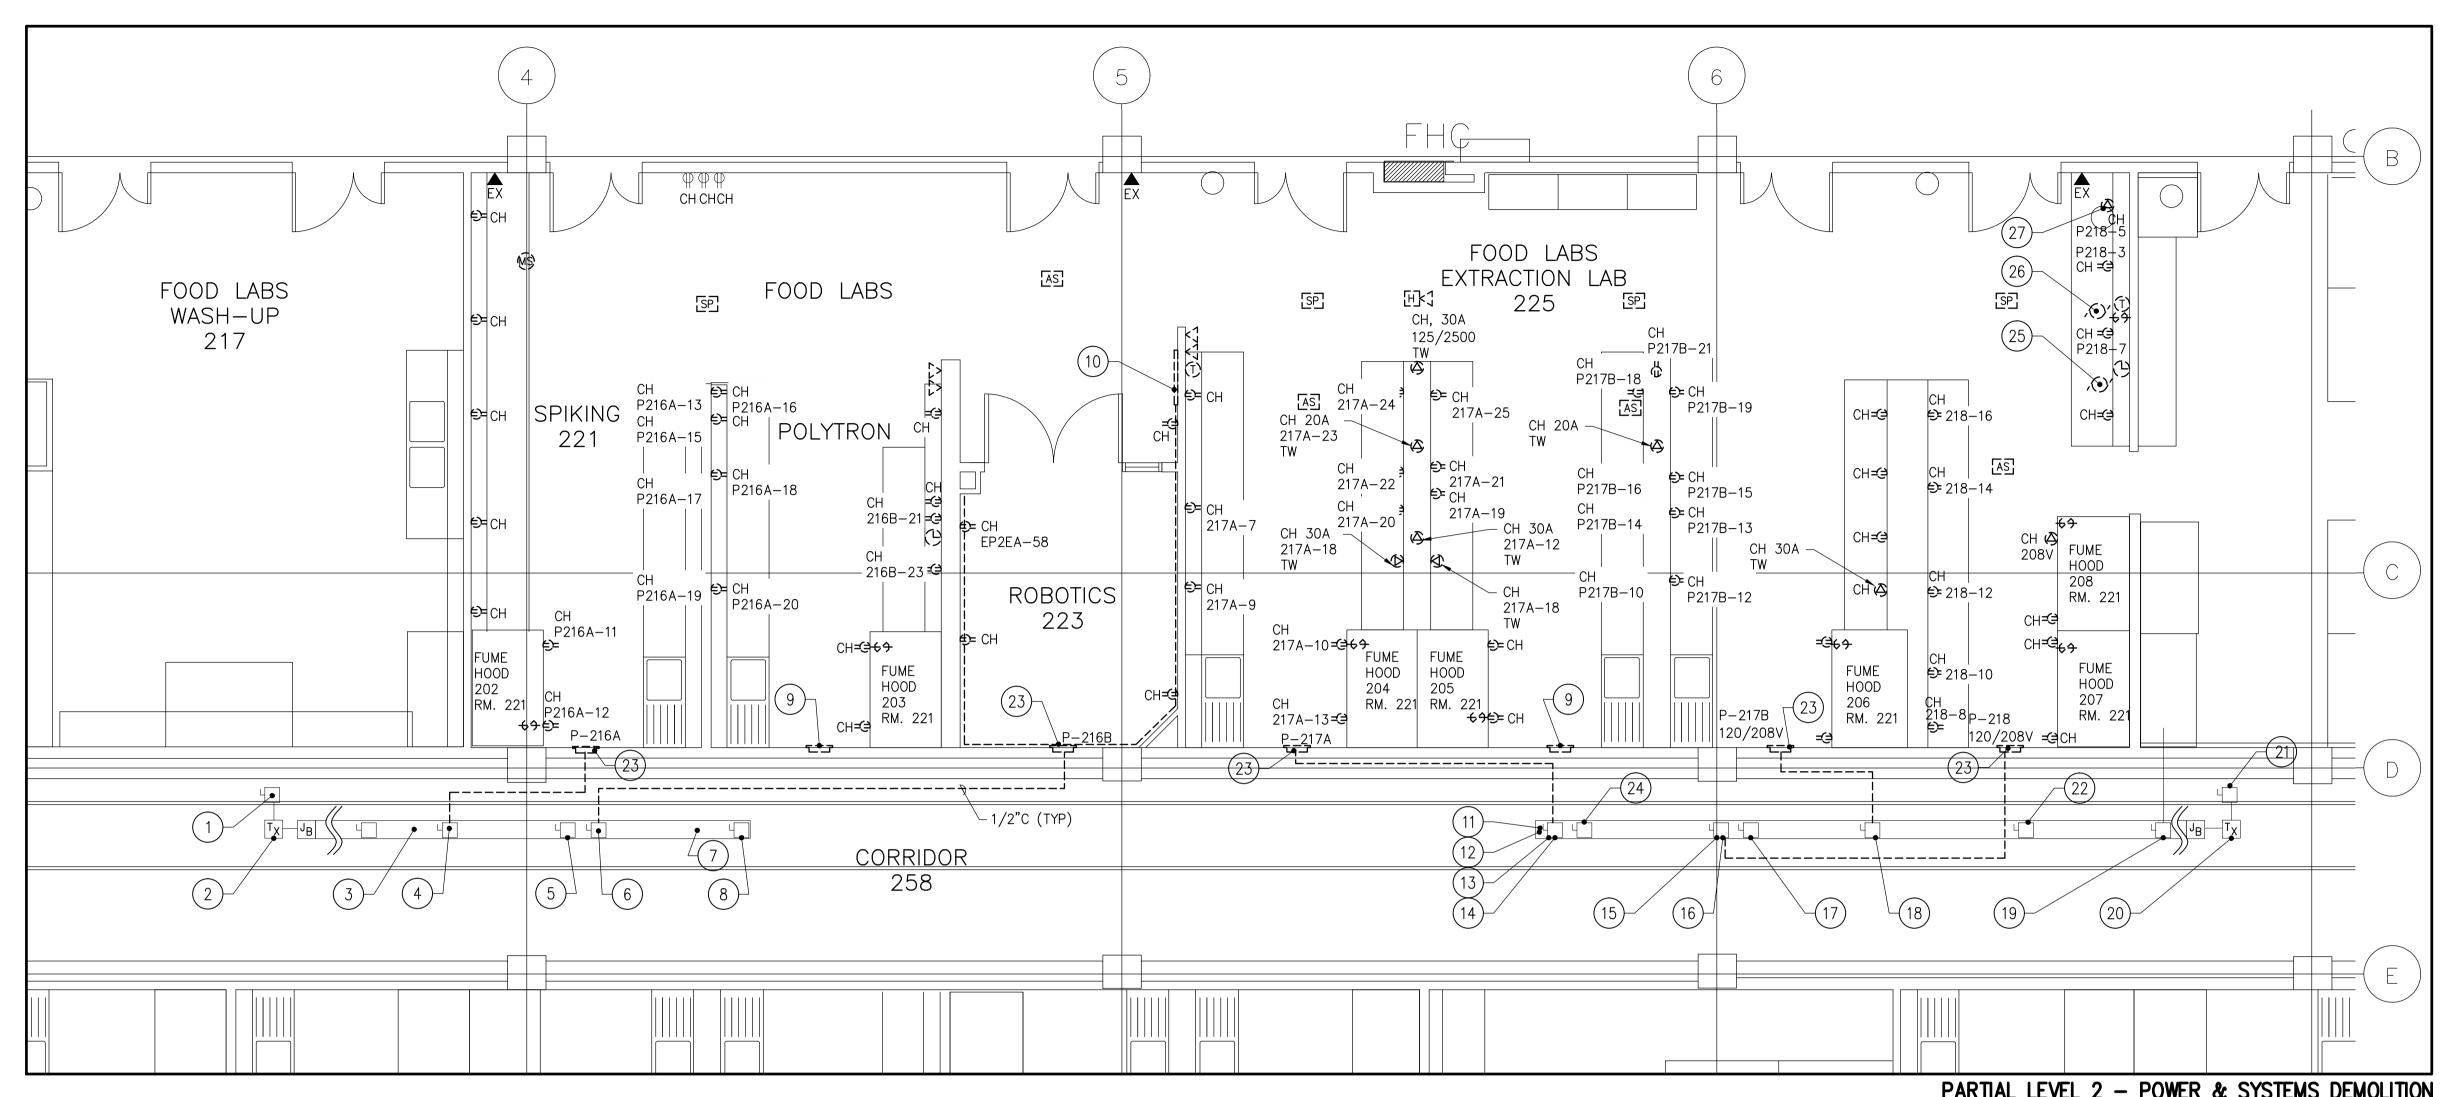

# PARTIAL LEVEL 2 - POWER & SYSTEMS DEMOLITION

#### LEVEL 2 POWER & SYSTEMS DEMO. **DRAWING NOTES:**

- EXISTING FPE 200A-600V DISCONNECT 2T2 TO T) REMAIN.
- 2 EXISTING TRANSFORMER 2T2 TO REMAIN. 112.5KVA, 600/120/208V-3ø, 3.2%Z FEEDS BUS DUCT.
- EXISTING FPE  $400A-347/600V-3\emptyset-4W$  RATED LOW 3 IMPEDANCE BUS DUCT. SERIES 54-00677-06 TO REMAIN.
- EXISTING FPE 125A DISCONNECT P-216A, 120/208V TO REMAIN.
- 5 EXISTING FPE 125A DISCONNECT P-225, 120/208V TO REMAIN. EXISTING FPE 125A DISCONNECT P-216B, 120/208V
- (6) TO REMAIN. (7) EXISTING 120/208VAC WEST BUS DUCT TO REMAIN.
- 8 EXISTING FPE 125A DISCONNECT P-223A, 120/208V TO REMAIN.
- (9) REMOVE EMPTY PANEL TUB.
- REMOVE COUNTER HEIGHT SURFACE RACEWAY, (10) POWER BAR & ALL ASSOCIATED CONDUIT & WIRING BACK TO SOURCE.
- 11 EXISTING REMAIN. EXISTING 120/208VAC EAST BUS DUCT TO
- LOW IMPEDANCE BUS DUCT. SERIES 54-00677-06 TO REMAIN.

EXISTING FPE  $400A-347/600V-3\phi-4W$  RATED

- EXISTING FPE 125A DISCONNECT P-217A 120/208V (13) EXISTING FP TO REMAIN.
- REUSE BUS DUCT MOUNTED SWITCH TO PROVIDE (14) POWER TO NEW PANEL P225A. (REFER TO DWG E3.2 & UPDATE LABEL).
- REUSE BUS DUCT MOUNTED SWITCH TO PROVIDE (15) REUSE BUS DOOT MICOURTED STATES TO DWG PANEL P225B. (REFER TO DWG E3.2 & UPDATE LABEL).

- (16) EXISTING TO REMAIN. EXISTING FPE 125A DISCONNECT P-218 120/208V
- EXISTING FPE 125A DISCONNECT P-222A 120/208V TO REMAIN.
- 18 EXISTING FPE 125A DISCONNECT P-217B 120/208V TO REMAIN.
- (19) EXISTING TO REMAIN. EXISTING FPE 125A DISCONNECT P-219A 120/208V
- (20) EXISTING TRANSPONDEN 2.1. 600/120/208V-3Ø 3.2%Z FEEDS BUS DUCT EXISTING TRANSFORMER 2T1 TO REMAIN. 112.5KVA
- EXISTING FPE 200A-600V DISCONNECT 2T1 TO (21) EXISTING REMAIN.
- EXISTING FPE 125A DISCONNECT P-221B 120/208V TO REMAIN. REMOVE FPE NBLP-42-4AB, 42CCT 225A-120/ (23) 208V-3Ø-4W RATED 125A-3P MAIN BREAKER
- (TYP.) ALL LAB PANELS EXISTING FPE 125A DISC. P-222B, 120/208V TO REMAIN.
- (25) REMOVE EX. CONES 30-270-22
- (26) REMOVE EX. CONES 30-270-2AA
- (27) REMOVE HUBBELL 20A-125/250V TW

#### **GENERAL NOTES**

- REFER TO DRAWING E1.2 FOR DEMOLITION POWER
- PULLED UP & SAFELY COILED IN THE CEILING SPACE TO THEN BE REUSED IN NEW LOCATIONS IDENTIFIED (RE-INSTALLATION, RE-CONNECTION, VERIFICATION & TESTING, ETC IS N.I.C. AND IS BY OTHERS).
- & SYSTEMS LEGEND.
- 2. DATA & PHONE WIRING IS TO BE TEMPORARILY

#### **CONTRACT DRAWINGS**


CONTRACT DRAWINGS FOR ELECTRICAL WORK ARE IN PART DIAGRAMMATIC, INTENDED TO CONVEY THE SCOPE OF WORK AND CONTRACTOR TO COORDINATE LAYOUT OF ELECTRICAL SYSTEMS WITH ARCHITECTURAL, STRUCTURAL, AND MECHANICAL BUILDING COMPONENTS, AS WELL AS OTHER ELECTRICAL SYSTEMS. PROVIDE ADDITIONAL JUNCTION BOXES, FITTINGS, SUPPORTS, ETC. REQUIRED TO FACILITATE THE WORK. NO EXTRA PAYMENTS ARISING FROM FAILURE TO MAKE THIS COORDINATION WILL BE CONSIDERED.




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2301 MIDLAND AVE

Ontario

LABORATORY UPGRADES

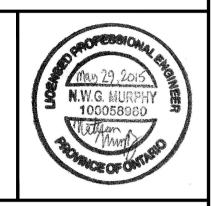drawing title titre du dessin PARTIAL LEVEL 2 POWER & SYSTEMS DEMOLITON

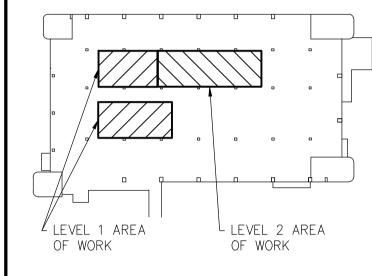dessiné par TS conçu par NM approuvé par FΗ

soumission AQUIL ALI


project date date du projet 2015/04/15

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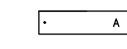
drawing no. no. du dessin

E1.4

GSC-A1 DATE PLOTTED: PLOT SCALE: CAD FILE:

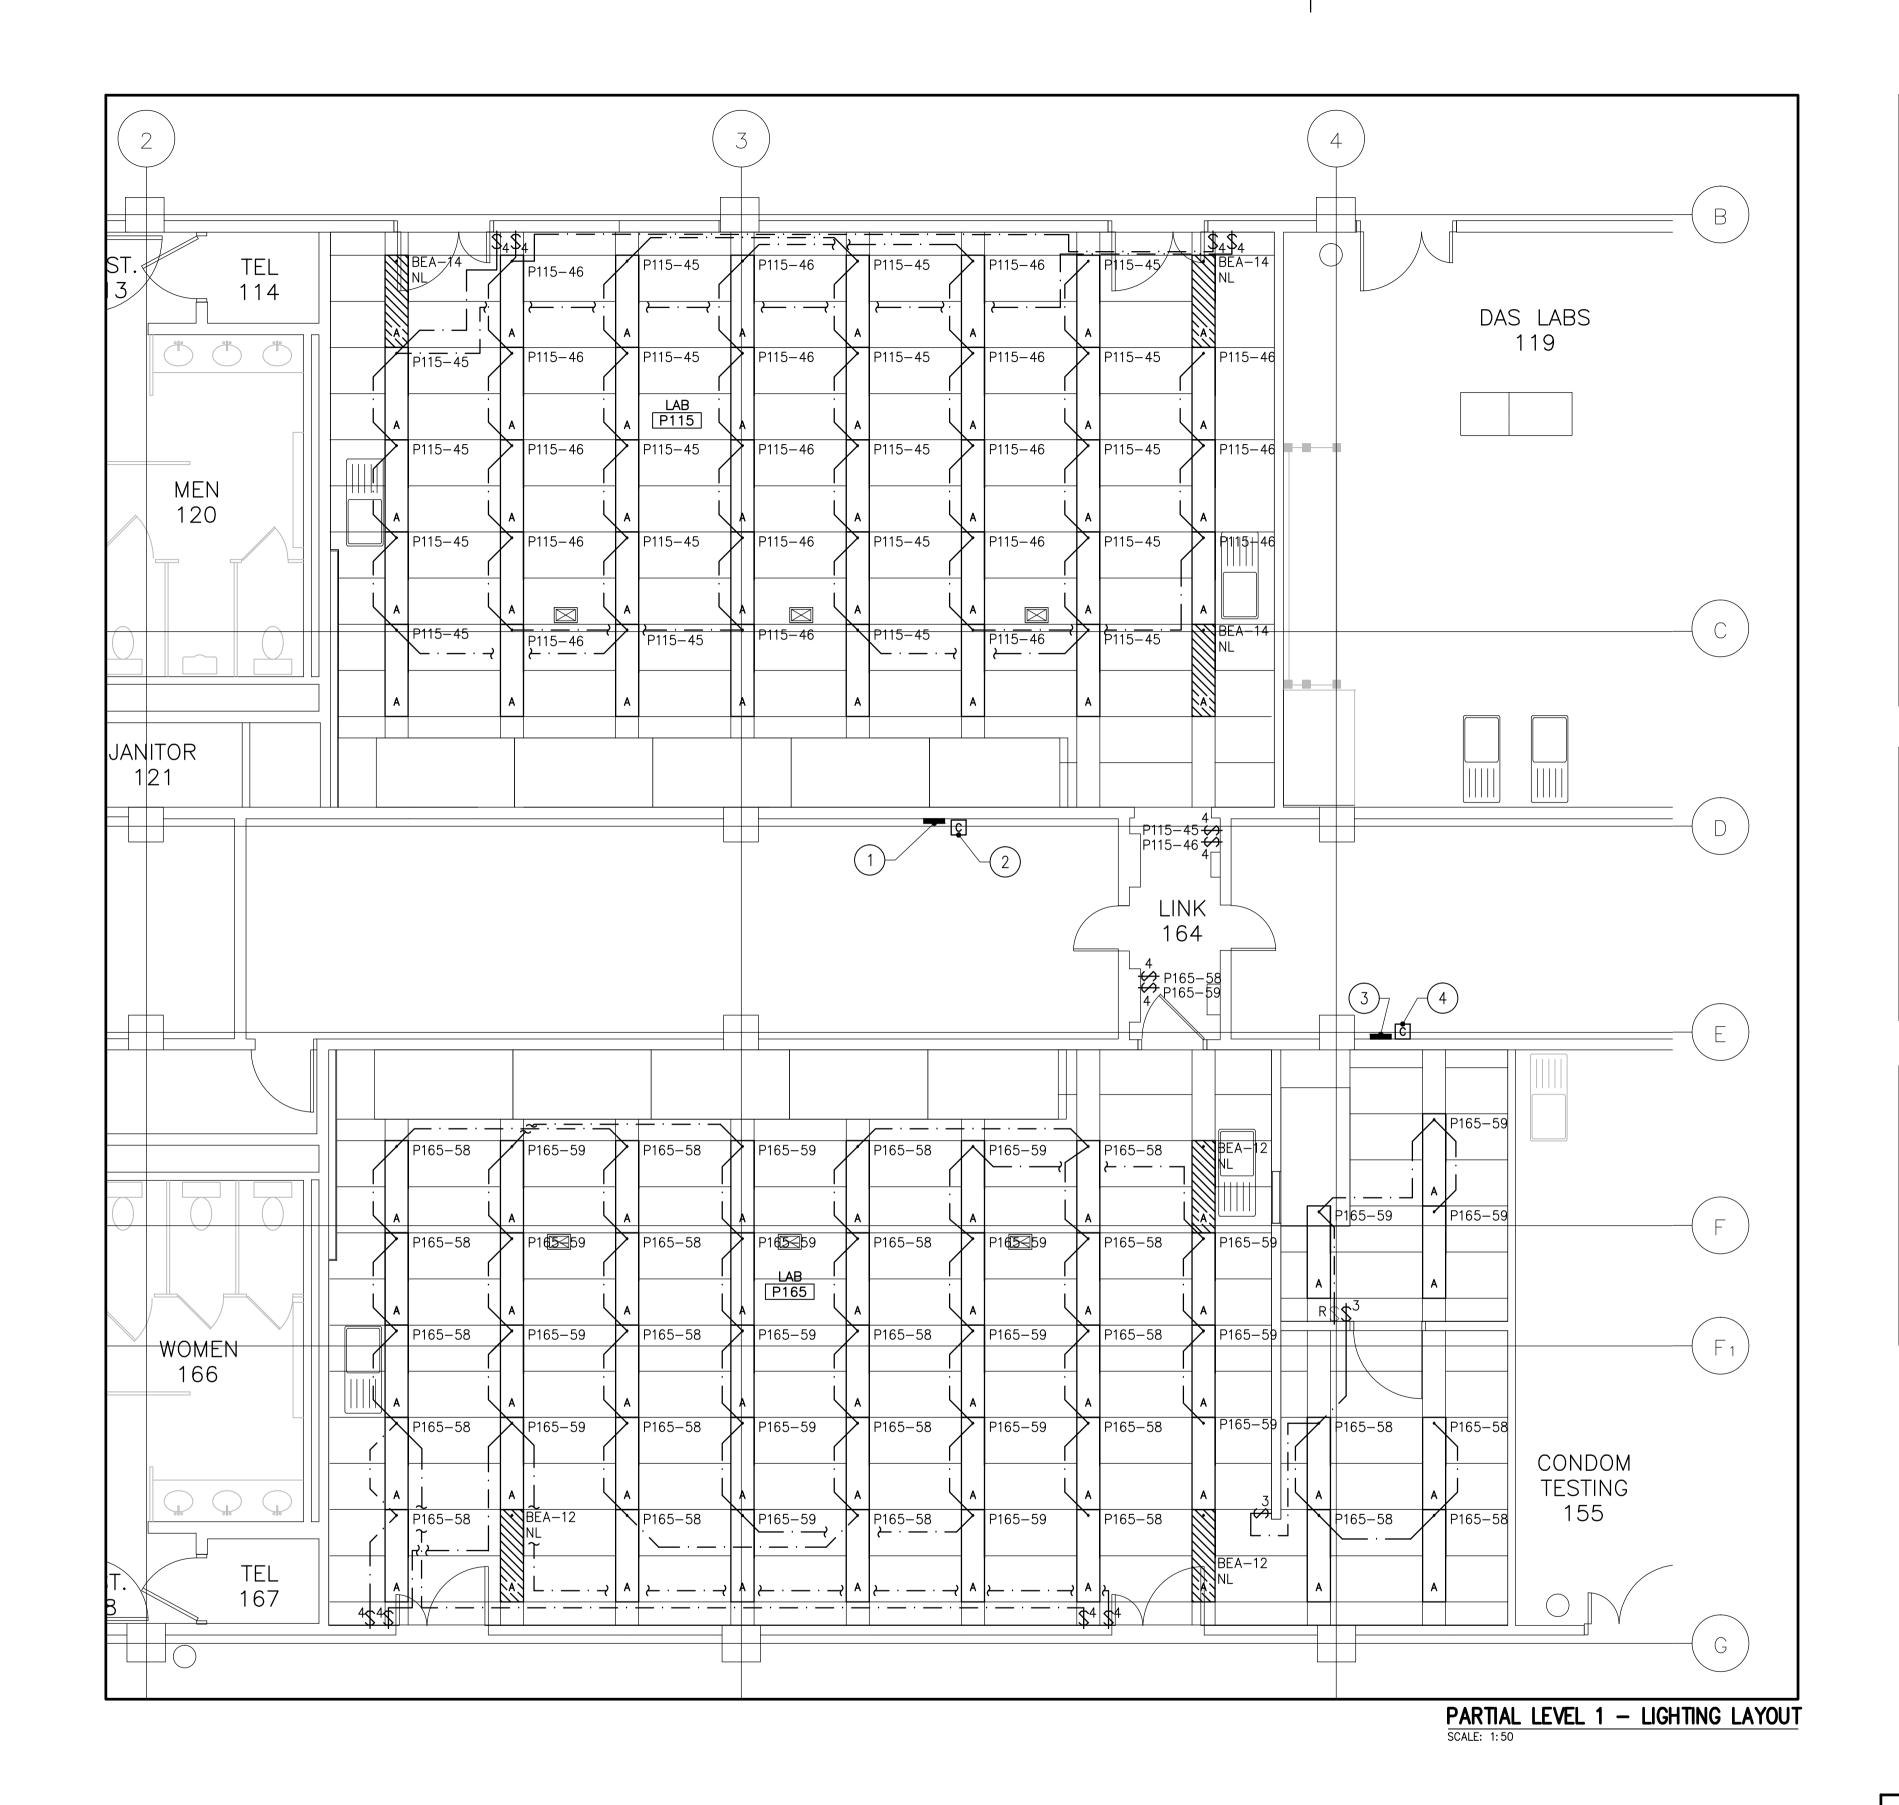

#### NEW LEGEND




1'x4' FLUORESCENT LIGHT FIXTURES, REFER TO SPECIFICATION FOR TYPE. PROVIDE JACK CHAINS & 'S' HOOKS.



HATCHING INDICATES FIXTURE WIRED TO AN EMERGENCY LIGHTING CIRCUIT



CONTACTOR. REFER TO REFERENCED LIGHTING CONTROL WIRING DIAGRAM ON DWG E2.2.

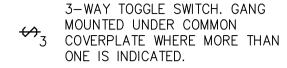

4-WAY TOGGLE SWITCH. GANG MOUNTED UNDER COMMON COVERPLATE WHERE MORE THAN ONE IS INDICATED.

NIGHT LIGHTING INDICATES FIXTURE IS WIRED TO THE NL UNSWITCHED SIDE OF EXISTING LIGHT CIRCUIT.

SURFACE MOUNTED ELECTRICAL

EXISTING TOGGLE SWITCH TO REMAIN

#### **GENERAL NOTES**

- 1. REMOVE FIXTURES AND REMOVE BALLAST FROM FIXTURE. HAND OVER BALLAST TO SNC- LAVALIN. REMOVE FIXTURE FROM SITE.
- 2. COORDINATE LOCATIONS OF MECHANICAL AND ELECTRICAL FIXTURES IN T-BAR CEILING. SUBMIT SPRINKLER HEAD LOCATIONS FOR APPROVAL (AS PER MECHANICAL) SHOWING ALL OTHER FIXTURES
- 3. LIGHT FIXTURE LOCATIONS MUST NOT BE ALTERED WITHOUT PRIOR APPROVAL DUE TO COORDINATION WITH ARCHITECTURAL AND MECHANICAL.

#### LEVEL 1 LIGHTING LAYOUT DRAWING NOTES:

(1) PROVIDE PANEL P-115

(2) REFER TO DETAIL 1/E2.2

(3) PROVIDE PANEL P-165

(4) REFER TO DETAIL 2/E2.2


Public Works and Government Services Canada Architectural and Engineering Services Ontario Region


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consultant



1345 ROSEMOUNT AVENUE CORNWALL, ONTARIO CANADA K6J 3E5 PHONE: 613-933-5602 FAX: 613-936-0335 WWW.WSPGROUP.COM



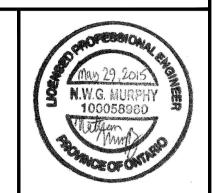
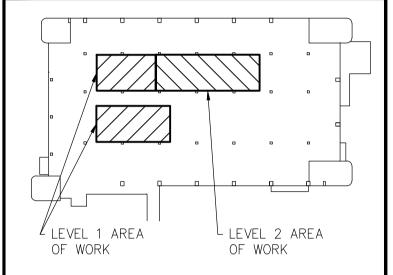
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project title titre du projet TORONTO HEALTH CANADA 2301 MIDLAND AVE

LABORATORY UPGRADES

drawing title titre du dessin PARTIAL LEVEL 1 LIGHTING LAYOUT

drawn by dessiné par CT

approved by approuvé par FΗ

conçu par

project manager administrateur de projets tender soumission AQUIL ALI

NM

project date date date du projet 2015/04/15

project no. no. du projet R.054345.001

drawing no. no. du dessin E2.1

#### CONTRACT DRAWINGS

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PLOT SCALE:

GSC-A1 DATE PLOTTED:

- (0S41) UPLC-MS-MS #424 AND COMPONENTS 31x34x36 (W"xD"xH")
- GC-MS 1 #215 & PUMP SYSTEM ON UPS 36x30x35 (W"xD"xH")

- (0S55) COMPRESSED GAS TANK STAND FOR 4 TANKS 60x13x55 (W"xD"xH")

- OS63) ANALYTICAL BALANCE ON MARBLE TABLE #226 24x18x16 (W"xD"xH")



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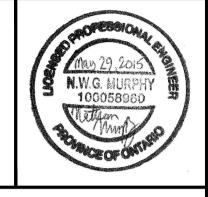
Ontario Region


Government Services Canada Architectural and Engineering Services

Services d'architecture et de génie

Services gouvernementaux Canada





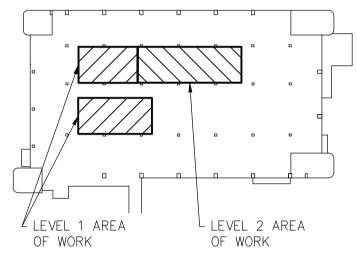

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2301 MIDLAND AVE

LABORATORY UPGRADES

drawing title titre du dessin

PARTIAL LEVEL 1 POWER & SYSTEMS LAYOUT

dessiné par CT

NM


approuvé par FΗ ádministratěu soumission AQUIL ALI

2015/04/15

R.054345.001

no. du dessin

E3.1

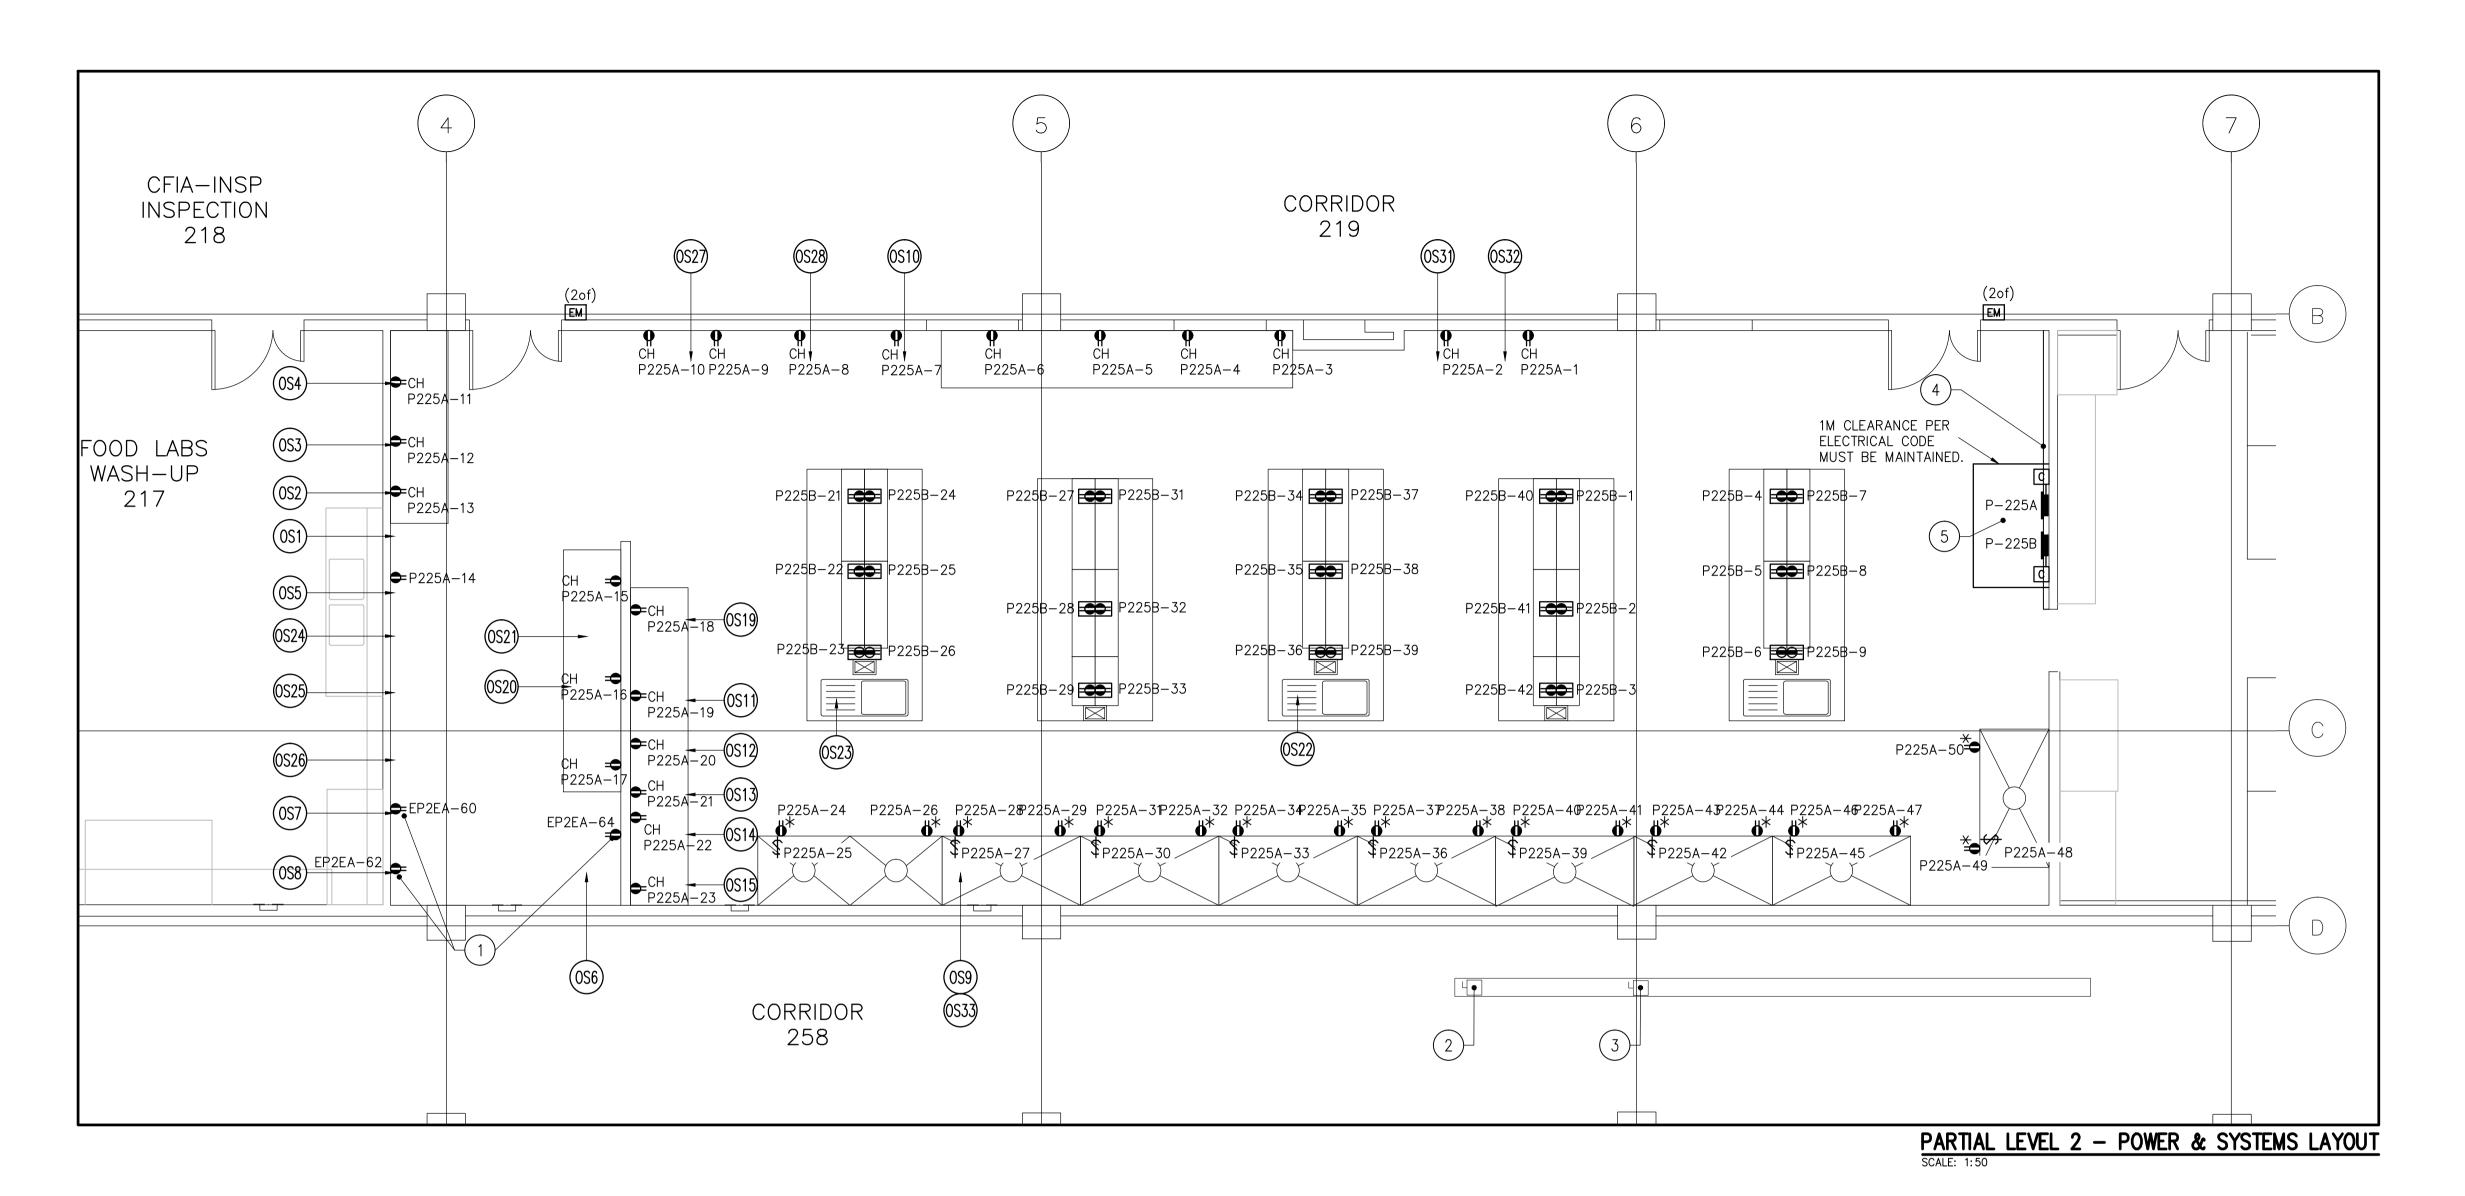

**GENERAL NOTES** 

SUPPLIED EQUIPMENT.

REFER TO DRAWING E3.1 FOR LIST OF OWNER

2. REFER TO DRAWING E3.1 FOR POWER & SYSTEMS LEGEND.

# LEVEL 2 POWER & SYSTEMS DRAWING NOTES:

- PROVIDE 20A-1P FPE BREAKERS (TAKE FROM 1 PANELS BEING REMOVED) IN THESE CIRCUITS IN PANEL EP2EA IN 2ND FLOOR MECHANICAL SPACE TO POWER THESE RECEPTACLES.
- REUSE BUS DUCT MOUNTED SWITCH TO PROVIDE POWER TO NEW PANEL PP225A. PROVIDE KNOCKOUT FILLERS AS REQUIRED. (REFER TO DWG E1.4).
- REUSE BUS DUCT MOUNTED SWITCH TO PROVIDE POWER TO NEW PANEL PP225B.
  PROVIDE KNOCKOUT FILLERS AS REQUIRED. (REFER TO DWG E1.4).
- 4 SUGGESTED ARCHITECTURAL FURRING TO MAKE PANELS RECESSED.
- 5) RECOMMENDED LOCATION OF NEW PANELS.
- HUMIDIFIER-1 18FLA-208V-1ø CIRCUIT (6) RP-3RB-B-35,37. THIRD FLOOR BLOWER FED FROM HUMIDIFIER.
- 7 HUMIDIFIER-Z IBFLA-ZUOV-IN CINCOLI RP-3RB-B-39,41. THIRD FLOOR BLOWER FED HUMIDIFIER-2 18FLA-208V-1ø CIRCUIT FROM HUMIDIFIER.

# CONTRACT DRAWINGS


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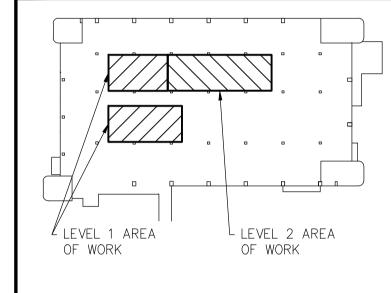
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dessin no. — où détaillé

project title titre du projet TORONTO HEALTH CANADA 2301 MIDLAND AVE

LABORATORY UPGRADES

drawing title titre du dessin PARTIAL LEVEL 2 POWER & SYSTEMS LAYOUT

drawn by dessiné par CT conçu par NM approuvé par FΗ soumission ádministratěu

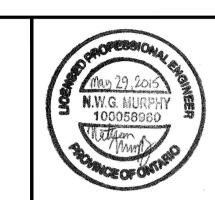AQUIL ALI

project date date date du projet 2015/04/15

drawing no. no. du dessin

R.054345.001

E3.2

JANITOR − HU−1 -(6)PARTIAL LEVEL 2 - JANITOR 267 POWER & SYSTEMS LAYOUT

PLOT SCALE:

GSC-A1 DATE PLOTTED:

HU-2-

268


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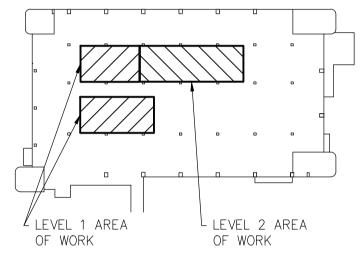
CAD FILE:

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> B drawing no. — where detail required dessin no. — où détail exigé dessin no. — où détail exigé

Ontario

PARTIAL LEVEL 3 POWER & SYSTEMS LAYOUT


CT FΗ project manager administrateur

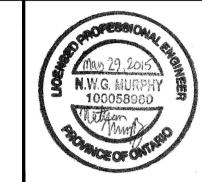AQUIL ALI

drawing no. no. du dessin


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E3.3

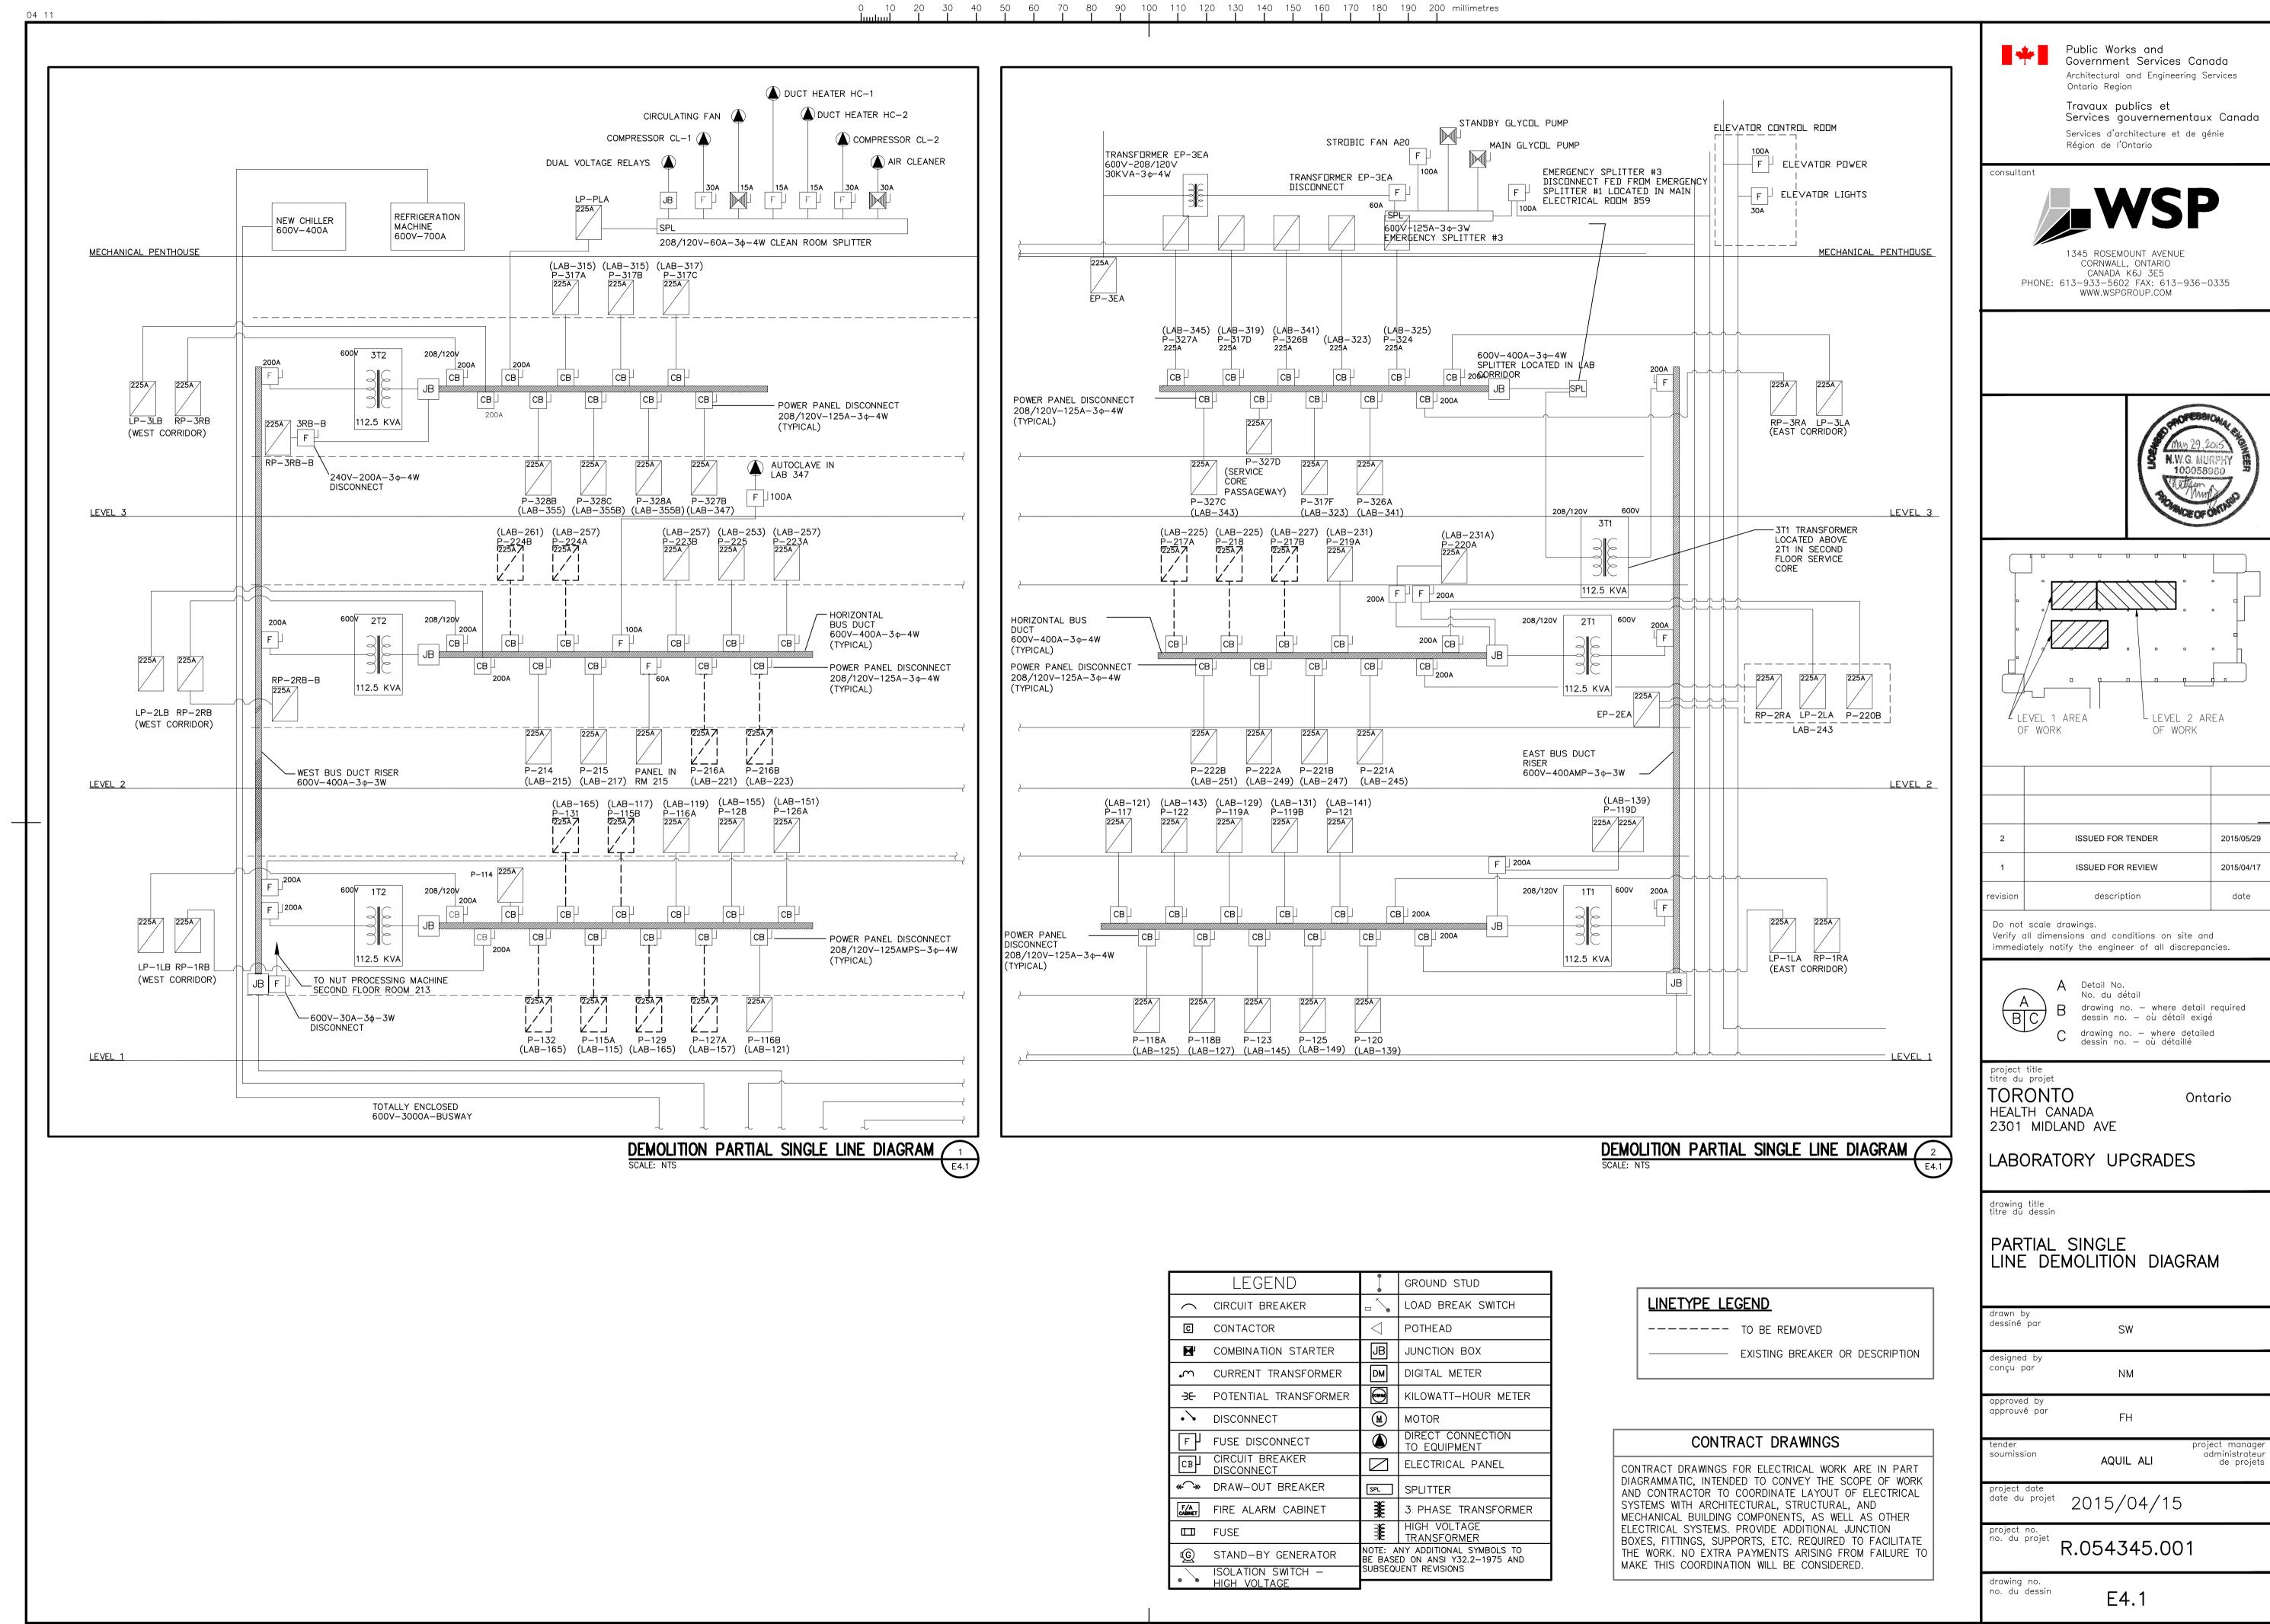

PLOT SCALE:

drawn by dessiné par	SW	
designed by conçu par	NM	
approved by approuvé par	FH	
tender soumission	AQUIL ALI	project manager administrateur de projets

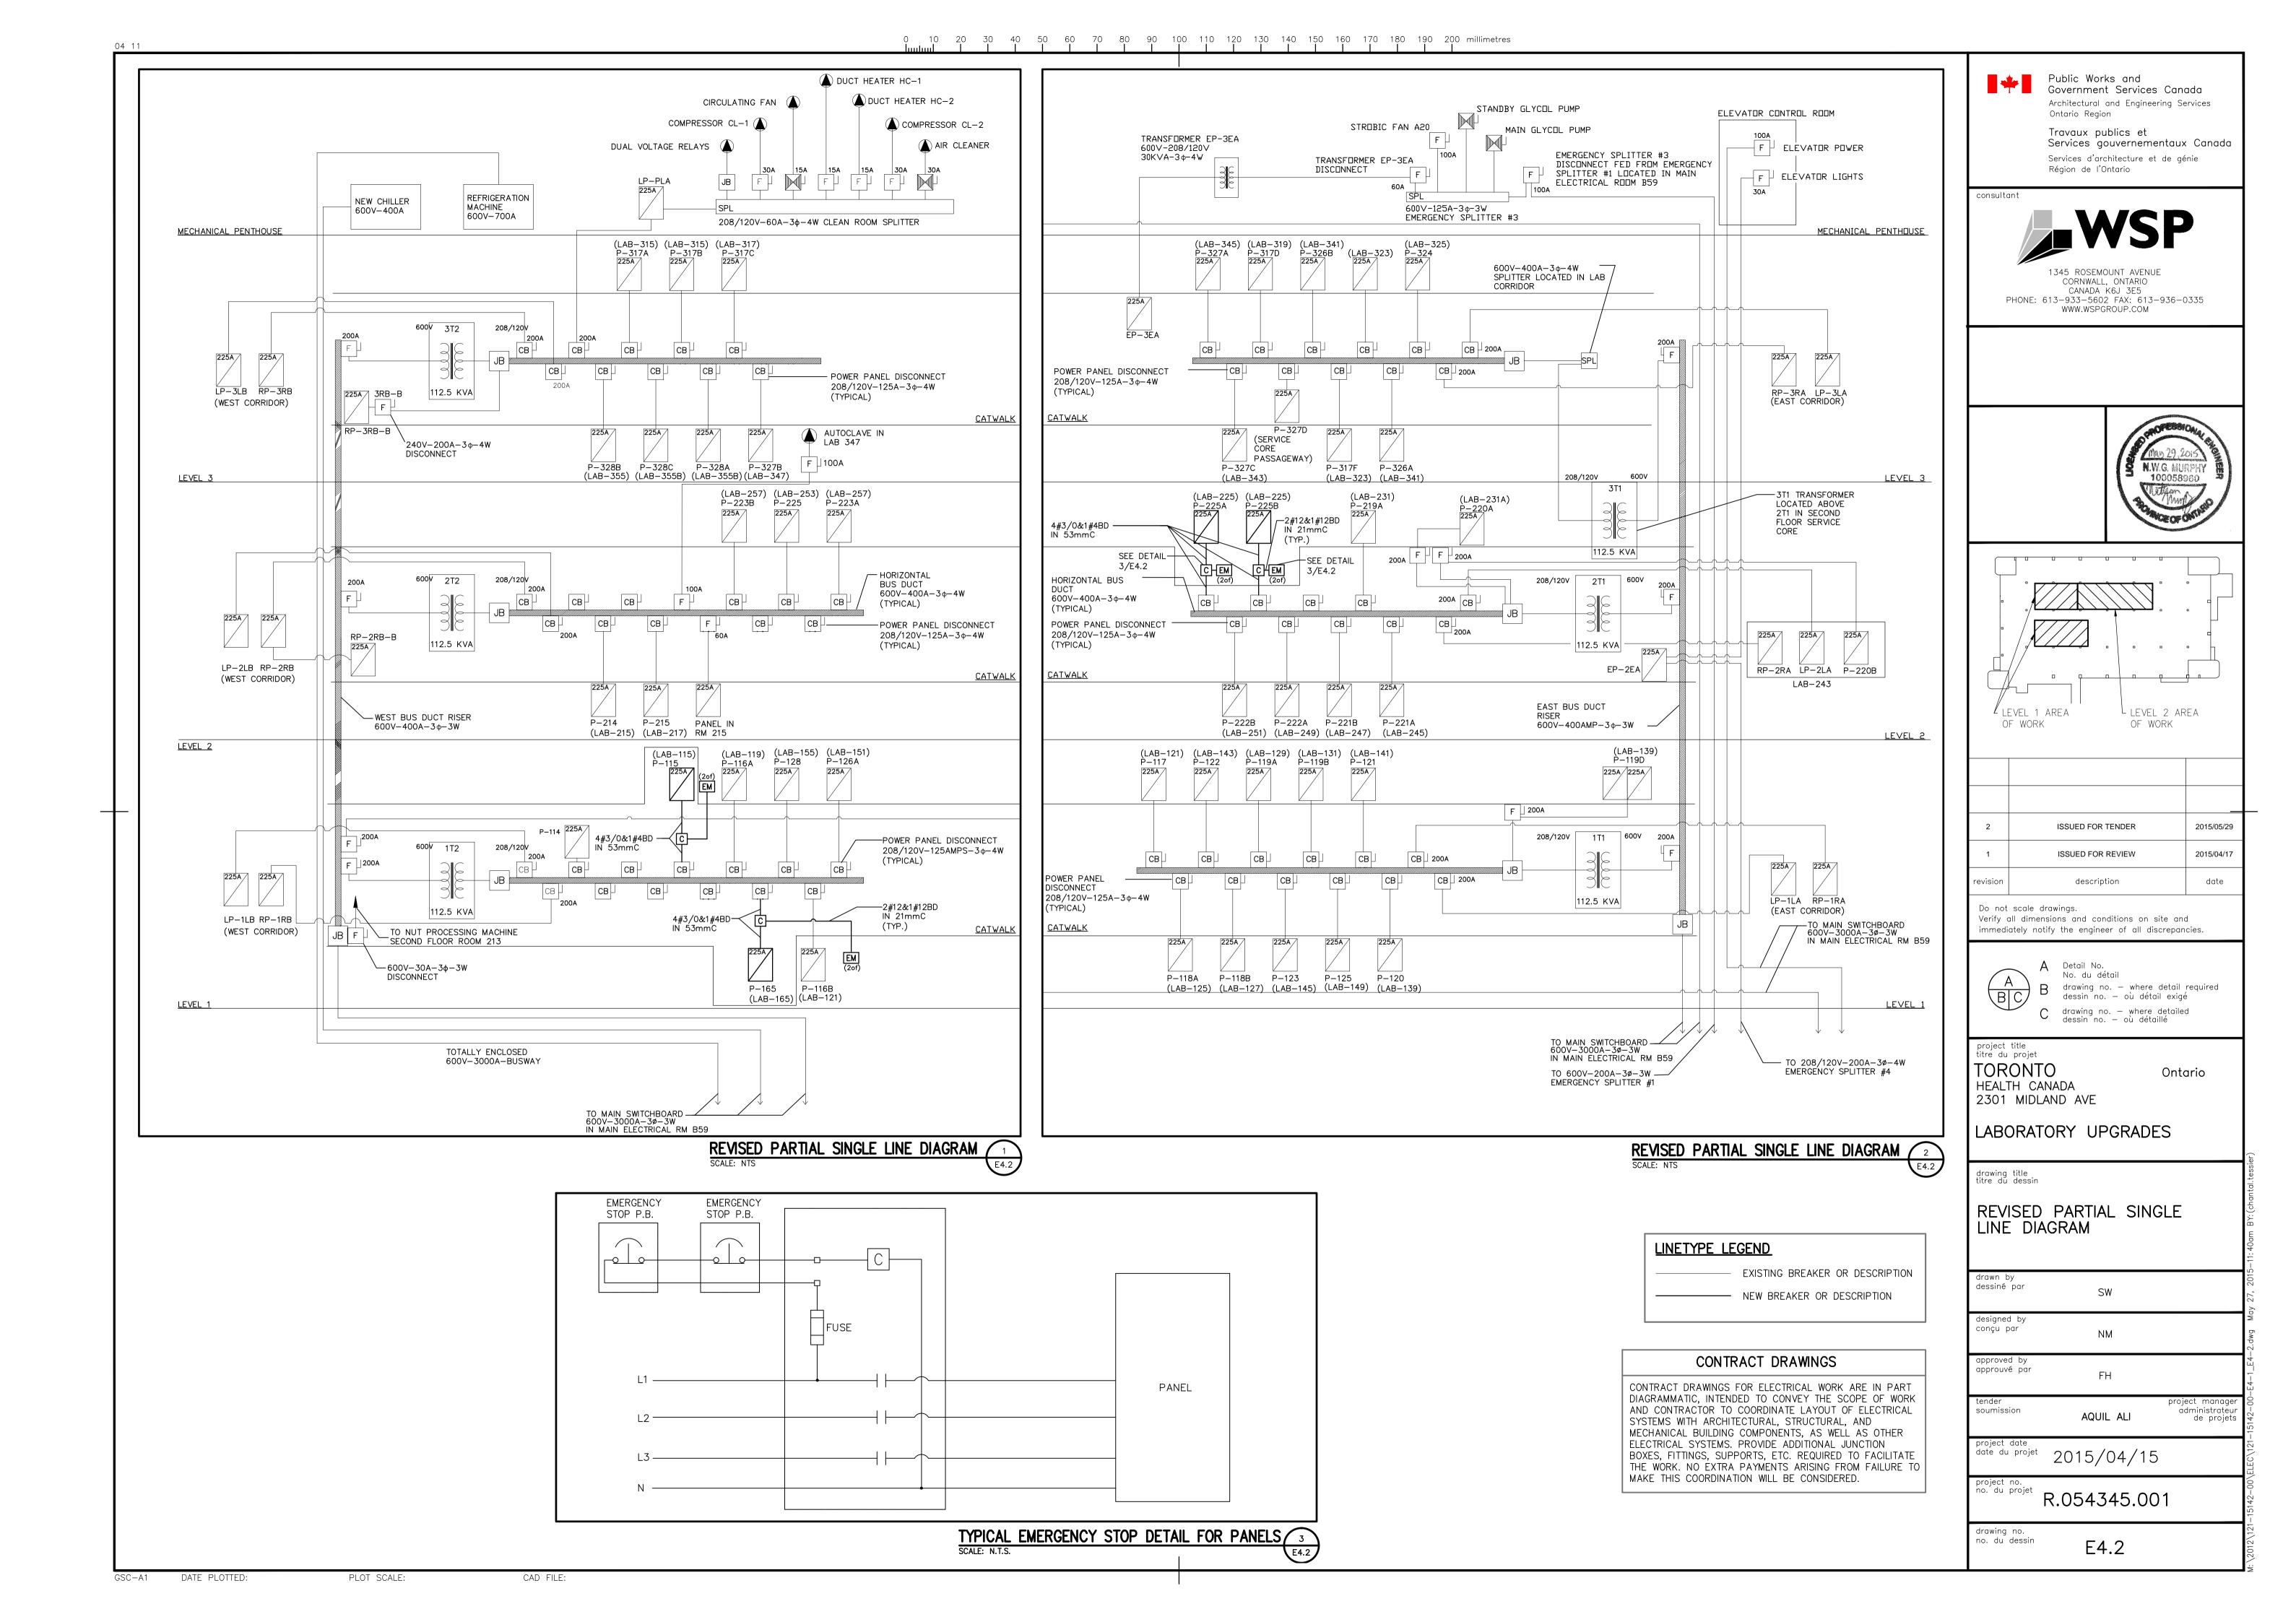

KW	LEG	DESCRIPTION	BKR	CCT #	CCT #	BKR	DESCRIPTION	LEG	кw
_	Р	ROOM 351	15	1	2	30			
-	Р	ROOM 312	15	3	4	2P .	208V-30A XEROX PHOTOCOPIER	Р	_
_	Р		15	5	6	15	REC PHOTO ROOM	Р	-
_	Р	ROM 334, 331, 330	15	7	8	15		Р	-
-	Р	ROOM 310	15	9	10	15		Р	
_	Р	CONVECTION FAN STAIR #1 & 2	20	11	12	15		Р	-
_	Р	POWER SCREEN & PROJECTOR RM 312	15	13	14	15	RM 304 MODULAR FURNITURE	Р	-
_	Р	POWER SCREEN RM 356	15	15	16	15	RM 350 LIGHTS	Р	-
-	Р	SPARE	15	17	18	15	PHOTOHELIC CONTROL PANEL RM 315	Р	-
_	-	MODULAR FURNITURE S.E.	15	19	20	15	MODULAR FURNITURE S.E.	Р	_
_	-	MODULAR FURNITURE S.E.	15	21	22	15	MODULAR FURNITURE S.E.	Р	-
-	-	MODULAR FURNITURE S.E.	15	23	24	15	SPARE TO S.E.	_	-
_	_	MODULAR FURNITURE S.C.	_	25	26	15	MODULAR FURNITURE S.C.	_	_
-	_	MODULAR FURNITURE S.C.	_	27	28	15	MODULAR FURNITURE S.C.	-	_
-	-	SPARE TO S.C.	-	29	30	-	SPARE TO S.C.	_	-
-	_	MODULAR FURNITURE S.W.	_	31	32	_	MODULAR FURNITURE S.W.	_	-
_	_	MODULAR FURNITURE S.W.	_	33	34	_	MODULAR FURNITURE S.W.	_	_
3.7	м	HUMIDIFICATION UNIT FOR	30	35	36	_	SPARE TO S.W.	-	_
<u></u>		CLEAN RM	2P	37	38	20	ELEVATOR MACHINE ROOM A/C	_	_
3.7	м	HUMIDIFICATION UNIT FOR CLEAN RM	30	39	40	2P .			
		CLEAN RM	. 2P	41	42	30	SPARE TO S.W.	Р	-
TYPE	: FEDE	ERAL PIONEER NBLP-42B-44			SHC	RT CIF	RCUIT RATING: 10kA		
MAIN	S RAT	ING: 225A							
MAIN	BREA	KER: N/A			LFG	END:			

LEGEND:

VOLTAGE RATING: 120/208V-3ø-4W

EXISTING PANEL RP-3RB-B (PANEL LOCATED IN 3rd FLOOR MECHANICAL SERVICE ROOM)

P-POWER, H-HEATING, L-LIGHTING, M-MOTOR, \*-GFCI BKR

кw	LEG	DESCRIPTION	BKR	CCT #	CCT #	BKR	DESCRIPTION	LEG	KW
_	Р	RM238, HALLWAYS	15	1	2	15	3RD FLOOR HALL & VALANCE	Р	-
_	Р	2ND FLOORHALL,PENTHOUSE EXIT LIGHTS(EM)	15	3	4	15	ROOMS 326 TO 328, SERVICE CORR.	Р	_
_	Р	2ND FLOOR HALLWAYS & E&N VALANCE	15	5	6	15	ROOMS 314 TO 324, SERVICE CORR.	Р	_
_	Р	ROOMS 221 TO 224, 238 AND HALL	15	7	8	15	PENTHOUSE LIGHTING	L	-
-	Р	ROOMS 214 TO 219, HALL	15	9	10	15	PENTHOUSE RECEPT.—S.WALL	Р	-
_	-	-	15	11	12	15	-	Р	-
_	Р	2ND SERVICE CORRIDOR	15	13	14	15	HUB CABINET RM 228 (LOCK-ON)	Р	-
_	Р	WASHROOM DOORS 2ND FLOOR	15	15	16	15	EMCS (DELTA SYSTEM)	Р	-
-	Р	CFIA 2ND NORTH EMERGENCY UNIT	15	17	18	15	WASHROOM DOORS 1ST FLOOR	Р	-
-	-	SPARE	15	19	20	15	SPARE	Р	-
_	-	-	15	21	22	15	-	Р	_
-	_	-	15	23	24	15	-	_	_
_	Р	ROOM 214-LIGHTS AND PLUGS	15	25	26	15	HUB CABINET-ROOM 204 (LOCK-ON)	_	_
_	Р	ROOM 214 PLUG WEST	15	27	28	15	EMERGENCY POWER TO OFFICE FURNITURE RM 106	-	-
-	Р	ROOM 214 PLUG EAST	15	29	30	15	EMERGENCY POWER TO JIFFY POLE ROOM 112	-	-
_	L	3RD FLOOR VALANCE LIGHTS	15	31	32	20	LAB REC 165	-	_
_	Р	PENTHOUSE COMPUTER RECEPTACLE	15	33	34	15	CIRC. PUMPS	_	_
_	Р	1ST FLOOR LAB SECURITY SYSTEM DAS	15	35	36	15	CIRC. PUMPS	-	_
_	Р	WATER BATHROOM	15	37	38	20	CORR. RECEPT.	_	_
_	Р	FRIDGE #1	20	39	40	15	BATTERY PACK	_	_
_	Ρ	FRIDGE #2	15	41	42	15	7	_	_
_	_	-	15	43	44	7.0	COMPRESSOR IN SERVICE CORR. FOR RM 249	_	_
_	Р	INCUBATOR #3	20	45	46	3P		_	_
_	Р	INCUBATOR #4	20	47	48	40	INSTRUMENT IN RM 249	_	_
_	Р	FRIDGE #6	20	49	50	2P	INSTRUMENT IN RIVIN 243	-	_
_	Р	RECEPT. FOR CORR. NEXT TO COMPRESSOR	15	51	52	30	RM 249 30A 250V TWISTLOCK REC.	_	_
_	Р	LAB 165 FRIDGE	20	53	54	2P	TIME 249 JOA 230V TWISTEOCK REG.	_	_
		Γ	30	55	56	15	CFIA IT RACK PAC POLE	_	-
-	-	_		57	58	15		_	-
		L	3P	59	60	-	SPACE	-	_
_	Р	PREACTION PANEL RM 243, 253(RED)	15	61	62	20	LAB 225 STANDARDS FRIDGE #474	P	_
_	Р	LAB 165 FRIDGE OS56	20	63	64	20	LAB 225 STANDARDS FRIDGE #304	P	-
_	_	SPACE	-	65	66	20	LAB 225 STANDARDS FRIDGE #445	Р	_
		NBLP-66B-44			SHO	RT CIF	RCUIT RATING: 10kA		
		NG: 225A							
MAIN BREAKER: N/A				LEGEND:					
VOLTAGE RATING: 120/208V-3ø-4W				P-POWER, H-HEATING, L-LIGHTING, M-MOTOR, *-GFCI BKR					

EXISTING PANEL EP2-EA 2nd FLOOR MECHANICAL SPACE

VOLTAGE RATING: 120/208V-3ø-4W

KW	LEG	DESCRIPTION	BKR	CCT #	CCT #	BKR	DESCRIPTION	LEG	KV
0.1	Р	LAB 165a RECEPTACLE OS60	20	1	2	20	LAB 165a RECEPTACLE OS61	Р	0.
0.1	Р	LAB 165a RECEPTACLE	20	3	4	20	LAB 165a RECEPTACLE OS57, OS58	Р	0.
0.2	Р	LAB 165a RECEPTACLE OS59, OS60	20	5	6	20	LAB 165a RECEPTACLE	Р	0
0.1	Р	LAB 165a RECEPTACLE	20	7	8	20	LAB 165a RECEPTACLE OS51	Р	0
0.1	P	LAB 165a RECEPTACLE	20	9	10	20	LAB 165a RECEPTACLE	Р	0
0.1	Р	LAB 165a RECEPTACLE	20	11	12	20	LAB 165 RECEPTACLE	Р	O
0.1	Р	LAB 165 RECEPTACLE	20	13	14	20	LAB 165 RECEPTACLE	Р	C
0.1	Р	LAB 165 RECEPTACLE	20	15	16	20	LAB 165 RECEPTACLE	Р	C
0.1	Р	LAB 165 RECEPTACLE	20	17	18	20	LAB 165 RECEPTACLE	Р	C
0.1	Р	LAB 165 RECEPTACLE	20	19	20	20	LAB 165 RECEPTACLE	Р	C
0.1	Р	LAB 165 RECEPTACLE	20	21	22	20	LAB 165 RECEPTACLE OS50	Р	C
0.2	Р	LAB 165 RECEPTACLE OS20	20	23	24	20	LAB 165 RECEPTACLE	Р	O
0.1	Р	LAB 165 RECEPTACLE OS39	20	25	26	20	LAB 165 RECEPTACLE OS39	Р	C
0.1	Р	LAB 165 RECEPTACLE 0S39	20	27	28	20	LAB 165 FUME HOOD MOUNTED SWITCH	Р	c
0.1	Р	LAB 165 RECEPTACLE OS39	20	29	30	20	LAB 165 RECEPTACLE OS39	Р	0
0.1	Р	LAB 165 FUME HOOD MOUNTED SWITCH	20	31	32	20	LAB 165 RECEPTACLE OS39	Р	7
0.1	Р	LAB 165 RECEPTACLE 0S39	20	33	34	20	LAB 165 FUME HOOD MOUNTED SWITCH	Р	,
0.1	Р	LAB 165 RECEPTACLE 0S39	20	35	36	20	LAB 165 RECEPTACLE OS39	Р	7
0.1	Р	LAB 165 FUME HOOD MOUNTED SWITCH	20	37	38	20	LAB 165 RECEPTACLE OS39	Р	,
0.1	Р	LAB 165 FUME HOOD MOUNTED SWITCH	20	39	40	20	LAB 165 RECEPTACLE OS49	Р	1
0.4	Р	LAB 165 RECEPTACLE OS17	20	41	42	20	LAB 165 RECEPTACLE OS16	Р	1
1.6	Р	LAB 165 RECEPTACLE OS16	20	43	44	20	LAB 165 RECEPTACLE 0S20	Р	C
0.1	Р	LAB 165 RECEPTACLE	20	45	46	20	LAB 165 RECEPTACLE OS53c	Р	7
0.2	Р	LAB 165 RECEPTACLE OS52d,	20	47	48	20	LAB 165 RECEPTACLE 0S45, OS52c	Р	7
0.1	Р	LAB 165 RECEPTACLE OS46, OS52e	20	49	50	20	LAB 165 RECEPTACLE OS47	Р	d
0.1	Р	LAB 165 RECEPTACLE OS48	20	51	52	30	LAB 165 RECEPTACLE		T
0.1	Р	LAB 165 RECEPTACLE OS41	20	53	54	2P	FOR UPS. OS42	P	4
0.1	Р	LAB 165 RECEPTACLE OS52b	20	55	56	20	LAB 165 RECEPTACLE OS53b	Р	7
0.1	Р	LAB 165 RECEPTACLE	20	57	58	20	LAB 165 LIGHTS	L	
-	L	LAB 165 LIGHTS	20	59	60	20	LAB 165 RECEPTACLE OS52a, OS53a	Р	C
-	_	SPARE	20	61	62	20	LAB 165 RECEPTACLE 0S52b	-	T
-	_	SPARE	20	63	64	20	SPARE	-	T
-	_	SPARE	20	65	66	20	SPARE	-	
-	_	SPARE	20	67	68	20	SPARE	<del> </del> -	T
_	_	SPARE	20	69	70	20	SPARE	<del> </del> -	T
$\dashv$	_	SPARE	20	71	72	20	SPARE	<del> </del> -	T
-			1			1		1	1

PANEL P-165

## LINETYPE LEGEND

EXISTING BREAKER OR DESCRIPTION

P-POWER, H-HEATING, L-LIGHTING, M-MOTOR, \*-GFCI BKR

NEW BREAKER OR DESCRIPTION

# CONTRACT DRAWINGS

CONTRACT DRAWINGS FOR ELECTRICAL WORK ARE IN PART DIAGRAMMATIC, INTENDED TO CONVEY THE SCOPE OF WORK AND CONTRACTOR TO COORDINATE LAYOUT OF ELECTRICAL SYSTEMS WITH ARCHITECTURAL, STRUCTURAL, AND MECHANICAL BUILDING COMPONENTS, AS WELL AS OTHER ELECTRICAL SYSTEMS. PROVIDE ADDITIONAL JUNCTION BOXES, FITTINGS, SUPPORTS, ETC. REQUIRED TO FACILITATE THE WORK. NO EXTRA PAYMENTS ARISING FROM FAILURE TO MAKE THIS COORDINATION WILL BE CONSIDERED.


Public Works and
Government Services Canada Architectural and Engineering Services Ontario Region

> Travaux publics et Services gouvernementaux Canada Services d'architecture et de génie Région de l'Ontario

consultant





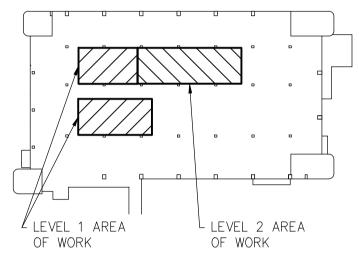

2	ISSUED FOR TENDER	2015/05/29
1	ISSUED FOR REVIEW	2015/04/17
revision	description	date

Do not scale drawings. Verify all dimensions and conditions on site and immediately notify the engineer of all discrepancies.



A Detail No. No. du détail B drawing no. – where detail required dessin no. — où détail exigé C drawing no. — where detailed dessin no. — où détaillé

project title titre du projet TORONTO HEALTH CANADA 2301 MIDLAND AVE

Ontario

LABORATORY UPGRADES

drawing title titre du dessin

PANEL SCHEDULES

drawn by dessiné par SW designed by conçu par NM approved by approuvé par FΗ

soumission AQUIL ALI

project date date date du projet 2015/04/15

project no. no. du projet R.054345.001

drawing no. no. du dessin E5.1

PLOT SCALE: GSC-A1 DATE PLOTTED: CAD FILE: 20 | 1 | 2 | 20 | LAB 221 RECEPTACLE OS31

20 7 8 20 LAB 221 RECEPTACLE OS28

20 | 11 | 12 | 20 | LAB 221 RECEPTACLE OS3

20 | 13 | 14 | 20 | LAB 221 RECEPTACLE OS5

20 | 15 | 16 | 20 | LAB 221 RECEPTACLE OS20

20 | 17 | 18 | 20 | LAB 221 RECEPTACLE OS19

20 | 19 | 20 | 20 | LAB 221 RECEPTACLE OS12

20 | 21 | 22 | 20 | LAB 221 RECEPTACLE OS14

20 | 23 | 24 | 20 | LAB 221 RECEPTACLE

20 | 25 | 26 | 20 | LAB 221 RECEPTACLE

20 | 27 | 28 | 20 | LAB 221 RECEPTACLE

20 | 31 | 32 | 20 | LAB 221 RECEPTACLE

20 | 33 | 34 | 20 | LAB 221 RECEPTACLE

20 37 38 20 LAB 221 RECEPTACLE

20 39 40 20 LAB 221 RECEPTACLE

20 29 30 20 LAB 221 FUME HOOD MOUNTED SWITCH

20 35 36 20 LAB 221 FUME HOOD MOUNTED SWITCH

20 3 4 20 LAB 221 RECEPTACLE

20 | 5 | 6 | 20 | LAB 221 RECEPTACLE

20 9 10 20 LAB 221 RECEPTACLE

DESCRIPTION

| KW | LEG |

DESCRIPTION

0.1 P LAB 221 RECEPTACLE OS32

0.1 P LAB 221 RECEPTACLE OS10

1.0 P LAB 221 RECEPTACLE OS4

0.2 P LAB 221 RECEPTACLE OS21

1.3 P LAB 221 RECEPTACLE OS11

0.1 P LAB 221 RECEPTACLE OS13

0.9 P LAB 221 RECEPTACLE OS15

SWITCH

0.1 P LAB 221 RECEPTACLE

SWITCH

PANEL P-115

0.1 P LAB 221 FUME HOOD MOUNTED

0.1 P LAB 221 FUME HOOD MOUNTED SWITCH

0.1 P LAB 221 FUME HOOD MOUNTED SWITCH

LAB 221 FUME HOOD MOUNTED

0.9 P LAB 221 RECEPTACLE OS2, OS1

0.1 P LAB 221 RECEPTACLE

LEG KW

P 0.1

P 0.1

KW	LEG	DESCRIPTION	BKR	CCT #	CCT #	BKR	DESCRIPTION	LEG	кw		
0.1	Р	LAB 115 RECEPTACLE OS39	20	1	2	20	LAB 115 RECEPTACLE OS39	Р	0.1		
0.1	Р	LAB 115 FUME HOOD MOUNTED SWITCH	20	3	4	20	LAB 115 RECEPTACLE OS39	Р	0.1		
0.1	Р	LAB 115 RECEPTACLE OS39	20	5	6	20	LAB 115 FUME HOOD MOUNTED SWITCH	Р	0.1		
0.1	Р	LAB 115 RECEPTACLE OS39	20	7	8	20	LAB 115 RECEPTACLE OS39	Р	0.1		
0.1	Р	LAB 115 FUME HOOD MOUNTED SWITCH	20	9	10	20	LAB 115 RECEPTACLE OS39	Р	0.1		
0.1	Р	LAB 115 RECEPTACLE OS39	20	11	12	20	LAB 115 FUME HOOD MOUNTED SWITCH	Р	0.1		
0.1	Р	LAB 115 RECEPTACLE OS39	20	13	14	20	LAB 115 RECEPTACLE OS39	Р	0.1		
0.1	Р	LAB 115 RECEPTACLE	20	15	16	20	LAB 115 RECEPTACLE	Р	0.1		
0.2	Р	LAB 115 RECEPTACLE OS38	20	17	18	20	LAB 115 RECEPTACLE	Р	0.1		
0.1	Р	LAB 115 RECEPTACLE	20	19	20	20	LAB 115 RECEPTACLE	Р	0.1		
0.1	Р	LAB 115 RECEPTACLE	20	21	22	20	LAB 115 RECEPTACLE OS35	Р	0.1		
0.1	Р	LAB 115 RECEPTACLE OS36	20	23	24	20	LAB 115 RECEPTACLE OS63	Р	0.1		
0.1	Р	LAB 115 RECEPTACLE	20	25	26	20	LAB 115 RECEPTACLE OS40	Р	0.1		
0.1	Р	LAB 115 RECEPTACLE	20	27	28	20	LAB 115 RECEPTACLE	Р	0.1		
0.1	Р	LAB 115 RECEPTACLE	20	29	30	20	LAB 115 RECEPTACLE	Р	0.1		
0.1	Р	LAB 115 RECEPTACLE	20	31	32	20	LAB 115 RECEPTACLE	Р	0.1		
0.1	Р	LAB 115 RECEPTACLE	20	33	34	20	LAB 115 RECEPTACLE	Р	0.1		
0.1	Р	LAB 115 RECEPTACLE	20	35	36	20	LAB 115 RECEPTACLE	Р	0.1		
0.1	Р	LAB 115 RECEPTACLE	20	37	38	20	LAB 115 RECEPTACLE	Р	0.1		
0.1	Р	LAB 115 RECEPTACLE	20	39	40	20	LAB 115 RECEPTACLE	Р	0.1		
0.1	Р	LAB 115 RECEPTACLE	20	41	42	20	LAB 115 RECEPTACLE	Р	0.1		
0.1	Р	LAB 115 RECEPTACLE	20	43	44	20	LAB 115 RECEPTACLE	Р	0.1		
_	L	LAB 115 LIGHTS	20	45	46	20	LAB 115 LIGHTS	L	_		
_	-	SPARE	20	47	48	20	SPARE	_	-		
_	-	SPARE	20	49	50	20	SPARE	_	_		
_	-	SPARE	20	51	52	20	SPARE	_	-		
_	-	SPARE	20	53	54	20	SPARE	_	_		
_	-	SPARE	20	55	56	20	SPARE	_	_		
_	_	SPARE	20	57	58	20	SPARE	_	_		
_	-	SPARE	20	59	60	20	SPARE	-	-		
_	-	SPARE	20	61	62	20	SPARE	_	_		
_	-	SPARE	20	63	64	20	SPARE	_	_		
_	-	SPARE	20	65	66	20	SPARE	_	_		
_	-	SPARE	20	67	68	20	SPARE	_	_		
_	-	SPARE	20	69	70	20	SPARE	_	_		
_	-	SPARE	20	71	72	20	SPARE	-	_		
TYPE	TYPE: SURFACE C/W BOLT-ON BKR. LOCK, DOOR & TRIM					SHORT CIRCUIT RATING: 10kA					
MAIN	MAINS RATING: 225A										
		KER C/W BARRIER: 225A			LEGEND:						
VOLTAGE RATING: 120/208V-3ø-4W					P-POWER, H-HEATING, L-LIGHTING, M-MOTOR, *-GFCI BKR						

GSC-A1 DATE PLOTTED:

PLOT SCALE:

CAD FILE:

٠ ا	٠ ا	SWITCH			'			1	***
0.1	Р	LAB 221 RECEPTACLE	20	41	42	20	LAB 221 FUME HOOD MOUNTED SWITCH	Р	0.1
0.1	Р	LAB 221 RECEPTACLE	20	43	44	20	LAB 221 RECEPTACLE	Р	0.1
0.1	Р	LAB 221 FUME HOOD MOUNTED SWITCH	20	45	46	20	LAB 221 RECEPTACLE	Р	0.1
0.1	Р	LAB 221 RECEPTACLE	20	47	48	20	LAB 221 FUME HOOD MOUNTED SWITCH	Р	0.1
0.1	Р	LAB 221 RECEPTACLE	20	49	50	20	LAB 221 RECEPTACLE	Р	0.1
-	ı	SPARE	20	51	52	20	SPARE	_	_
-	-	SPARE	20	53	54	20	SPARE	_	-
-	1	SPARE	20	55	56	20	SPARE	_	-
-	-	SPARE	20	57	58	20	SPARE	-	-
-	-	SPARE	20	59	60	20	SPARE	_	-
-	-	SPARE	20	61	62	20	SPARE	_	-
-	-	SPARE	20	63	64	20	SPARE	_	-
-	-	SPARE	20	65	66	20	SPARE	_	-
-	-	SPARE	20	67	68	20	SPARE	_	-
-	-	SPARE	20	69	70	20	SPARE	_	-
-	-	SPARE	20	71	72	20	SPARE	_	_
TYPE: RECESSED C/W BOLT-ON BKR. LOCK, DOOR & TRIM					SHORT CIRCUIT RATING: 10kA				
AINS	RATI	ING: 225A							
MAIN BREAKER C/W BARRIER: 225A				LEGEND:					
/OLTAGE RATING: 120/208V-3ø-4W				P-POWER, H-HEATING, L-LIGHTING, M-MOTOR, *-GFCI BKR					
							PANEL F	2-25	254

KW	LEG	DESCRIPTION	BKR	CCT #	CCT #	BKR	DESCRIPTION	LEG	ΚV
0.1	Р	LAB 221 RECEPTACLE	20	1	2	20	LAB 221 RECEPTACLE	Р	0.
0.1	Р	LAB 221 RECEPTACLE	20	3	4	20	LAB 221 RECEPTACLE	Р	0.
0.1	Р	LAB 221 RECEPTACLE	20	5	6	20	LAB 221 RECEPTACLE	Р	0.
0.1	Р	LAB 221 RECEPTACLE	20	7	8	20	LAB 221 RECEPTACLE	Р	0.
0.1	Р	LAB 221 RECEPTACLE	20	9	10	15	LAB 221 LIGHTS	L	-
_	L	LAB 221 LIGHTS	15	11	12	20	SPARE	_	-
_	L	LAB 221 LIGHTS	15	13	14	20	SPARE	-	-
_	-	SPARE	20	15	16	20	SPARE	-	-
-	-	SPARE	20	17	18	20	SPARE	-	-
-	-	SPARE	20	19	20	20	SPARE	_	-
0.1	-	LAB 221 RECEPTACLE - ISLAND	20	21	22	20	LAB 221 RECEPTACLE - ISLAND	-	0.
0.1	-	LAB 221 RECEPTACLE - OS23	20	23	24	20	LAB 221 RECEPTACLE - ISLAND	-	0.
0.1	-	LAB 221 RECEPTACLE - ISLAND	20	25	26	20	LAB 221 RECEPTACLE - ISLAND	-	0.
0.1	_	LAB 221 RECEPTACLE - ISLAND	20	27	28	20	LAB 221 RECEPTACLE - ISLAND	_	0.
0.1	_	LAB 221 RECEPTACLE - ISLAND	20	29	30	20	LAB 221 RECEPTACLE - ISLAND	-	0.
0.1	_	LAB 221 RECEPTACLE - ISLAND	20	31	32	20	LAB 221 RECEPTACLE - ISLAND	_	0
0.1	_	LAB 221 RECEPTACLE - ISLAND	20	33	34	20	LAB 221 RECEPTACLE - ISLAND	_	0.
0.1	_	LAB 221 RECEPTACLE - ISLAND	20	35	36	20	LAB 221 RECEPTACLE - OS22	-	0
0.1	_	LAB 221 RECEPTACLE - ISLAND	20	37	38	20	LAB 221 RECEPTACLE - ISLAND	_	0
0.1	-	LAB 221 RECEPTACLE - ISLAND	20	39	40	20	LAB 221 RECEPTACLE - ISLAND	-	0
0.1	-	LAB 221 RECEPTACLE - ISLAND	20	41	42	20	LAB 221 RECEPTACLE - ISLAND	-	0.
-	-	SPARE	20	43	44	20	SPARE	-	-
-	-	SPARE	20	45	46	20	SPARE	-	-
-	_	SPARE	20	47	48	20	SPARE	-	-
-	_	SPARE	20	49	50	20	SPARE	-	-
-	_	SPARE	20	51	52	20	SPARE	-	-
-	-	SPARE	20	53	54	20	SPARE	-	-
-	-	SPARE	20	55	56	20	SPARE	-	-
-	_	SPARE	20	57	58	20	SPARE	-	-
_	-	SPARE	20	59	60	20	SPARE	-	-
-	-	SPARE	20	61	62	20	SPARE	-	-
-	-	SPARE	20	63	64	20	SPARE	-	-
_	_	SPARE	20	65	66	20	SPARE	-	-
-	-	SPARE	20	67	68	20	SPARE	-	-
-	_	SPARE	20	69	70	20	SPARE	-	-
-	-	SPARE	20	71	72	20	SPARE	-	-
TYPE	: REC	ESSED C/W BOLT-ON BKR. LOCK, DOOR	& TRIM	1	SHO	RT CIF	RCUIT RATING: 10kA		
MAIN	S RAT	ING: 225A							
MAIN BREAKER C/W BARRIER: 225A					LEGI	END:			
VOLTAGE RATING: 120/208V-3ø-4W							H-HEATING, L-LIGHTING, M-MOTOR, *-	-GFCI B	KR

### LINETYPE LEGEND

EXISTING BREAKER OR DESCRIPTION

— NEW BREAKER OR DESCRIPTION

# CONTRACT DRAWINGS


CONTRACT DRAWINGS FOR ELECTRICAL WORK ARE IN PART DIAGRAMMATIC, INTENDED TO CONVEY THE SCOPE OF WORK AND CONTRACTOR TO COORDINATE LAYOUT OF ELECTRICAL SYSTEMS WITH ARCHITECTURAL, STRUCTURAL, AND MECHANICAL BUILDING COMPONENTS, AS WELL AS OTHER ELECTRICAL SYSTEMS. PROVIDE ADDITIONAL JUNCTION BOXES, FITTINGS, SUPPORTS, ETC. REQUIRED TO FACILITATE THE WORK. NO EXTRA PAYMENTS ARISING FROM FAILURE TO MAKE THIS COORDINATION WILL BE CONSIDERED.


Public Works and Government Services Canada Architectural and Engineering Services Ontario Region

Travaux publics et Services gouvernementaux Canada Services d'architecture et de génie Région de l'Ontario

consultant



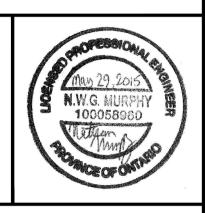

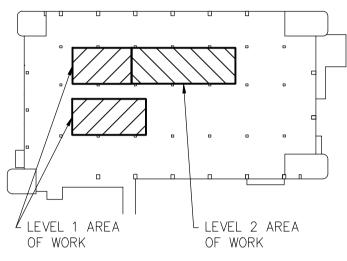

2	ISSUED FOR TENDER	2015/05/29
1	ISSUED FOR REVIEW	2015/04/17
revision	description	date

Do not scale drawings. Verify all dimensions and conditions on site and immediately notify the engineer of all discrepancies.



A Detail No. No. du détail B drawing no. - where detail required dessin no. — où détail exigé C drawing no. — where detailed dessin no. — où détaillé

project title titre du projet TORONTO HEALTH CANADA 2301 MIDLAND AVE

Ontario

LABORATORY UPGRADES

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