


GENERAL NOTES :  
DO NOT SCALE THIS DRAWING FOR CONSTRUCTION PURPOSES. USE FIGURED DIMENSIONS AS NOTED.  
THESE DRAWINGS ARE TO BE READ IN CONJUNCTION WITH SPECIFICATIONS AND GENERAL CONTRACTUAL CONDITIONS.  
ALL DIMENSIONS AND CONDITIONS ARE TO BE VERIFIED ON SITE. ALL DISCREPANCIES ARE TO BE REPORTED TO THE DEPARTMENTAL REPRESENTATIVE AND AGREED UPON WITH THEM IN WRITING BEFORE PROCEEDING WITH WORKS.  
INFORMATION ON THESE DRAWINGS IS TO BE USED FOR THIS PROJECT ONLY AND SHALL NOT BE USED FOR ANY OTHER PURPOSE.

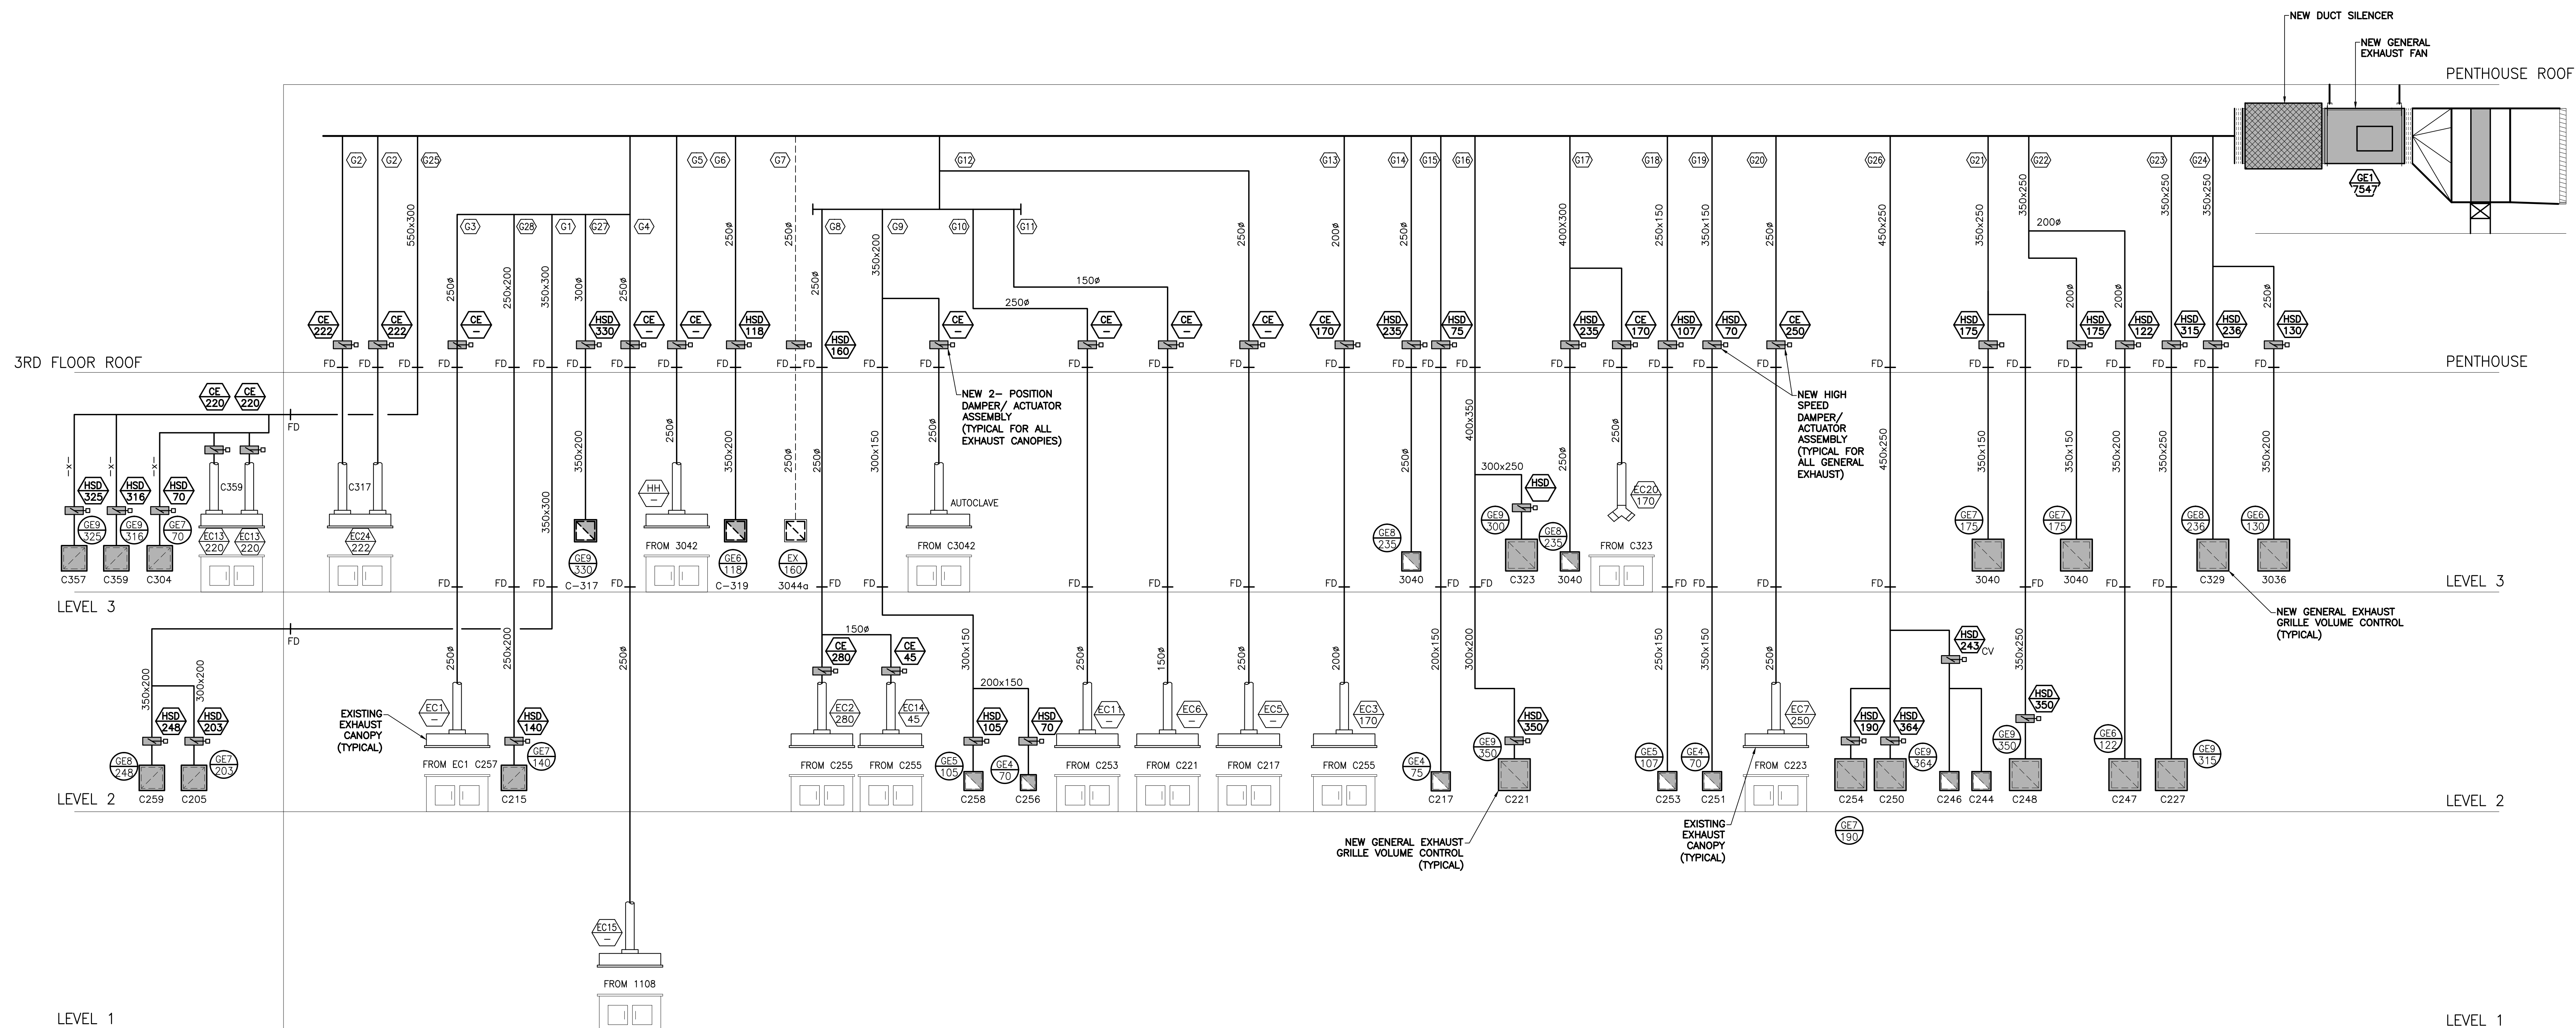

GENERAL EXHAUST RISER  
FUME HOOD RISER  
FUME HOOD TYPE  
FUME HOOD AIRFLOW (L/S)  
FUME HOOD NUMBER

HSD  
NEW 2-POSITION STAINLESS STEEL BUTTERFLY DAMPER C/W HIGH SPEED ACTUATOR AND FLOW MEASURING STATION (TYPICAL FOR ALL LABORATORY GENERAL EXHAUST)  
NEW 2-POSITION STAINLESS STEEL BUTTERFLY DAMPER C/W AIR FLOW MEASURING STATION (TYPICAL FOR ALL CANOPY EXHAUST)  
NOTE:  
1) THIS DRAWING IS FOR SCHEMATIC LAYOUT, EQUIPMENT QUANTITIES, AND AIR BALANCING. SEE DWG'S H302, H306, ANF H308 FOR NEW AND EXISTING DUCTWORK LAYOUTS.

MECHANICAL: GENERAL EXHAUST SCHEMATIC  
SCALE: 1:50  
0m 1m 2m 3m 4m 5m



3	ISSUED FOR TENDER	OCT 28 2015
2	99% REVIEW	SEP 11 2015
1	66% REVIEW	JUN 30 2015
revisions		date

project  
AFC KENTVILLE RESEARCH CENTRE LABATORY BLOCK-C CONTROLS SYSTEM UPGRADE KENTVILLE, N.S.

drawing  
MECHANICAL: GENERAL EXHAUST SCHEMATIC

designed	PFH	conçu
date	JULY 2015	
drew	CAB	dessiné
date	JULY 2015	
approved		approuvé
date		
Tender		Submission
PWOSC Project Manager	Administrateur de projets TPSC	
project number		no. du projet
	R.074306.001	
drawing no.		no. du dessin
	H503	