



POLE LIGHT FIXTURE INSTALLATION
SCALE : N.T.S.
1 E3

NOTES:

1. TYPICAL MOUNTING HEIGHT IS 7620mm FROM WHARF DECK TO UNDERSIDE OF FIXTURE
2. TYPICAL FOR POLES 2, 3, & 4

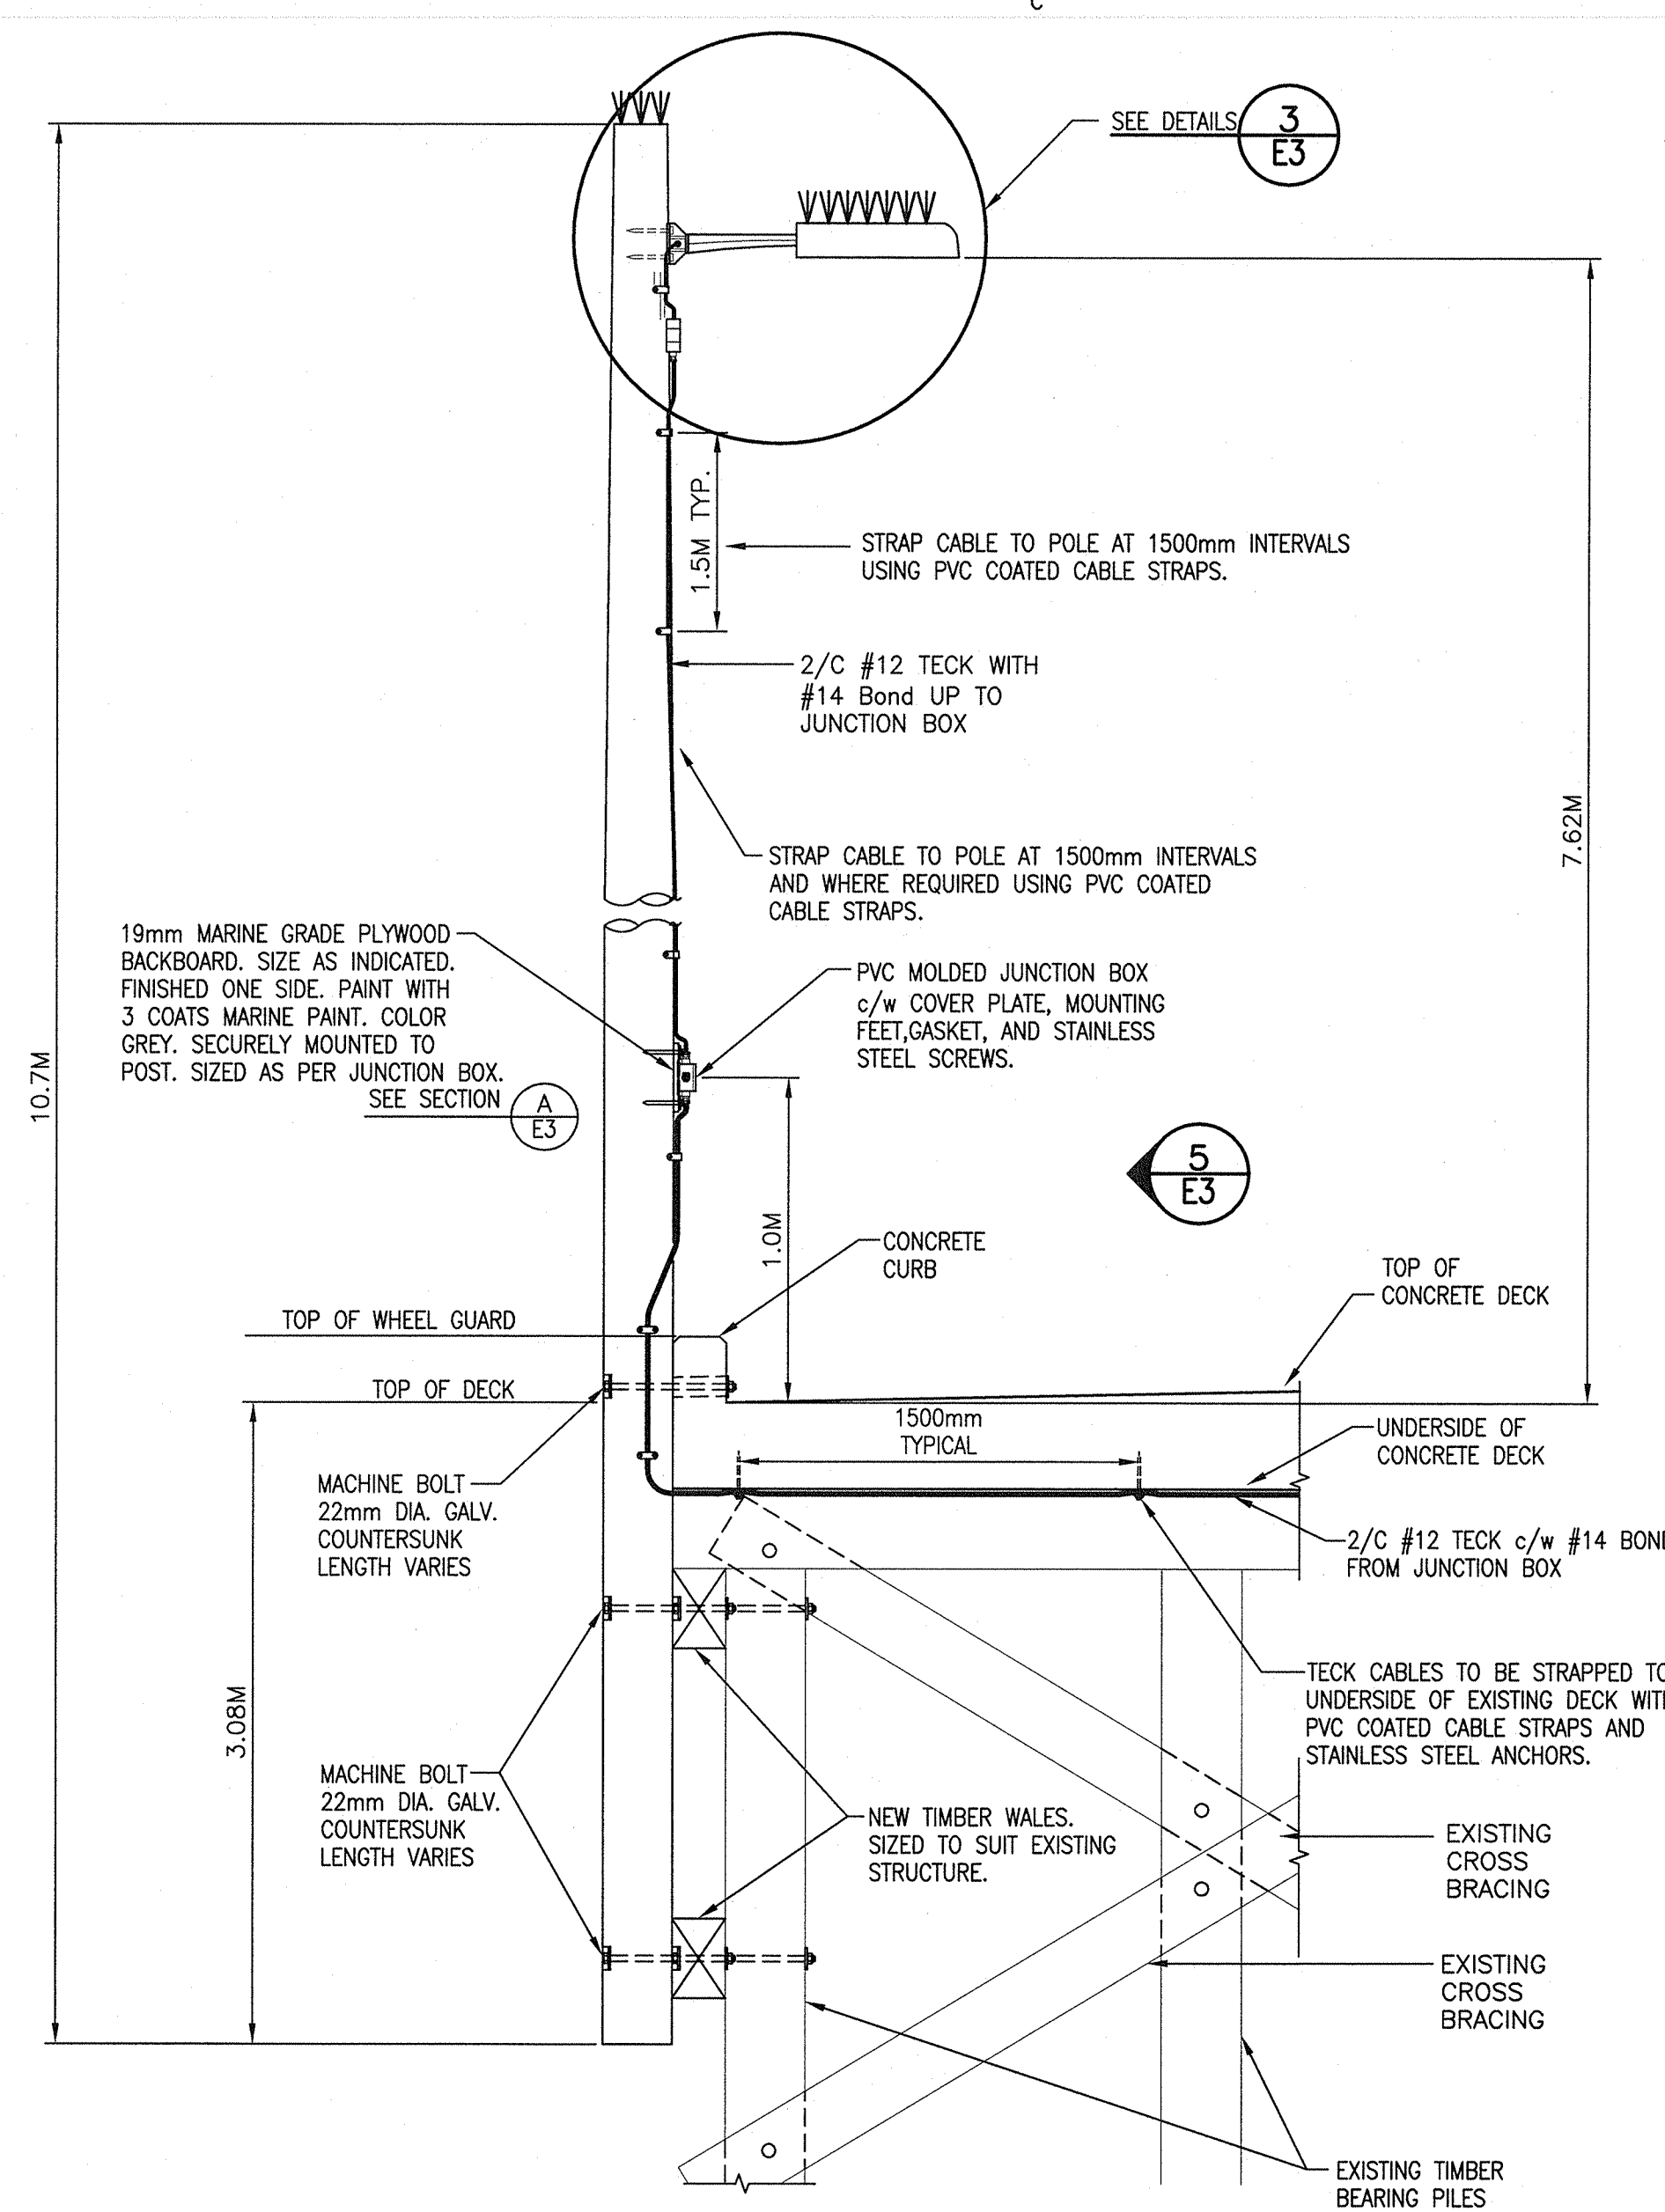


NEW POLE #5 POLE & LIGHT INSTALLATION
SCALE: 1:25
2 E3

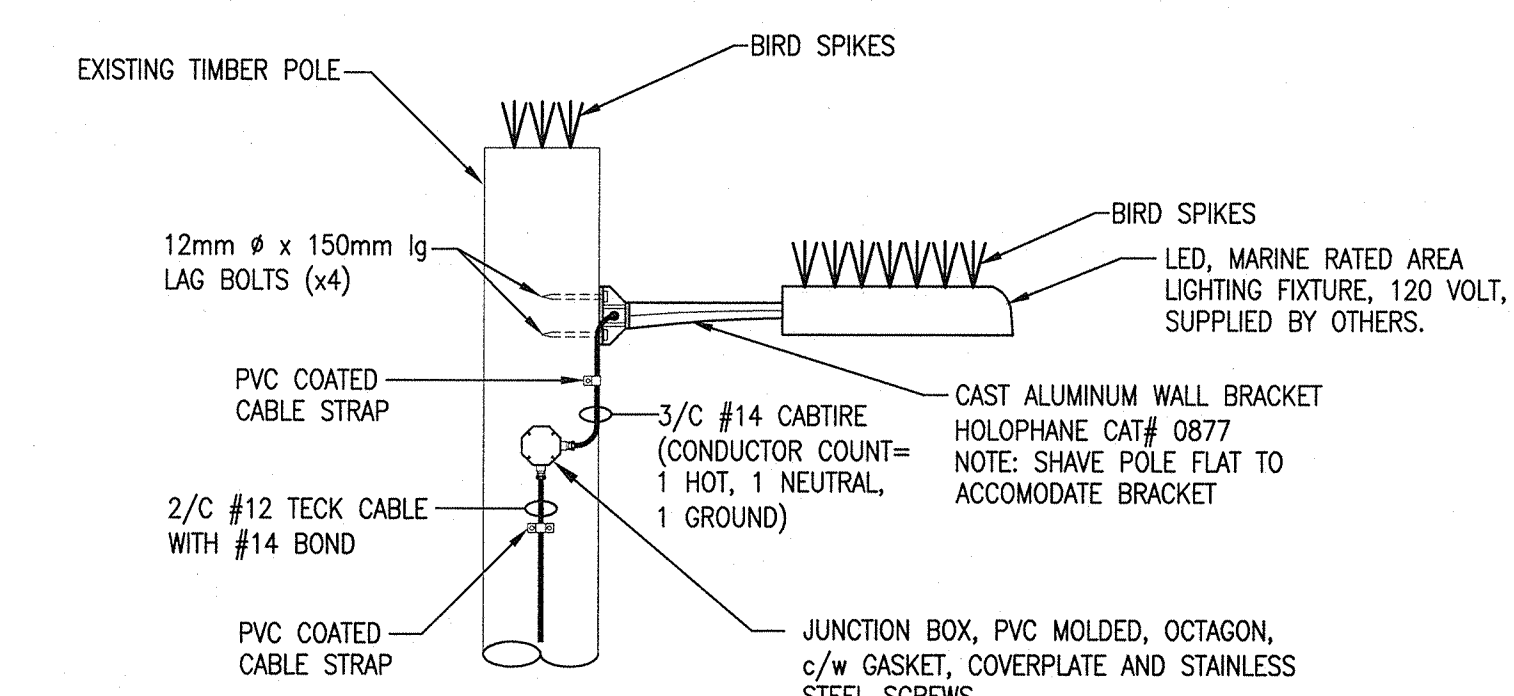

LUMINAIRE MOUNTING DETAIL
SCALE : N.T.S.
3 E3


NOTE: TYPICAL FOR FIXTURE ON POLES 1, 2 & 3

- NOTES:**
1. ALL TECK CABLE OR METALLIC CONDUIT TERMINATED ON FIBREGLASS OR PVC BOXES SHALL UTILIZE BONDING LOCKNUTS. ALL BONDING LOCKNUTS SHALL BE CONNECTED TO GROUND USING A #14 AWG GREEN INSULATED CONDUCTOR.
 2. CONTRACTOR TO SUPPLY AND INSTALL PVC COATED CABLE GLAND FOR ALL CABTIRE CONNECTIONS.
 3. CONTRACTOR TO SUPPLY AND INSTALL PVC COATED TECK CONNECTORS FOR ALL TECK CABLE CONNECTIONS.

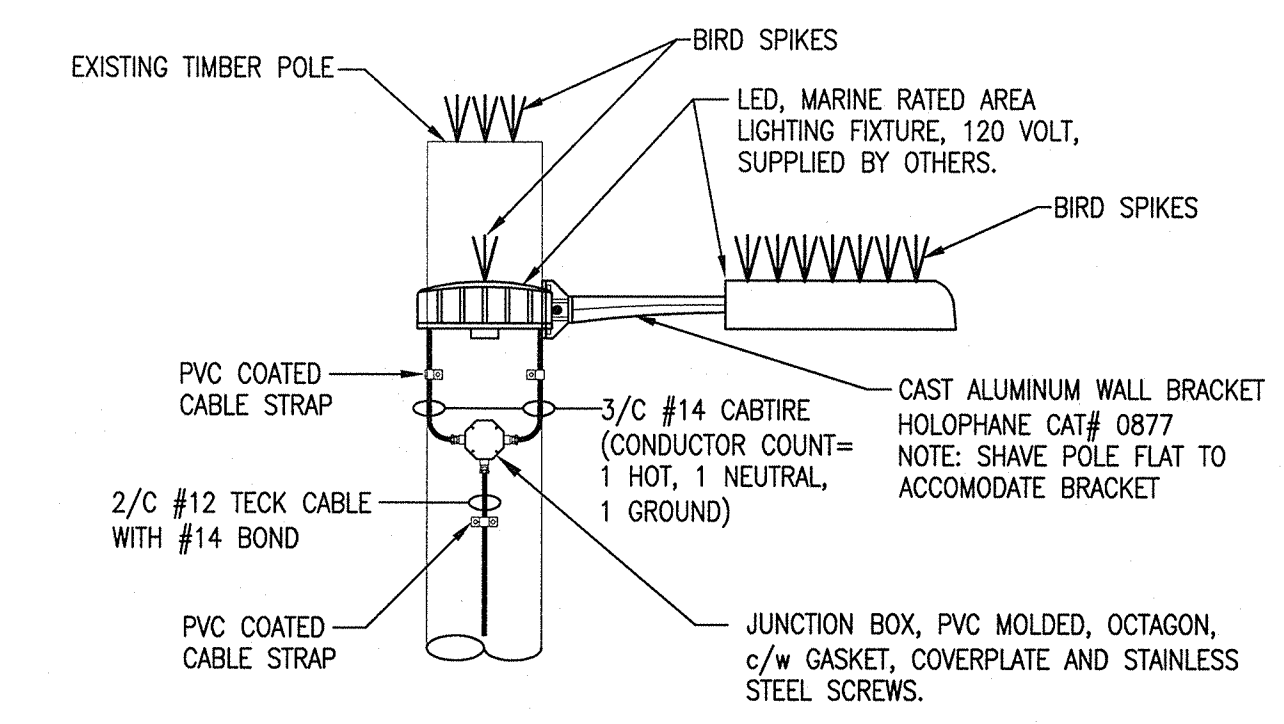


POLE #4 LUMINAIRE MOUNTING DETAIL
SCALE : N.T.S.
4 E3


- NOTES:**
1. ALL TECK CABLE OR METALLIC CONDUIT TERMINATED ON FIBREGLASS OR PVC BOXES SHALL UTILIZE BONDING LOCKNUTS. ALL BONDING LOCKNUTS SHALL BE CONNECTED TO GROUND USING A #14 AWG GREEN INSULATED CONDUCTOR.
 2. CONTRACTOR TO SUPPLY AND INSTALL PVC COATED CABLE GLAND FOR ALL CABTIRE CONNECTIONS.
 3. CONTRACTOR TO SUPPLY AND INSTALL PVC COATED TECK CONNECTORS FOR ALL TECK CABLE CONNECTIONS.

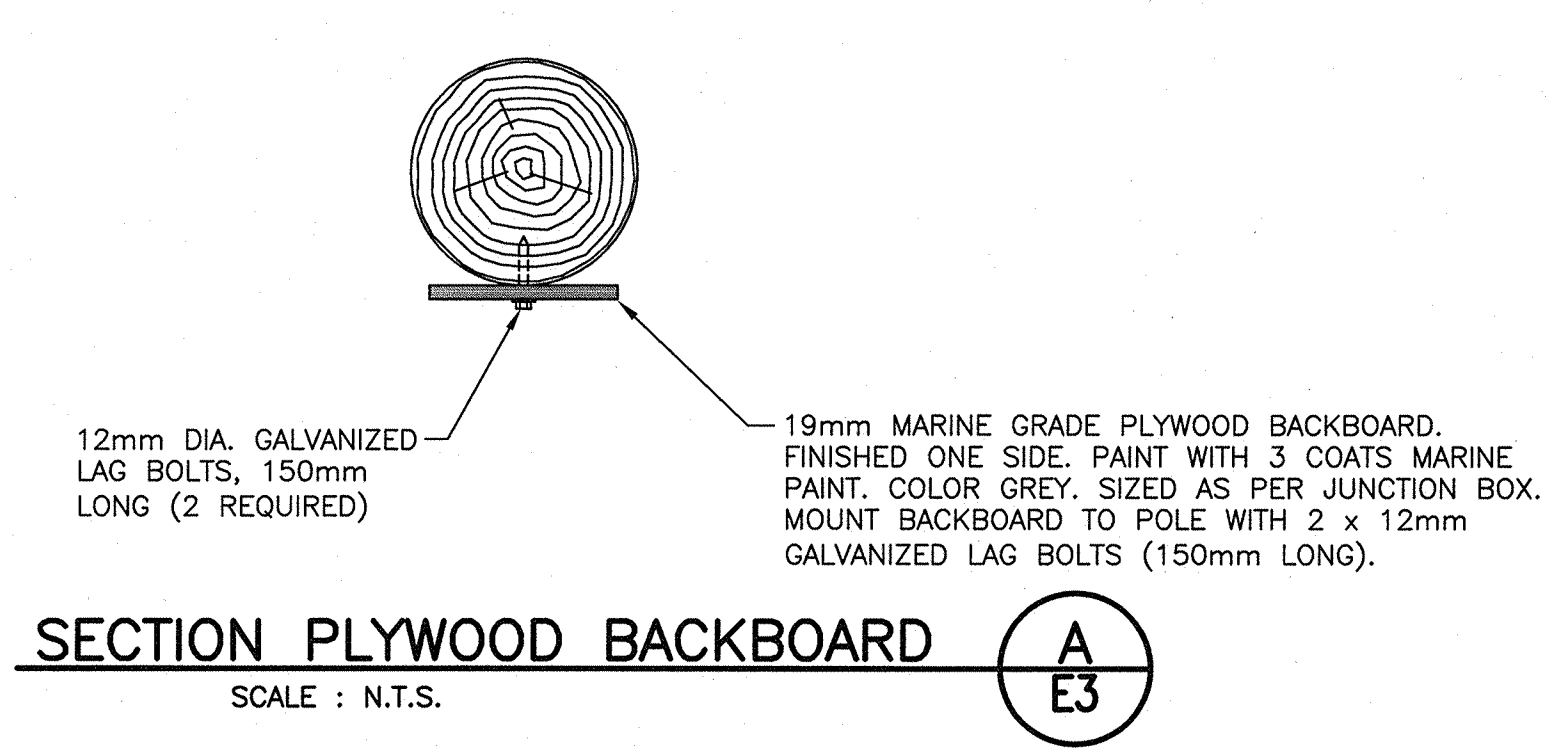

SECTION PLYWOOD BACKBOARD
SCALE : N.T.S.
A E3

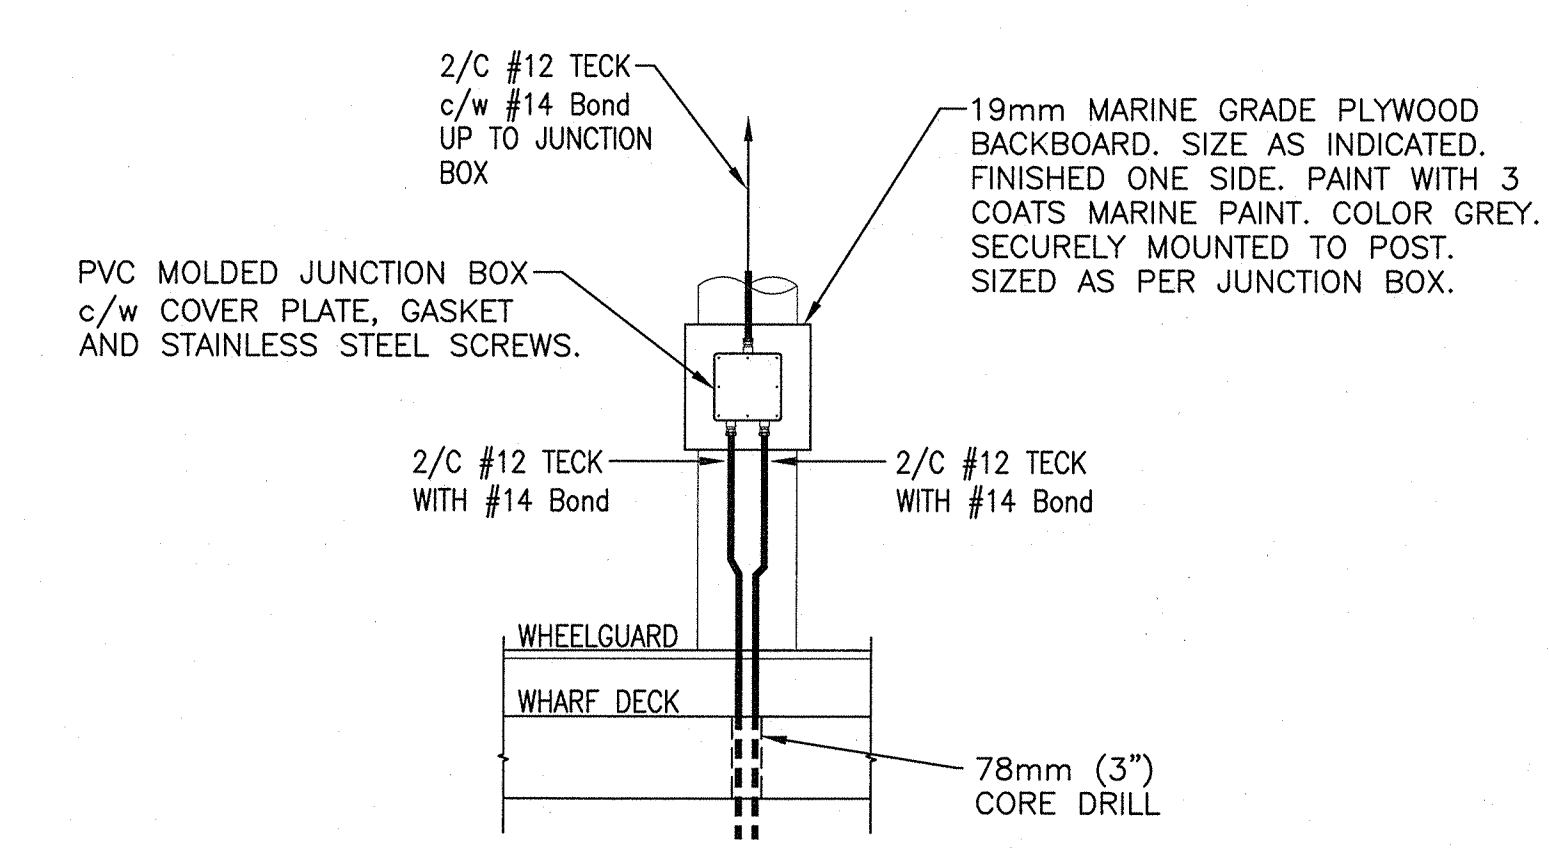

ELEVATION - POLE MOUNTED JUNCTION BOX
SCALE : N.T.S.
5 E3

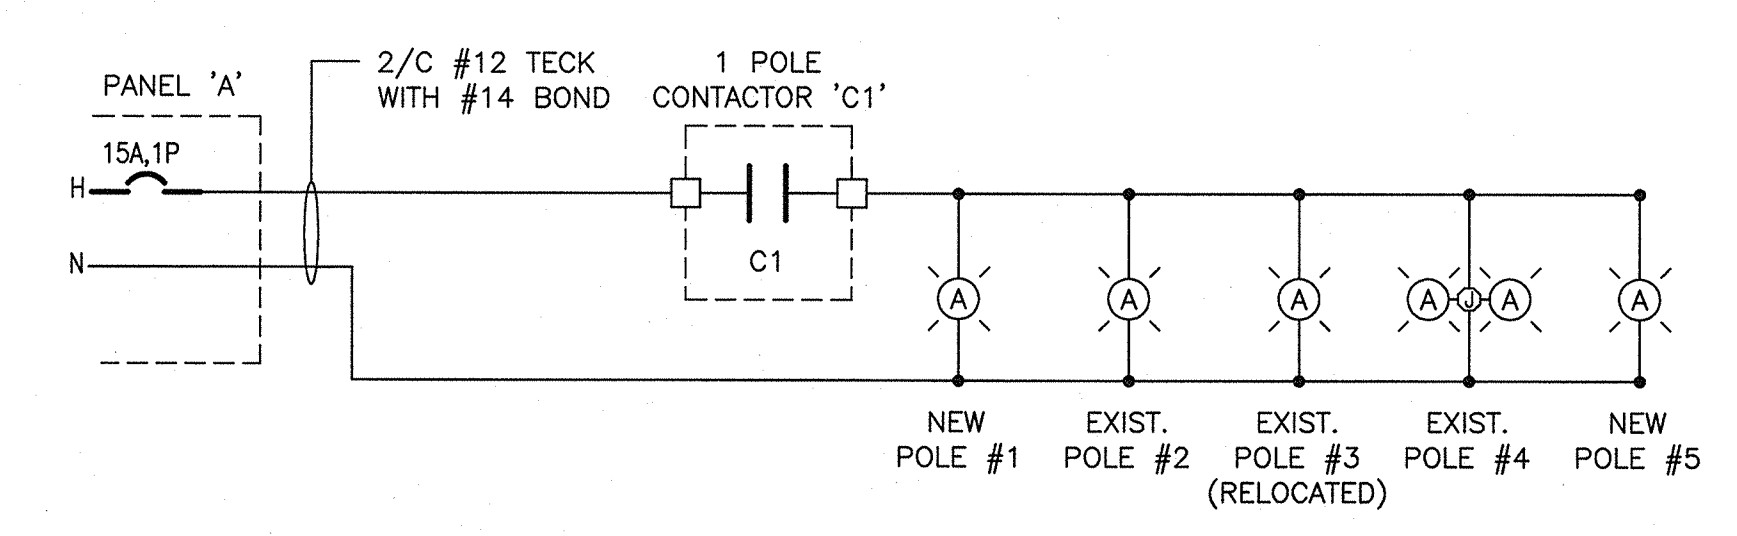

NEW WHARF LIGHTING CONTROL SCHEMATIC & WIRING DIAGRAM - 1 POLE CONTACTOR
SCALE : N.T.S.
6 E3

- NOTES:**
1. CONTACTS RATED FOR 15 AMP, 120V
 2. 15 AMP COIL

0	ISSUED FOR TENDER	NOV. 2015
revisions		date
project	project	
WHARF CONSTRUCTION		
MARIE JOSEPH GUYSBOROUGH COUNTY NOVA SCOTIA		
drawing	dessein	
SITE LIGHTING DETAILS		
designed	K. WOLFE/G. BOWSER	conçu
date	NOVEMBER 2015	
drawn	K. WOLFE	dessiné
date	NOVEMBER 2015	
approved		approuvé
date	2015 11	
submitted	soumission	
PWBC Project Manager	RÉALISATEUR DE PROJETS TPSC	
project number	no. du projet	
R.076162.001		
drawing no.	no. du dessein	
E3		