


1 SECOND FLOOR CONSTRUCTION RCP
A5 SCALE: 1:100

GENERAL NOTES

- NOTES REGARDING "MAKE GOOD EXISTING" DO NOT APPLY TO AREAS IDENTIFIED AS HAVING A LIMITED SCOPE.
- ENSURE THAT ALL PIPING, DUCTING AND ANY OPENINGS THAT RUN THROUGH NEW SLAB TO SLAB PARTITIONS OR PLENUM BARRIERS ARE FIRESTOPPED TO MEET FRR SEPARATIONS AND PROPERLY SEALED WITH ACOUSTIC CAULKING TO ACHIEVE STC SEPARATIONS. REFER TO MECHANICAL.
- INSTALL BLOCKING AND/OR BRACING IN CEILING AS REQUIRED TO SUPPORT DOORS, FRAMES AND SIDELIGHTS.

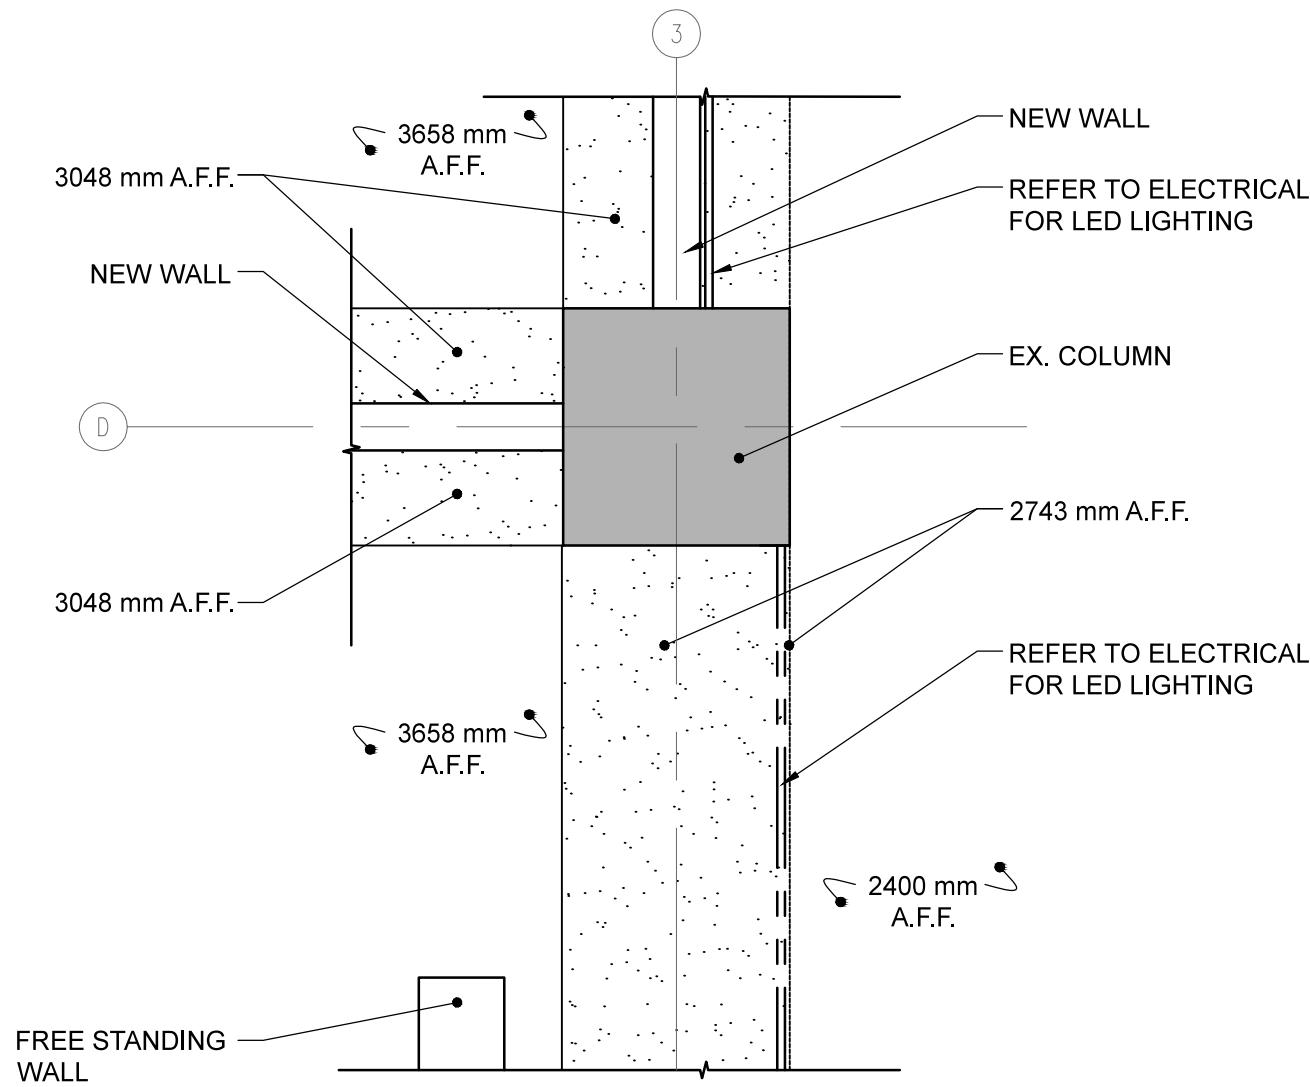


2 BULKHEAD CEILING HEIGHT DETAIL
A5 SCALE: 1:20

RCP LEGEND

- NEW RETURN AIR
- NEW EXHAUST GRILLE
- NEW AIR CONDITIONING UNIT
- NEW SUPPLY DIFFUSER
- EXISTING LIGHT FIXTURE RELOCATED FROM EXISTING SPACE
- NEW RECESSED LUMINAIRE (610 X 1220)
- NEW RECESSED LUMINAIRE (305 X 1220)
- NEW RECESSED LUMINAIRE (152 X 1220)
- NEW WALL MOUNT LUMINAIRE
- COVE STRIP LIGHTING
- LINEAR & SUSPENDED FIXTURE
- STRIP STYLE LUMINAIRE
- RECESSED DOWNLIGHT
- 1219 mm x 610 mm ACOUSTIC CEILING TILE (NEW UNLESS INDICATED W/ KEYNOTE 3)
- 610 mm x 610 mm ACOUSTIC CEILING TILE (NEW)
- EXISTING GYPSUM BOARD FINISH
- NEW GYPSUM BOARD FINISH
- CEILING HEIGHT, A.F.F. CEILING FINISH
- NEW FIRE RESISTANCE RATING SEPARATION (FRR) (REFER TO A3)
- ACOUSTIC PLENUM BARRIER (REFER TO SPEC.)
- AREA NOT WITHIN SCOPE OF RENOVATION
- LIMITED SCOPE OF WORK
NOTE: TO INCLUDE DEMO OF INDICATED WALLS AND MECH. & ELEC. WORK (AS INDICATED ON MECH & ELEC). FINISHES TO REMAIN. NOT REQUIRED TO MAKE GOOD EXISTING IN AREAS LABELED AS LIMITED SCOPE.

KEYNOTES

- POCKET FOR FOLDING PANEL PARTITIONS
- PATCH, REPAIR AND MAKE GOOD CEILING AT LOCATION WHERE ACT. MEETS EXISTING HALLWAY BULKHEAD. REVIEW W/ DEPARTMENTAL REPRESENTATIVE (POST DEMOLITION) FOR BULKHEAD DETAIL.
- REUSE EXISTING STORED ACT. AND LIGHT FIXTURES IN RM 100A PUBLIC CORRIDOR A AND RM 100B PUBLIC CORRIDOR B.
- INSTALL ACT. AT MAXIMUM HEIGHT A.F.F. TO CLEAR ANY EXISTING STRUCTURAL MEMBERS (IE: BULKHEADS)
- CONTROL JOINT TO ALIGN W/ COLUMN.
- ALIGN BULKHEAD FACE W/ EDGE OF WALL.
- ALIGN BULKHEAD EAST VERTICAL FACE WITH COLUMNS AT INTERSECTIONS OF GRIDLINE 3 AND A, B, & C AT THEIR MOST WESTERLY EAST FACE.
- ALIGN BULKHEAD W/ FACE OF COLUMN.
- RECESSED DOWNLIGHT TO BE CENTERED IN CEILING TILE. DOWNLIGHT IN BULKHEAD TO ALIGN WITH DOWNLIGHT IN ACT. ON EAST / WEST PLANE.
- RECESSED DOWNLIGHT TO ALIGN WITH RECESSED LIGHT FIXTURE.
- RECESSED DOWNLIGHT TO ALIGN WITH SUSPENDED LIGHT FIXTURE.
- GWB BULKHEAD TO MATCH HEIGHT A.F.F. OF EXISTING BULKHEAD ALONG GRIDLINE 2.
- DROP CEILING TO BE CENTERED OVER MEETING ROOM TABLE.
- ACCESS HATCH (305 mm x 305 mm).

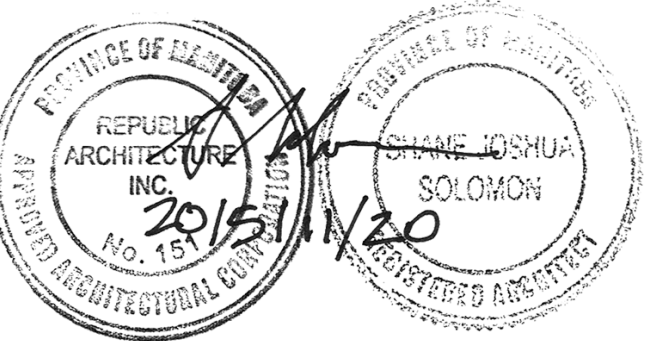

DO NOT SCALE DRAWINGS

Revision/Revision	Description/Description	Date/Date
3	ISSUED FOR CONSTRUCTION	15/11/20
2	100% CD SUBMISSION	15/10/29
1	99% CD SUBMISSION	15/09/28
0	50% CD SUBMISSION	15/08/14

CANADA SCHOOL OF PUBLIC SERVICE (CSPS)

Winnipeg
Manitoba

Project title/Titre du projet
**2ND FLOOR - 391 YORK AVENUE
WINNIPEG, MANITOBA**
CSPS WINNIPEG FIT-UP

Approved by/Approuvé par
SS
Designed by/Concept par
BP
Drawn by/Dessiné par
HR
PWGSC Project Manager/Administrateur de Projets TPSCG
JOHN ALIBIN
PWGSC, Architectural and Engineering Resources Manager/
Ressources Architectural et de Directeur d'ingénierie, TPSCG
Client/client
PUBLIC WORKS AND GOVERNMENT SERVICES CANADA
Drawing title/Titre du dessin
**SECOND FLOOR CONSTRUCTION
REFLECTED CEILING PLAN**