


GREENHOUSE LINE VOLTAGE PLAN

SCALE: 1:50
0m 1m 2m 3m 4m 5m


1
GHE-02

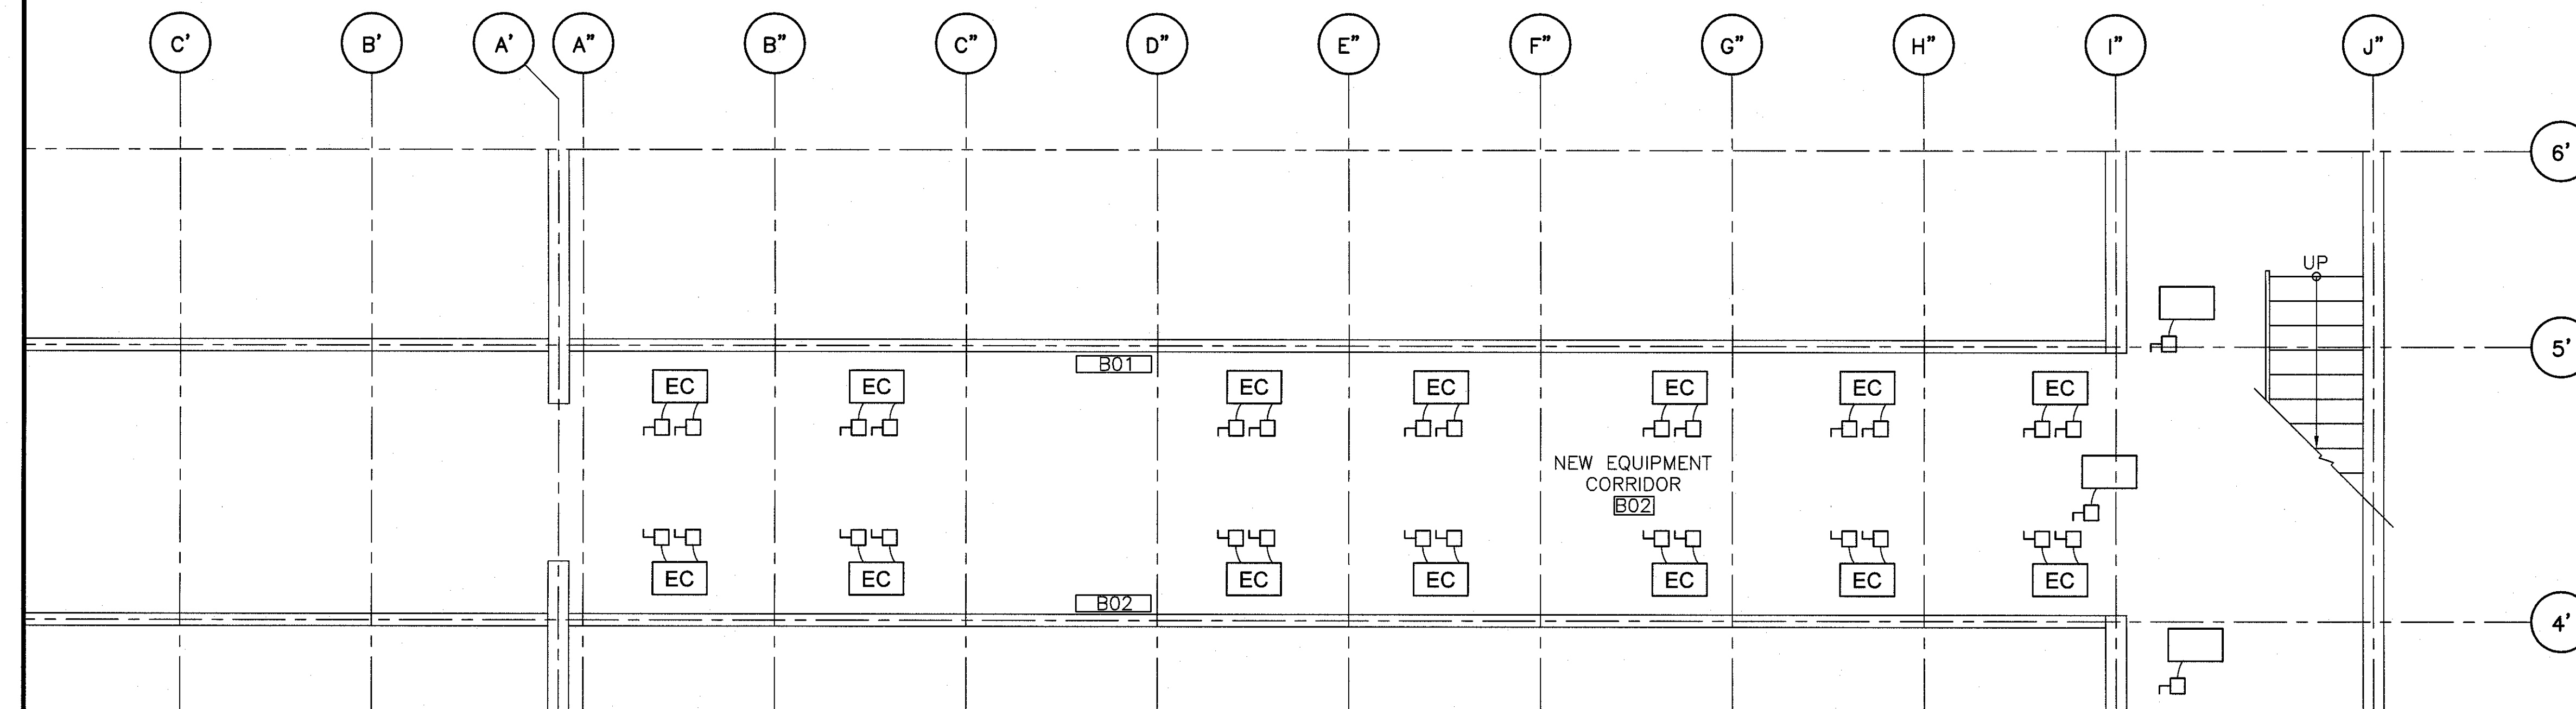

BASEMENT LEVEL LINE VOLTAGE PLAN

SCALE: 1:50
0m 1m 2m 3m 4m 5m

2
GHE-01

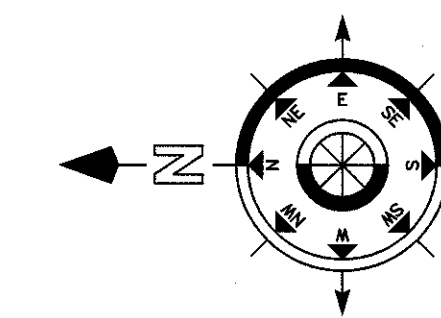


KEYED NOTES:

EC	EVAPORATIVE COOLER UNIT - 3#12 + GROUND + 3 POLE DISCONNECT SWITCH (FAN) + 2#12 + 2 POLE DISCONNECT SWITCH (PUMP)
P1	OVERHEAD HW WATER CIRCULATING PUMP 2#12 + GROUND + DISCONNECT SWITCH
P2	LOW LEVEL HW WATER CIRCULATING PUMP 2#12 + GROUND + DISCONNECT SWITCH
HAF	HAF FAN - 2#12 + GROUND
⊗	SERVICE LIGHT - 2#12 + GROUND
RVM	RIDGE VENT MOTOR 3#12 + GROUND + 3 POLE DISCONNECT SWITCH
RSM	ROOF SHADE MOTOR 3#12 + GROUND + 3 POLE DISCONNECT SWITCH
VSM	VERTICAL SHADE MOTOR - 2#12 + GROUND + DISCONNECT SWITCH
PPF	POSITIVE PRESSURE - 2#12 + GROUND + DISCONNECT SWITCH
NPF	NEGATIVE PRESSURE - 2#12 + GROUND + DISCONNECT SWITCH
MD	MOTORIZED DAMPER
TLMD	TRANSFER LOUVER MOTORIZED DAMPER

NOTES:

- ALL CONNECTIONS TO BE CONNECTED TO ZONE PANEL LOCATED IN THE CORRIDOR
- REFER TO DRAWING GH-05, CORRIDOR ELEVATIONS FOR CONTROL PANELS.
- THE EXISTING NEGATIVE PRESSURE FAN AND DAMPER ON GRID A' ABOVE THE EXISTING DOOR TO BE RELOCATED TO THE NORTH ELEVATION OF THE EXISTING GREENHOUSE. DISCONNECT THE EXISTING ELECTRICAL CONNECTIONS AND PROVIDE NEW 2#12 + GROUND + DISCONNECT SWITCH TO THE FAN IN THE RELOCATED POSITION.

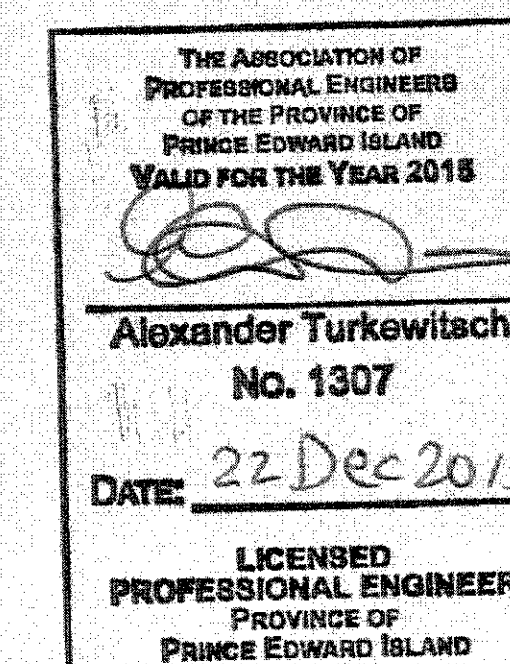

2	ISSUED FOR TENDER	9-10-15
1	ISSUED FOR 66% SUBMISSION	15-9-15
revisions		date

project
**A AFC GREENHOUSE
EXPANSION
HARRINGTON RESEARCH
FARM
HARRINGTON, PEI**

drawing
**GREENHOUSE
LINE VOLTAGE PLAN**

designed AT	conçu
drawn AE	dessiné
date JULY 21, 2015	
approved <i>[Signature]</i>	approuvé
date <i>[Signature]</i>	
Tender <i>[Signature]</i>	Soumission
PWOSC Project Manager	Administrateur de projets TPSCC
project number	no. du projet
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drawing no.	no. du dessin
GHE-02	