

2	ISSUED FOR TENDER	9-10-15
1	ISSUED FOR 66% SUBMISSION	15-9-15
revisions		date

project  
**AFC GREENHOUSE  
EXPANSION  
HARRINGTON RESEARCH  
FARM  
HARRINGTON, PEI**

drawing  
**GREENHOUSE  
CORRIDOR ELEVATIONS**

designed AT congru

drawn AE dessiné

date JULY 21, 2015

approved *[Signature]* approuvé

Tender *[Signature]* Soumission


PWOSC Project Manager Administrateur de projets TPSGC

project number no. du projet

**R.072545.001**


drawing no. no. du dessin

**GH-05**

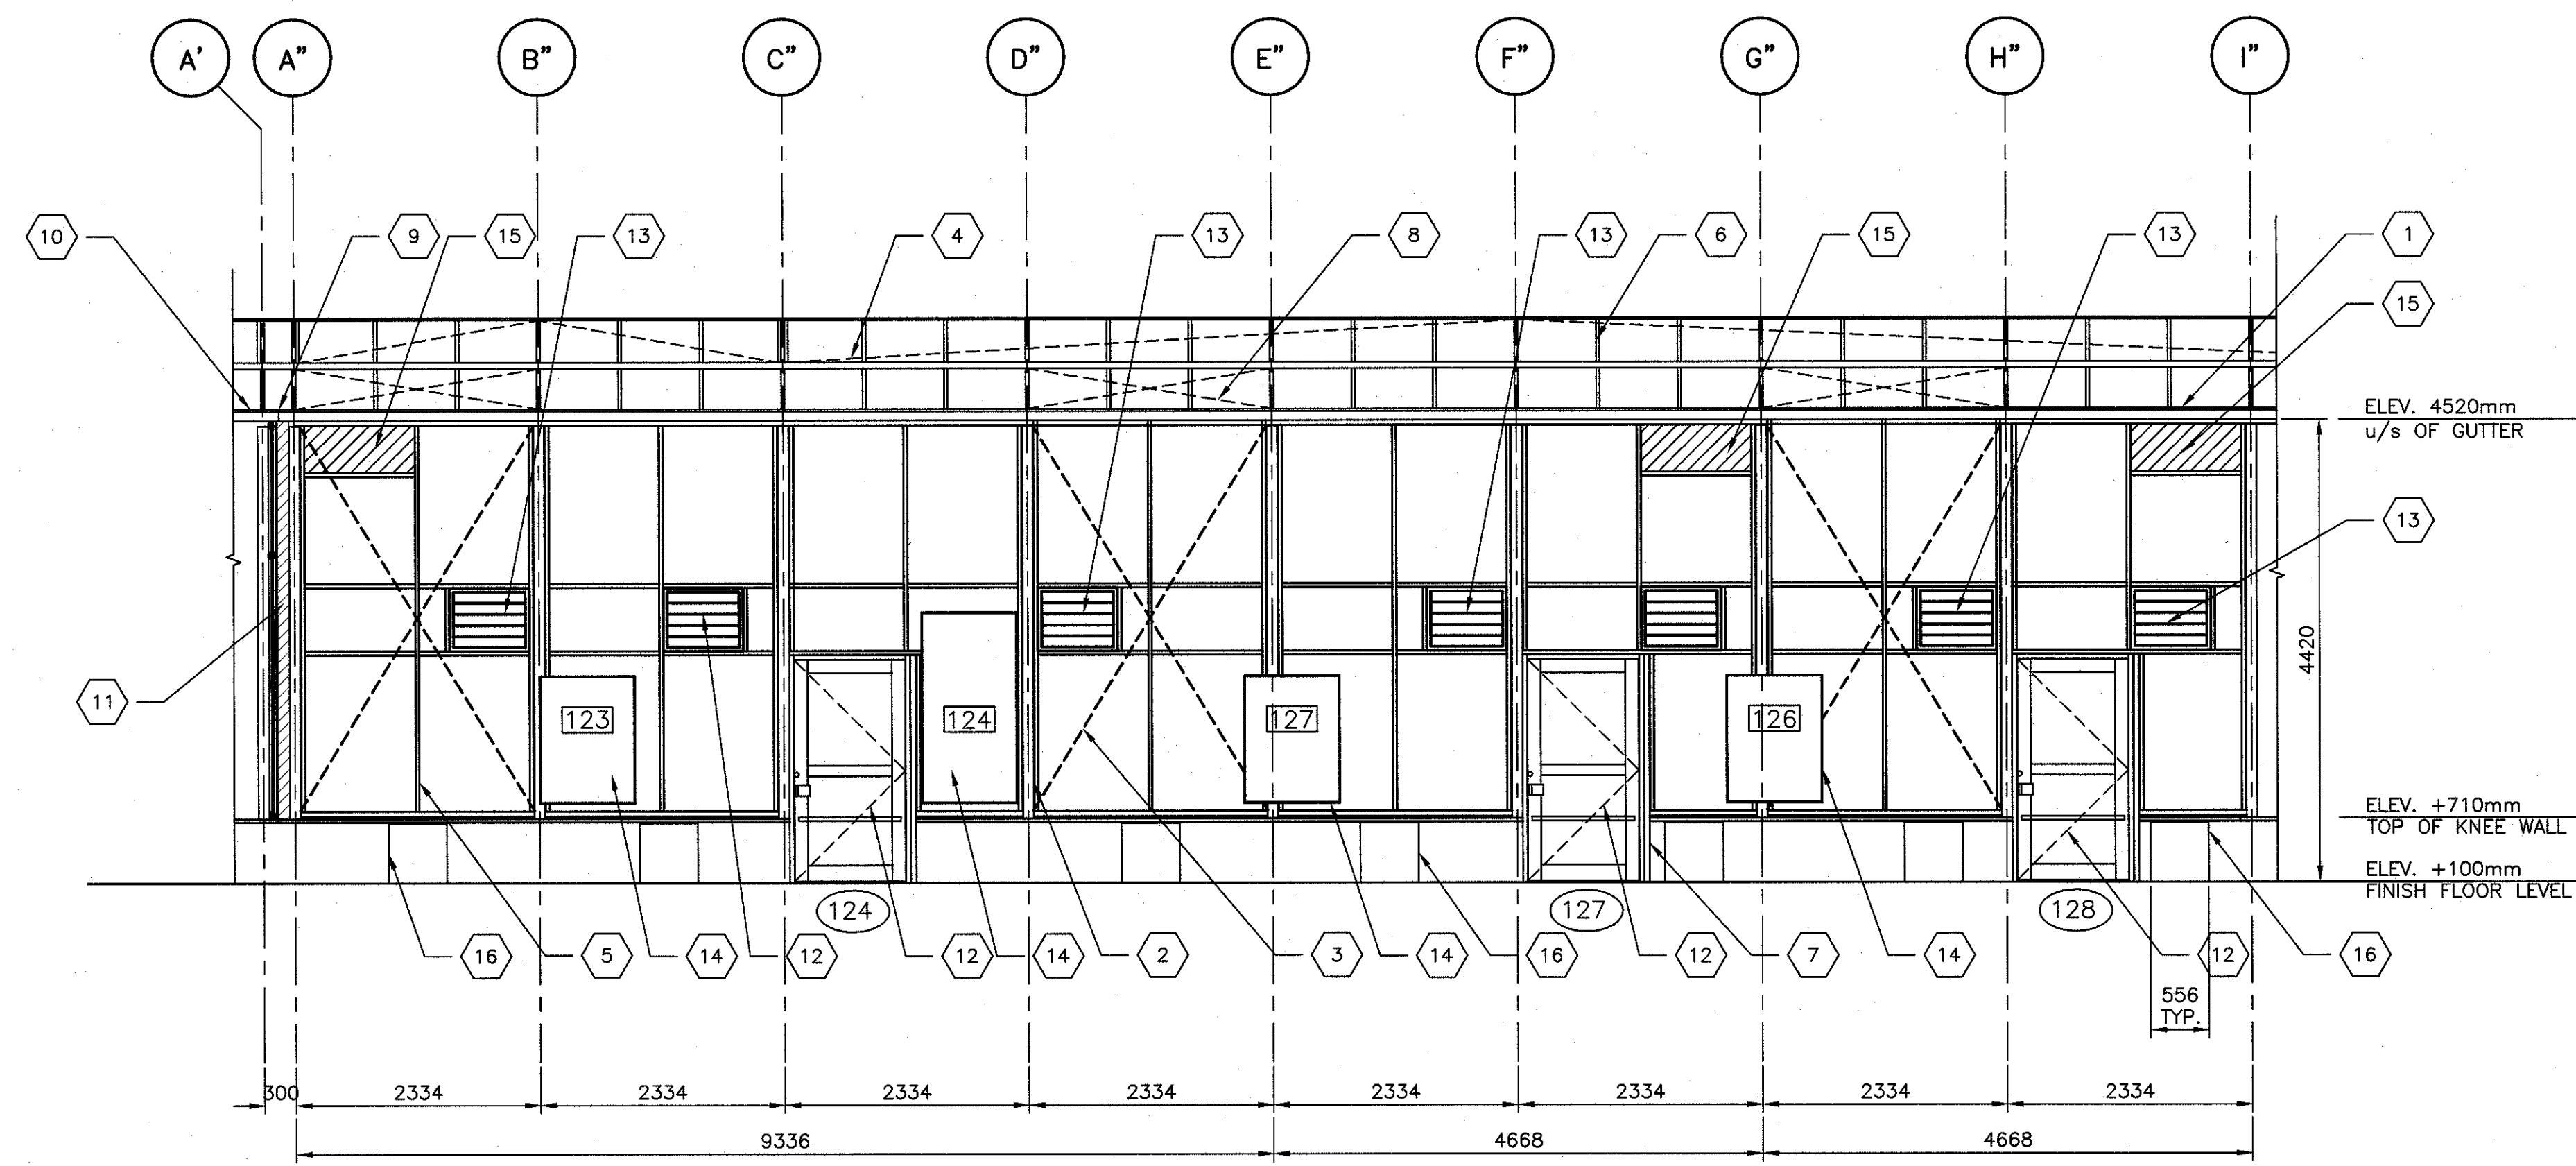

**CORRIDOR - EAST ELEVATION**  
SCALE: 1:50  
0m 1m 2m 3m 4m 5m  
**1**  
**GH-05**

- KEYED NOTES:
- 1- ALUM. GUTTER
  - 2- 100X100mm GALVANIZED HSS POST (TYP.)
  - 3- THRD. ROD WALL BRACING MIN. 13mm DIA. (TYP.)
  - 4- 914mm DEEP ROOF VENT, w/ACCORDION INSECT SCREEN (TYP. FOR CORRIDOR)
  - 5- ALUM. GLAZING BARS w/4mm TEMP. GLASS FOR ALL INTERNAL WALLS.
  - 6- ALUM. GLAZING SYSTEM w/4mm MIN. LAMINATED TEMP GLASS, w/FOUR SIDES EDGE SUPPORTS
  - 7- 50X100mm GALVANIZED HSS DOOR POST (TYP.)
  - 8- THRD. ROD ROOF BRACING MIN. 13mm DIA. (TYP.)
  - 9- CUT EXISTING GUTTER AS REQUIRED TO SUIT, AND CONNECT TO THE NEW GUTTER
  - 10- EXISTING ALUM. GUTTER
  - 11- NEW ALUM. FLASHING AND EXPAND-O-FLASH BETWEEN THE EXISTING GREENHOUSE & THE NEW GREENHOUSE
  - 12- 1067mm X 2134mm ALUM. DOOR (TYP.)
  - 13- 762X810mm TRANSFER LOUVER
  - 14- CONTROL PANEL (TYP.)
  - 15- 1055X450mm ANODIZED ALUM. PANEL FOR M&E PENETRATIONS (TYP.)
  - 16- 511X556mm GALVANIZED AIR SUPPLY ELBOW CONNECTED TO 480X556mm VERTICAL DUCT FROM BASEMENT (TYP.)

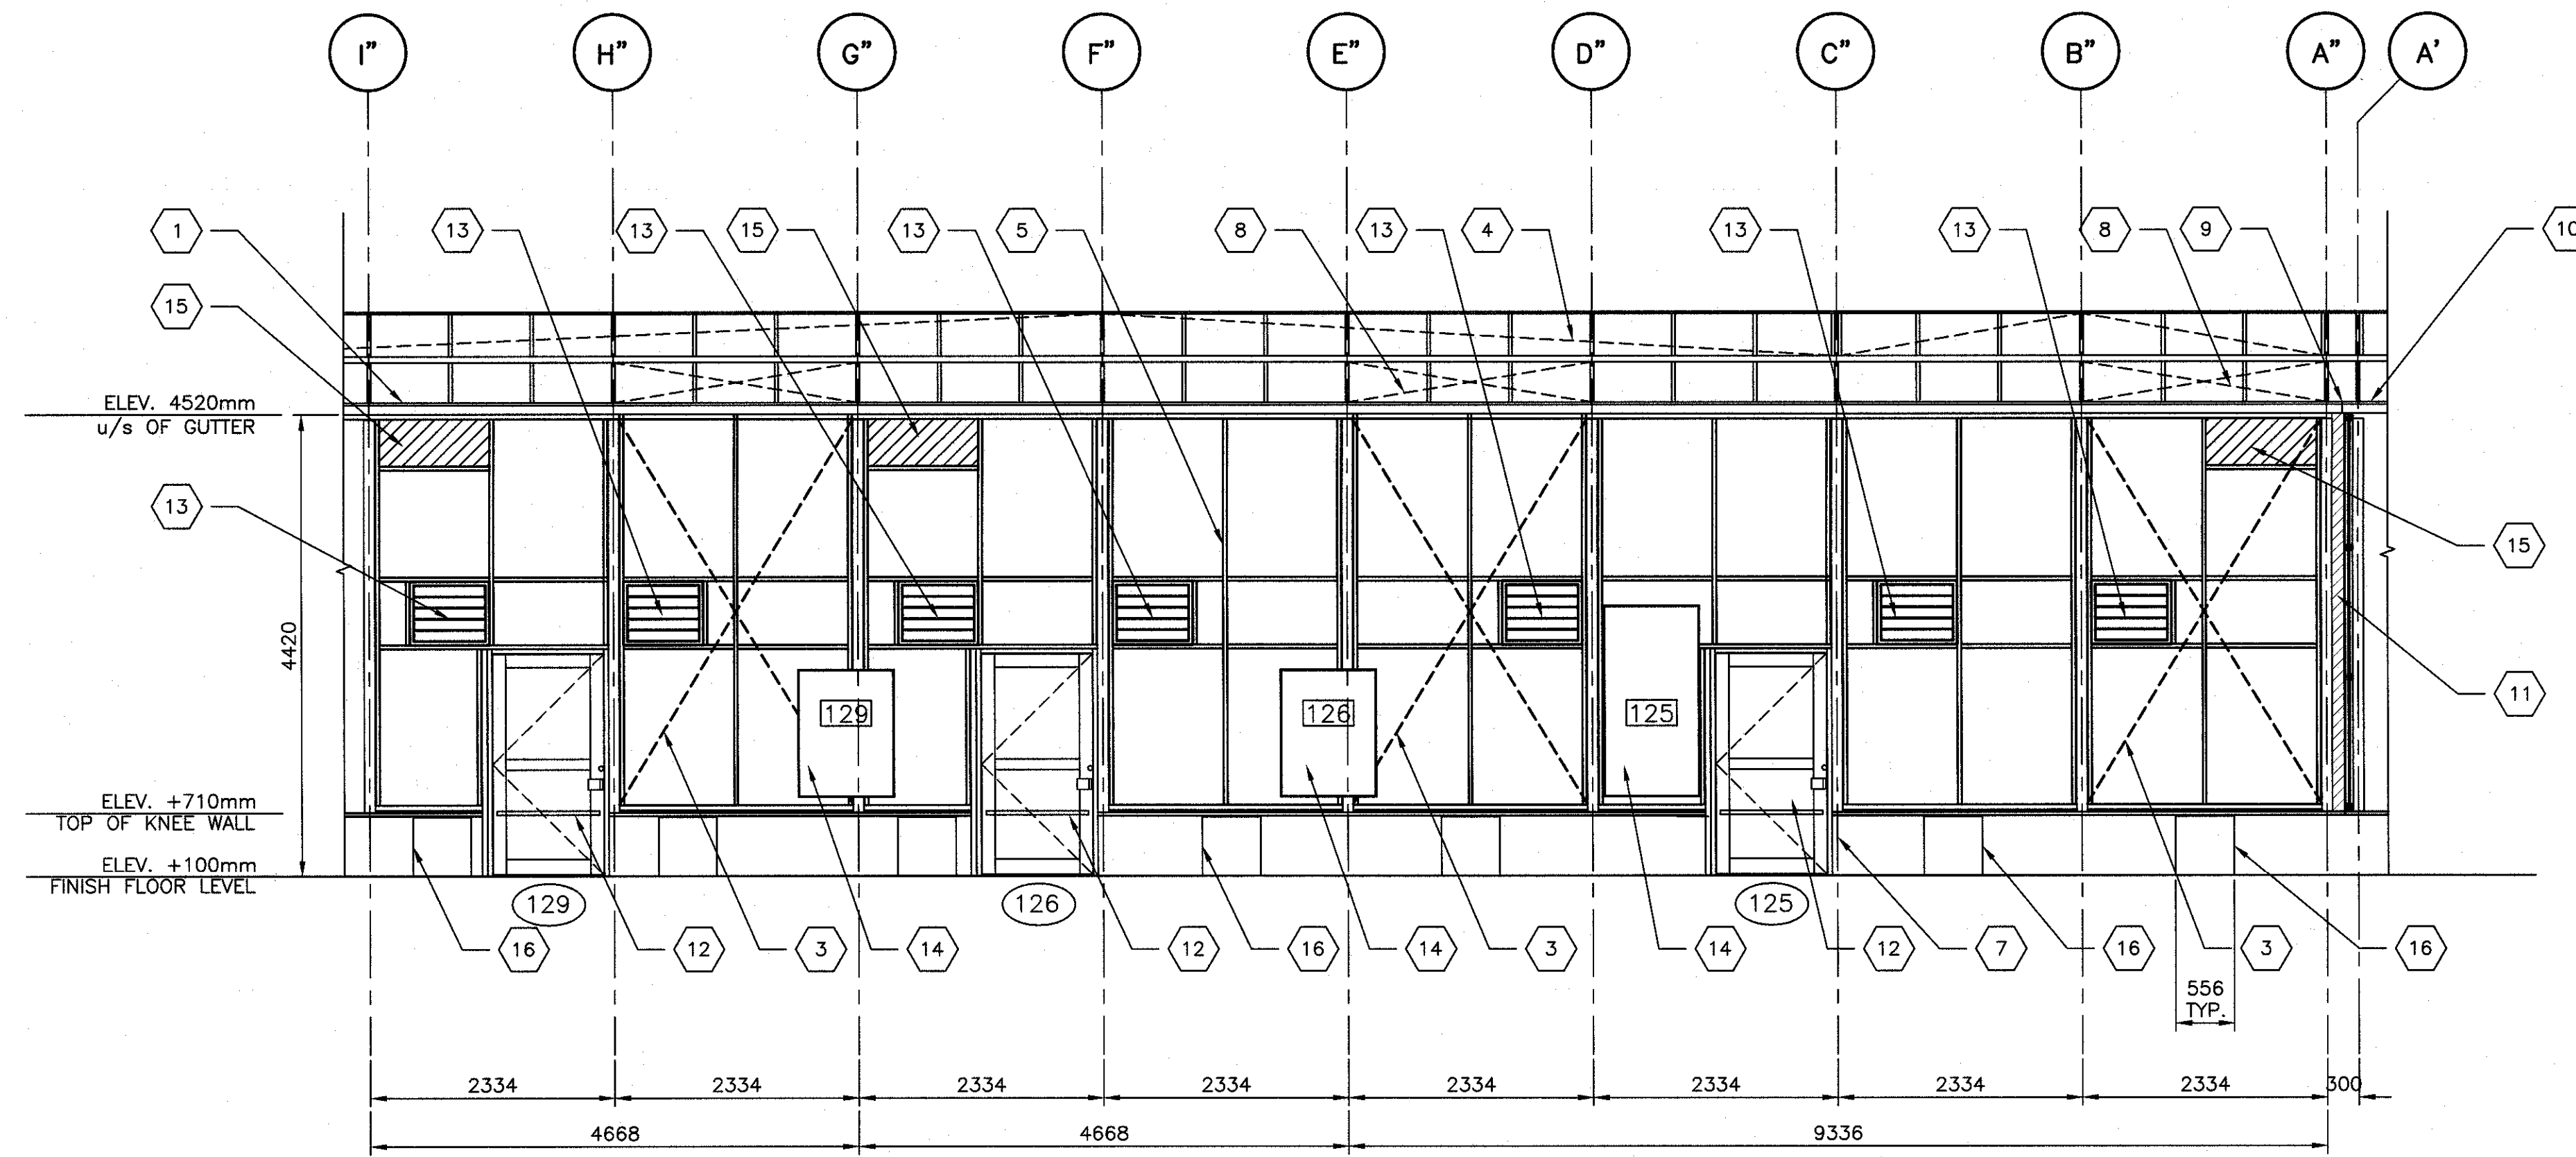

**CORRIDOR - WEST ELEVATION**  
SCALE: 1:50  
0m 1m 2m 3m 4m 5m  
**2**  
**GH-05**