


BASEMENT — EAST ELEVATION

SCALE: 1:50




1
GH-14

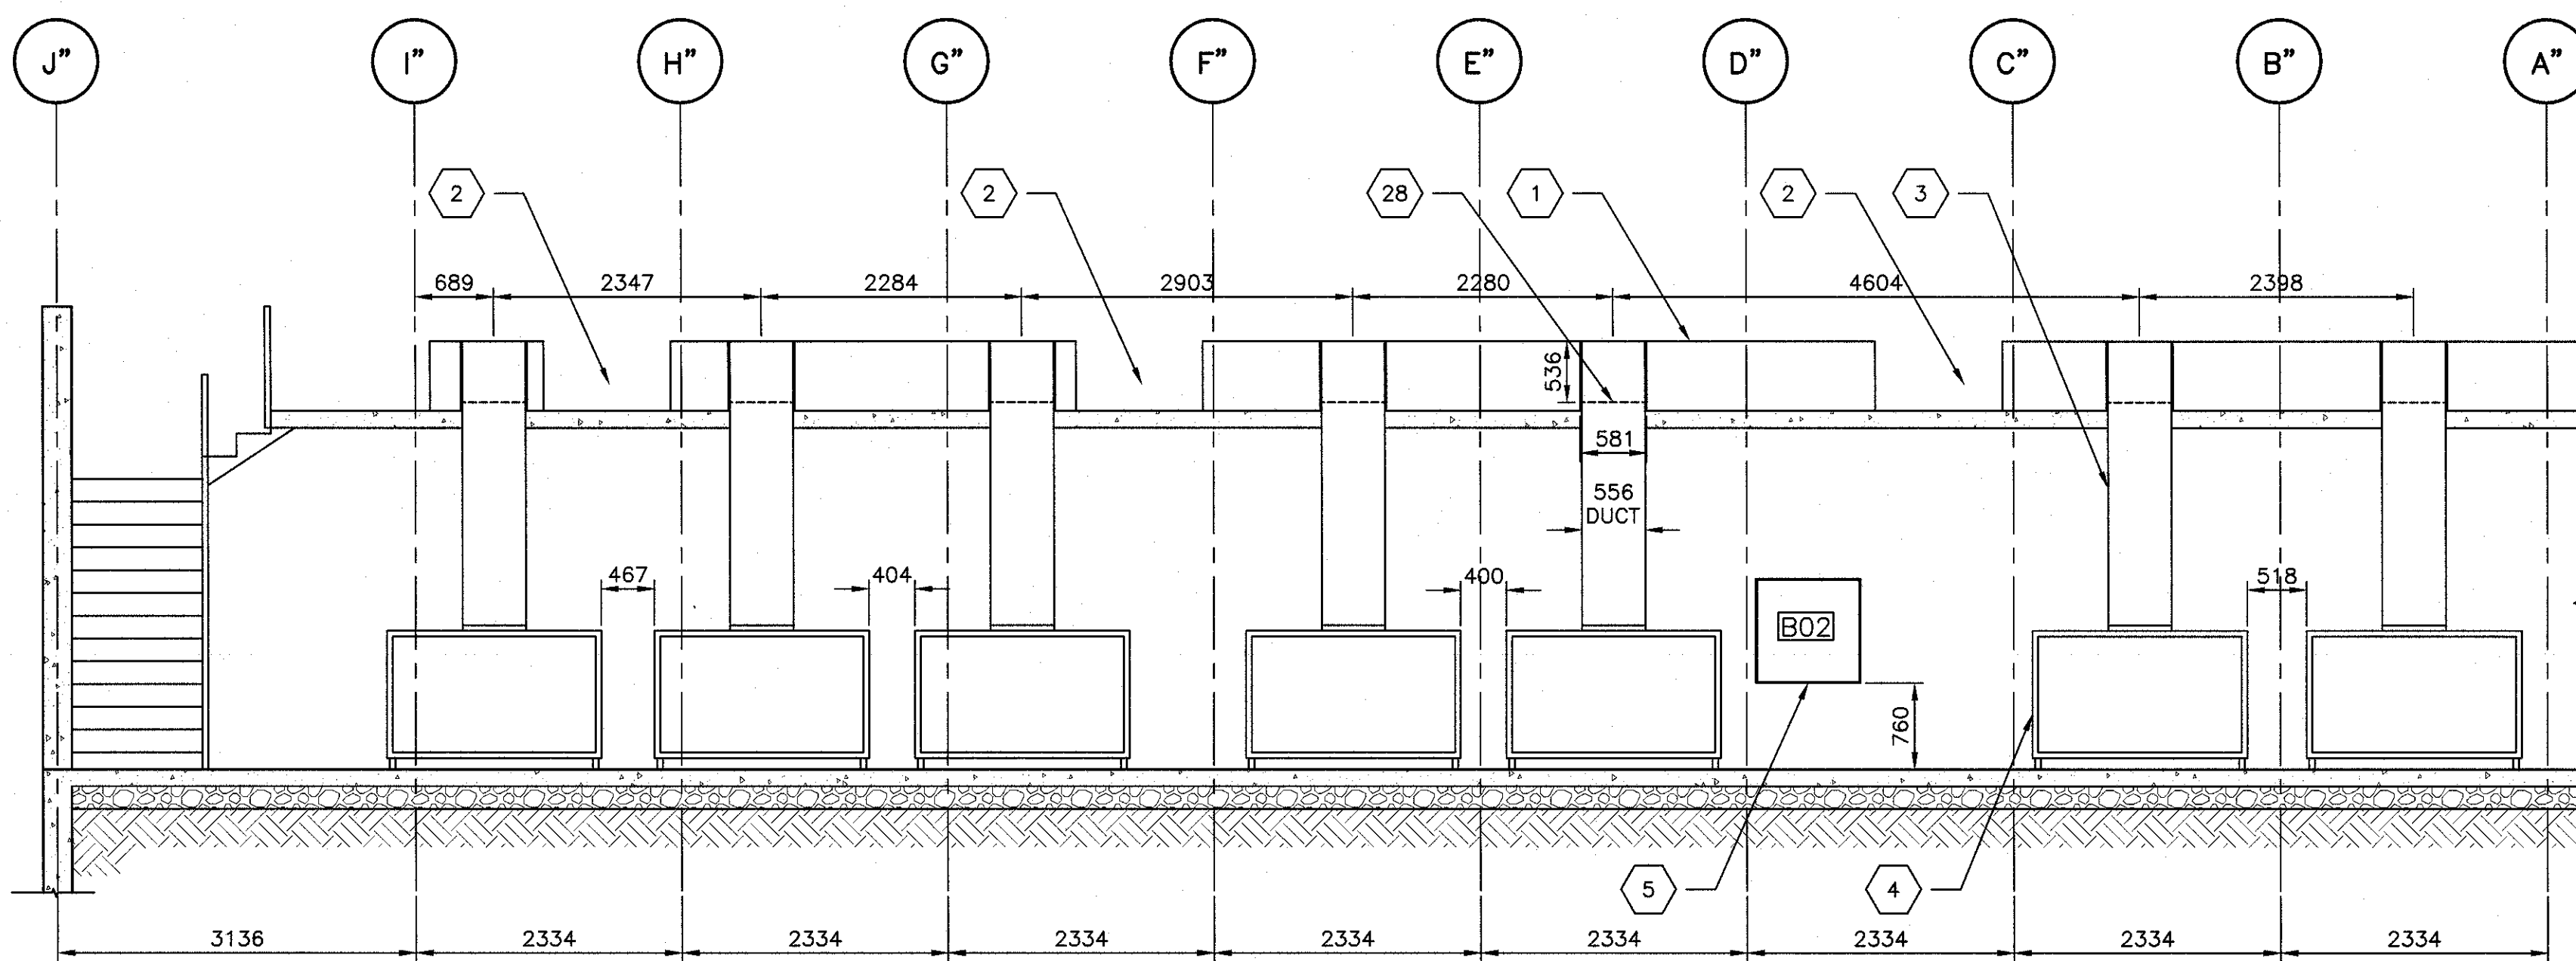


BASEMENT — WEST ELEVATION

SCALE: 1:50

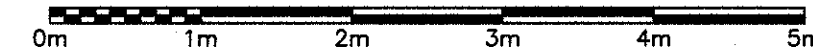


2
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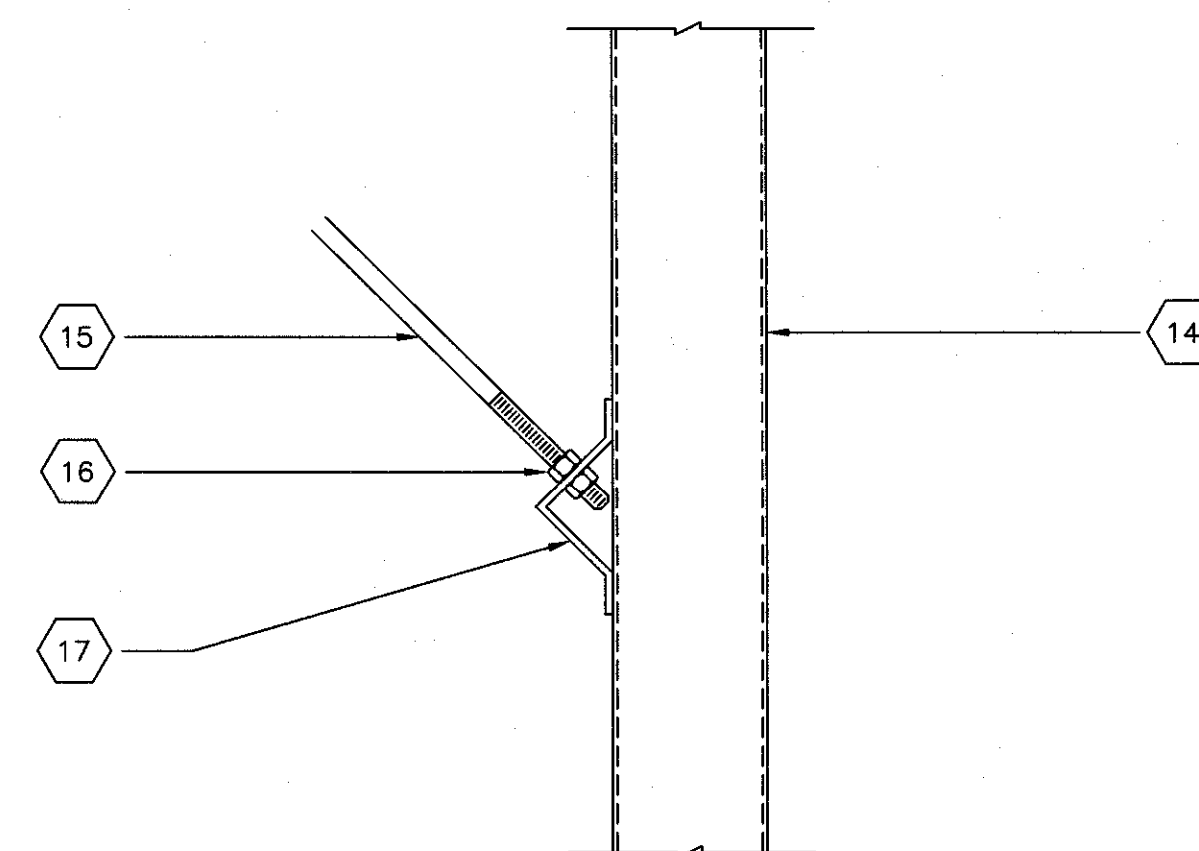


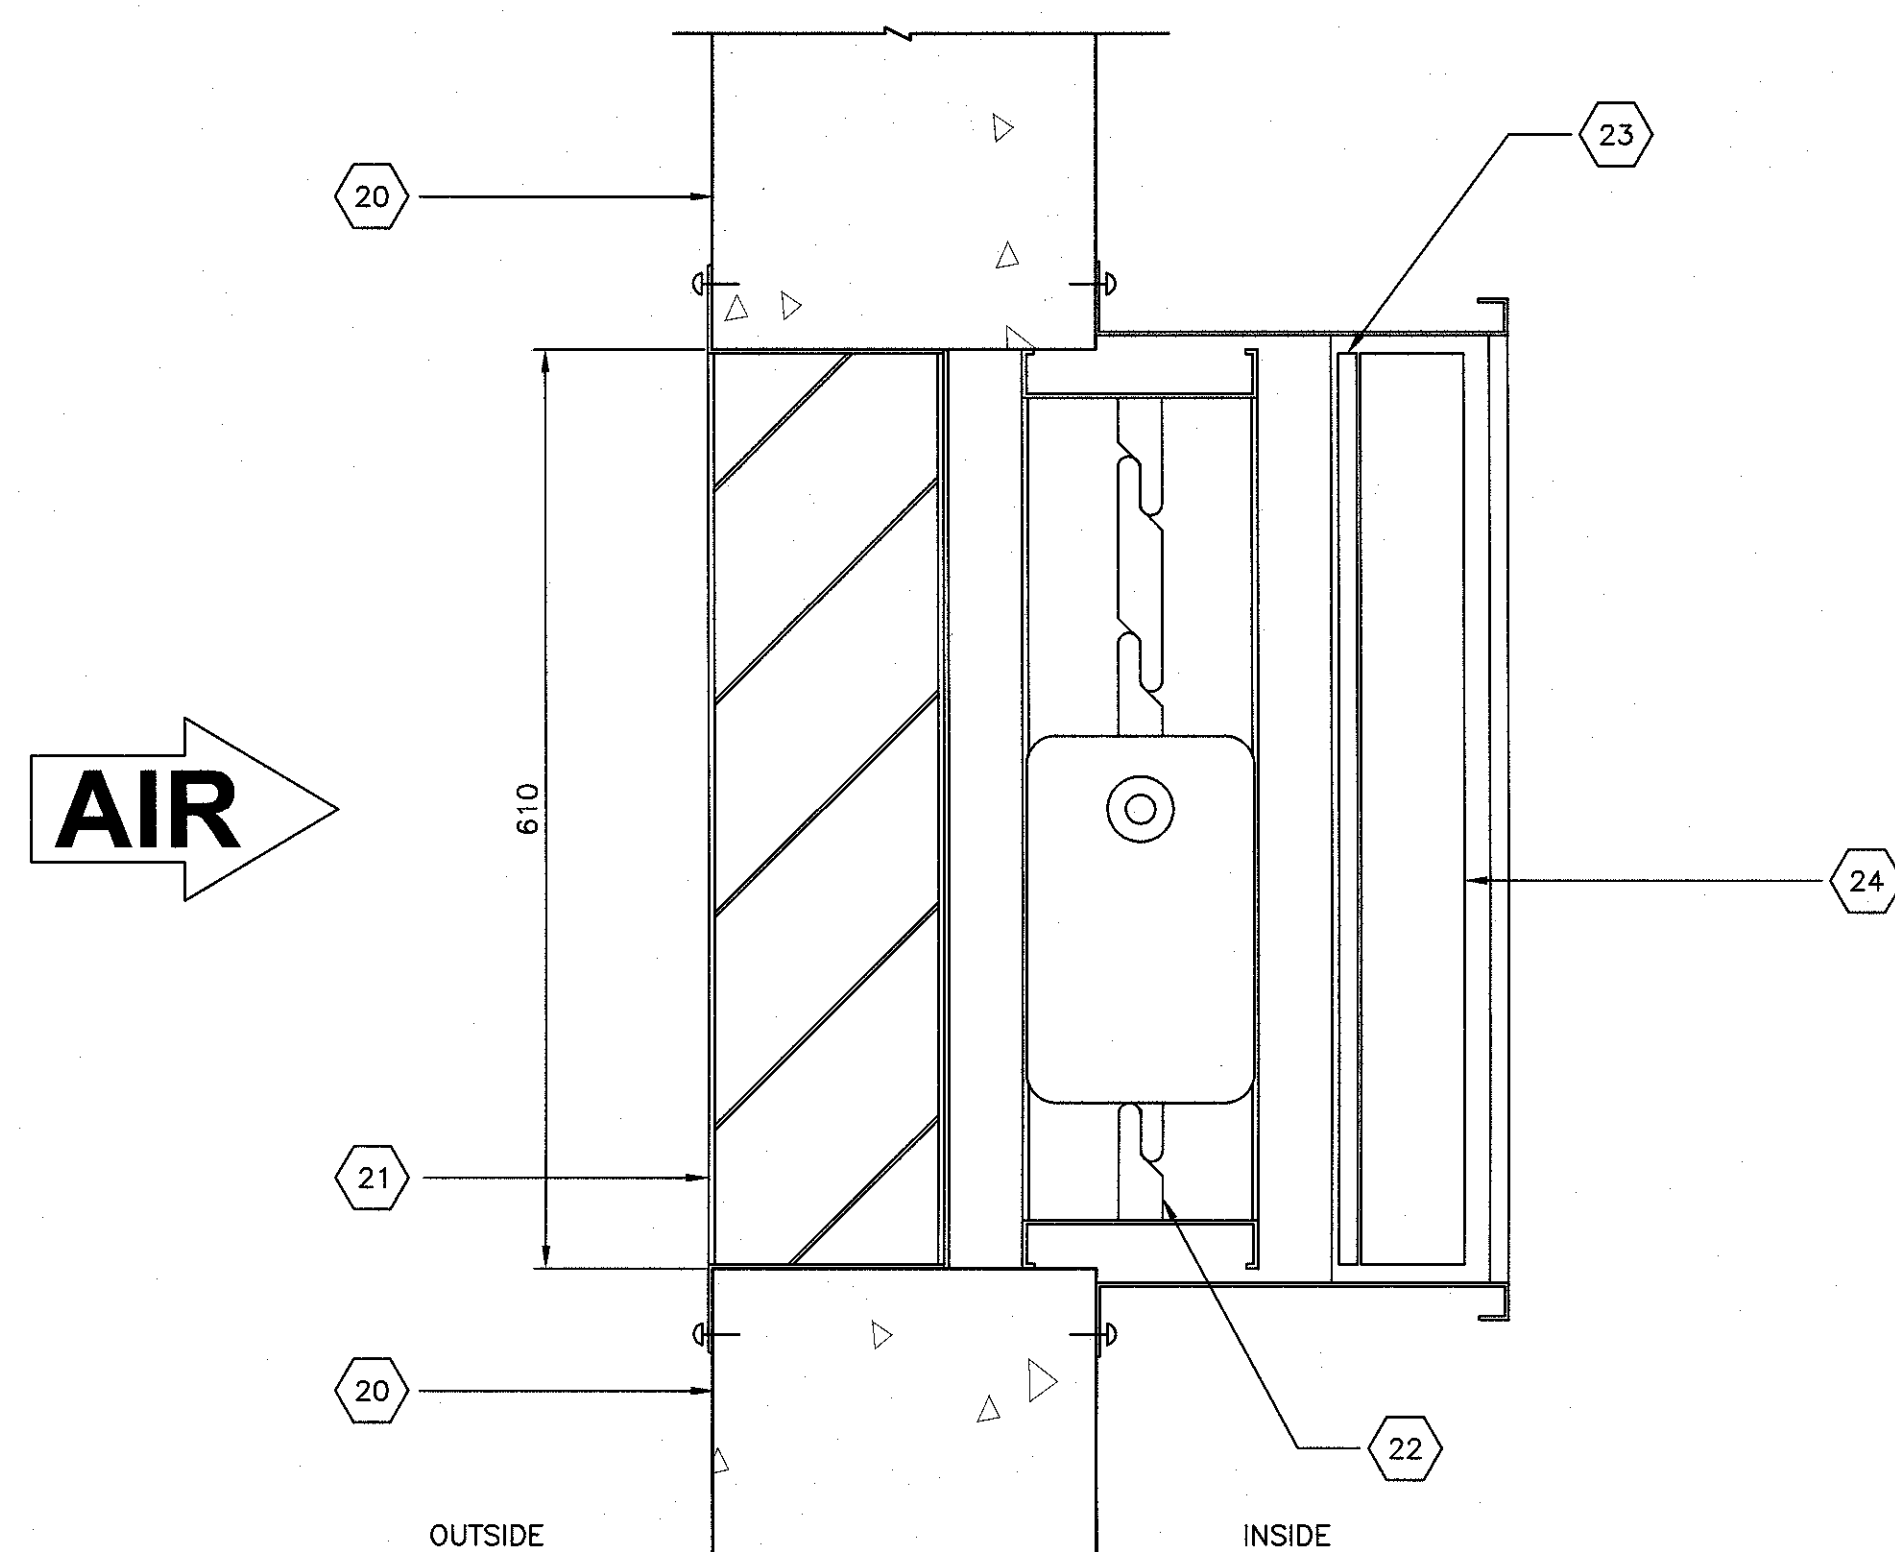AIR INLET MODULE

SCALE: 1:5

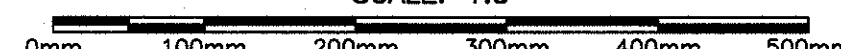

6
GH-14




TYP. WALL BRACING CONNECTION

SCALE: 1:5




7
GH-14

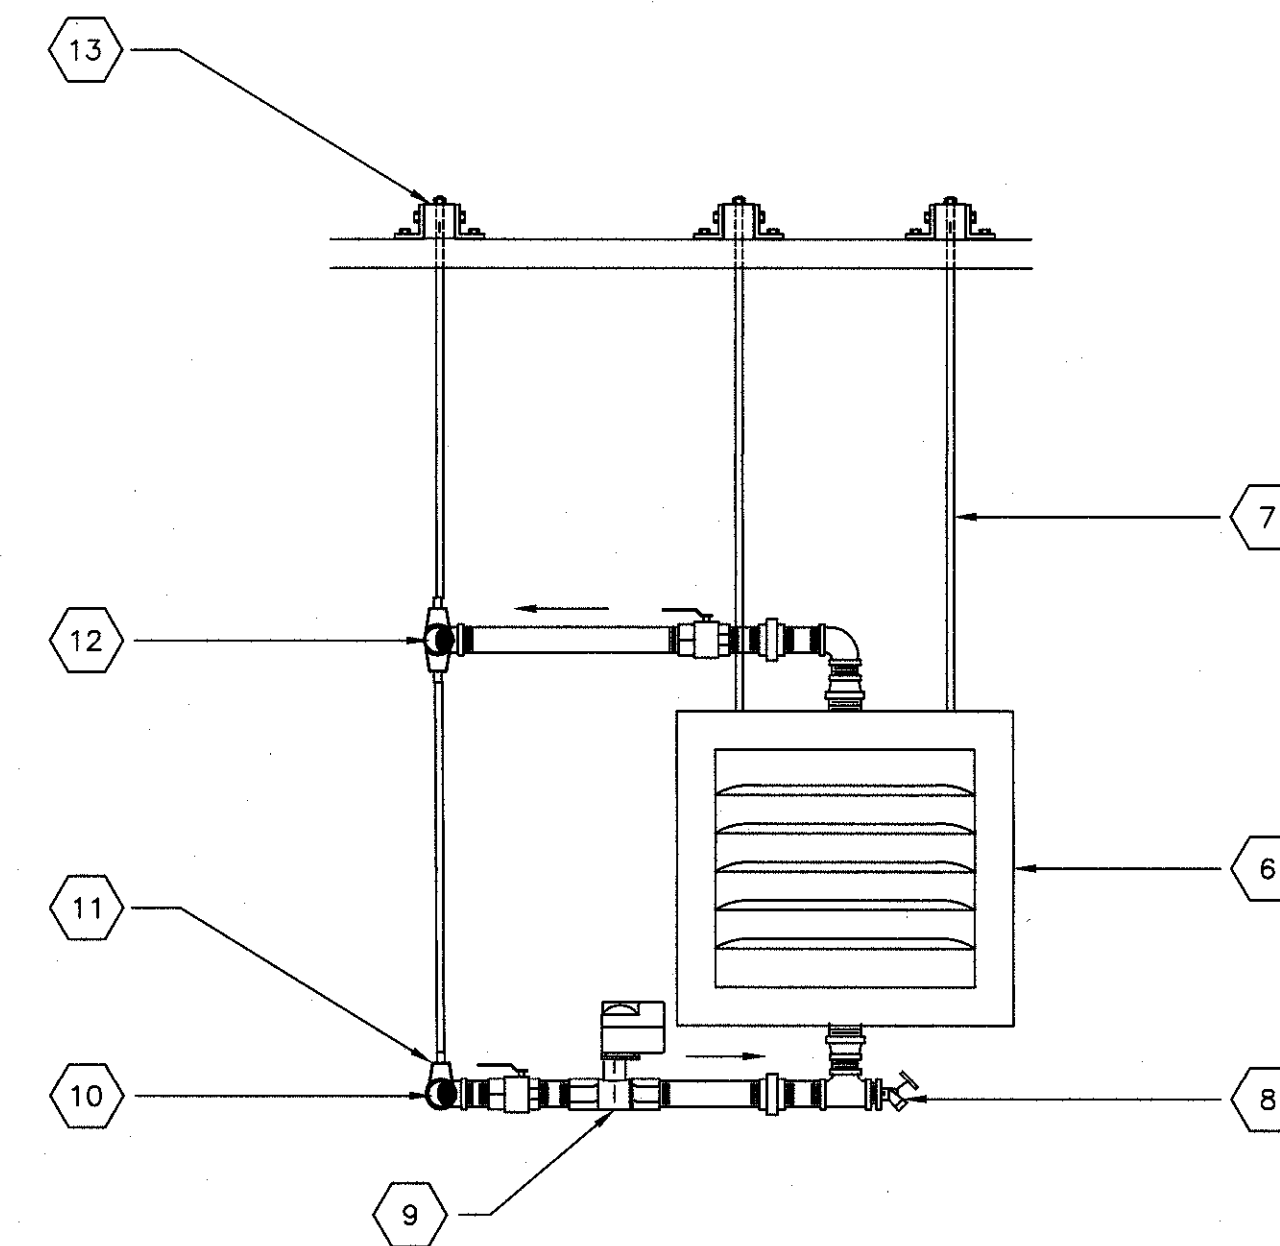


UNIT HEATER

SCALE: 1:10

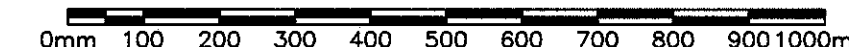


3
GH-14

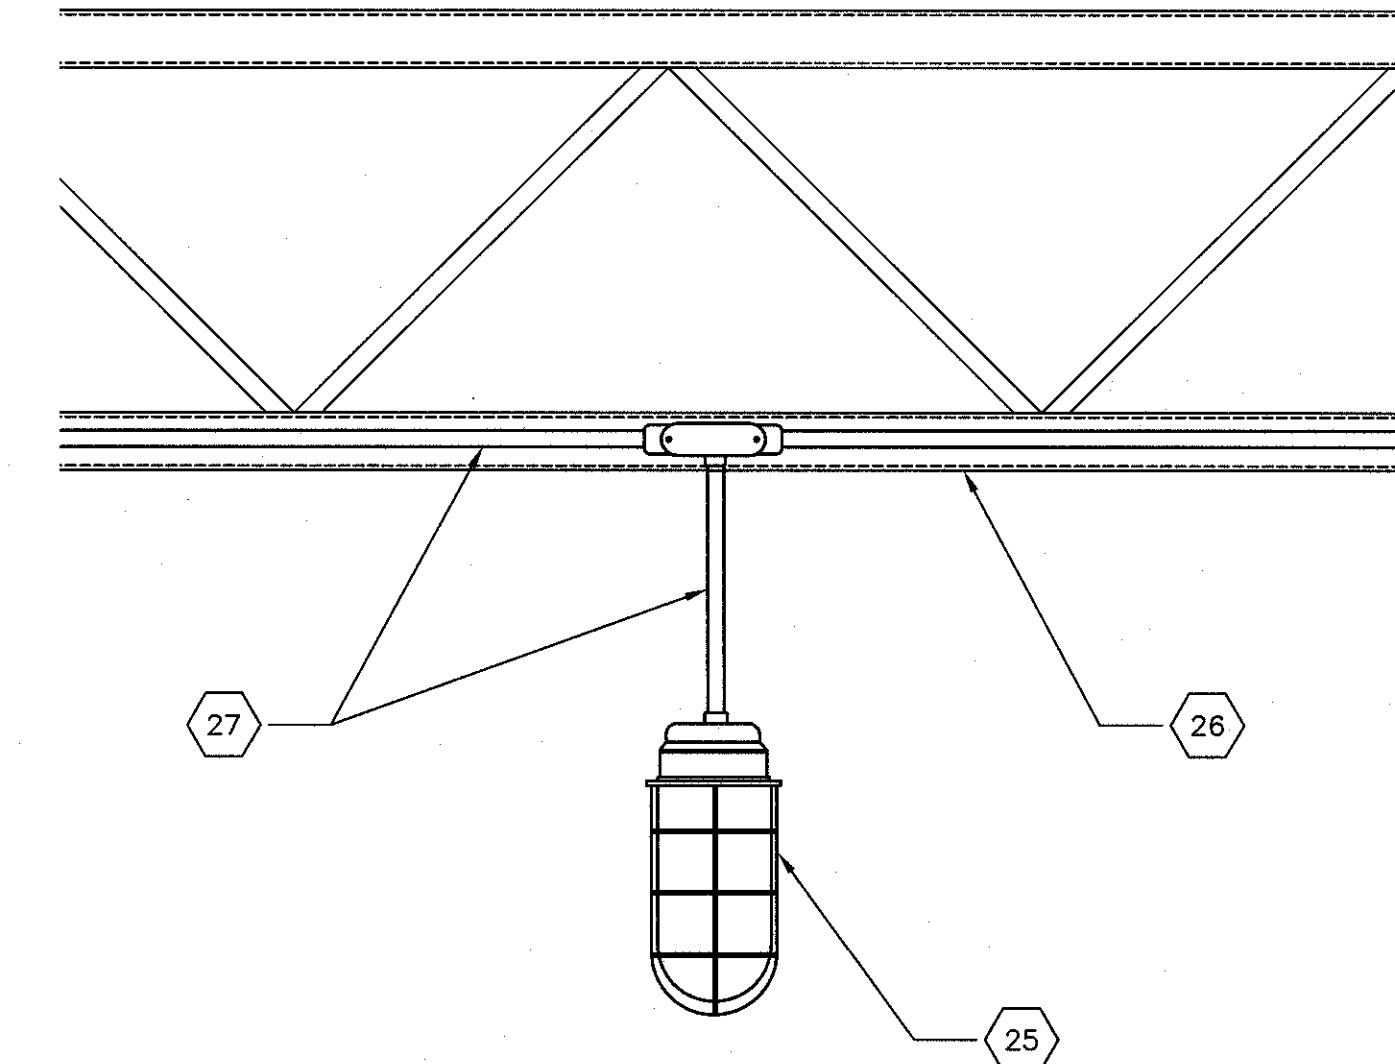


SERVICE LIGHT AT COMPARTMENT

SCALE: 1:5

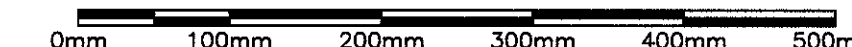

4
GH-14

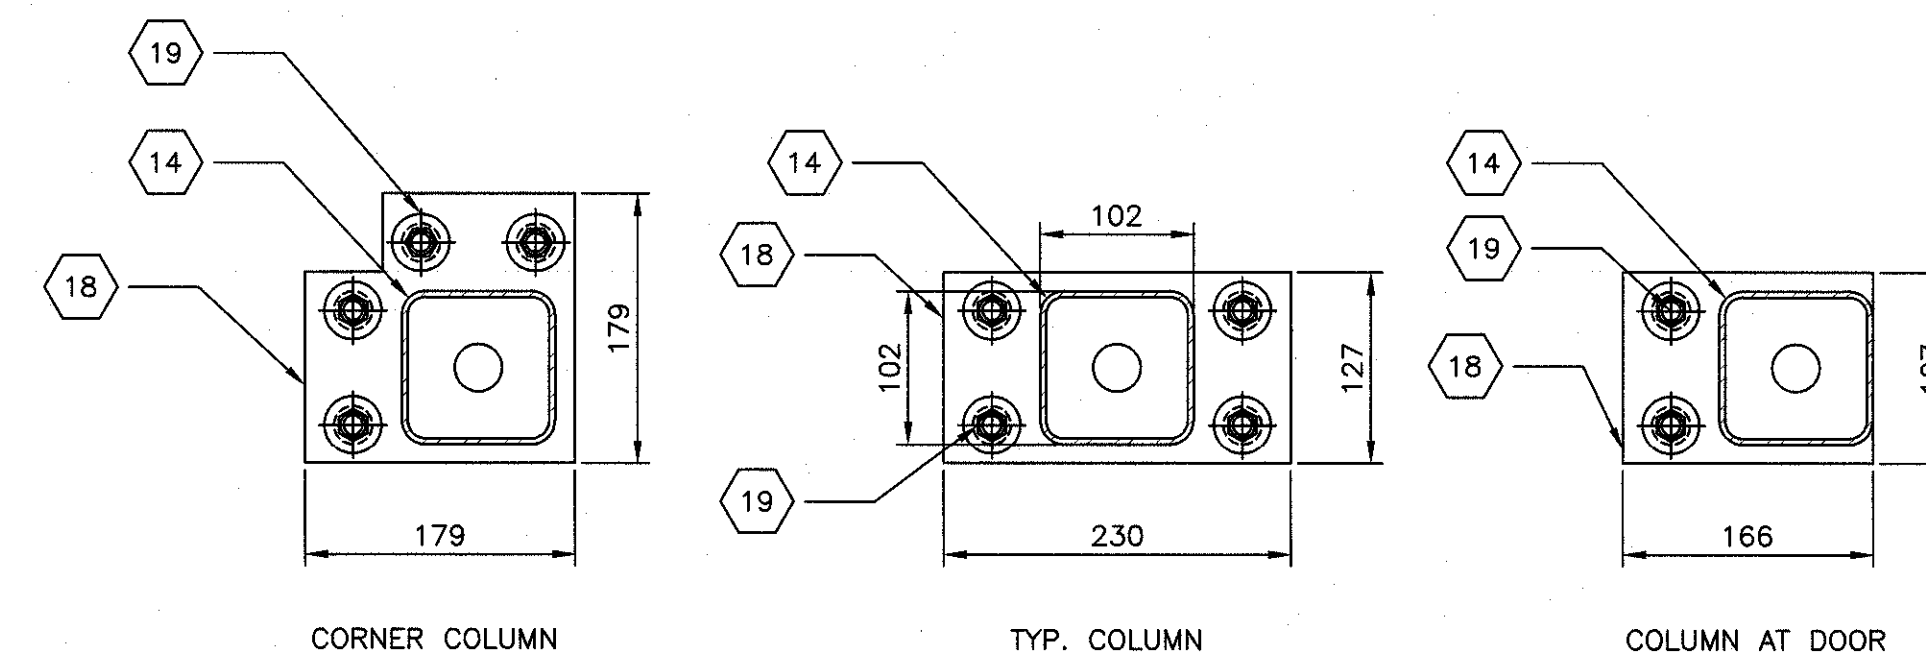

CORNER COLUMN


TYP. COLUMN

COLUMN AT DOOR

NOTE:
- ENSURE THAT KNEE WALLS REBARS DO NOT INTERFERE WITH THE ANCHOR BOLTS OF THE BASE PLATES

COLUMN BASE PLATE

SCALE: 1:5

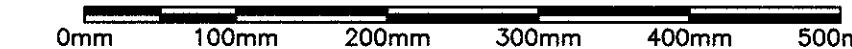

5
GH-14

KEYED NOTES:

- | | |
|---|---|
| 1- CONC. KNEE WALL (REFER TO STRUCTURAL DRAWINGS) | 15- THRD. ROD WALL BRACING MIN. 13mm DIA. (TYP.) |
| 2- DOOR LOCATION (TYP.) | 16- 13mm HEXAGONAL NUT |
| 3- 480X556mm GALVANIZED AIR SUPPLY DUCT | 17- 5mm THK. BRACING BRACKET PRE-WELDED TO HSS POST |
| 4- EVAPORATIVE COOLER | 18- BASE PLATE |
| 5- CONTROL PANEL | 19- ANCHOR BOLT (TYP.) |
| 6- UNIT HEATER | 20- FOUNDATION WALL |
| 7- Ø9.5mm THREADED ROD | 21- FLUSH-MOUNT INTAKE STYLE ALUM. WEATHER LOUVRE WITH INTEGRAL BIRDSCREEN |
| 8- SEDIMENT FAUCET | 22- AIRFOIL CONTROL DAMPER (PARALLEL BLADE) c/w 24V FLOATING-POINT ACTUATOR |
| 9- BELIMO CHARACTERIZED CONTROL VALVE | 23- PRE-FILTER WITH ALUM. FRAME & STAINLESS STEEL MESH |
| 10- Ø25mm SUPPLY PIPE | 24- THIRP FILTER WITH ALUM. FRAME AND LS ECONET SCREEN |
| 11- SWIVEL PIPE HANGER | 25- SERVICE LIGHT |
| 12- Ø25mm RETURN PIPE | 26- GREENHOUSE TRUSS |
| 13- 38 X 38mm GALVANIZED HSS | 27- ELECTRICAL CONDUIT - REFER TO SPECIFICATIONS |
| 14- 100X100mm GALVANIZED HSS POST | 28- 581X 536mm OPENING IN CONCRETE KNEE WALL FOR DUCT PENETRATION |

2	ISSUED FOR TENDER	9-10-15
1	ISSUED FOR 66% SUBMISSION	15-9-15
revisions		date
project	Aafc GREENHOUSE EXPANSION HARRINGTON RESEARCH FARM HARRINGTON, PEI	
designed	AT	compu
drawn	AE	dessiné
date	JULY 21, 2015	
approved	<i>Alexander Turkewitsch</i>	approuvé
date	22 Dec 2015	
Tender	Submission	
PMSC Project Manager	Administrateur de projets TPSC	
project number	R.072545.001	
drawing no.	GH-14	