


1 REFLECTED CEILING PLAN – LEVEL SIX

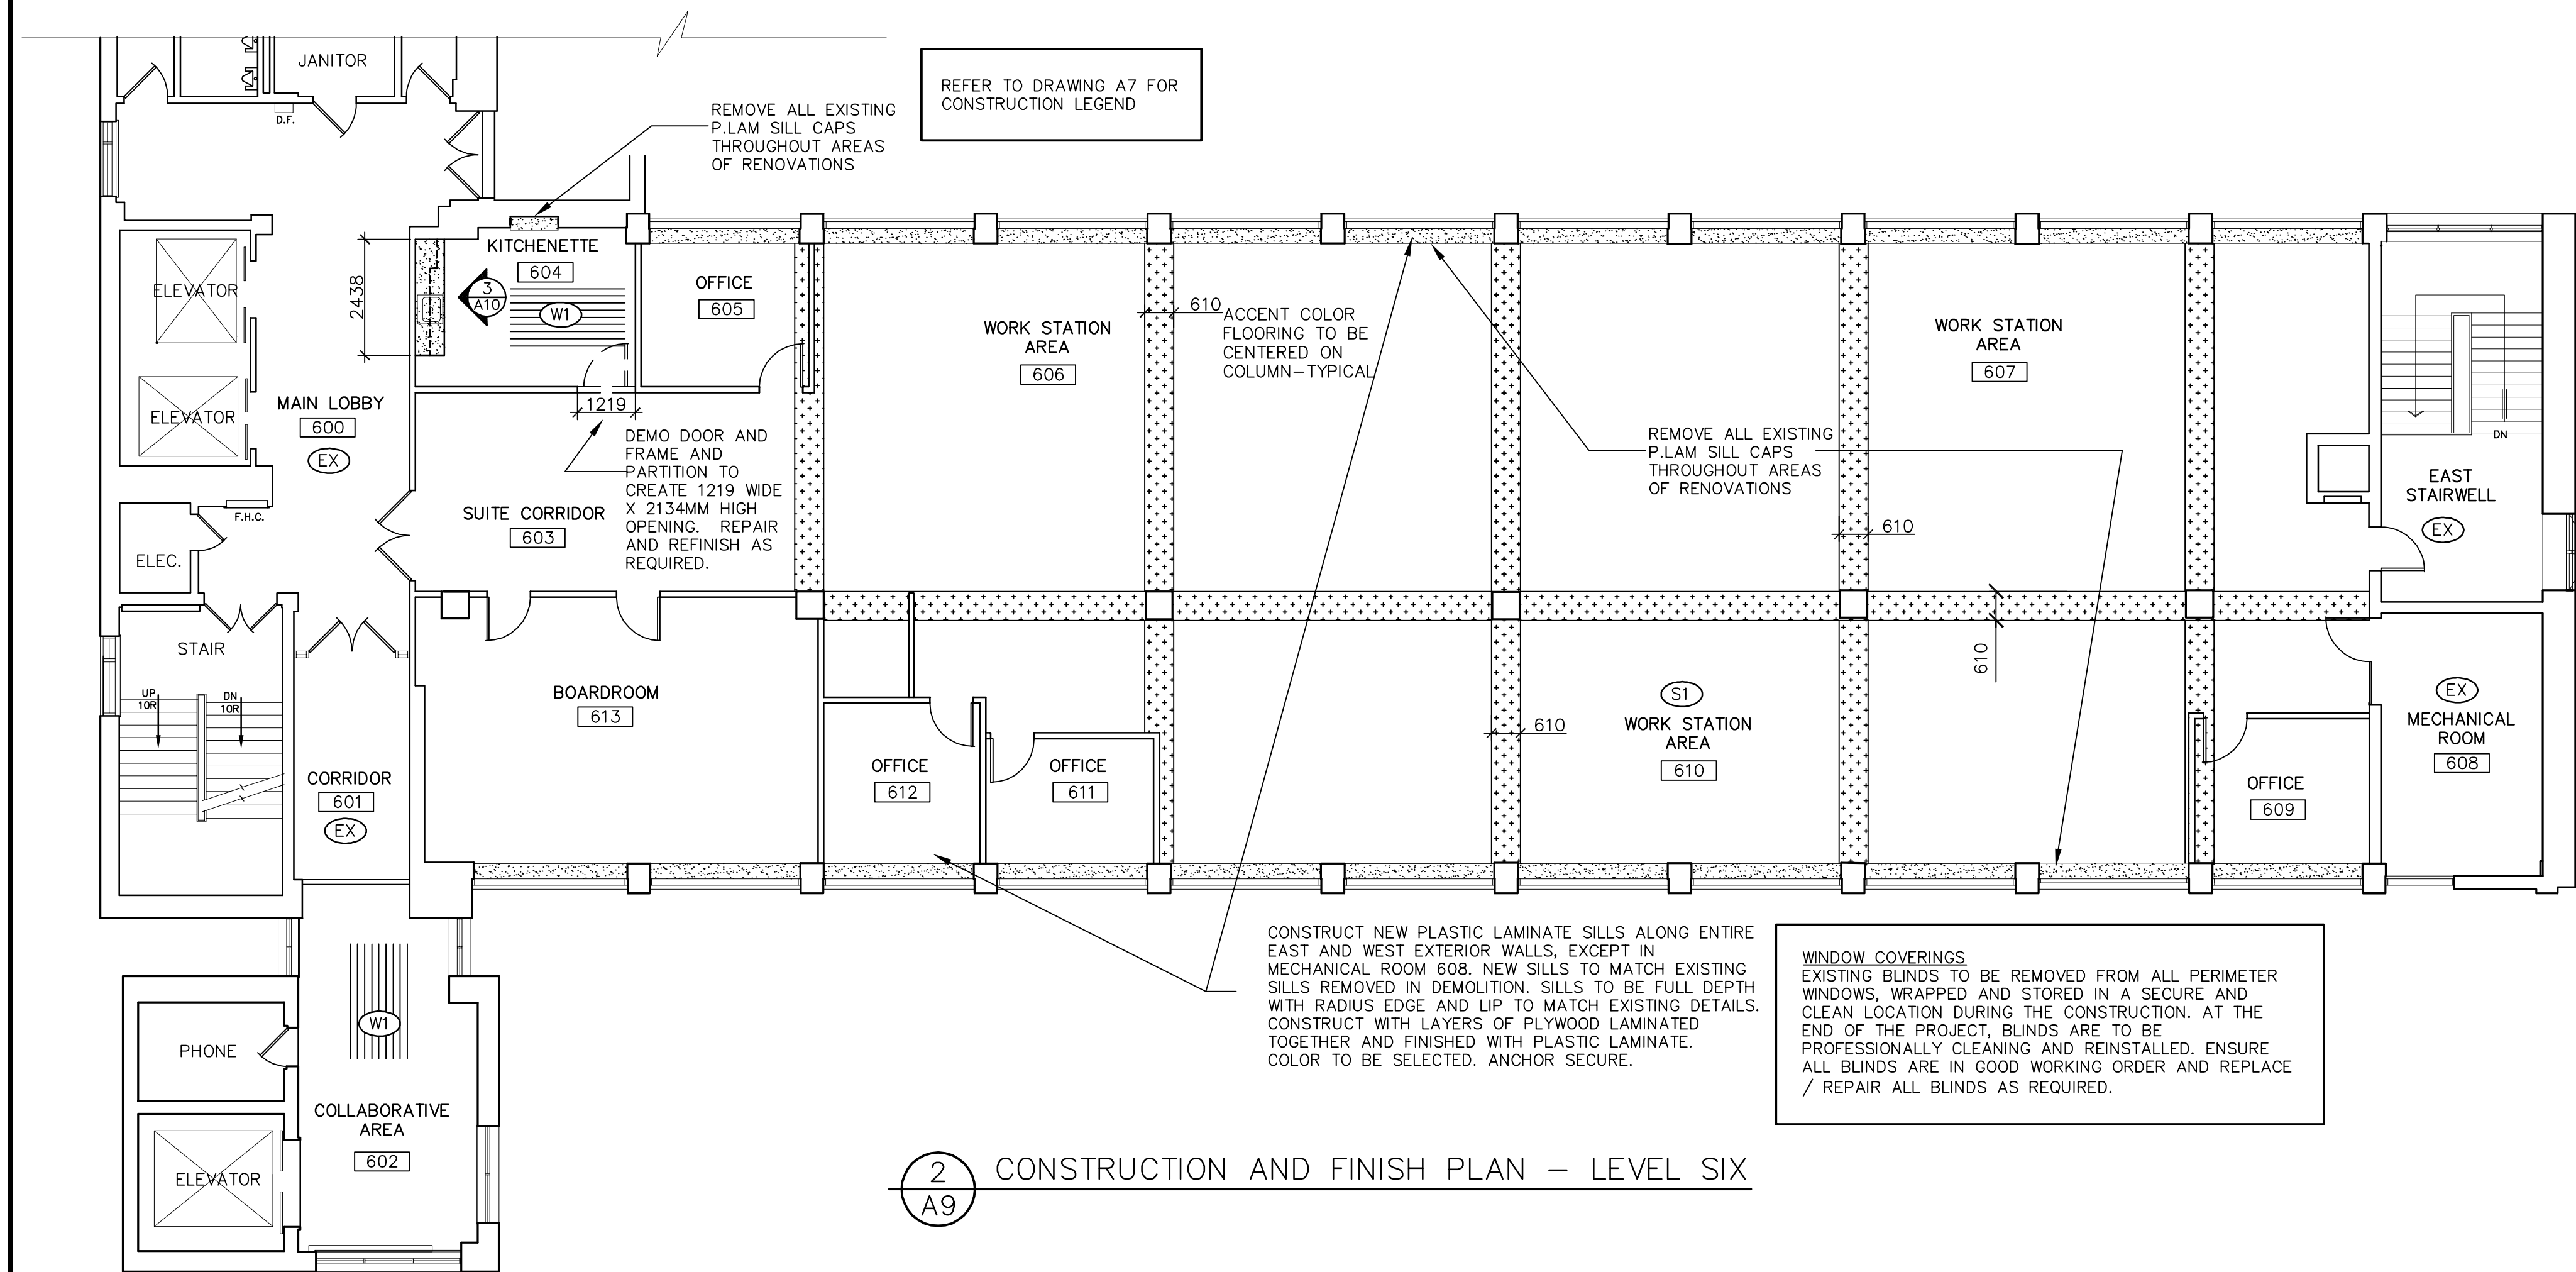

2 CONSTRUCTION AND FINISH PLAN – LEVEL SIX

REFLECTED CEILING LEGEND

INDICATES EXISTING T-BAR SYSTEM
 CLEAN ALL T-BAR AND REPAIR ALL VISIBLE DAMAGE, INCLUDING DAMAGE FROM DEMOLITION OF PARTITIONS. REPLACE ALL DAMAGED OR PUNCTURED OR MISSING T-BAR SPINES TO MATCH EXISTING.
 REMOVE ALL EXISTING CEILING TILE AND REPLACE WITH NEW AS SPECIFIED IN SPECIFICATIONS
 *CONTRACTOR IS RESPONSIBLE TO REVIEW TILE AND CONFIRM TILE IS COMPATIBLE WITH EXISTING GRID

INDICATES APPROXIMATE AREAS TO PROVIDE AND INSTALL NEW T-BAR CEILING, HEIGHT TO MATCH EXISTING. REMOVE SUFFICIENT GRID TO TIE IN NEW GRID AT MAIN SUPPORTS. REPLACE IN FULL SECTIONS. PROVIDE ALL REQUIRED T-BAR GRID AND HANGERS. INSTALL NEW ACOUSTIC CEILING TILE TO MATCH NEW TILE NOTED ABOVE. PROVIDE ALL REQUIRED SUPPORT FOR NEW AND EXISTING CEILING AS REQUIRED.

NOTES:

1. REPAIR AND ADJUST EXISTING SUSPENDED T-BAR CEILING AS REQUIRED TO SUIT PARTITION LAYOUT.
2. THE CONTRACTOR IS RESPONSIBLE TO CUT CEILING TILE TO FIT NEW SYSTEMS FURNITURE POLE POWERS / TOP FEEDS AFTER FURNITURE INSTALLATION AND ELECTRICAL CONNECTIONS ARE COMPLETE.
3. THESE DRAWINGS TO BE READ IN CONJUNCTION WITH MECHANICAL AND ELECTRICAL DRAWINGS FOR ALL INFORMATION CONCERNING LIGHTING, ELECTRICAL, HVAC AND SPRINKLERS.

(S1) INDICATES NEW FLOORING TYPE

(EX) EX INDICATES EXISTING FLOORING TO REMAIN

FINISHES NOTES

FLOORING
 REMOVE ALL EXISTING FLOOR AND WALL BASE THROUGHOUT AREAS OF RENOVATIONS UNLESS NOTED OTHERWISE. REPAIR ALL DAMAGE TO FLOOR SLAB AND WALLS. SKIM FLOOR SMOOTH AND LEVEL AND PREP AS REQUIRED TO RECEIVE NEW PRODUCT AS PER SPECIFICATIONS. INSTALL NEW FLOORING AS PER PLAN.

W1 VINYL TILE – LUXURY VINYL TILE/PLANK AS PER SPECIFICATIONS


S1 SHEET LINOLEUM FLOORING AS PER SPECIFICATIONS

WALLS & BULKHEADS
 SKIM ALL DRYWALL SURFACES TO A SMOOTH FINISH. APPLY NEW FINISHES AS SPECIFIED.

DOORS & FRAMES
 ALL EXISTING AND NEW DOORS AND FRAMES THROUGHOUT AREA OF PROJECT ARE TO BE SANDED SMOOTH AND PREP FOR PAINT FINISH AS SPECIFIED

CONSTRUCT NEW PLASTIC LAMINATE SILLS ALONG ENTIRE EAST AND WEST EXTERIOR WALLS, EXCEPT IN MECHANICAL ROOM 608. NEW SILLS TO MATCH EXISTING SILLS REMOVED IN DEMOLITION. SILLS TO BE FULL DEPTH WITH RADIUS EDGE AND UP TO MATCH EXISTING DETAILS. CONSTRUCT WITH LAYERS OF PLYWOOD LAMINATED TOGETHER AND FINISHED WITH PLASTIC LAMINATE. COLOR TO BE SELECTED. ANCHOR SECURE.

WINDOW COVERINGS
 EXISTING BLINDS TO BE REMOVED FROM ALL PERIMETER WINDOWS, WRAPPED AND STORED IN A SECURE AND CLEAN LOCATION DURING THE CONSTRUCTION. AT THE END OF THE PROJECT, BLINDS ARE TO BE PROFESSIONALLY CLEANING AND REINSTALLED. ENSURE ALL BLINDS ARE IN GOOD WORKING ORDER AND REPLACE / REPAIR ALL BLINDS AS REQUIRED.

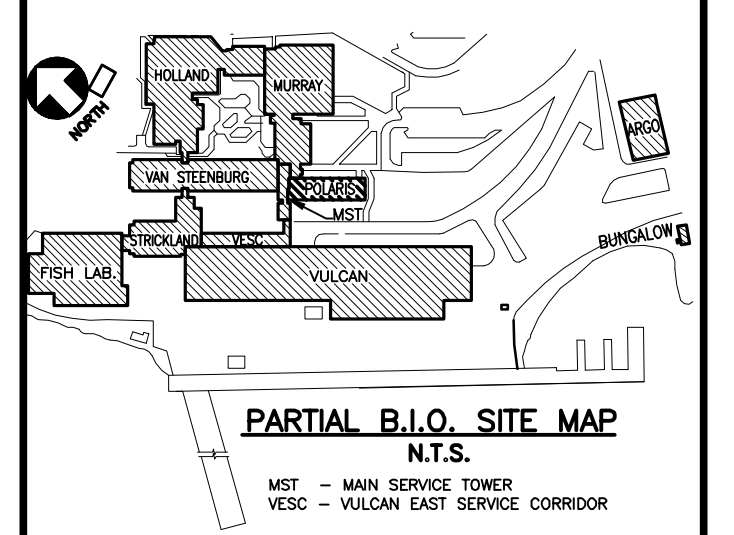

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revisions	date
00	UPDATED & ISSUED FOR TENDER 14JAN15
0	ISSUED FOR TENDER & CONSTRUCT 22DEC15
-	ISSUED FOR 99% REVIEW 04DEC15
-	ISSUED FOR 90% REVIEW 20NOV15

project

POLARIS BUILDING RENOVATIONS

BEDFORD INSTITUTE OCEANOGRAPHY
 DARTMOUTH – NS

drawing

LEVEL 6 REFLECTED CEILING PLAN AND FINISH PLAN

designed DH

date NOV 2015

drawn TRI

date NOV 2015

approved JEFF HILCHEY

date JAN 04, 2016

Tender JEFF HILCHEY

PWOSC Project Manager Administrateur de projets TPSC

project number

drawing no.

A-9

SCALE : 1:100
 0m 1m 2m 3m 4m 5m 6m 7m 8m 9m 10m