


1 H6 HEATING DEMOLITION PLAN – LEVEL TWO

SCALE : 1:100  
0m 1m 2m 3m 4m 5m 6m 7m 8m 9m 10m

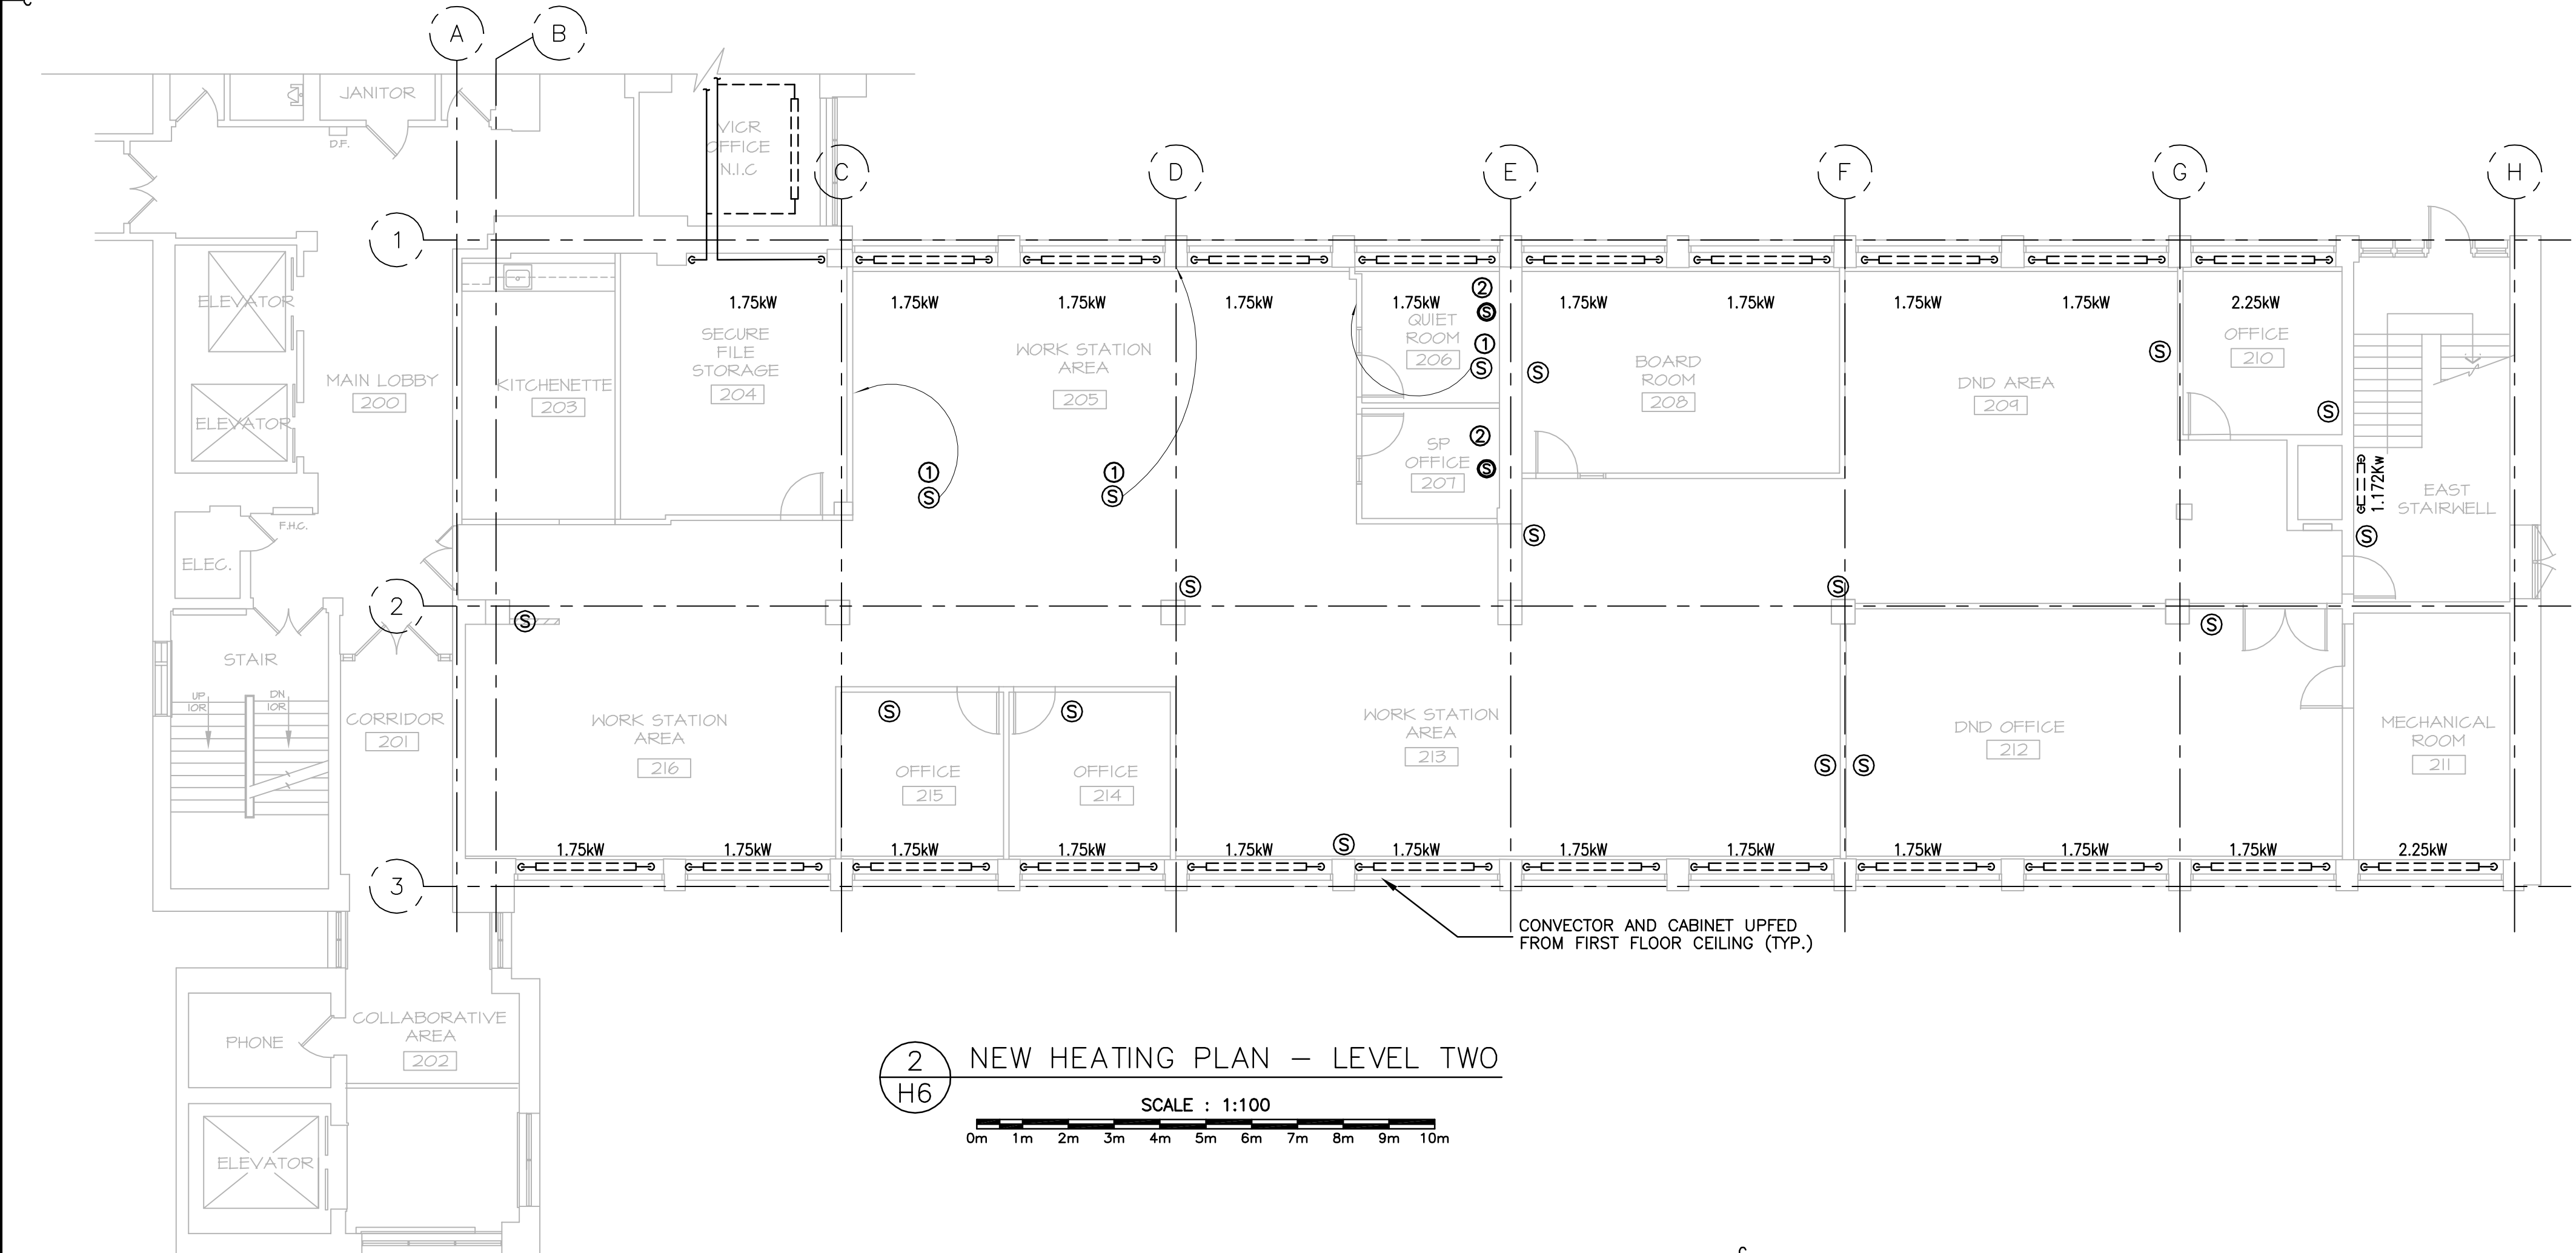

2 H6 NEW HEATING PLAN – LEVEL TWO

SCALE : 1:100  
0m 1m 2m 3m 4m 5m 6m 7m 8m 9m 10m

### GENERAL NOTES


- Ⓐ VERIFY EXISTING SITE CONDITIONS BEFORE COMMENCING WORK.
- Ⓑ COORDINATE WORK WITH OTHER SERVICES TO AVOID INTERRUPTION OR CHANGES TO PIPING AND/OR EQUIPMENT IN CEILING SPACE OUTSIDE SCOPE OF WORK.
- Ⓒ EXISTING SERVICES OUTSIDE SCOPE OF WORK ARE NOT SHOWN FOR CLARITY.
- Ⓓ THE CONTRACTOR AND ALL SUB-CONTRACTORS SHALL NOT SCALE DRAWINGS AND VERIFY ALL JOB SITE DIMENSIONS.

### HEATING NOTES

- ① RELOCATE EXISTING THERMOSTAT AS SHOWN.
- ② NEW THERMOSTAT TO CONTROL VAV BOX AND HEATING CONTROL VALVE, IF APPLICABLE.

### HEATING LEGEND

NEW	DESCRIPTION	EXISTING
	HEATING WATER SUPPLY	———
	HEATING WATER RETURN	----
	BALL VALVE	⌘
Ⓢ	DDC TEMPERATURE SENSOR	Ⓢ
	EXISTING PERIMETER RADIATION	=====
	PIPE DOWN	⌋
	PIPE UP	⌋
	PIPE BREAK	⌋

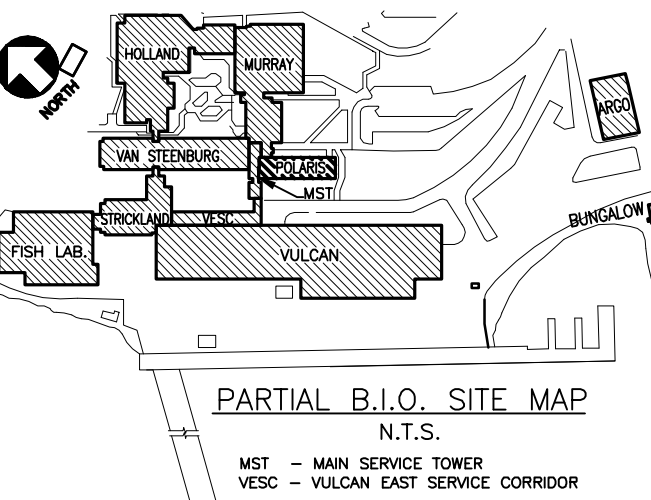

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B	ISSUED FOR TENDER	01/18 2016
A	ISSUED FOR 100% REVIEW	01/14 2016

revisions: date

project: project

POLARIS BUILDING  
FLOOR PLAN UPGRADES

BEDFORD INSTITUTE OCEANOGRAPHY  
DARTMOUTH – NS

drawing: dessin

LEVEL 2  
DEMO & NEW  
HEATING

designed BS conçu

date DEC 2015

drawn BS dessiné

date DEC 2015

approved MR approuvé

date JAN 2016

Tender: Soumission

PWGSC Project Manager / Administrateur de projets TPSGC

project number no. du projet

F5654-150080

drawing no. no. du dessin

H6