


LIGHTING EXISTING / DEMOLITION PLAN - LEVEL 1

SCALE : 1:100
0m 1m 2m 3m 4m 5m 6m 7m 8m 9m 10m

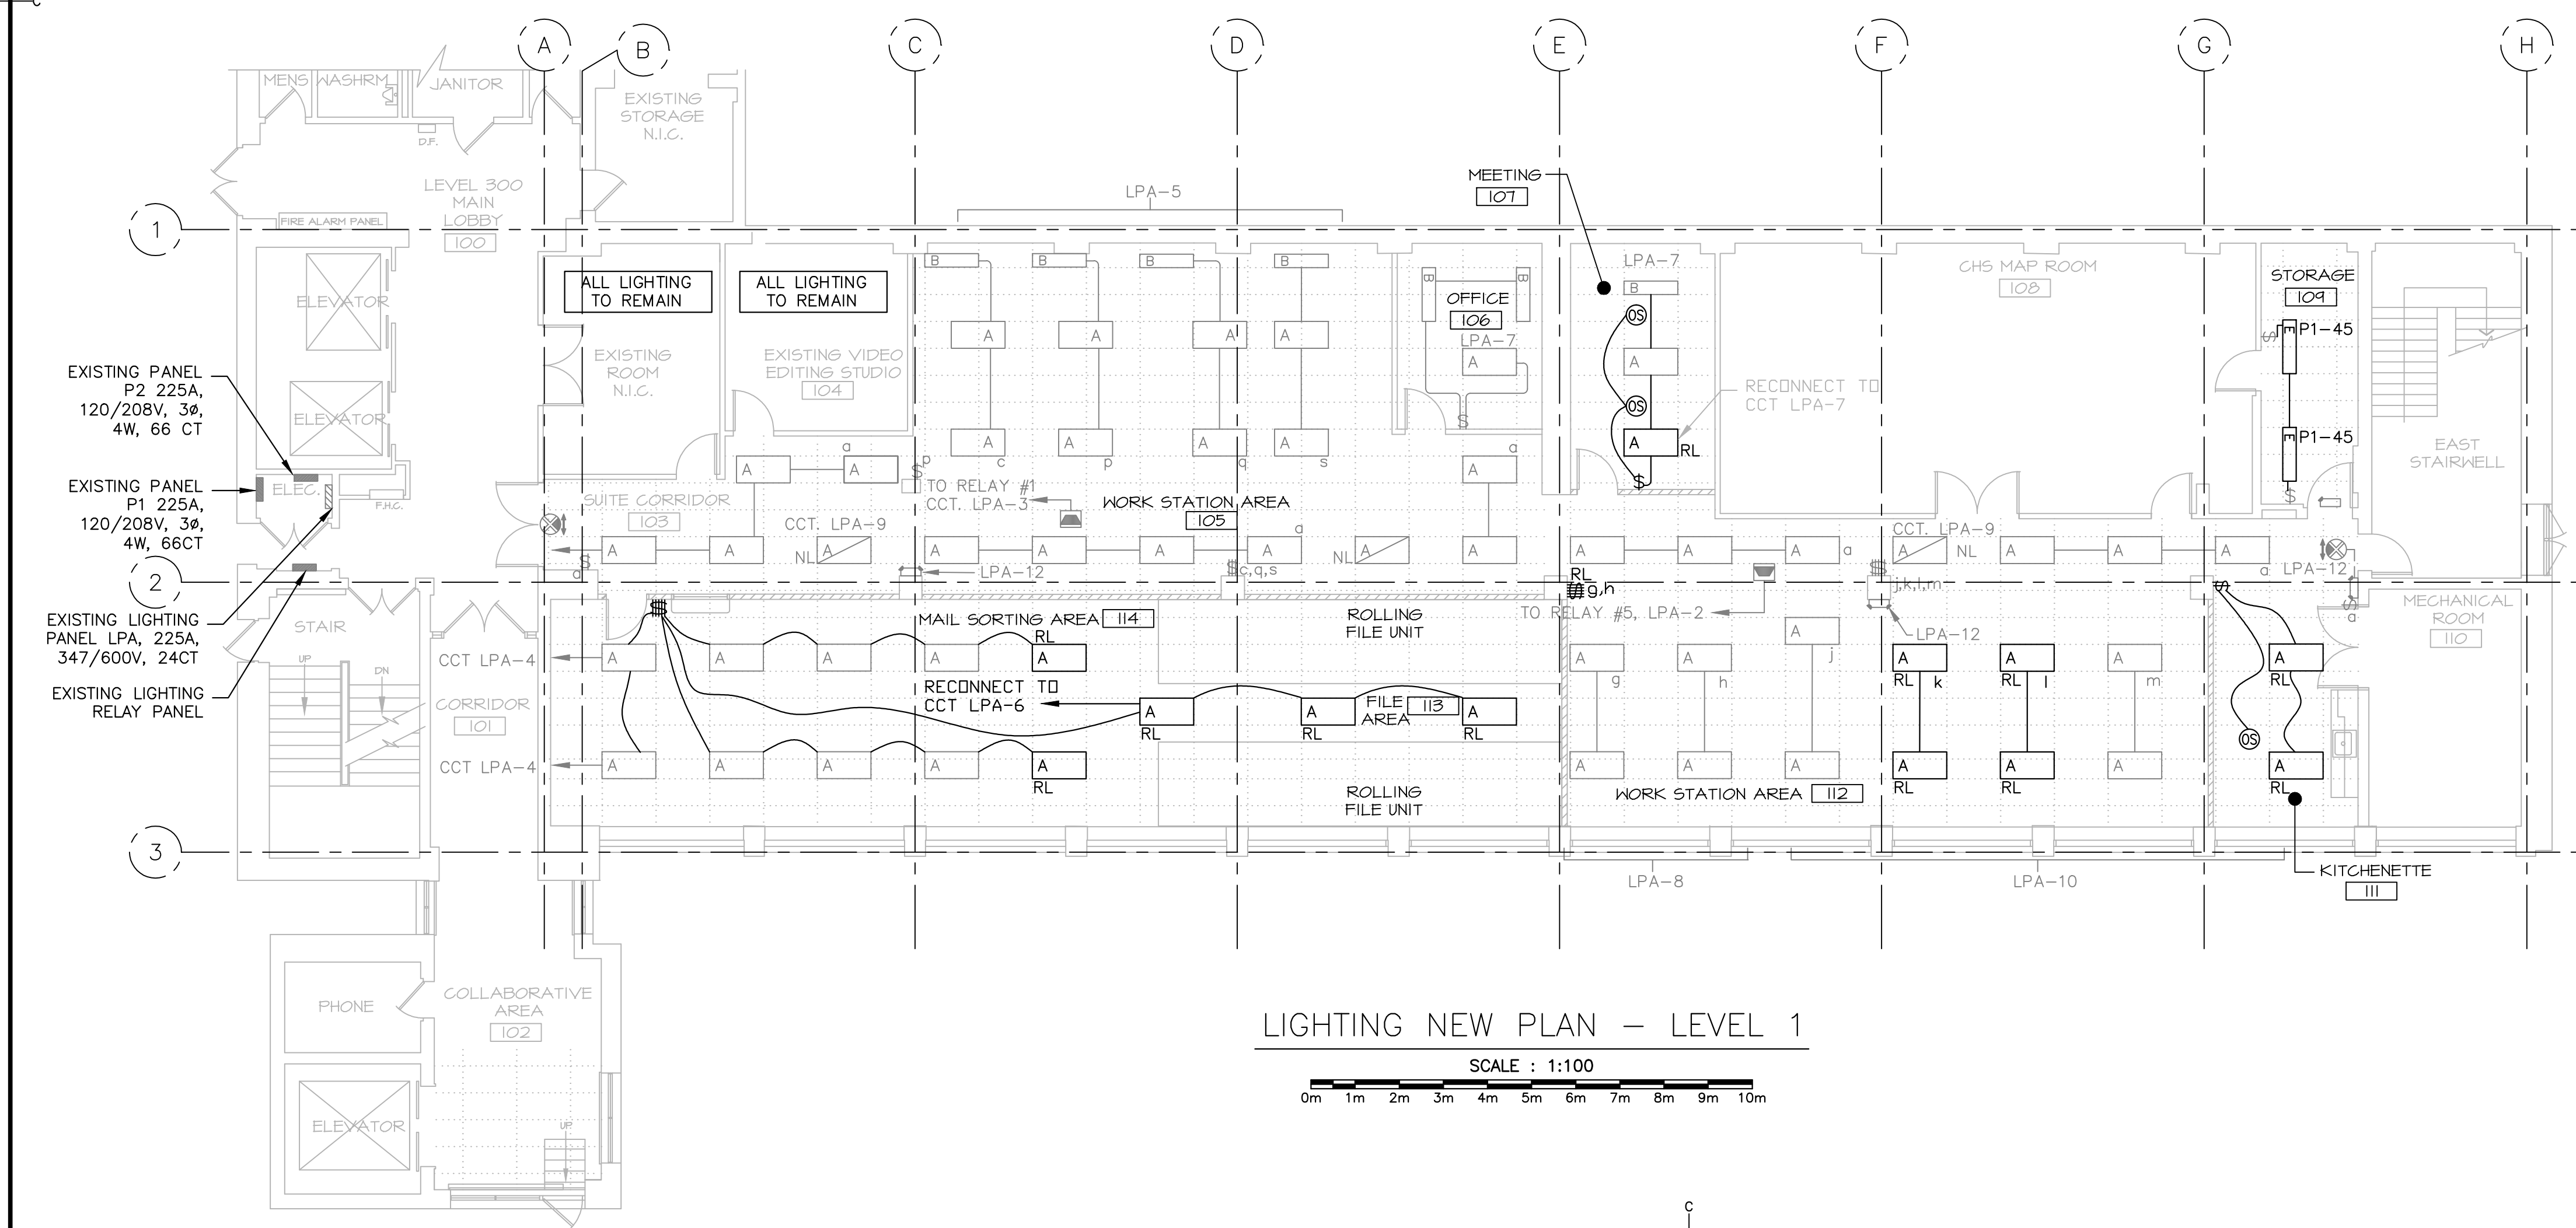


LIGHTING NEW PLAN - LEVEL 1

SCALE : 1:100
0m 1m 2m 3m 4m 5m 6m 7m 8m 9m 10m

ELECTRICAL NOTES:

INDICATED BY THE SYMBOL ON THE DRAWINGS. (I.E. INDICATES NOTE 1)

- DISCONNECT LIGHTING CONTROL FOR ZONE b.
- DISCONNECT LIGHTING CONTROL FOR ZONES d,r and f. CONTROL FOR ZONES g AND h TO REMAIN. RELOCATE SWITCH AND RE-CIRCUIT LIGHTING CONTROL ZONES AS INDICATES ON NEW LIGHTING PLAN.
- NEW SUSPENDED CEILING WILL BE INSTALLED IN STORAGE ROOM 109. DISCONNECT EXISTING SUSPENDED FIXTURES AND RE-INSTALL SURFACE MOUNT TO NEW CEILING. EXTEND EXISTING CIRCUITRY AS REQUIRED. RELOCATE EMERGENCY LIGHT IF REQUIRED. EXISTING CONDUIT AND CABLES SHALL BE RAISED AS NECESSARY TO ACCOMMODATE NEW CEILING HEIGHT.
- DISCONNECT AND REMOVE EXISTING LIGHTING CONTROL CIRCUITRY AND DEVICES. PROVIDE NEW LIGHTING CONTROL SYSTEM AND RELOCATE FIXTURES AS INDICATED ON NEW LIGHTING PLAN.
- NEW MAIL SORTING AREA 114 AND FILE AREA 113 WILL BE ADDED IN THIS LOCATION. REMOVE EXISTING LIGHTING CONTROL CIRCUITRY AND DEVICES MADE REDUNDANT. PROVIDE NEW LIGHTING CONTROL SYSTEM AND RELOCATE EXISTING FIXTURES AS INDICATED ON NEW LIGHTING PLAN.
- NEW KITCHENETTE 111 WILL BE ADDED IN THIS AREA. REMOVE EXISTING LIGHTING CONTROL CIRCUITRY AND DEVICES MADE REDUNDANT. PROVIDE NEW LIGHTING CONTROL SYSTEM AND RELOCATE EXISTING FIXTURES AS INDICATED ON NEW LIGHTING PLAN.
- DISCONNECT EXISTING LIGHTING CONTROL FOR ZONE n. RE-CIRCUIT ZONES j,k,l,m AND RELOCATES EXISTING FIXTURES AS INDICATED ON NEW LIGHTING PLAN.
- LIGHTING CONTROL CIRCUITRY C/W ASSOCIATED RACEWAY MADE REDUNDANT SHALL BE REMOVED BACK TO THE NEAREST JUNCTION BOX IN CEILING SPACE. FOR RELOCATION, EXTEND AND REROUTE ALL EXISTING LIGHTING CONTROL CIRCUITRY AND RACEWAY TO THE NEW LOCATION AS REQUIRED. TYPICAL FOR LEVEL 1, 2, 3 AND 4.
- TRACE ALL EXISTING CIRCUITS AND CONFIRM LOCATION OF ALL FIXTURES, LIGHTING CONTROL SWITCHES, RELAY NUMBERS AND CIRCUIT BREAKER NUMBERS PRIOR TO ANY DEMOLITION, RELOCATION OR NEW INSTALLATION. TYPICAL FOR LEVEL 1, 2, 3 AND 4.

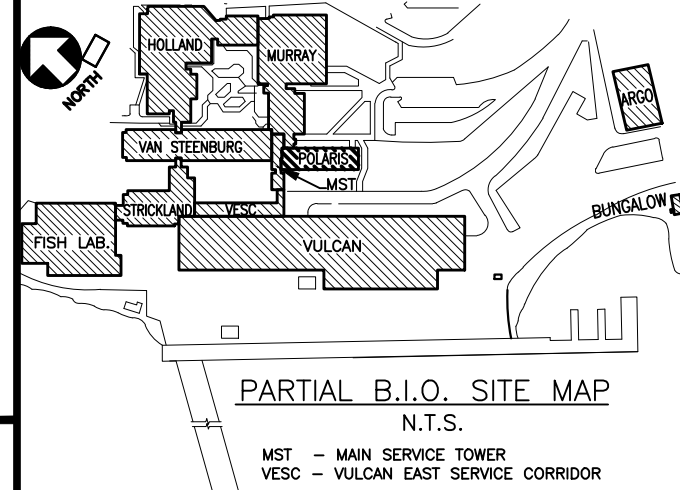


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B	ISSUE FOR TENDER	01/18/2016
A	ISSUED FOR 100% REVIEW	01/14/2016
revisions		date
project		project

POLARIS BUILDING FLOOR PLAN UPGRADES

BEDFORD INSTITUTE OCEANOGRAPHY
DARTMOUTH - NS

drawing no. dessin

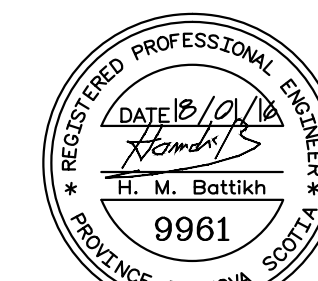LEVEL 1 LIGHTING PLAN NEW LAYOUT & DEMOLITION

designed	AL	conçu
date	DEC 2015	
drawn	AL	dessiné
date	DEC 2015	
approved	H.B.	approuvé
date	JAN 2016	
Tender		Soumission
PWOSC Project Manager	Administrateur de projets TPSGC	
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