



PART PLAN - TEMPORARY FUEL OIL TANK ARRANGEMENT

SCALE/ÉCHELLE: 1:100
0m 1m 2m 3m 4m 5m 6m 7m 8m 9m 10m

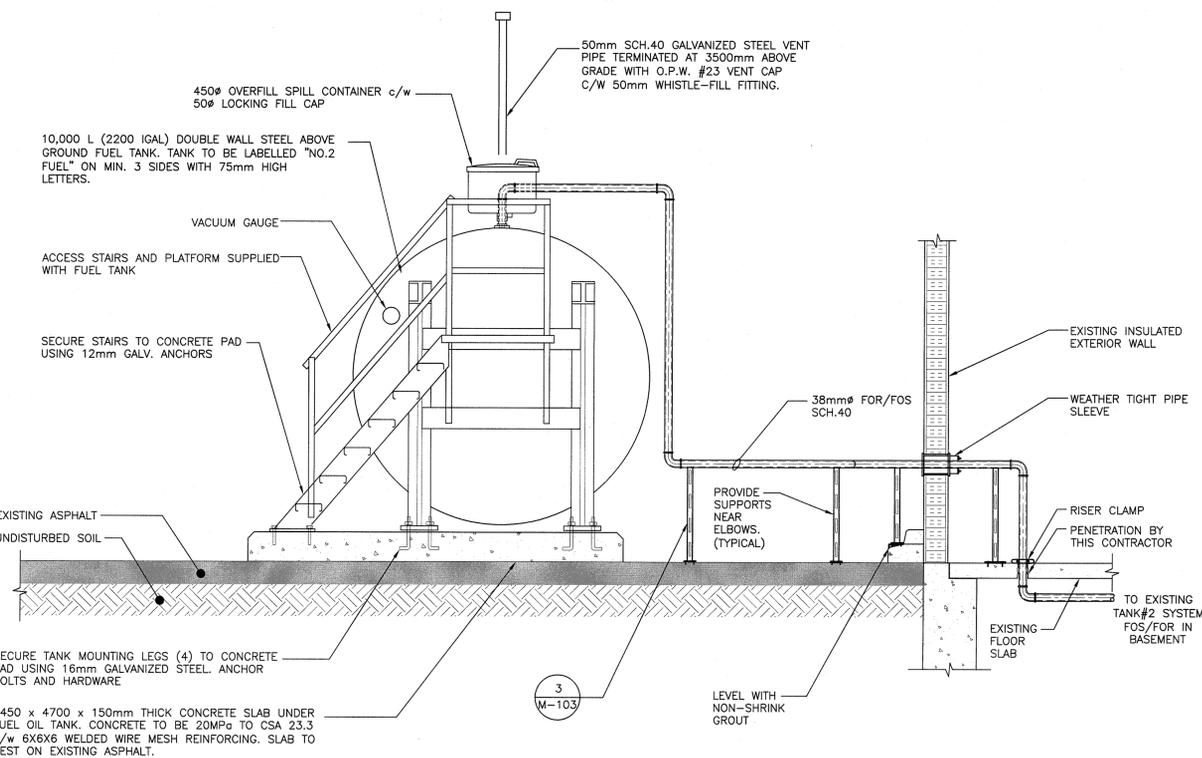


TEMPORARY FUEL OIL TANK DETAIL

SCALE/ÉCHELLE: 1:20
0mm 500mm 1000mm 1500mm 2000mm 2500mm

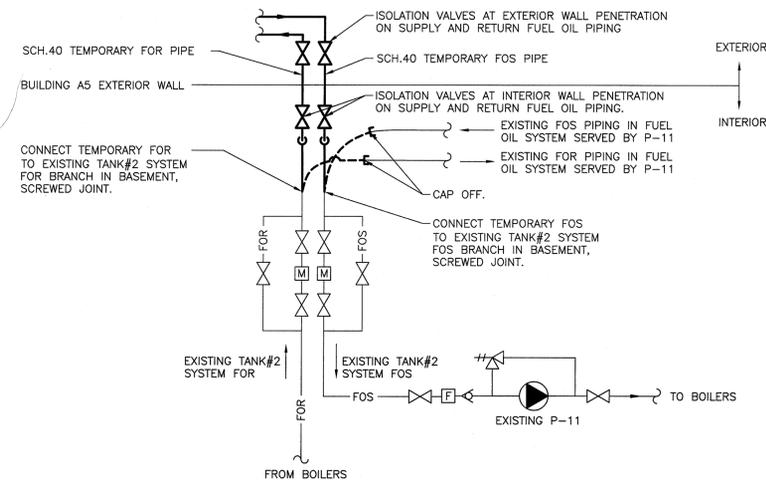


CONNECTION OF TEMPORARY FUEL OIL: BASEMENT

N.T.S.

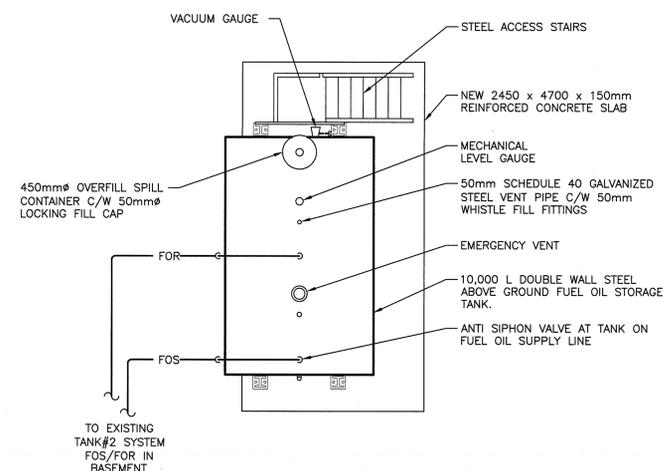


PART PLAN - TEMPORARY FUEL OIL TANK ARRANGEMENT

N.T.S.

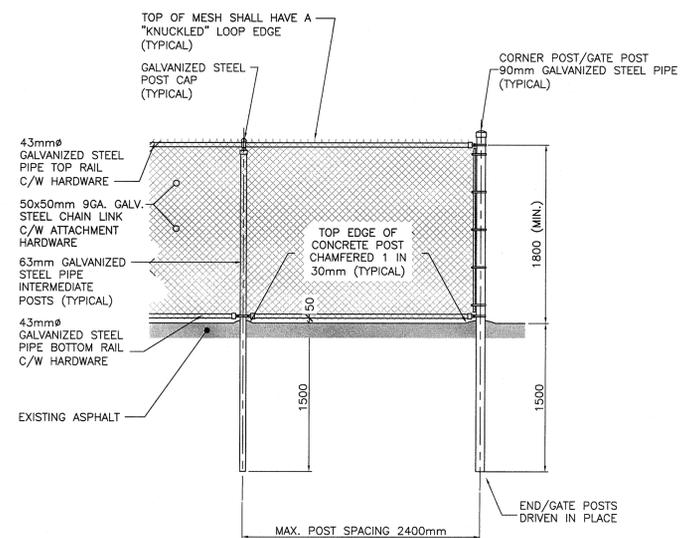

CHAIN LINK FENCE DETAIL


N.T.S.

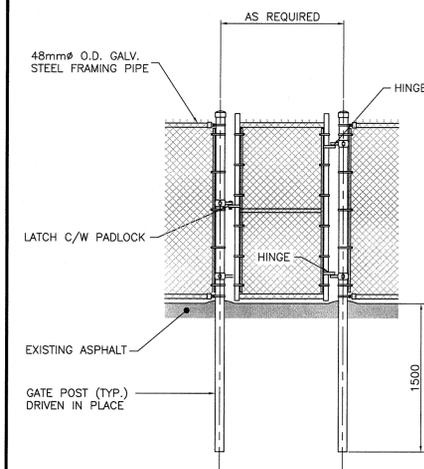

GATE DETAIL

N.T.S.

| LEGEND | |
|--------|--------------------------------|
| | NEW FUEL OIL SUPPLY |
| | NEW FUEL OIL RETURN |
| | EXISTING FUEL OIL SUPPLY |
| | EXISTING FUEL OIL RETURN |
| | ISOLATION VALVE |
| | EXISTING FLOW METER |
| | NEW PRESSURE RELIEF VALVE |
| | GEAR TYPE OIL TRANSFER PUMP |
| | EXISTING INLINE FUEL FILTER |
| | EXISTING PRESSURE RELIEF VALVE |

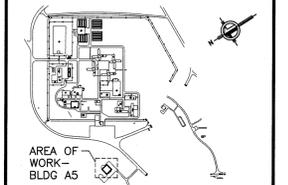

| | | |
|-----------|---------------------------|--------------|
| 0 | RELEASED FOR CONSTRUCTION | JAN. 04 2016 |
| revisions | | date |

project: REPLACEMENT OF PETROLEUM STORAGE TANKS, BLDG A5 SPRINGHILL INSTITUTION

drawing: MECHANICAL LAYOUT TEMPORARY FUEL OIL TANK REPLACEMENT

| | | |
|-----------------|-------------------|---------------------------------|
| designed | JYS | conçu |
| date | JAN. 04, 2016 | |
| drawn | AJB | dessiné |
| date | JAN. 04, 2016 | |
| approved | | approuvé |
| date | | |
| Project Manager | Raymond J. Yousif | Administrateur de projets TPSGC |
| project number | R.061879.001 | no. du projet |
| drawing no. | M-105 | no. du dessin |