


SCALE: 1/4'=1'-0'

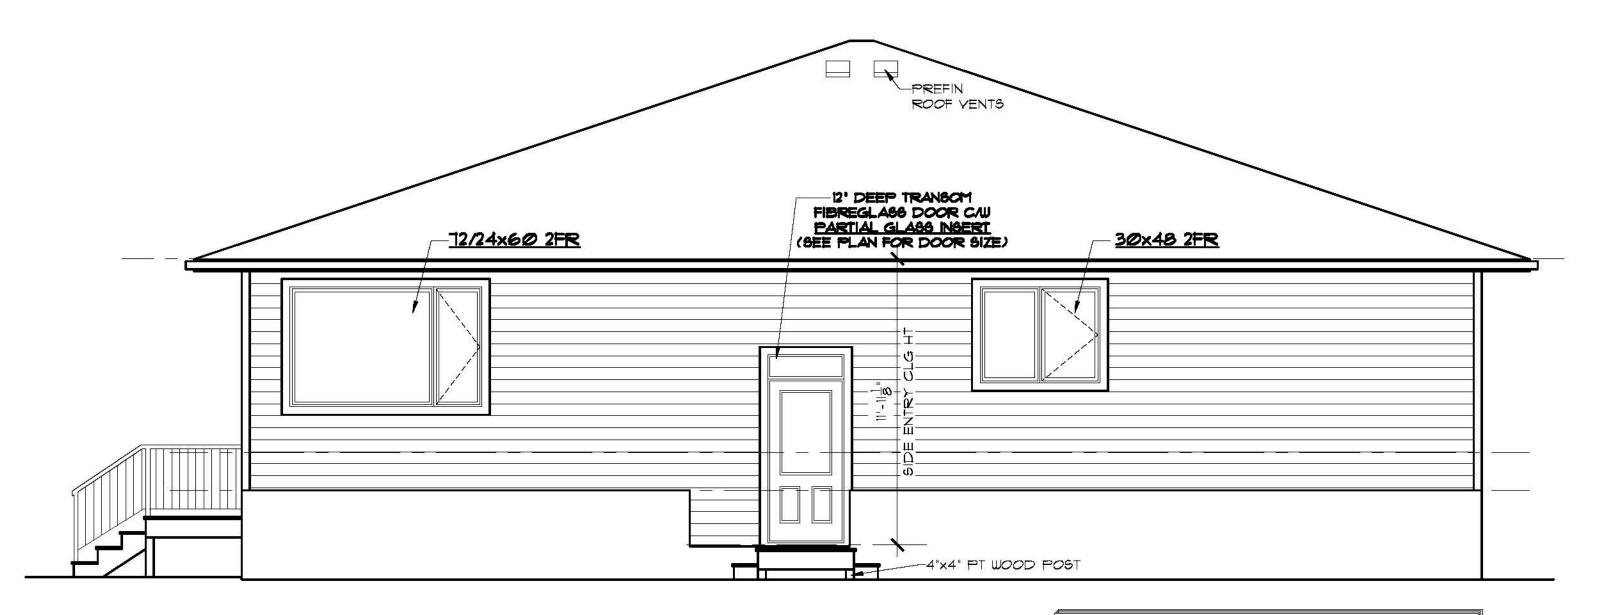

NORTH ELEVATION SCALE: 1/4'=1'-0'

NORTH ELEVATION GLAZED OPENING CALCS:

LIMITING DISTANCE = 7.5m MAX % OF GLAZED OPENINGS = 34% (NBC 9.10.15.4) EXPOSED BUILDING FACE AREA = 691 SQ FT AREA OF GLAZED OPENINGS (%) = 71 SQ FT (11%)

ABBREVIATIONS:

UNO - UNLESS NOTED OTHERWISE

TYP - TYPICAL U/S - UNDER SIDE

C/W - COMPLETE WITH

R.O. - ROUGH OPENING

O.C. - ON CENTER LBW - LOAD BEARING WALL

T/O - TOP OF

SH - SHELF

COL - COLUMN CJ - CONTROL JOINT

WD - WOOD CONC - CONCRETE

PREFIN - PREFINISHED FLR - FLOOR

CLG - CEILING HT - HEIGHT

ELEVATION NOTES:

- 1. WINDOWS AND DOOR SIZES SHOWN DO NOT INCLUDE ROUGH OPENING DIMENSIONS. WINDOW SUPPLIER TO PROVIDE EXACT ROUGH OPENINGS PRIOR TO FRAMING.
- 2. WINDOWS AND DOORS TO ILLUSTRATE DIRECTION OF OPERATION, OBSCURE GLASS, ETC.
- 3. TYPICAL MOUNTING HEIGHTS DIMENSIONED. ADJUST MOUNTING HEIGHT TO MATCH R.O. OF AN ADJACENT DOOR WHEN THEY ARE WITHIN THE SAME ROOM
- 4. SEE FRONT ELEVATIONS FOR EXTERIOR FINISHES & DETAILS. ONLY UNIQUE FINISHES & DETAILS WILL BE NOTED ON REMAINING ELEVATIONS.

GENERAL NOTES:

- 1. BUILDER TO CONFORM TO NATIONAL BUILDING CODE OF CANADA (2010) PART 9.
- 2. DRAWINGS NOT TO BE SCALED.
- 3. BUILDER SHALL SATISFY HIMSELF THAT ALL DIMENSIONS, DATUMS, AND INFORMATION SHOWN ARE CORRECT. VERIFY ALL DIMENSIONS ON
- 4. DIMENSIONS ARE TAKEN TO EXTERIOR FACE OF WALL SHEATHING FOR EXTERIOR WALLS AND TO CENTERLINE OF INT PARTITIONS U.N.O. DIMENSIONS WILL GO TO FACE OF FRAMING WHERE THERE ARE FLOOR OR CEILING FRAMING CHANGES, AND AT TUB/SHOWER UNITS.
- 5. NO MODIFICATIONS PERMITTED TO STRUCTURE WITHOUT WRITTEN APPROVAL OF BUILDER'S STRUCTURAL ENGINEER.
- 6. ALL BEAMS & HEADERS TO BE SIZED BY OTHERS TO SUIT STRUCTURAL LOADING.
- 7. IF THERE IS A DISCREPANCY BETWEEN THE DRAWINGS AND THE BUILDERS SPECS, THE SPECS SHALL OVERRULE THE DRAWINGS.



2232 2ND AVENUE REGINA, SASKATCHEWAN CANADA S4R 1K3

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PROJECT

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DUPLEX

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CORONACH

SASKATCHEWAN

1/4" = 1'-Ø" DRAWING TITLE

SCALE

DM

DESIGNED BY DRAWN BY


TYDK

DRAWING NO.


A-1 EXTERIOR ELEVATIONS

DATE

SEPT. 18, 2015

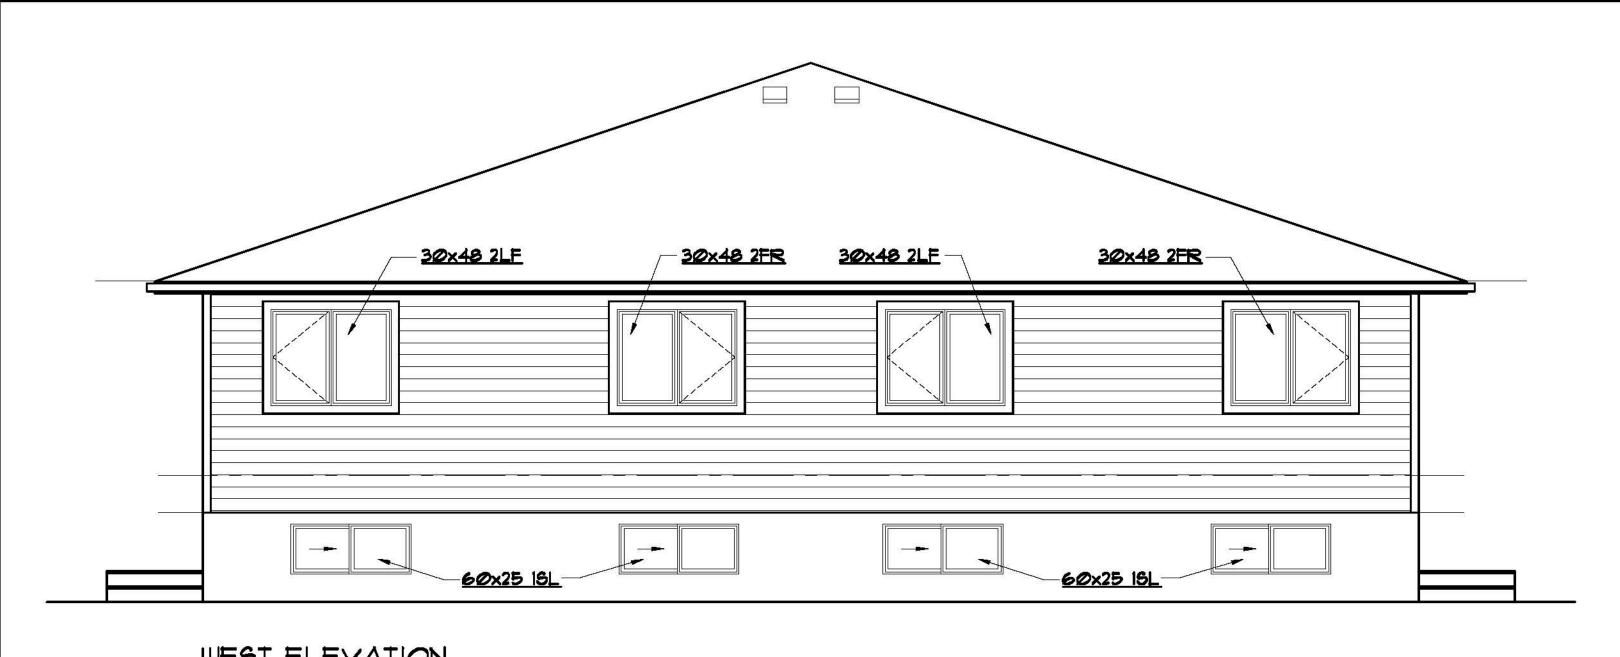

WEST ELEVATION SCALE: 1/4"=1'-0"

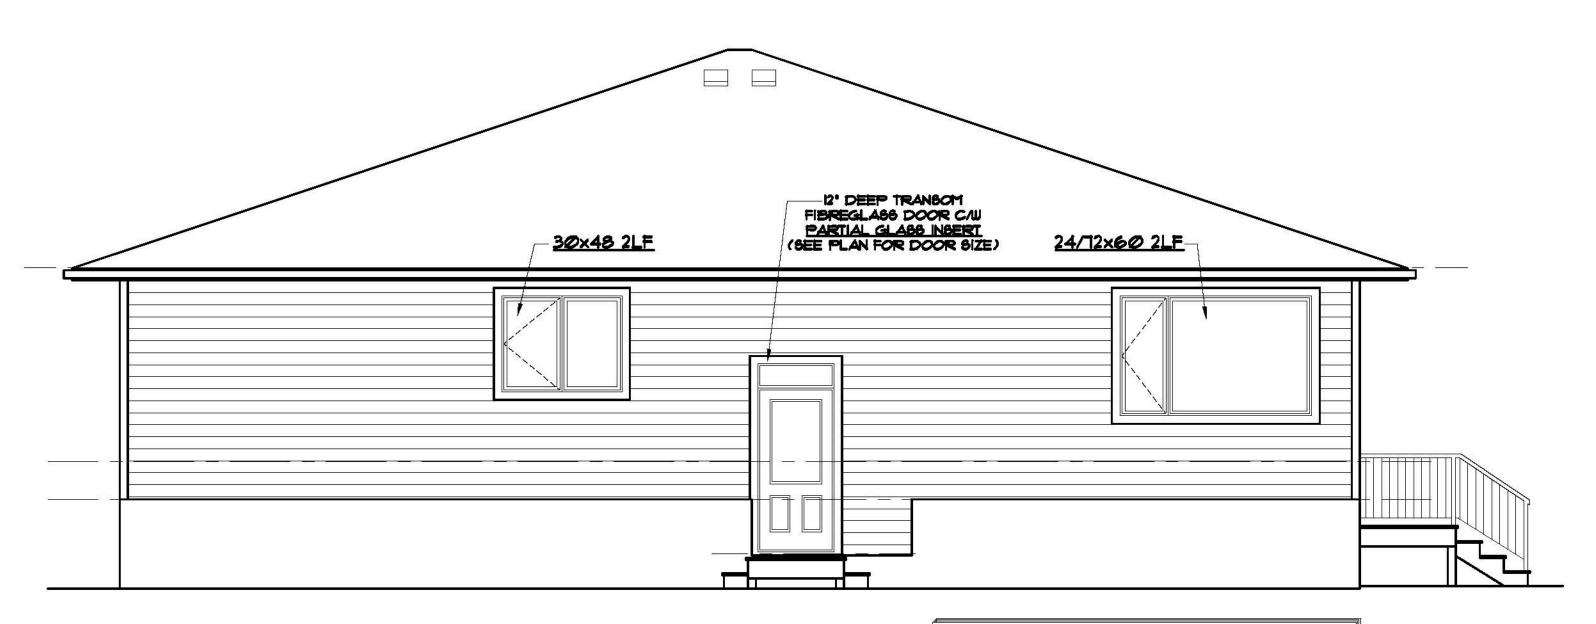

SOUTH ELEVATION SCALE: 1/4'=1'-0'

SOUTH ELEVATION GLAZED OPENING CALCS:

LIMITING DISTANCE = 7.5m MAX % OF GLAZED OPENINGS = 34% (NBC 9.10.15.4) EXPOSED BUILDING FACE AREA = 691 SQ FT AREA OF GLAZED OPENINGS (%) = 71 SQ FT (11%)

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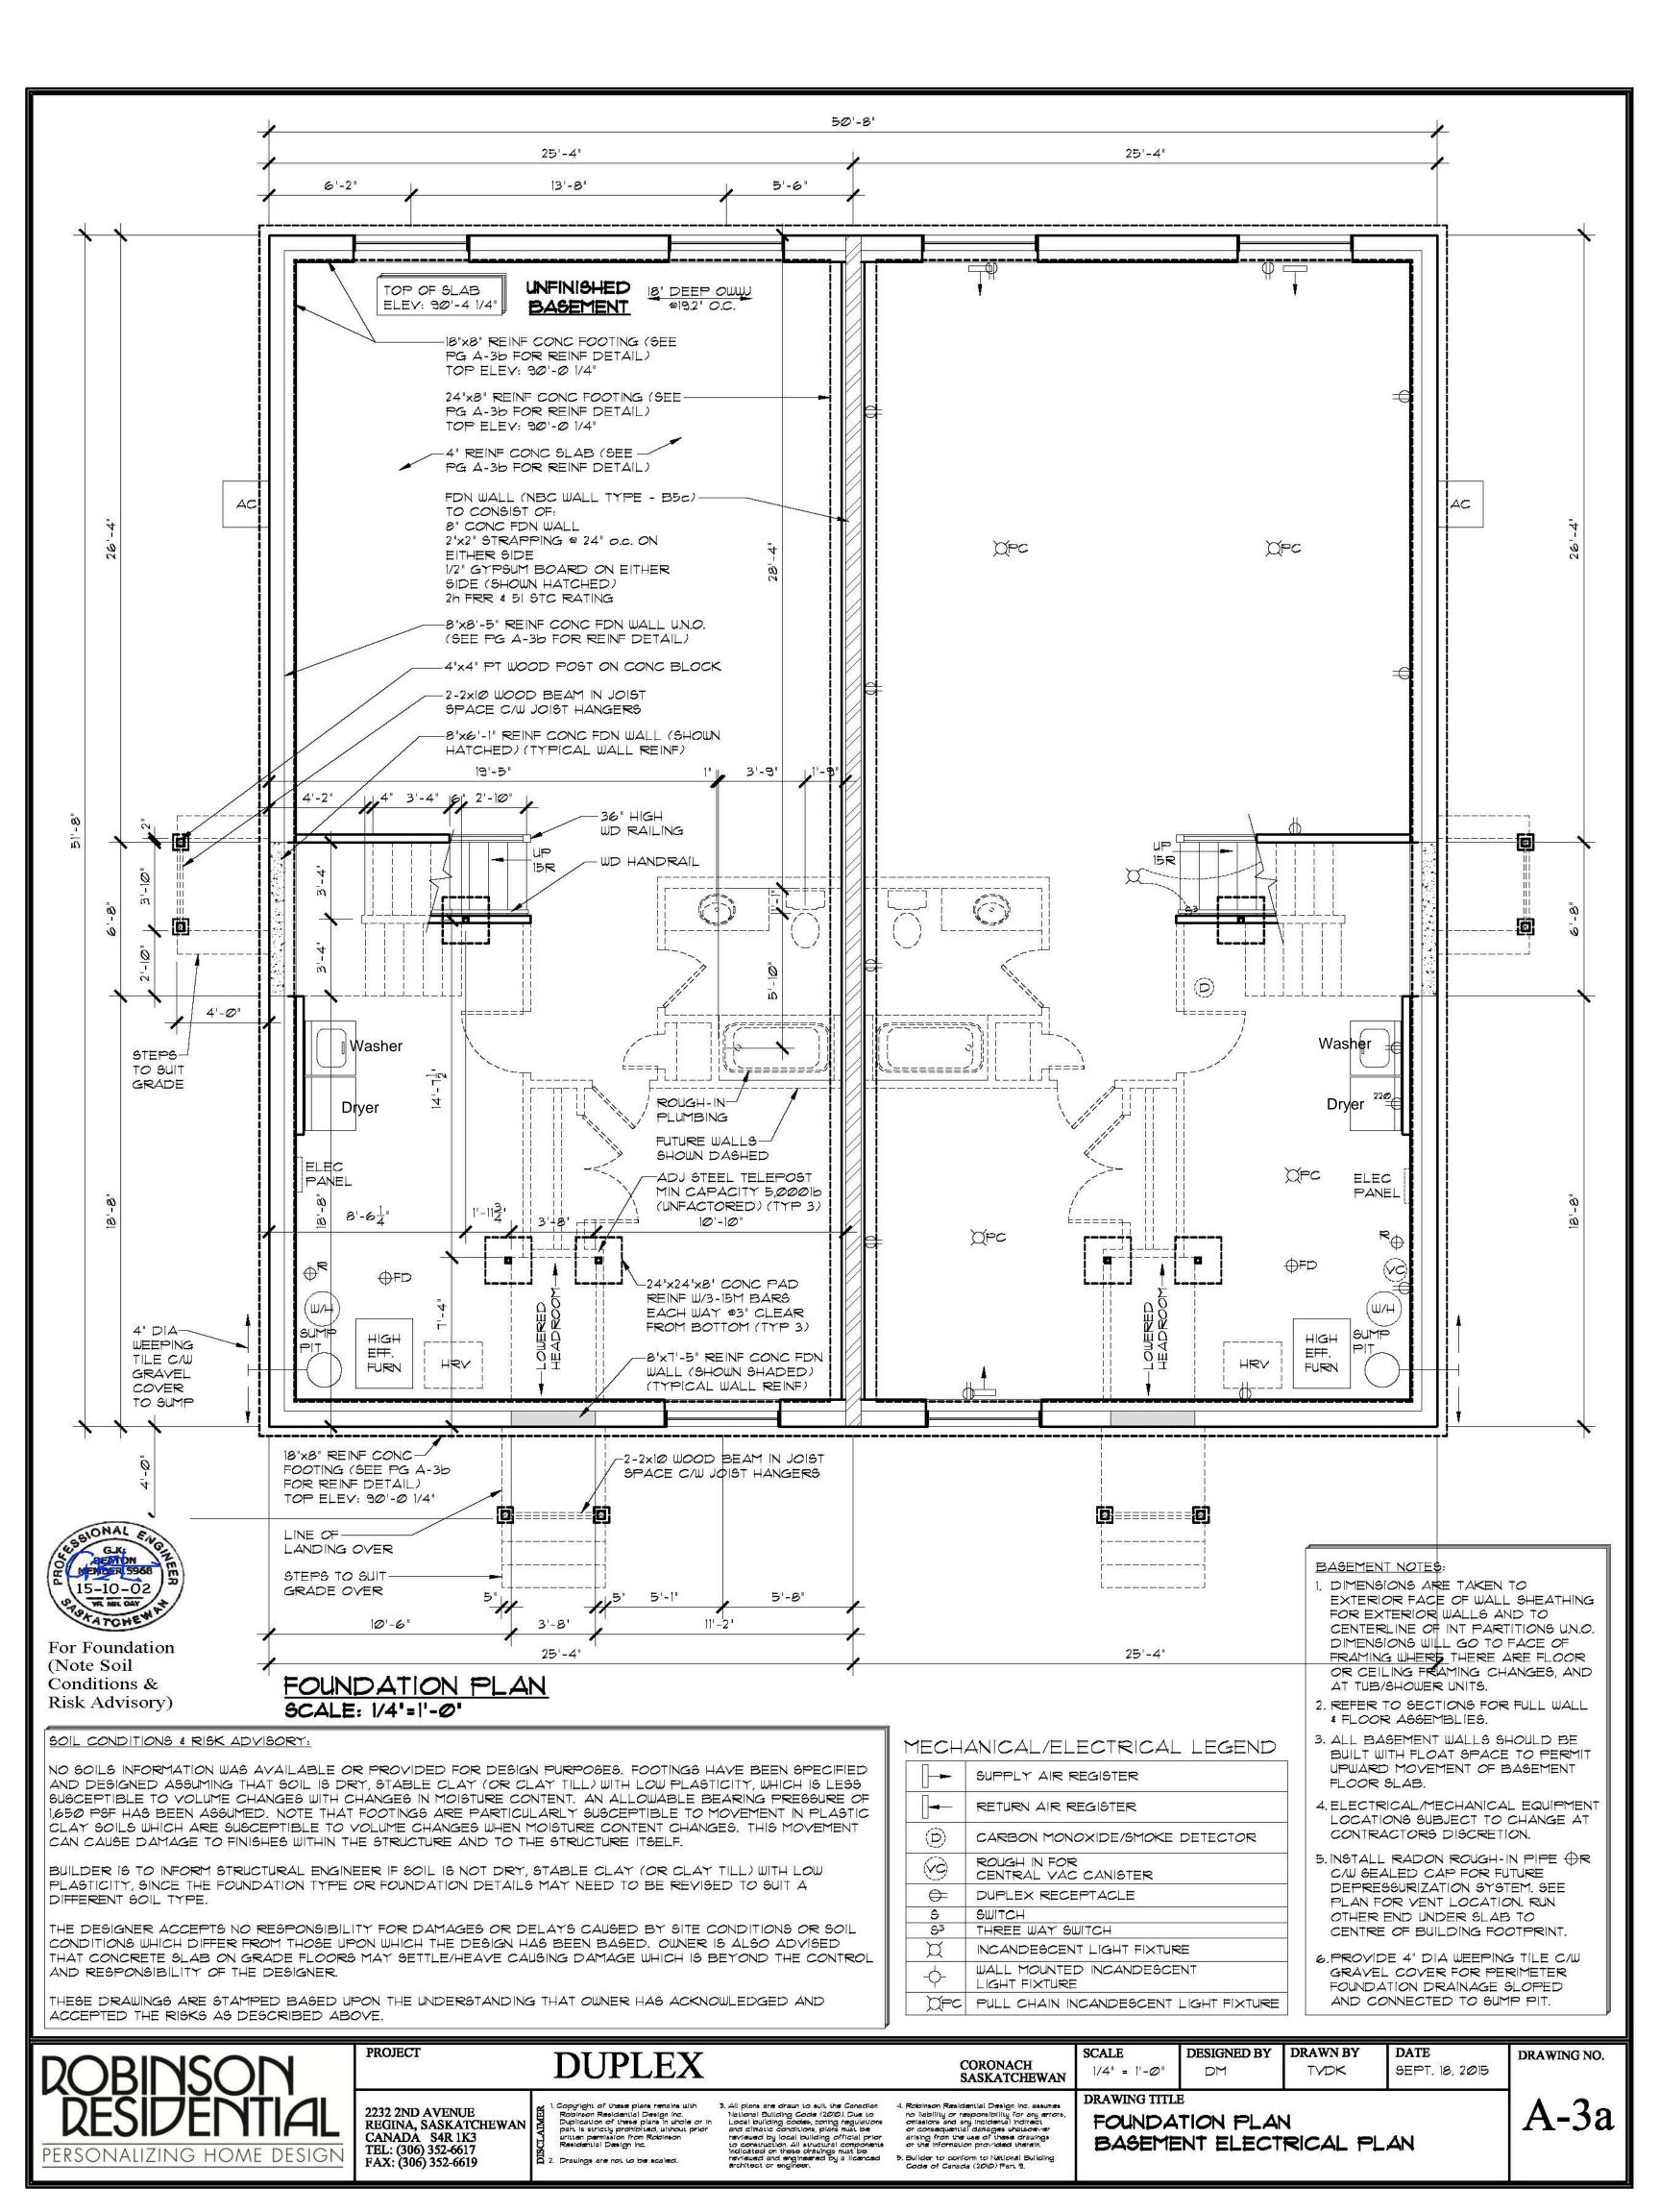
CORONACH SASKATCHEWAN


SCALE DESIGNED BY DRAWN BY DATE SEPT. 18, 2015 1/4" = 1'-0" TYDK DM DRAWING TITLE

EXTERIOR ELEVATIONS

A-2

DRAWING NO.



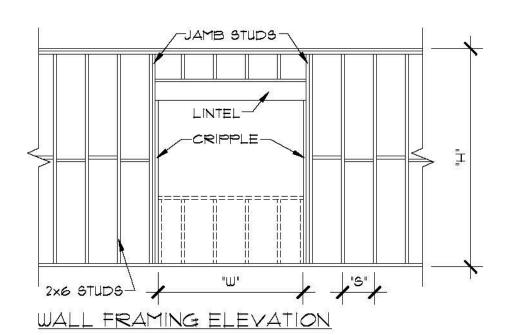

BASEMENT WALL REINF

DETAIL @ WINDOW

SCALE: 1/4"=1'-0

OPENING "W"	LINTEL SIZE	NO. OF	JAMB STUDS EA. SIDE				
		CRIPPLES	S=24"	5=16"	S=12"		
Ø - 3'-11"	2-2"×8"	1 EA. SIDE	Ţ	2	2		
4'-0" - 5'-11"	2-2"×1Ø"	1 EA. SIDE	2	2	3		
6'-0" - 8'-0"	3-2"x10"	1 EA. SIDE	2	3	4		

LINTELS FOR 2x6 EXTERIOR WALLS

STUD SPACING 'S"	MAX WALL HEIGHT "H"
24" <i>O</i> C	10'-6"
16" OC	12'-6"
12" OG	13'-6"


WALL HEIGHTS FOR 2×6 EXTERIOR WALL

CONDITIONS:

- ALL STUDS NO. 3/STUD SPF OR D. FIR
- 2. ALL LINTELS NO. IMO. 2 SPF OR D. FIR ALL STUDS TO HAVE MID-HEIGHT BLOCKING
- ALL STUDS TO BE SHEATHED BOTH FACES WITH
- 1/2" GWB # 3/8" PLYWD OR OSB
- WHERE STUDS ARE SHEATHED ON EXTERIOR FACE ONLY, STUDS ARE TO BE BLOCKED AT MAXIMUM 4'-0' O.C.

2x6 EXTERIOR TALL WALL FRAMING

SCALE: NTS

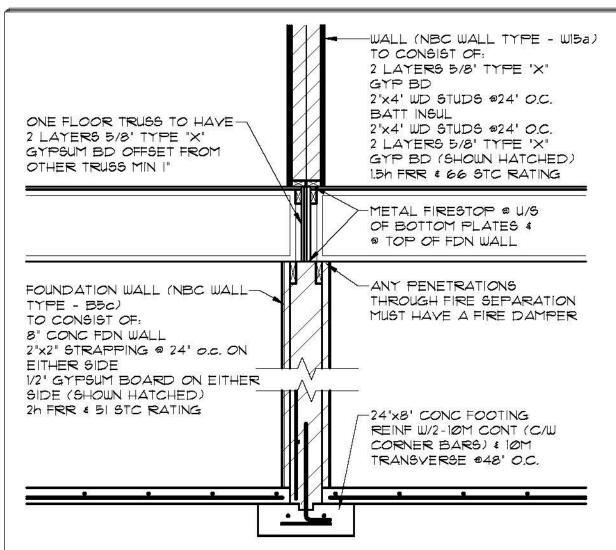

(FIRE SEPARATION) DETAIL SCALE: 1/4"=1'-0"

FASTEN METAL STRAP TO-

USE METAL STRAP 3" WIDE

BRACE AT SIDEWALLS

(SEE PLAN FOR HEIGHT)

VERT @ 16" oc MIDWALL

10M HOR @16" O.C., 1/5 FACE

15M #20" O.C. VERT, 1/S FACE C/W CORNER BARS TO MATCH

8" CONC FDN WALL

× 18 GA C/W 3-1 1/2" LG NAILS

@ EACH FLOOR JOIST & EACH

REINF W/1-15M HOR TOP & BOTTOM

(ADJUST WALL HTS TO MAINTAIN FTG

ELEY MIN 4'-0" BELOW FINAL GRADE)

NOTE: INTERIOR CONCRETE DEMISING

PROVIDE 1 1/2' CONT KEY & 10Mx32"-

WALL REINFORCED WITH 1-15M HORIZ

TOP & BOTTOM, AND IOM HORIZ &

(24"x8" HOOKED) DWLS @32" O.C.

4" CONC SLAB REINF. W/IØM @-

16' O.C. EA. WAY C/W 6 MIL

18"x8' CONC FOOTING REINF

10M TRANSVERSE #48" O.C.

4" DIA WEEPING TILE C/W-

GRAVEL COVER TO SUMP

SCALE: 1/2"=1'-0"

W/2-IOM CONT (C/W CORNER BARS)

INSULATION AS PER FOOTINGS NOTE.

ADJUST GRADE TO MAINTAIN MINIMUM OF 4'-0" SOIL

COVER OVER FOOTINGS. FOOTINGS WITH SOIL COVER


OF 4'-0" TO 6'-0" MUST BE INSULATED WITH 2" RIGID


FON WALL REINF DETAIL

POLY DAMPPROOFING &

5" COMP GRANULAR FILL


END OF EACH JOIST

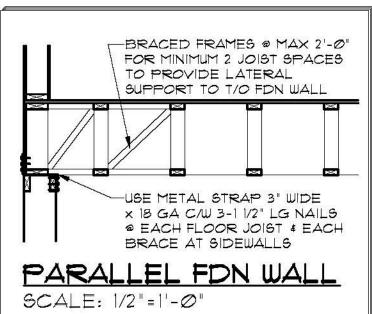


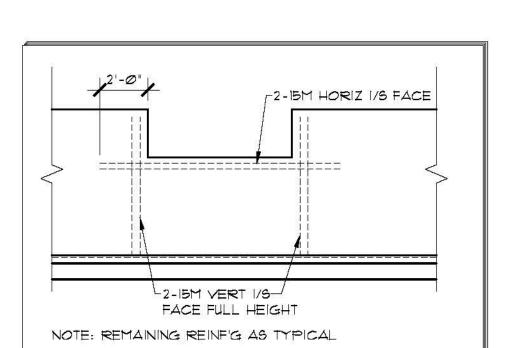

REINF'G DETAIL @ LOWERED FOUNDATION WALL

SCALE: 1/4"=1'-0"

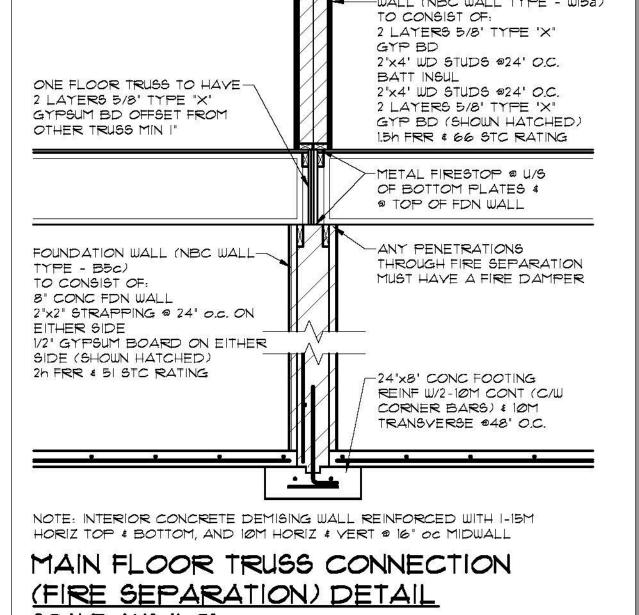

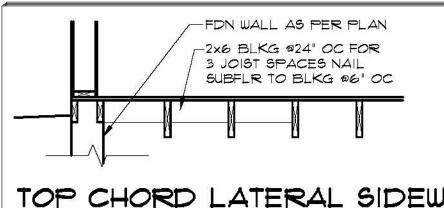

TOP CHORD LATERAL SIDEWALL SUPPORT DETAIL @ FOYERS

2 3

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DET

NOTES

STRUCTURAL

4. Recinson Residential Design in the leading or responsibility for amissions and ext. Inclosers in the or consequential demages when arising from the use of these of or the information provided the

All plans a National # Local buf and climater reviewed to construct and construction and construction architects.

DISCIPLIMER

Z

SCALE AS SHOWN

<u>@</u>

DATE SEPT.

SCALE: 1/2"=1'-0"



For Designated Tall Wall Framing



For Foundation (Note Soil

Conditions & Risk Advisory)

CLEAR

STRUCTURAL NOTES

ALL BASEMENT WALLS SHOULD BE BUILT WITH FLOAT SPACE TO PERMIT UPWARD MOVEMENT OF BASEMENT FLOOR SLAB

Association of Professional Engineers & Geoscientists

of Saskatchewan

CERTIFICATE OF AUTHORIZATION

Beam and Basement Design Ltd.

Number 33214

Permission to Consult held by:

CONCRETE TO CSA A23.

Civil

REINFORCING TO CSA G30.18

2. ALL OTHER BARS GRADE 400

- ALL CONCRETE FOOTINGS TO BE FOUNDED ON SOUND, DRY, UNDISTURBED SOIL. SOIL BELOW FOOTINGS MUST BE FREE OF FROST AND NOT
- FOOTINGS WITH SOIL COVER OF 6'-0" AND
- FOOTINGS WITH SOIL COVER OF 4'-0" TO 6'-0" MUST BE INSULATED WITH A MINIMUM OF 2" RIGID INSULATION SET ON TOP OF THE FOOTING AND EXTENDED A MINIMUM OF 4'-0' FROM THE EXTERIOR FACE OF THE FOUNDATION WALL
- 4. FOOTINGS WITH SOIL COVER LESS THAN 4'-0' ARE NOT PERMITTED.

SOIL CONDITIONS & RISK ADVISORY:


PROVIDED FOR DESIGN PURPOSES. FOOTINGS HAVE BEEN SPECIFIED AND DESIGNED ASSUMING THAT SOIL IS DRY, STABLE CLAY (OR CLAY TILL) WITH LOW PLASTICITY, WHICH IS LESS SUSCEPTIBLE TO YOLUME CHANGES WITH CHANGES IN MOISTURE CONTENT. AN ALLOWABLE BEARING PRESSURE OF 1,650 PSF HAS BEEN ASSUMED. NOTE THAT FOOTINGS ARE PARTICULARLY SUSCEPTIBLE TO MOVEMENT IN PLASTIC CLAY SOILS WHICH ARE SUSCEPTIBLE TO VOLUME CHANGES WHEN MOISTURE CONTENT CHANGES. THIS MOVEMENT CAN CAUSE DAMAGE TO FINISHES WITHIN THE STRUCTURE AND TO THE STRUCTURE ITSELF.


SOIL IS NOT DRY, STABLE CLAY (OR CLAY TILL) WITH LOW PLASTICITY, SINCE THE FOUNDATION TYPE OR FOUNDATION DETAILS MAY NEED TO BE REVISED TO SUIT A DIFFERENT SOIL TYPE.


DAMAGES OR DELAYS CAUSED BY SITE CONDITIONS OR SOIL CONDITIONS WHICH DIFFER FROM THOSE UPON WHICH THE DESIGN HAS BEEN BASED. OWNER IS ALSO ADVISED THAT CONCRETE SLAB ON GRADE FLOORS MAY SETTLE/HEAVE CAUSING DAMAGE WHICH IS BEYOND THE CONTROL AND RESPONSIBILITY OF THE DESIGNER.

THESE DRAWINGS ARE STAMPED BASED UPON THE UNDERSTANDING THAT OWNER HAS ACKNOWLEDGED AND ACCEPTED THE RISKS AS DESCRIBED ABOVE.

BUILDER IS TO INFORM STRUCTURAL ENGINEER IF THE DESIGNER ACCEPTS NO RESPONSIBILITY FOR

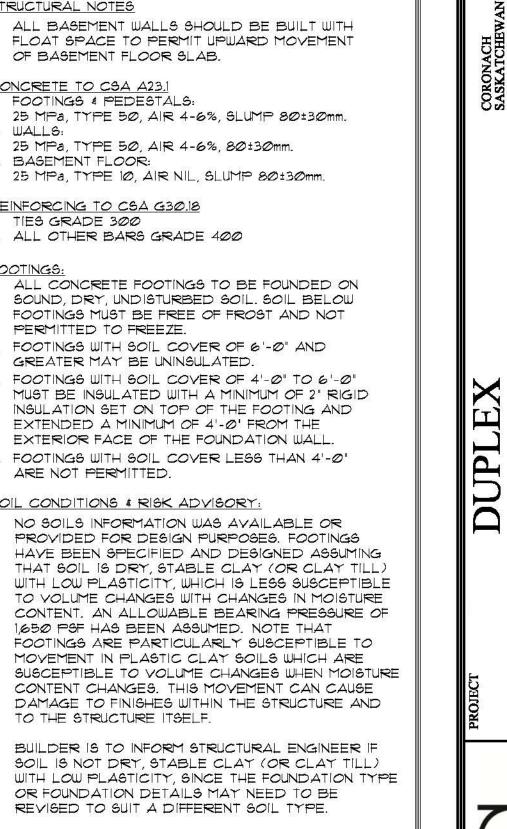

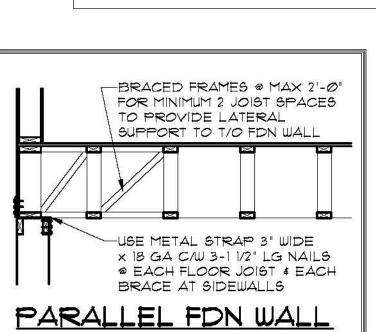

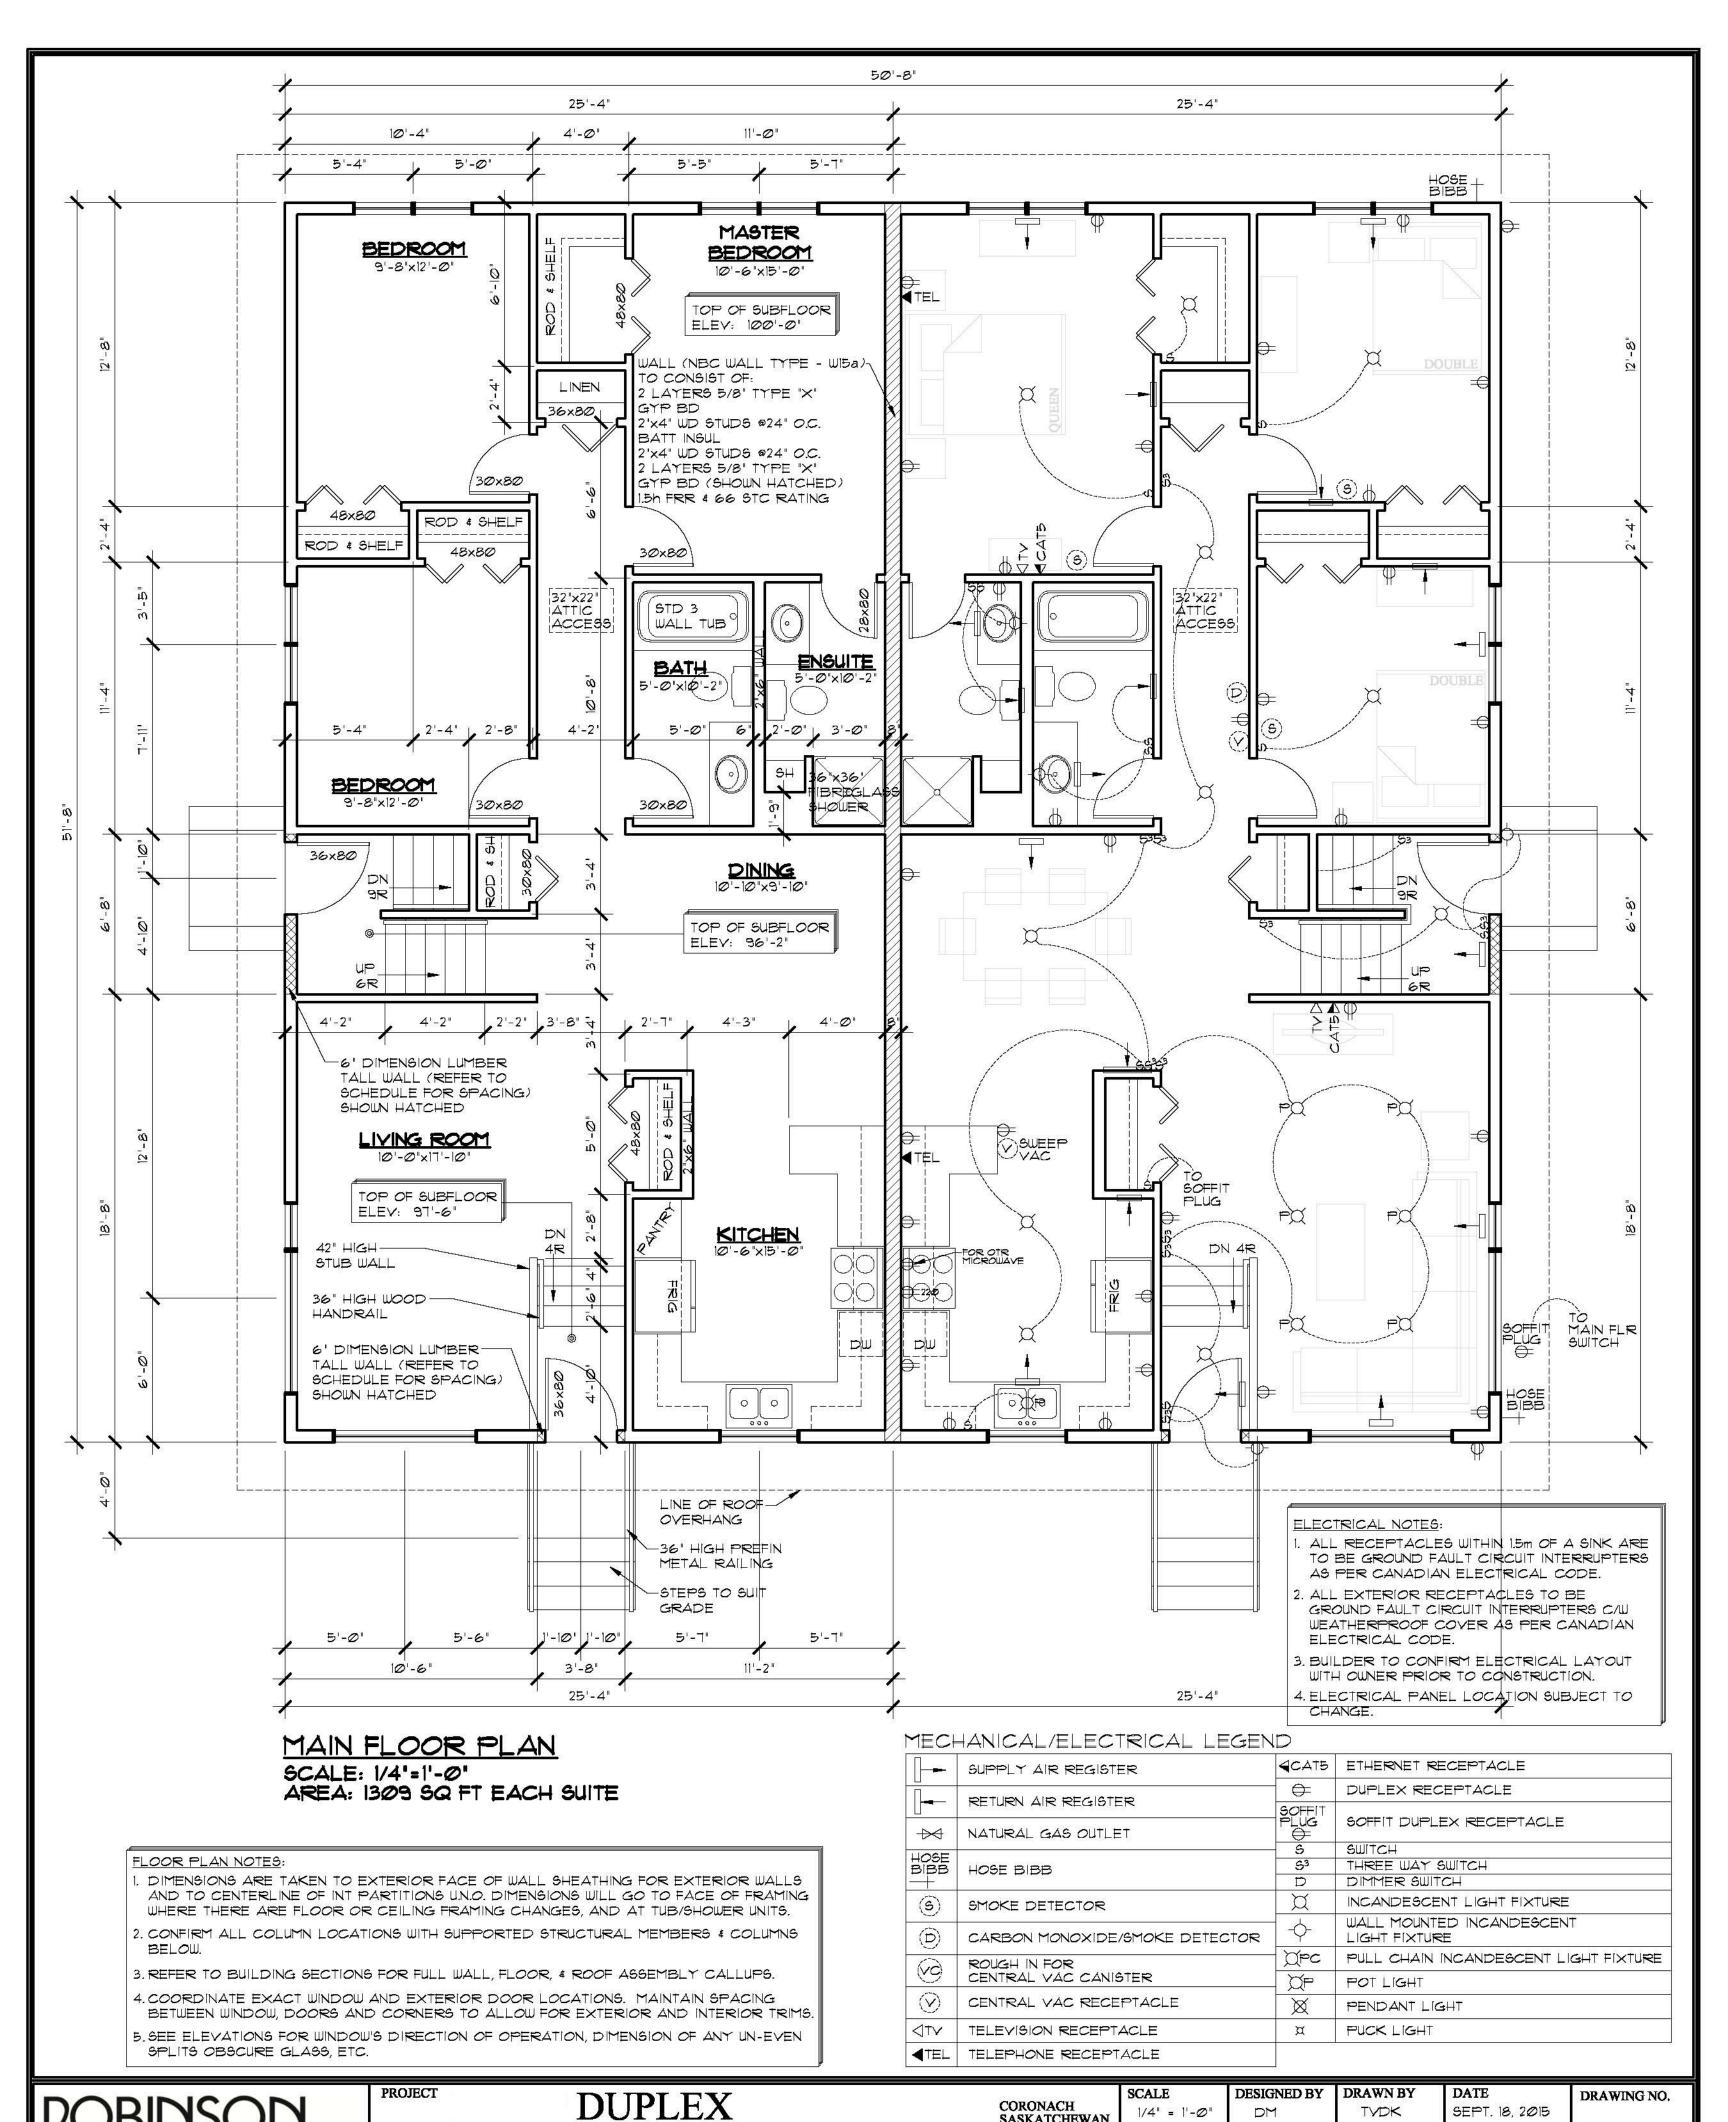

PERSONALIZING HOME DESIGN

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Code of Canada (2010) Part 9.

CORONACH SASKATCHEWAN


1/4" = 1'-0"

DRAWING TITLE MAIN FLOOR PLAN MAIN FLOOR ELECTRICAL PLAN

TYDK

A-4

SEPT. 18, 2015

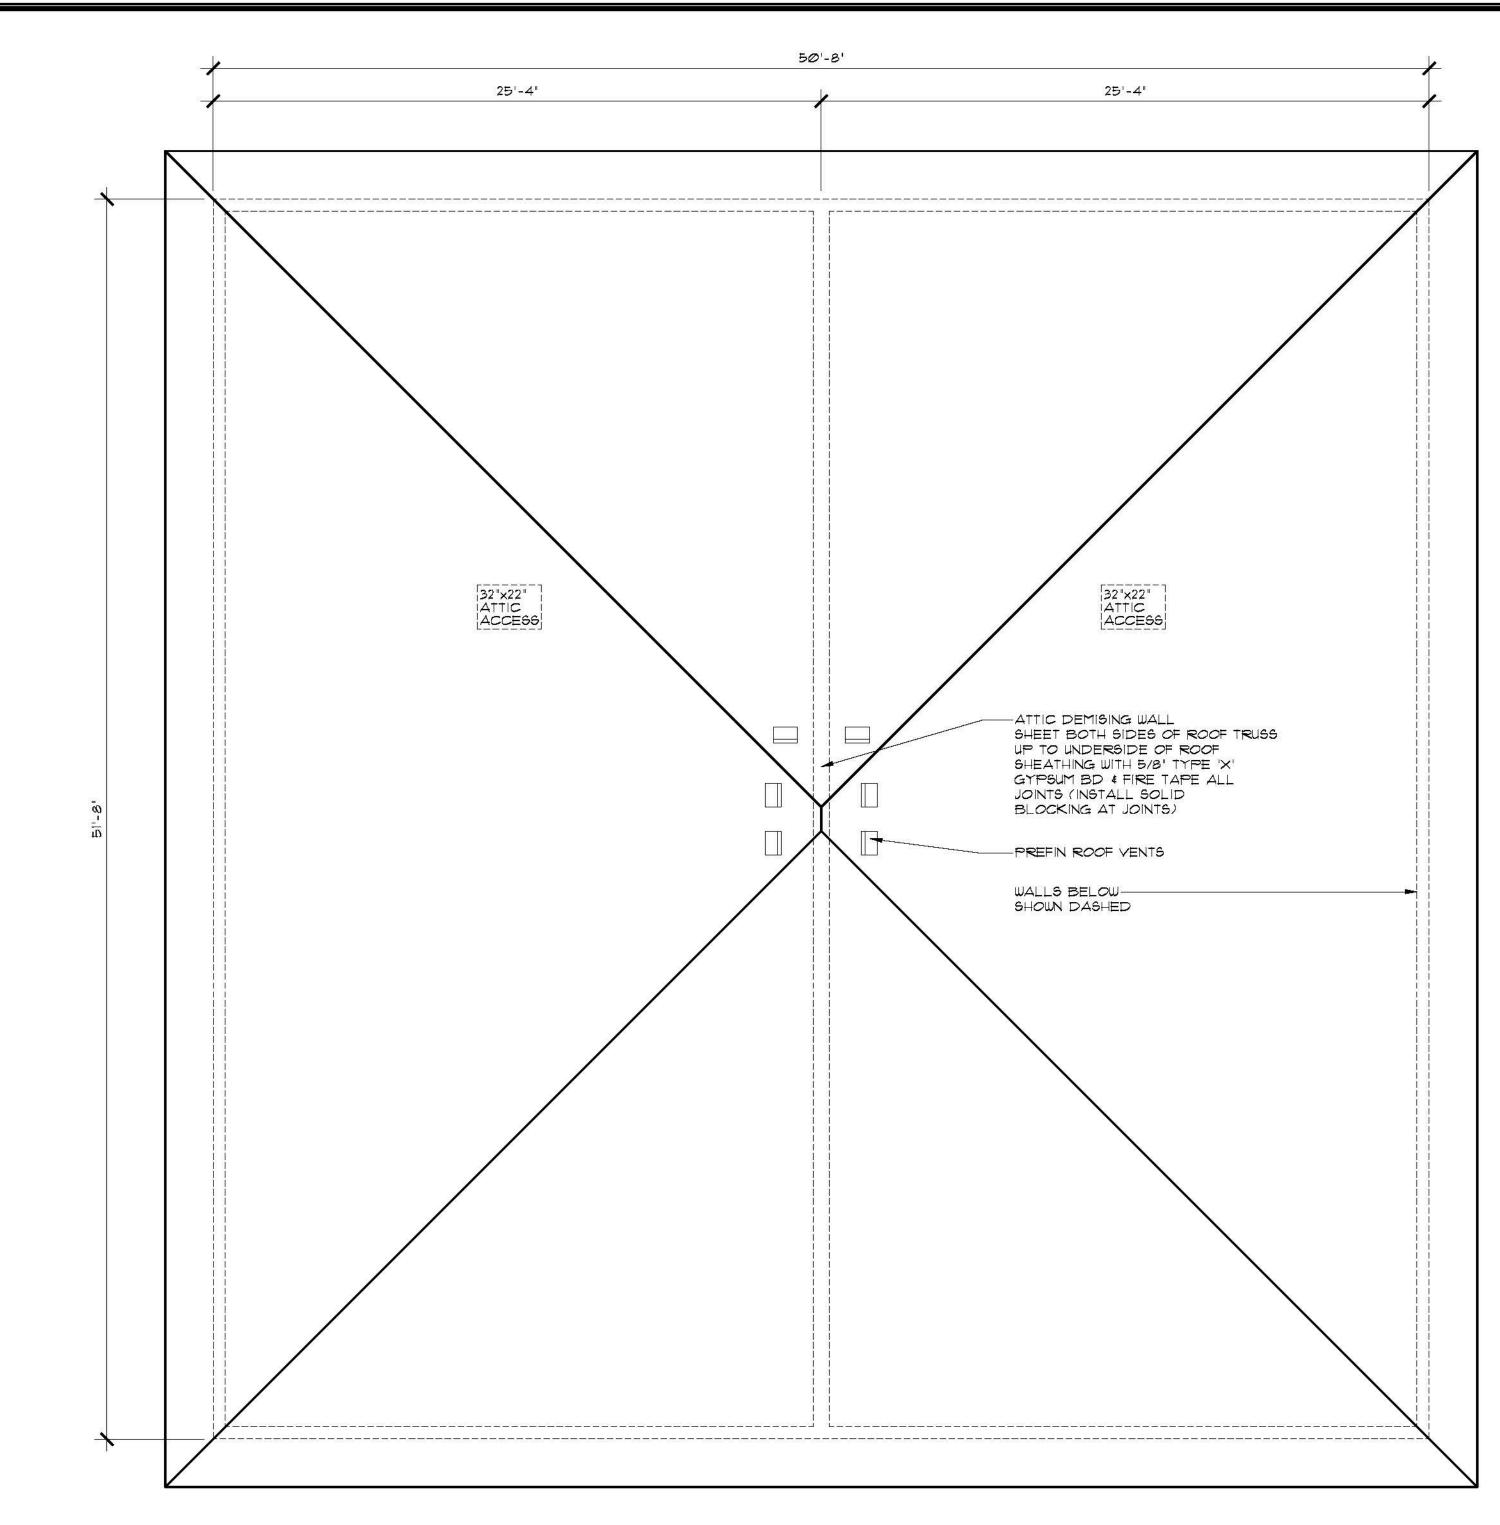

ROOF PLAN SCALE: 1/4'=1'-0'

ROOF NOTES:

1. ALL ROOF SLOPES ARE 4:12 UNLESS NOTED OTHERWISE.

- 2. ALL ROOF OVERHANGS ARE 2'-0" UNLESS NOTED OTHERWISE.
- 3. ALL SOFFITS WITHIN THE 1.2M LIMITING DISTANCE MUST BE UNVENTED AND MADE OF NON-COMBUSTIBLE MATERIAL

CORONACH SASKATCHEWAN

VENTING CALCULATIONS: 2618 SQFT/300 SQFT = 8.7 SQ FT REQ'D VENT AREA TOTAL

HIGH END - MIN 25% REQUIRED 0.38 SQFT NET FREE VENT AREA PER ROOF VENT 6 VENTS @ 0.38 SQFT = 2.28 SQ FT 2.28 SQFT / 8.7 SQ FT TOTAL REQ'D = 26%

LOW END - MIN 25% REQUIRED 425 SQFT VENTED SOFFIT 35 SQIN (0.0243 SQ FT) NET FREE VENT AREA PER SOFT OF SOFFIT AREA 425 SQFT x 0.0243 = 10.3 SQFT OF LOWER VENTING 10.3 SQ FT/ 8.7 SQ FT TOTAL REQ'D = 119%

ROBINSON	PROJECT		
RESIDENTIAL	2232 2ND A REGINA, S CANADA		
Personalizing home design	TEL: (306) FAX: (306)		

DUPLEX 2232 2ND AVENUE REGINA, SASKATCHEWAN CANADA S4R 1K3 TEL: (306) 352-6617 FAX: (306) 352-6619

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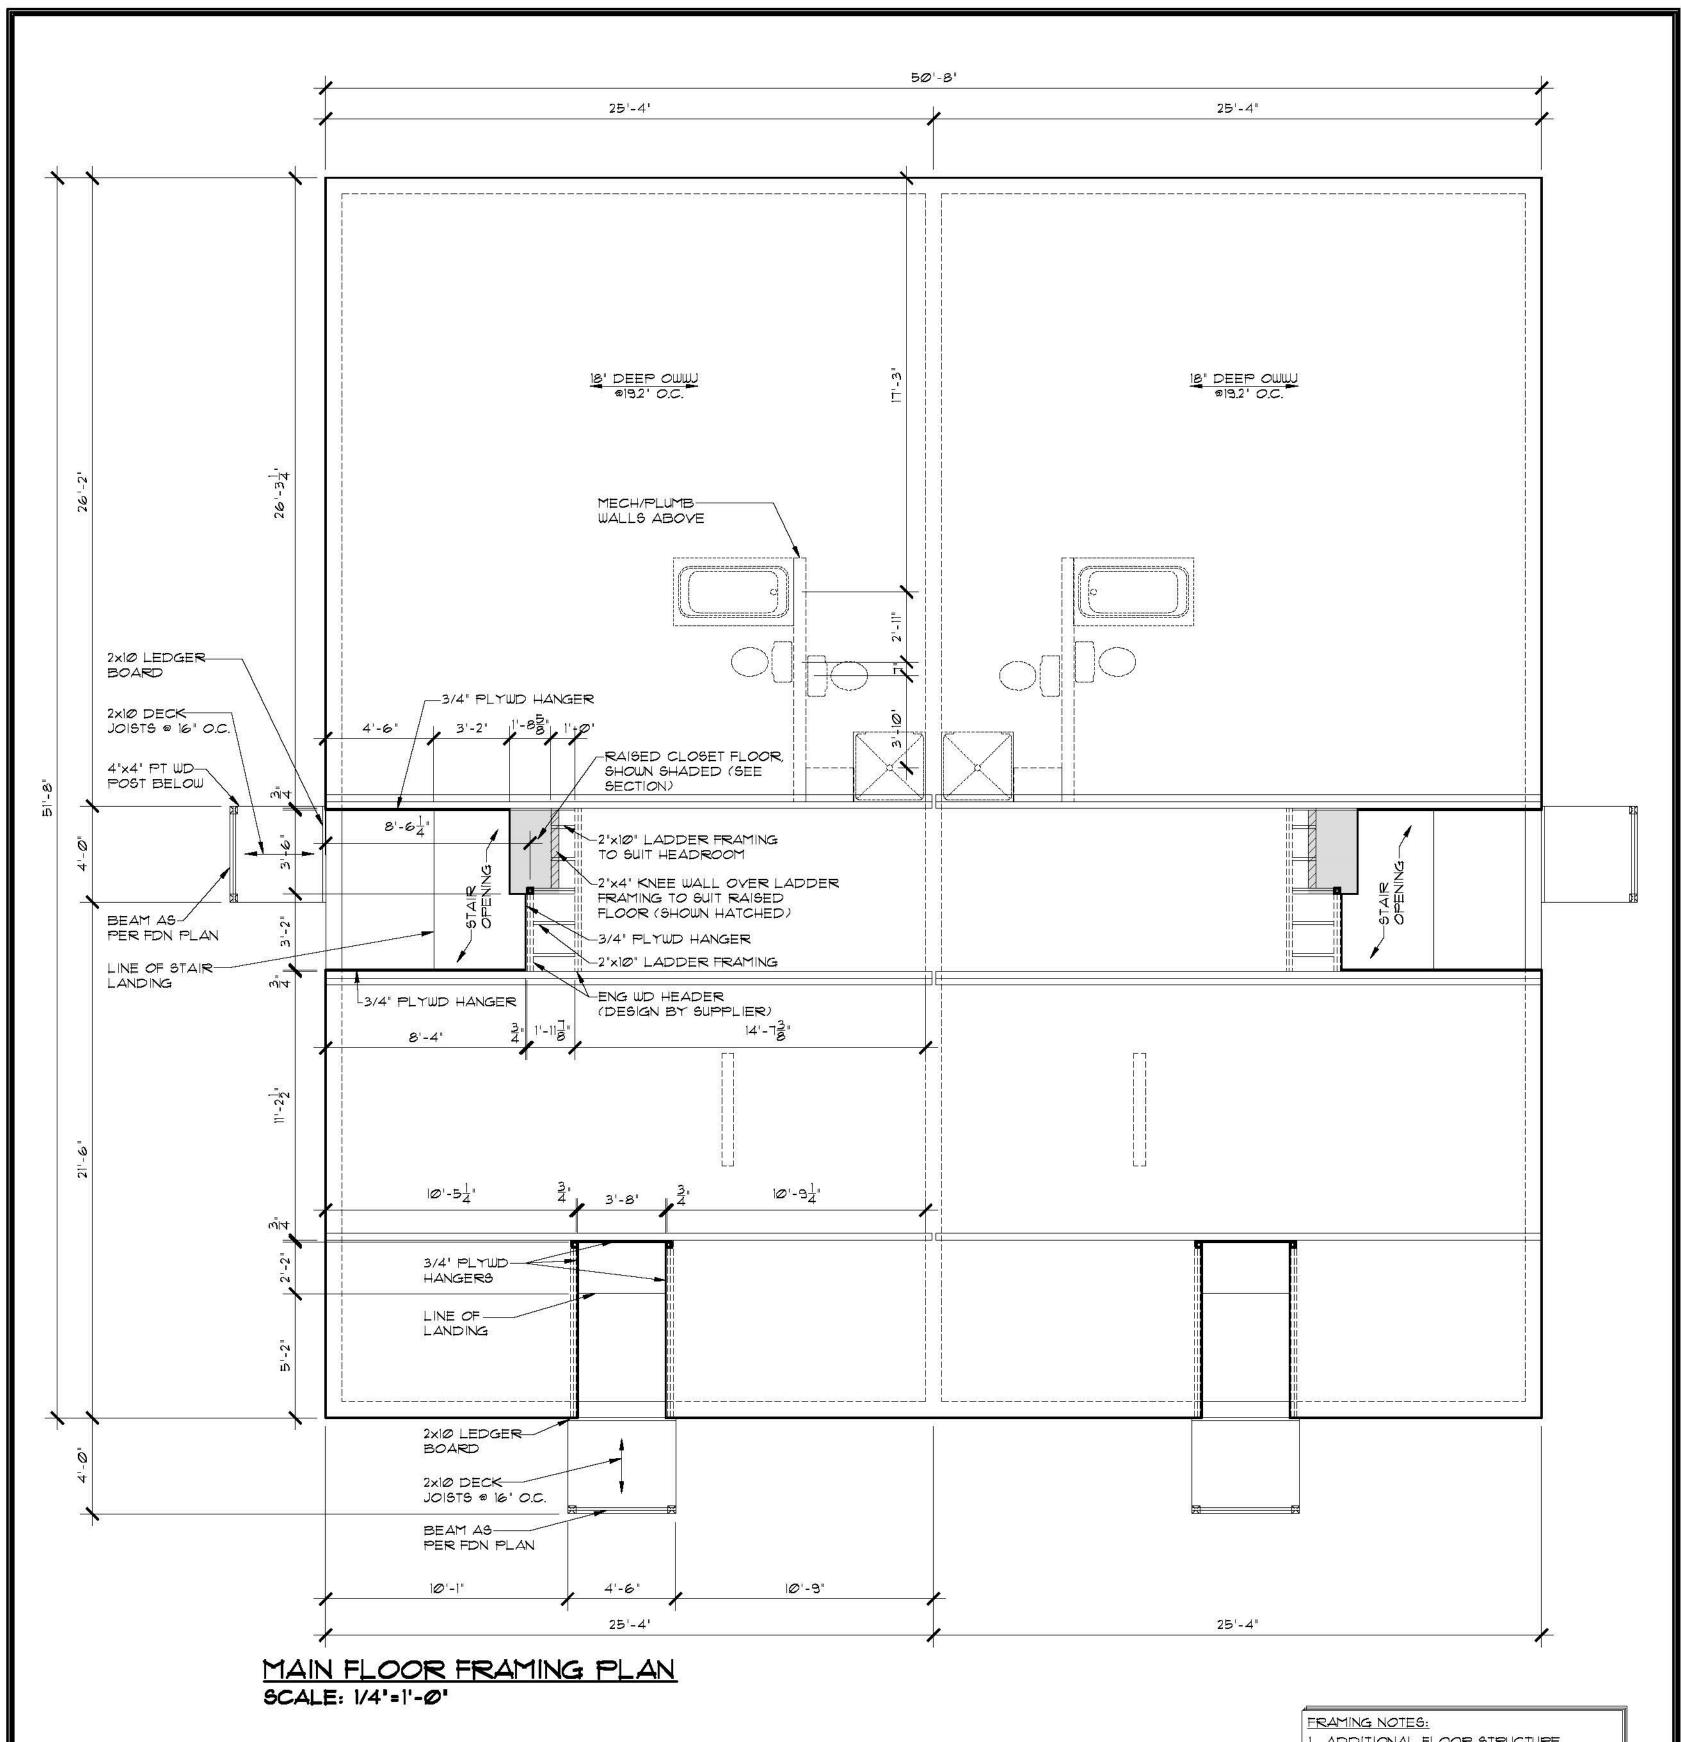
DRAWING TITLE ROOF PLAN

1/4" = 1'-0"

SCALE

DESIGNED BY DRAWN BY DATE DRAWING NO. SEPT. 18, 2015 TYDK

A-5



- 1. ADDITIONAL FLOOR STRUCTURE SHOWN FOR OPENINGS AND CANTILEVERS, FINAL DESIGN DETERMINED BY SUPPLIER.
- 2. FLOOR TRUSS SUPPLIER TO DESIGN TRUSSES TO SUIT MECHANICAL.
- 3. INSTALL SOLID BLOCKING IN FLOOR SPACE UNDER COLUMNS AS REQUIRED.
- 4. INSTALL BLOCKING UNDER INTERIOR WALLS PARALLEL TO FLOOR TRUSSES AS REQUIRED.
- 5. FLOOR TRUSS SUPPLIER TO INCORPORATE HEADERS INTO TRUSS SPACE AS NECESSARY (SEE ELEVATIONS FOR WINDOW MOUNTING HEIGHTS)

DATE

ROBINSON
RESIDENTIAL
PERSONALIZING HOME DESIGN

CANADA S4R 1K3 TEL: (306) 352-6617	I. Copyright of these plane remains with Robinson Residential Design inc. Duplication of these plans in whole a part is strictly profibilited, without primititien permission from Robinson Residential Design inc.
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CORONACH SASKATCHEWAN

SCALE

1/4" = 1'-0"


DRAWING TITLE MAIN FLOOR FRAMING PLAN


DESIGNED BY DRAWN BY

TYDK

DRAWING NO. SEPT. 18, 2015

A-6

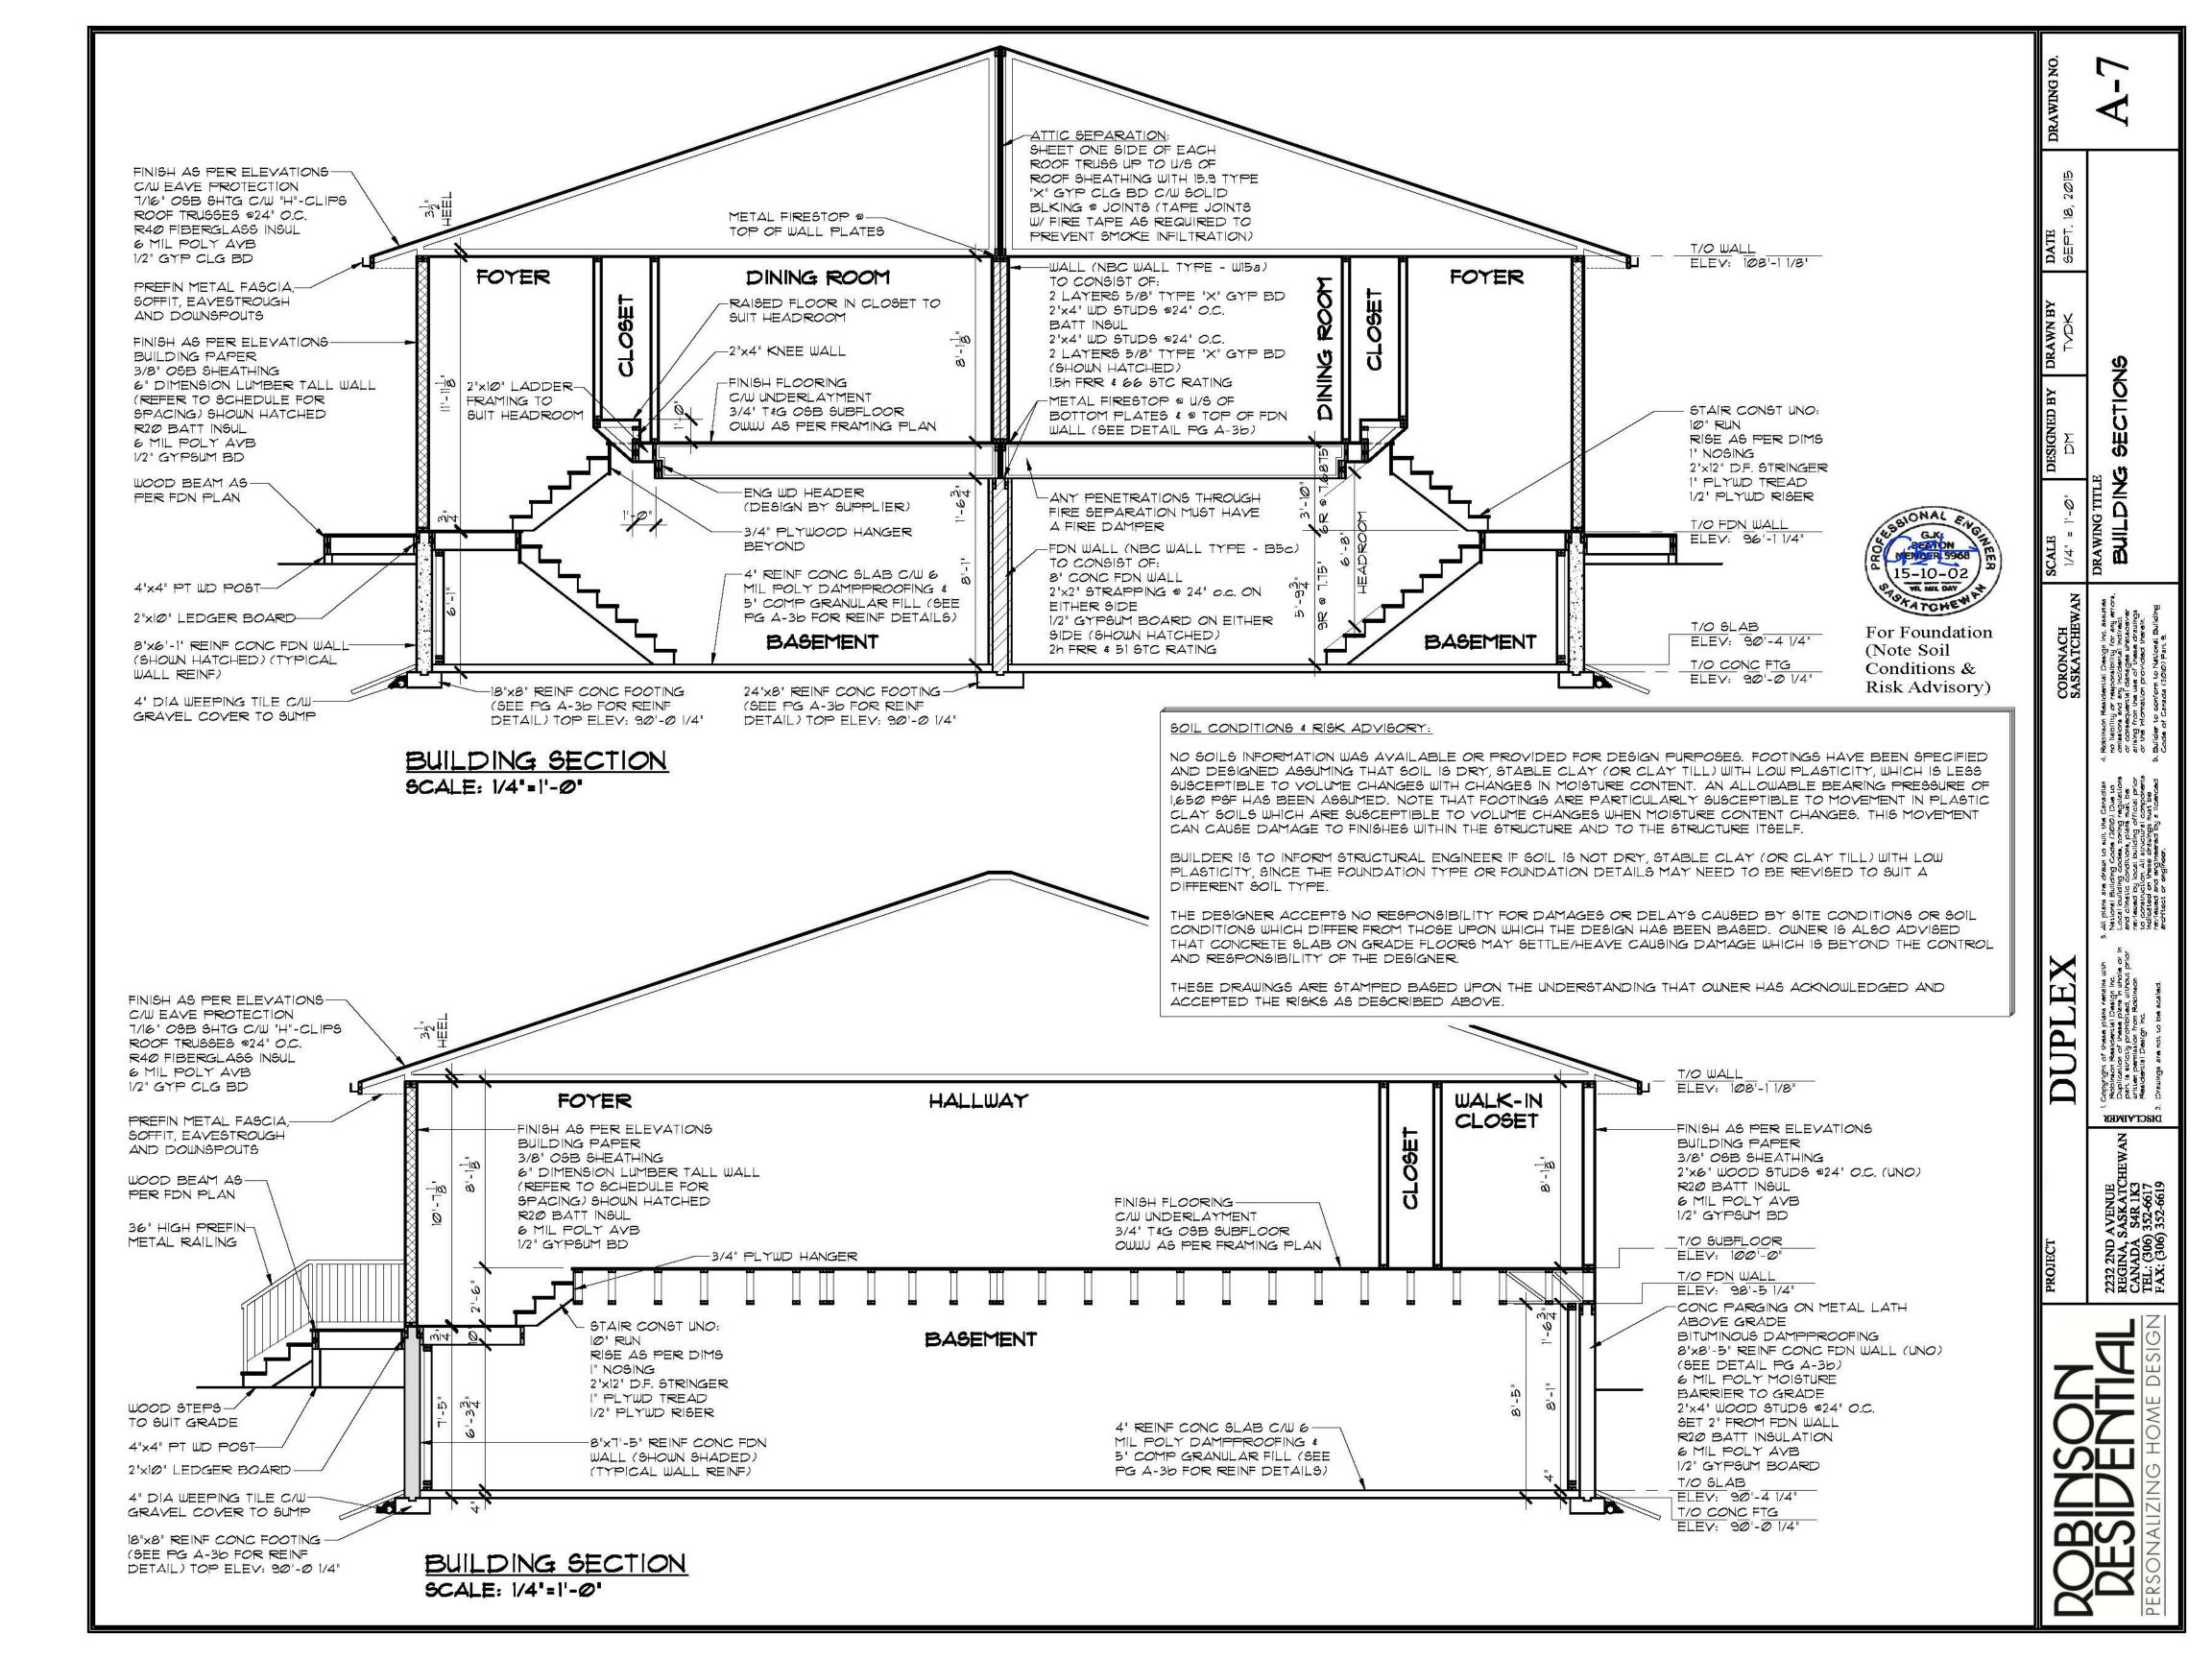

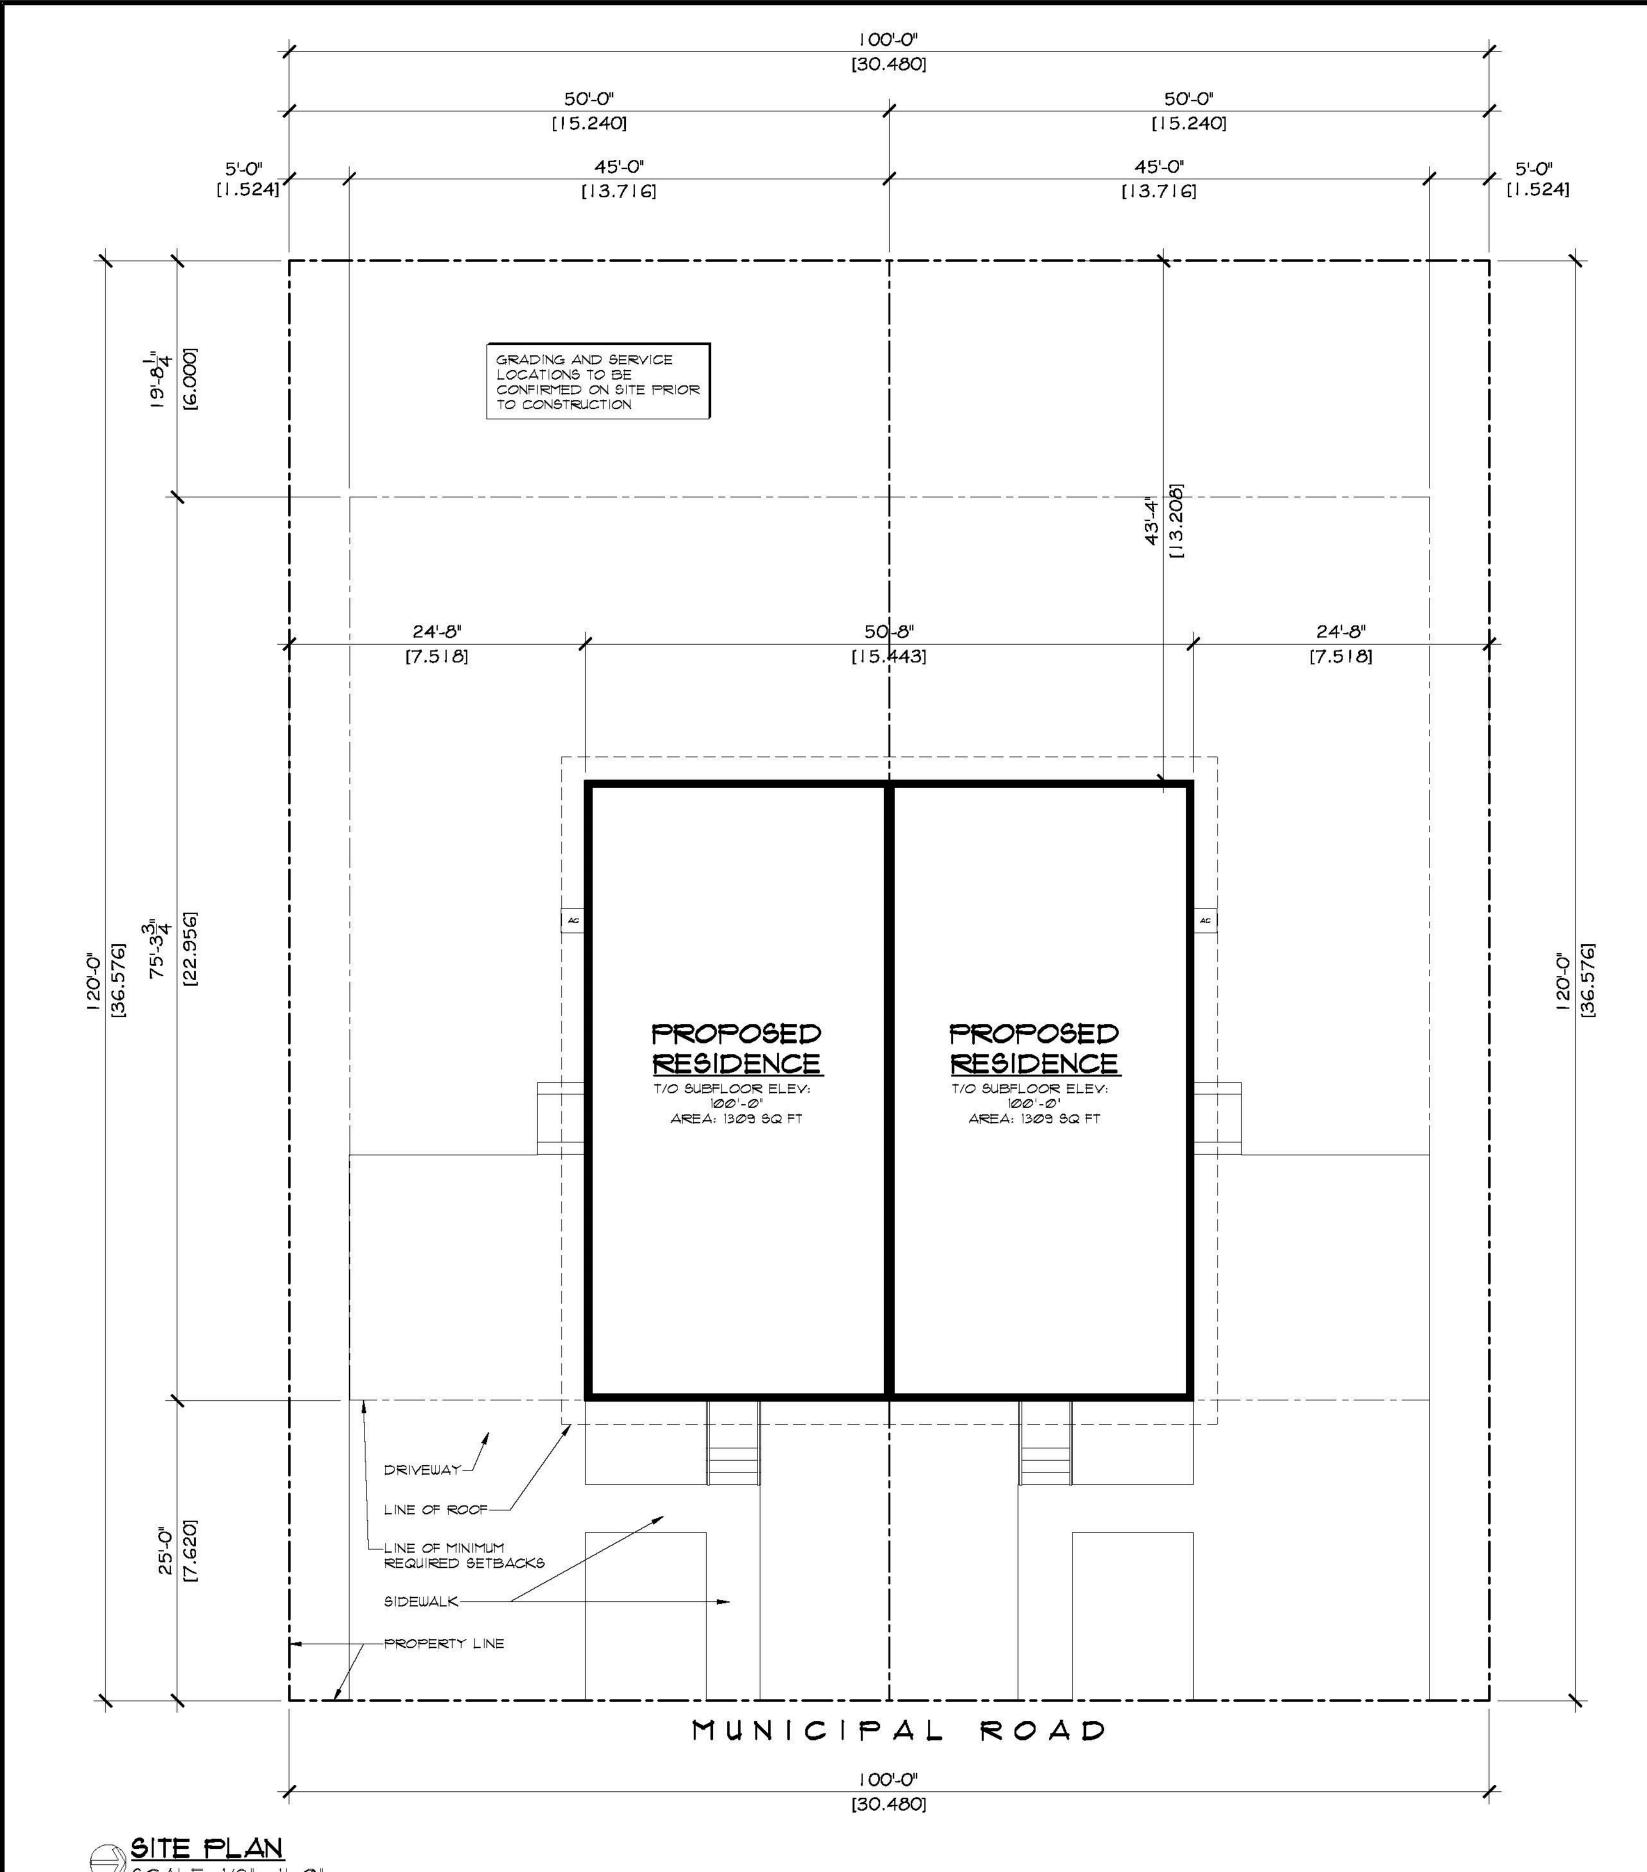

SITE PLAN SCALE: 1/8" =1'-0"

LEGAL DESCRIPTION

LOT: #243 BLOCK: *11 PLAN: *C.X. 870 LOCATION: CORONACH, SASKATCHEWAN

DOBINSON	PROJECT	DUPLEX		CORONACH SASKATCHEWAN	SCALE 1/8" = 1'-Ø"	DESIGNED BY	DRAWN BY TV⊅K	DATE SEPT. 18, 2015	DRAWING NO.		
	DESIDENTIAL PERSONALIZING HOME DESIGN	TBL: (306) 352-6617	1. Copyright of these plane remains with Robinson Residential Design Inc. Duplication of these plans in whole or in part is strictly prolifeted, without prior written permission from Robinson Residential Design Inc. 2. Drawings are not to be scaled.	3. All plans are drawn to suit the Canadian National Building Code (2010). Due to Local building codes, coning regulations and climatic conditions, plans must be reviewed by local building official prior to construction. All structural components indicated on these drawings must be reviewed and engineers.	4. Robinson Residential Design Inc. assumes no liability or responsibility for any errors, omissions and any incidental indirect or consequential damages whatsoever arising from the use of these drawings or the information provided therein. 5. Builder to conform to National Building Code of Canada (200) Part 9.	SITE PL				A-8	